

Kings/Tulare (Potential Station) **Burbank to Los Angeles** 

Option B Revised Alignment Volume 3.4

General, Utilities, Grading & Drainage, Traction Power, Communication Towers, Train Control & System Support Facilities

August 2021






## PRELIMINARY ENGINEERING FOR PROJECT DEFINITION (PEPD)

# CALIFORNIA HIGH-SPEED TRAIN PROJECT VALLEY/RIVER SUBDIVISION

BURBANK TO LOS ANGELES - OPTION B REFINED VOLUME 3.4

GENERAL, UTILITIES, GRADING & DRAINAGE, TRACTION POWER COMMUNICATION TOWERS, TRAIN CONTROL & SYSTEM SUPPORT FACILITIES



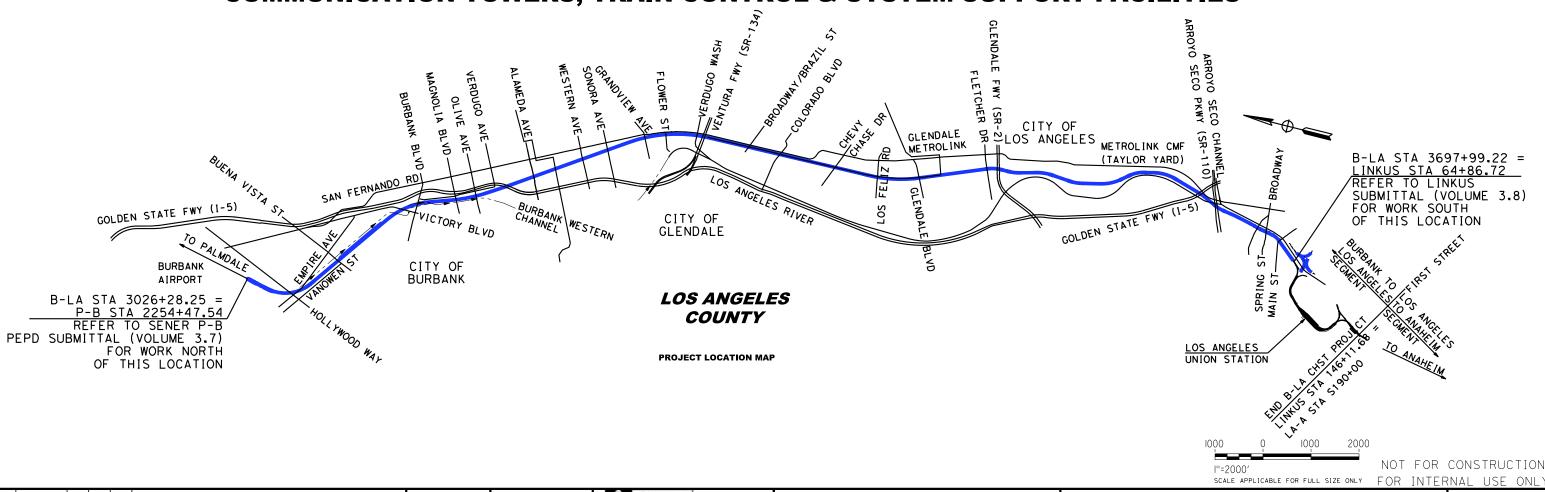

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## CALIFORNIA HIGH-SPEED TRAIN PROJECT BURBANK TO LOS ANGELES

OPTION B REVISED ALIGNMENT - REVISED FINAL
PEPD ALTERNATIVE F
VOLUME 3.4
PROJECT LOCATION MAP

HSR14-39
DRAWING NO. GE-A0401
NO SCALE
SHEET NO.

VOLUME NO.	CONTENT
VOLUME 3.5	GENERAL
	STATIONS
	MAINTENANCE FACILITIES
	TRACKSIDE ACCESS
VOLUME 3.6	GENERAL
	CONSTRUCTION PHASING PLANS
VOLUME 3.7	GENERAL
	BURBANK AIRPORT STATION
VOLUME 3.8	GENERAL
	LINK UNION STATION (LINK US) BY LA METRO

NOT FOR CONSTRUCTION FOR INTERNAL USE ONLY

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							DRAWN BY C. CUSSON	
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Sonc							IN CHARGE C. LEE	С
SD2	REV	DATE	ВΥ	СНК	APP	DESCRIPTION	DATE 07/15/2021	

PEPD RECORD SET NOT FOR CONSTRUCTION





## CALIFORNIA HIGH-SPEED TRAIN PROJECT BURBANK TO LOS ANGELES

OPTION B REVISED ALIGNMENT - REVISED FINAL PEPD INDEX OF VOLUMES

CONTRACT NO.
HSR14-39

DRAWING NO.
GE-A0410

SCALE
NO SCALE
SHEET NO.

## **VOLUME 3.4 - GENERAL, UTILITIES, GRADING & DRAINAGE, TRACTION POWER, COMMUNICATION TOWERS, TRAIN CONTROL & SYSTEM SUPPORT FACILITIES** IITII ITIES

	GENERAL
DRAWING NO.	DRAWING TITLE
GE-A0400	COVER SHEET - VOLUME 3.4
GE-A0401	PROJECT LOCATION MAP - VOLUME 3.4
GE-A0410	INDEX OF VOLUMES
GE-A0411	INDEX OF DRAWINGS VOLUME 3.4 - SHEET 1 OF 4
GE-A0412	INDEX OF DRAWINGS VOLUME 3.4 - SHEET 2 OF 4
GE-A0413	INDEX OF DRAWINGS VOLUME 3.4 - SHEET 3 OF 4
GE-A0414	INDEX OF DRAWINGS VOLUME 3.4 - SHEET 4 OF 4
GE-D0401	VOLUME 3.4 - KEY MAP UTILITIES AND GRADING AND DRAINAGE - SHEET 1 OF 2
GE-D0402	VOLUME 3.4 - KEY MAP UTILITIES AND LOCKHEED CHANNEL - SHEET 2 OF 2
GE-B0401	BASIS OF DESIGN SUMMARY
GE-C0401	ACRONYMS AND ABBREVIATIONS - SHEET 1 OF 5
GE-C0402	ACRONYMS AND ABBREVIATIONS - SHEET 2 OF 5
GE-C0403	ACRONYMS AND ABBREVIATIONS - SHEET 3 OF 5
GE-C0404	ACRONYMS AND ABBREVIATIONS - SHEET 4 OF 5
GE-C0405	ACRONYMS AND ABBREVIATIONS - SHEET 5 OF 5
GE-C0411	SYMBOLS - SHEET 1 OF 2
GE-C0412	SYMBOLS - SHEET 2 OF 2
GE-B0411	GENERAL NOTES
GE-D6401	TRACK SCHEMATIC

	UTILITIES
DRAWING NO.	DRAWING TITLE
UT-C1501	COMPOSITE UTILITIES PLAN STA HSR2 3026+28 TO STA HSR2 3034+00
UT-C1501A	COMPOSITE UTILITIES PLAN STA HSR2 3034+00 TO STA HSR2 3047+00
UT-C1501B	COMPOSITE UTILITIES PLAN STA HSR2 3047+00 TO STA HSR2 3060+00
UT-C1502	COMPOSITE UTILITIES PLAN STA HSR2 3060+00 TO STA HSR2 3073+00
UT-C1503	COMPOSITE UTILITIES PLAN STA HSR2 3073+00 TO STA HSR2 3086+00
UT-C1504	COMPOSITE UTILITIES PLAN STA HSR2 3086+00 TO STA HSR2 3099+00
UT-C1505	COMPOSITE UTILITIES PLAN STA HSR2 3099+00 TO STA HSR2 3112+00
UT-C1506	COMPOSITE UTILITIES PLAN STA HSR2 3112+00 TO STA HSR2 3125+00
UT-C1507	COMPOSITE UTILITIES PLAN STA HSR2 3125+00 TO STA HSR2 3138+00
UT-C1508	COMPOSITE UTILITIES PLAN STA HSR2 3138+00 TO STA HSR2 3151+00
UT-C1509	COMPOSITE UTILITIES PLAN STA HSR2 3151+00 TO STA HSR2 3164+00
UT-C1510	COMPOSITE UTILITIES PLAN STA HSR2 3164+00 TO STA HSR2 3177+00
UT-C1511	COMPOSITE UTILITIES PLAN STA HSR2 3177+00 TO STA HSR2 3190+00
UT-C1512	COMPOSITE UTILITIES PLAN STA HSR2 3190+00 TO STA HSR2 3203+00
UT-C1513	COMPOSITE UTILITIES PLAN STA HSR2 3203+00 TO STA HSR2 3216+00
UT-C1514	COMPOSITE UTILITIES PLAN STA HSR2 3216+00 TO STA HSR2 3229+00
UT-C1515	COMPOSITE UTILITIES PLAN STA HSR2 3229+00 TO STA HSR2 3242+00
UT-C1516	COMPOSITE UTILITIES PLAN STA HSR2 3242+00 TO STA HSR2 3255+00
UT-C1517	COMPOSITE UTILITIES PLAN STA HSR2 3255+00 TO STA HSR2 3268+00
UT-C1518	COMPOSITE UTILITIES PLAN STA HSR2 3268+00 TO STA HSR2 3281+00

	UTILITIES
DRAWING NO.	DRAWING TITLE
UT-C1519	COMPOSITE UTILITIES PLAN STA HSR2 3281+00 TO STA HSR2 3294+00
UT-C1520	COMPOSITE UTILITIES PLAN STA HSR2 3294+00 TO STA HSR2 3307+00
UT-C1521	COMPOSITE UTILITIES PLAN STA HSR2 3307+00 TO STA HSR2 3320+00
UT-C1522	COMPOSITE UTILITIES PLAN STA HSR2 3320+00 TO STA HSR2 3333+00
UT-C1523	COMPOSITE UTILITIES PLAN STA HSR2 3333+00 TO STA HSR2 3346+00
UT-C1524	COMPOSITE UTILITIES PLAN STA HSR2 3346+00 TO STA HSR2 3359+00
UT-C1525	COMPOSITE UTILITIES PLAN STA HSR2 3359+00 TO STA HSR2 3372+00
UT-C1526	COMPOSITE UTILITIES PLAN STA HSR2 3372+00 TO STA HSR2 3385+00
UT-C1527	COMPOSITE UTILITIES PLAN STA HSR2 3385+00 TO STA HSR2 3398+00
UT-C1528	COMPOSITE UTILITIES PLAN STA HSR2 3398+00 TO STA HSR2 3411+00
UT-C1529	COMPOSITE UTILITIES PLAN STA HSR2 3411+00 TO STA HSR2 3424+00
UT-C1530	COMPOSITE UTILITIES PLAN STA HSR2 3424+00 TO STA HSR2 3437+00
UT-C1531	COMPOSITE UTILITIES PLAN STA HSR2 3437+00 TO STA HSR2 3450+00
UT-C1532	COMPOSITE UTILITIES PLAN STA HSR2 3450+00 TO STA HSR2 3463+00
UT-C1533	COMPOSITE UTILITIES PLAN STA HSR2 3463+00 TO STA HSR2 3476+00
UT-C1534	COMPOSITE UTILITIES PLAN STA HSR2 3476+00 TO STA HSR2 3489+00
UT-C1535	COMPOSITE UTILITIES PLAN STA HSR2 3489+00 TO STA HSR2 3502+00
UT-C1536	COMPOSITE UTILITIES PLAN STA HSR2 3502+00 TO STA HSR2 3515+00
UT-C1537	COMPOSITE UTILITIES PLAN STA HSR2 3515+00 TO STA HSR2 3528+00
UT-C1538	COMPOSITE UTILITIES PLAN STA HSR2 3528+00 TO STA HSR2 3541+00
UT-C1539	COMPOSITE UTILITIES PLAN STA HSR2 3541+00 TO STA HSR2 3554+00
UT-C1540	COMPOSITE UTILITIES PLAN STA HSR2 3554+00 TO STA HSR2 3567+00
UT-C1541	COMPOSITE UTILITIES PLAN STA HSR2 3567+00 TO STA HSR2 3580+00
UT-C1542	COMPOSITE UTILITIES PLAN STA HSR2 3580+00 TO STA HSR2 3593+00
UT-C1543	COMPOSITE UTILITIES PLAN STA HSR2 3593+00 TO STA HSR2 3606+00
UT-C1544	COMPOSITE UTILITIES PLAN STA HSR2 3606+00 TO STA HSR2 3619+00
UT-C1545	COMPOSITE UTILITIES PLAN STA HSR2 3619+00 TO STA HSR2 3632+00
UT-C1546	COMPOSITE UTILITIES PLAN STA HSR2 3632+00 TO STA HSR2 3645+00
UT-C1547	COMPOSITE UTILITIES PLAN STA HSR2 3645+00 TO STA HSR2 3658+00
UT-C1548	COMPOSITE UTILITIES PLAN STA HSR2 3658+00 TO STA HSR2 3671+00
UT-C1549	COMPOSITE UTILITIES PLAN STA HSR2 3671+00 TO STA HSR2 3684+00
UT-C1550	COMPOSITE UTILITIES PLAN STA HSR2 3684+00 TO STA HSR2 3697+00
UT-C1601	COMPOSITE UTILITIES PLAN STA SF 3211+43.44 TO STA SF 3218+00
UT-C1602	COMPOSITE UTILITIES PLAN STA SF 3218+00 TO STA SF 3231+00
UT-C1603	COMPOSITE UTILITIES PLAN STA SF 3231+00 TO STA SF 3244+00
UT-C1604	COMPOSITE UTILITIES PLAN STA SF 3244+00 TO STA SDNG 111+00
UT-C1605	COMPOSITE UTILITIES PLAN STA SDNG 111+00 TO STA SDNG 124+00
UT-C1606	COMPOSITE UTILITIES PLAN STA SDNG 124+00 TO STA SDNG 133+02.62
UT-C1701	COMPOSITE UTILITIES PLAN STA VE01, VE01, VE02 3215+72.96 TO VE01, VE02 3218+00
UT-C1702	COMPOSITE UTILITIES PLAN STA VEO1, VEO2 3218+00 TO STA VEO1, VEO2 3231+00
UT-C1703	COMPOSITE UTILITIES PLAN STA VEO1, VEO2 3231+00 TO STA VEO1, VEO2 3244+00
UT-C1704	COMPOSITE UTILITIES PLAN STA VEO1, VEO2 3244+00 TO STA VEO1, VEO2 3257+00

						DESIGNED BY C. CUSSON  DRAWN BY C. CUSSON  CHECKED BY C. LEE IN CHARGE C. LEE	
REV	DATE	ВΥ	СНК	APP	DESCRIPTION	DATE 08/27/2021	

PEPD RECORD SET NOT FOR CONSTRUCTION





## CALIFORNIA HIGH-SPEED TRAIN PROJECT BURBANK TO LOS ANGELES

OPTION B REVISED ALIGNMENT - REVISED FINAL PEPD INDEX OF DRAWINGS VOLUME 3.4 - SHEET 1 OF 4

CONTRACT NO. HSR14-39
DRAWING NO. GE - AO411
NO SCALE
SHEET NO.

**VOLUME 3.4 - GENERAL, UTILITIES, GRADING & DRAINAGE, TRACTION POWER, COMMUNICATION TOWERS, TRAIN CONTROL & SYSTEM SUPPORT FACILITIES** 

	UTILITIES
DRAWING NO.	DRAWING TITLE
UT-C1705	COMPOSITE UTILITIES PLAN STA VEO1, VEO2 3257+00 TO STA VEO1, VEO2 3270+00
UT-C1706	COMPOSITE UTILITIES PLAN STA VEO1, VEO2 3270+00 TO STA VEO1, VEO2 3283+00
UT-C1707	COMPOSITE UTILITIES PLAN STA VEO1, VEO2 3283+00 TO STA VEO1, VEO2 3291+65.95
UT-C1801	COMPOSITE UTILITIES PLAN MT01 52+80 TO MT01 40+00
UT-C1802	COMPOSITE UTILITIES PLAN MT01 40+00 TO MT01 35+27
UT-C1803	COMPOSITE UTILITIES PLAN UPRR 1 TRACK
UT-D1601	PROPOSED UTILITIES RELOCATION PLAN STA HSR2 3026+28.25 TO STA HSR2 3034+00
UT-D1601A	PROPOSED UTILITIES RELOCATION PLAN STA HSR2 3034+00 TO STA HSR2 3047+00
UT-D1601B	PROPOSED UTILITIES RELOCATION PLAN STA HSR2 3047+00 TO STA HSR2 3060+00
UT-D1602	PROPOSED UTILITIES RELOCATION PLAN STA HSR2 3060+00 TO STA HSR2 3073+00
UT-D1603	PROPOSED UTILITIES RELOCATION PLAN STA HSR2 3073+00 TO STA HSR2 3086+00
UT-D1604	PROPOSED UTILITIES RELOCATION PLAN STA HSR2 3086+00 TO STA HSR2 3099+00
UT-D1605	PROPOSED UTILITIES RELOCATION PLAN STA HSR2 3099+00 TO STA HSR2 3112+00
UT-D1606	PROPOSED UTILITIES RELOCATION PLAN STA HSR2 3112+00 TO STA HSR2 3125+00
UT-D1607	PROPOSED UTILITIES RELOCATION PLAN STA HSR2 3125+00 TO STA HSR2 3138+00
UT-D1608	PROPOSED UTILITIES RELOCATION PLAN STA HSR2 3138+00 TO STA HSR2 3151+00
UT-D1609	PROPOSED UTILITIES RELOCATION PLAN STA HSR2 3151+00 TO STA HSR2 3164+00
UT-D1610	PROPOSED UTILITIES RELOCATION PLAN STA HSR2 3164+00 TO STA HSR2 3177+00
UT-D1611	PROPOSED UTILITIES RELOCATION PLAN STA HSR2 3177+00 TO STA HSR2 3190+00
UT-D1612	PROPOSED UTILITIES RELOCATION PLAN STA HSR2 3190+00 TO STA HSR2 3203+00
UT-D1613	PROPOSED UTILITIES RELOCATION PLAN STA HSR2 3203+00 TO STA HSR2 3216+00
UT-D1614	PROPOSED UTILITIES RELOCATION PLAN STA HSR2 3216+00 TO STA HSR2 3229+00
UT-D1615	PROPOSED UTILITIES RELOCATION PLAN STA HSR2 3229+00 TO STA HSR2 3242+00
UT-D1616	PROPOSED UTILITIES RELOCATION PLAN STA HSR2 3242+00 TO STA HSR2 3255+00
UT-D1617	PROPOSED UTILITIES RELOCATION PLAN STA HSR2 3255+00 TO STA HSR2 3268+00
UT-D1618	PROPOSED UTILITIES RELOCATION PLAN STA HSR2 3268+00 TO STA HSR2 3281+00
UT-D1619	PROPOSED UTILITIES RELOCATION PLAN STA HSR2 3281+00 TO STA HSR2 3294+00
UT-D1620	PROPOSED UTILITIES RELOCATION PLAN STA HSR2 3294+00 TO STA HSR2 3307+00
UT-D1621	PROPOSED UTILITIES RELOCATION PLAN STA HSR2 3307+00 TO STA HSR2 3320+00
UT-D1622	PROPOSED UTILITIES RELOCATION PLAN STA HSR2 3320+00 TO STA HSR2 3333+00
UT-D1623	PROPOSED UTILITIES RELOCATION PLAN STA HSR2 3333+00 TO STA HSR2 3346+00
UT-D1624	PROPOSED UTILITIES RELOCATION PLAN STA HSR2 3346+00 TO STA HSR2 3359+00
UT-D1625	PROPOSED UTILITIES RELOCATION PLAN STA HSR2 3359+00 TO STA HSR2 3372+00
UT-D1626	PROPOSED UTILITIES RELOCATION PLAN STA HSR2 3372+00 TO STA HSR2 3385+00
UT-D1627	PROPOSED UTILITIES RELOCATION PLAN STA HSR2 3385+00 TO STA HSR2 3398+00
UT-D1628	PROPOSED UTILITIES RELOCATION PLAN STA HSR2 3398+00 TO STA HSR2 3411+00
UT-D1629	PROPOSED UTILITIES RELOCATION PLAN STA HSR2 3411+00 TO STA HSR2 3424+00
UT-D1630	PROPOSED UTILITIES RELOCATION PLAN STA HSR2 3424+00 TO STA HSR2 3437+00
UT-D1631	PROPOSED UTILITIES RELOCATION PLAN STA HSR2 3437+00 TO STA HSR2 3450+00
UT-D1632	PROPOSED UTILITIES RELOCATION PLAN STA HSR2 3450+00 TO STA HSR2 3463+00
UT-D1633	PROPOSED UTILITIES RELOCATION PLAN STA HSR2 3463+00 TO STA HSR2 3476+00
UT-D1634	PROPOSED UTILITIES RELOCATION PLAN STA HSR2 3476+00 TO STA HSR2 3489+00

	UTILITIES
DRAWING NO.	DRAWING TITLE
UT-D1635	PROPOSED UTILITIES RELOCATION PLAN STA HSR2 3489+00 TO STA HSR2 3502+00
UT-D1636	PROPOSED UTILITIES RELOCATION PLAN STA HSR2 3502+00 TO STA HSR2 3515+00
UT-D1637	PROPOSED UTILITIES RELOCATION PLAN STA HSR2 3515+00 TO STA HSR2 3528+00
UT-D1638	PROPOSED UTILITIES RELOCATION PLAN STA HSR2 3528+00 TO STA HSR2 3541+00
UT-D1639	PROPOSED UTILITIES RELOCATION PLAN STA HSR2 3541+00 TO STA HSR2 3554+00
UT- <b>D</b> 1640	PROPOSED UTILITIES RELOCATION PLAN STA HSR2 3554+00 TO STA HSR2 3567+00
UT-D1641	PROPOSED UTILITIES RELOCATION PLAN STA HSR2 3567+00 TO STA HSR2 3580+00
UT-D1642	PROPOSED UTILITIES RELOCATION PLAN STA HSR2 3580+00 TO STA HSR2 3593+00
UT-D1643	PROPOSED UTILITIES RELOCATION PLAN STA HSR2 3593+00 TO STA HSR2 3606+00
UT-D1644	PROPOSED UTILITIES RELOCATION PLAN STA HSR2 3606+00 TO STA HSR2 3619+00
UT-D1645	PROPOSED UTILITIES RELOCATION PLAN STA HSR2 3619+00 TO STA HSR2 3632+00
UT- <b>D</b> 1646	PROPOSED UTILITIES RELOCATION PLAN STA HSR2 3632+00 TO STA HSR2 3645+00
UT-D1647	PROPOSED UTILITIES RELOCATION PLAN STA HSR2 3645+00 TO STA HSR2 3658+00
UT-D1648	PROPOSED UTILITIES RELOCATION PLAN STA HSR2 3658+00 TO STA HSR2 3671+00
UT-D1649	PROPOSED UTILITIES RELOCATION PLAN STA HSR2 3671+00 TO STA HSR2 3684+00
UT-D1650	PROPOSED UTILITIES RELOCATION PLAN STA HSR2 3684+00 TO STA HSR2 3697+99
UT- <b>D</b> 1701	PROPOSED UTILITIES RELOCATION PLAN STA SF 3211+43.44 TO STA SF 3218+00
UT- <b>D</b> 1702	PROPOSED UTILITIES RELOCATION PLAN STA SF 3218+00 TO STA SF 3231+00
UT- <b>D</b> 1703	PROPOSED UTILITIES RELOCATION PLAN STA SF 3231+00 TO STA SF 3244+00
UT-D1704	PROPOSED UTILITIES RELOCATION PLAN STA SF 3244+00 TO STA SDNG 111+00
UT- <b>D</b> 1705	PROPOSED UTILITIES RELOCATION PLAN STA SDNG 111+00 TO STA SDNG 124+00
UT- <b>D</b> 1706	PROPOSED UTILITIES RELOCATION PLAN STA SDNG 124+00 TO STA SDNG 133+02.62
UT- <b>D</b> 1801	PROPOSED UTILITIES RELOCATION PLAN STA VEO1, VEO2 3215+72.96 TO STA VEO1, VEO2 3218+00
UT- <b>D</b> 1802	PROPOSED UTILITIES RELOCATION PLAN STA VEO1, VEO2 3218+00 TO STA VEO1, VEO2 3231+00
UT- <b>D</b> 1803	PROPOSED UTILITIES RELOCATION PLAN STA VEO1, VEO2 3231+00 TO STA VEO1, VEO2 3244+00
UT- <b>D</b> 1804	PROPOSED UTILITIES RELOCATION PLAN STA VEO1, VEO2 3244+00 TO STA VEO1, VEO2 3257+00
UT- <b>D</b> 1805	PROPOSED UTILITIES RELOCATION PLAN STA VEO1, VEO2 3257+00 TO STA VEO1, VEO2 3270+00
UT-D1806	PROPOSED UTILITIES RELOCATION PLAN STA VEO1, VEO2 3270+00 TO STA VEO1, VEO2 3283+00
UT-D1807	PROPOSED UTILITIES RELOCATION PLAN STA VEO1, VEO2 3283+00 TO STA VEO1, VEO2 3291+66
UT-D1901	PROPOSED UTILITIES RELOCATION PLAN - 20" OIL AND FIBER OPTIC DUCTS
UT-D1902	PROPOSED UTILITIES RELOCATION PLAN - 20" OIL AND FIBER OPTIC DUCTS
UT-D1903	PROPOSED UTILITIES RELOCATION PLAN - 20" OIL AND FIBER OPTIC DUCTS
UT-D1904	PROPOSED UTILITIES RELOCATION PLAN - 20" OIL AND FIBER OPTIC DUCTS
UT-D1905	PROPOSED UTILITIES RELOCATION PLAN - 20" OIL AND FIBER OPTIC DUCTS
UT-D1906	PROPOSED UTILITIES RELOCATION PLAN - 20" OIL AND FIBER OPTIC DUCTS
UT-D1907	PROPOSED UTILITIES RELOCATION PLAN - 20" OIL AND FIBER OPTIC DUCTS
UT-D1908	PROPOSED UTILITIES RELOCATION PLAN - 20" OIL AND FIBER OPTIC DUCTS
UT-D1909	PROPOSED UTILITIES RELOCATION PLAN - 20" OIL AND FIBER OPTIC DUCTS
UT-D1910	PROPOSED UTILITIES RELOCATION PLAN - 20" OIL AND FIBER OPTIC DUCTS
UT-D1911	PROPOSED UTILITIES RELOCATION PLAN - 20" OIL AND FIBER OPTIC DUCTS
UT-D1912	PROPOSED UTILITIES RELOCATION PLAN - 20" OIL AND FIBER OPTIC DUCTS
UT-D1913	PROPOSED UTILITIES RELOCATION PLAN - 20" OIL AND FIBER OPTIC DUCTS
	CONTRACT NO.

						DESIGNED BY C. CUSSON
						DRAWN BY C. CUSSON CHECKED BY
						C. LEE IN CHARGE C. LEE
REV	DATE	BY	СНК	APP	DESCRIPTION	DATE 08/27/2021

PEPD RECORD SET NOT FOR CONSTRUCTION





## CALIFORNIA HIGH-SPEED TRAIN PROJECT BURBANK TO LOS ANGELES

OPTION B REVISED ALIGNMENT - REVISED FINAL INDEX OF DRAWINGS VOLUME 3.4 - SHEET 2 OF 4

CONTRACT NO. HSR14-39
GE-A0412
SCALE NO SCALE

SHEET NO.

## VOLUME 3.4 - GENERAL, UTILITIES, GRADING & DRAINAGE, TRACTION POWER, COMMUNICATION TOWERS, TRAIN CONTROL & SYSTEM SUPPORT FACILITIES

	UTILITIES
DRAWING NO.	DRAWING TITLE
UT-D1914	PROPOSED UTILITIES RELOCATION PLAN - 20" OIL AND FIBER OPTIC DUCTS
UT-D1915	PROPOSED UTILITIES RELOCATION PLAN - 20" OIL AND FIBER OPTIC DUCTS
UT-D1916	PROPOSED UTILITIES RELOCATION PLAN - 20" OIL AND FIBER OPTIC DUCTS
UT-D1917	PROPOSED UTILITIES RELOCATION PLAN - 20" OIL AND FIBER OPTIC DUCTS
UT-D1918	PROPOSED UTILITIES RELOCATION PLAN - 20" OIL AND FIBER OPTIC DUCTS
UT-D1919	PROPOSED UTILITIES RELOCATION PLAN - 20" OIL AND FIBER OPTIC DUCTS
UT-D1920	PROPOSED UTILITIES RELOCATION PLAN - 20" OIL AND FIBER OPTIC DUCTS
UT-D1921	PROPOSED UTILITIES RELOCATION PLAN - 20" OIL AND FIBER OPTIC DUCTS
UT-D1922	PROPOSED UTILITIES RELOCATION PLAN - 20" OIL AND FIBER OPTIC DUCTS
UT-D1923	PROPOSED UTILITIES RELOCATION PLAN - 20" OIL AND FIBER OPTIC DUCTS
UT-D1924	PROPOSED UTILITIES RELOCATION PLAN - 20" OIL AND FIBER OPTIC DUCTS
UT-D1925	PROPOSED UTILITIES RELOCATION PLAN - 20" OIL AND FIBER OPTIC DUCTS
UT-D1926	PROPOSED UTILITIES RELOCATION PLAN - 20" OIL AND FIBER OPTIC DUCTS
UT-D1927	PROPOSED UTILITIES RELOCATION PLAN - 20" OIL AND FIBER OPTIC DUCTS
UT-D1928	PROPOSED UTILITIES RELOCATION PLAN - 20" OIL AND FIBER OPTIC DUCTS
UT-D1929	PROPOSED UTILITIES RELOCATION PLAN - 20" OIL AND FIBER OPTIC DUCTS
UT-D1930	PROPOSED UTILITIES RELOCATION PLAN - 20" OIL AND FIBER OPTIC DUCTS
UT-D1931	PROPOSED UTILITIES RELOCATION PLAN - 20" OIL AND FIBER OPTIC DUCTS
UT-D1932	PROPOSED UTILITIES RELOCATION PLAN - 20" OIL AND FIBER OPTIC DUCTS
UT-D1933	PROPOSED UTILITIES RELOCATION PLAN - 20" OIL AND FIBER OPTIC DUCTS
UT-D1934	PROPOSED UTILITIES RELOCATION PLAN - 20" OIL AND FIBER OPTIC DUCTS
UT-D1935	PROPOSED UTILITIES RELOCATION PLAN - 20" OIL AND FIBER OPTIC DUCTS
UT-D1936	PROPOSED UTILITIES RELOCATION PLAN - 20" OIL AND FIBER OPTIC DUCTS
UT-D1937	PROPOSED UTILITIES RELOCATION PLAN - 20" OIL AND FIBER OPTIC DUCTS
UT-D1938	PROPOSED UTILITIES RELOCATION PLAN - 20" OIL AND FIBER OPTIC DUCTS
UT-D1939	PROPOSED UTILITIES RELOCATION PLAN - 20" OIL AND FIBER OPTIC DUCTS
UT-D1940	PROPOSED UTILITIES RELOCATION PLAN - 20" OIL AND FIBER OPTIC DUCTS
UT-D1941	PROPOSED UTILITIES RELOCATION PLAN - 20" OIL AND FIBER OPTIC DUCTS
UT-D3942	PROPOSED UTILITIES RELOCATION PLAN - TYPICAL CROSS SECTIONS
UT-D7011	FINAL ROAD REALIGNMENT - VANOWEN ST PROPOSED UTILITY REOCATION PLAN
UT-D7012	FINAL ROAD REALIGNMENT - VANOWEN ST ROAD IMPACT PLAN
UT-D7021	PROPOSED UTILITIES RELOCATION PLAN - BUENA VISTA GRADE CROSSING
UT-D7022	PROPOSED UTILITIES RELOCATION PROFILE - BUENA VISTA GRADE CROSSING
UT-D7031	PROPOSED UTILITIES RELOCATION PLAN - VICTORY PLACE UNDERPASS
UT-D7032	PROPOSED UTILITIES RELOCATION PROFILE - VICTORY PLACE UNDERPASS
UT-D7041	PROPOSED UTILITIES RELOCATION PLAN - BURBANK BLVD OVERPASS
UT-D7042	PROPOSED UTILITIES RELOCATION PROFILE - BURBANK BLVD OVERPASS
UT-D7051	PROPOSED UTILITIES RELOCATION PLAN - SOUTH FLOWER EXTENSION ROAD
UT-D7071	PROPOSED UTILITIES RELOCATION PLAN - SONORA AVE UNDERPASS HYBRID
UT-D7072	PROPOSED UTILITIES RELOCATION PROFILE - SONORA AVE UNDERPASS HYBRID
UT-D7081	PROPOSED UTILITIES RELOCATION PLAN - GRANDVIEW AVE UNDERPASS HYBRID
UT-D7082	PROPOSED UTILITIES RELOCATION PROFILE - GRANDVIEW AVE UNDERPASS HYBRID

	UTILITIES
DRAWING NO.	DRAWING TITLE
UT- <b>D</b> 7091	PROPOSED UTILITIES RELOCATION PLAN - FLOWER ST UNDERPASS HYBRID SHEET 1 OF 2
UT- <b>D</b> 7092	PROPOSED UTILITIES RELOCATION PLAN - FLOWER ST UNDERPASS HYBRID SHEET 2 OF 2
UT-D7111	PROPOSED UTILITIES RELOCATION PLAN - GOODWIN AVE UNDERPASS SHEET 1 OF 2
UT- <b>D</b> 7112	PROPOSED UTILITIES RELOCATION PLAN - GOODWIN AVE UNDERPASS SHEET 2 OF 2
UT-D7113	PROPOSED UTILITIES RELOCATION PLAN - GOODWIN AVE UNDERPASS
UT-D7114	PROPOSED UTILITIES RELOCATION PROFILE - CHEVY CHASE DR PEDESTRIAN OVERPASS
UT- <b>D</b> 7121	PROPOSED UTILITIES RELOCATION PLAN - LOS FELIZ AVE UNDERPASS
UT- <b>D</b> 7122	PROPOSED UTILITIES RELOCATION PROFILE - LOS FELIZ AVE UNDERPASS
UT-D7131	PROPOSED UTILITIES RELOCATION PLAN - GLENDALE BLVD UNDERPASS
UT-D7141	PROPOSED UTILITIES RELOCATION PLAN - KERR RD (CMF ACCESS) UNDERPASS SHEET 1 OF 2
UT-D7142	PROPOSED UTILITIES RELOCATION PLAN - CMF ACCESS UNDERPASS SHEET 2 OF 2
UT-D7143	PROPOSED UTILITIES RELOCATION PLAN - CMF ACCESS UNDERPASS SHEET 3 OF 3
UT-D7144	PROPOSED UTILITIES RELOCATION PROFILE - CMF ACCESS UNDERPASS
UT-D7151	PROPOSED UTILITIES RELOCATION PLAN - MAIN STREET OVERPASS SHEET 1 OF 4
UT- <b>D</b> 7152	PROPOSED UTILITIES RELOCATION PLAN - MAIN STREET OVERPASS SHEET 2 OF 4
UT-D7153	PROPOSED UTILITIES RELOCATION PLAN - MAIN STREET OVERPASS SHEET 3 OF 4
UT-D7154	PROPOSED UTILITIES RELOCATION PLAN - MAIN STREET OVERPASS SHEET 4 OF 4
UT- <b>D</b> 7155	PROPOSED UTILITIES RELOCATION PLAN - MAIN STREET PROFILE

	GRADING & DRAINAGE
DRAWING NO.	DRAWING TITLE
CV-G1101	GRADING AND DRAINAGE STA HSR2 3026+28.25 TO STA HSR2 3034+00
CV-G1101A	GRADING AND DRAINAGE STA HSR2 3034+00 TO STA HSR2 3047+00
CV-G1101B	GRADING AND DRAINAGE STA HSR2 3047+00 TO STA HSR2 3060+00
CV-G1102	GRADING AND DRAINAGE STA HSR2 3060+00 TO STA HSR2 3073+00
CV-G1103	GRADING AND DRAINAGE STA HSR2 3073+00 TO STA HSR2 3086+00
CV-G1104	GRADING AND DRAINAGE STA HSR2 3086+00 TO STA HSR2 3099+00
CV-G1105	GRADING AND DRAINAGE STA HSR2 3099+00 TO STA HSR2 3112+00
CV-G1106	GRADING AND DRAINAGE STA HSR2 3112+00 TO STA HSR2 3125+00
CV-G1107	GRADING AND DRAINAGE STA HSR2 3125+00 TO STA HSR2 3138+00
CV-G1108	GRADING AND DRAINAGE STA HSR2 3138+00 TO STA HSR2 3151+00
CV-G1109	GRADING AND DRAINAGE STA HSR2 3151+00 TO STA HSR2 3164+00
CV-G1110	GRADING AND DRAINAGE STA HSR2 3164+00 TO STA HSR2 3177+00
CV-G1111	GRADING AND DRAINAGE STA HSR2 3177+00 TO STA HSR2 3190+00
CV-G1112	GRADING AND DRAINAGE STA HSR2 3190+00 TO STA HSR2 3203+00
CV-G1113	GRADING AND DRAINAGE STA HSR2 3203+00 TO STA HSR2 3216+00
CV-G1114	GRADING AND DRAINAGE STA HSR2 3216+00 TO STA HSR2 3229+00
CV-G1115	GRADING AND DRAINAGE STA HSR2 3229+00 TO STA HSR2 3242+00
CV-G1116	GRADING AND DRAINAGE STA HSR2 3242+00 TO STA HSR2 3255+00
CV-G1117	GRADING AND DRAINAGE STA HSR2 3255+00 TO STA HSR2 3268+00
CV-G1118	GRADING AND DRAINAGE STA HSR2 3268+00 TO STA HSR2 3281+00
CV-G1119	GRADING AND DRAINAGE STA HSR2 3281+00 TO STA HSR2 3294+00

						DESIGNED BY
						DRAWN BY
						CHECKED BY
						C. LEE
						C. LEE
REV	DATE	ВΥ	СНК	APP	DESCRIPTION	DATE 08/27/2021

PEPD RECORD SET NOT FOR CONSTRUCTION





## CALIFORNIA HIGH-SPEED TRAIN PROJECT BURBANK TO LOS ANGELES

OPTION B REVISED ALIGNMENT - REVISED FINAL PEPD INDEX OF DRAWINGS VOLUME 3.4 - SHEET 3 OF 4

CONTRACT NO. HSR14-39
DRAWING NO. GE-A0413
SCALE NO SCALE

SHEET NO.

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## VOLUME 3.4 - GENERAL, UTILITIES, GRADING & DRAINAGE, TRACTION POWER, COMMUNICATION TOWERS, TRAIN CONTROL & SYSTEM SUPPORT FACILITIES

	GRADING & DRAINAGE
DRAWING NO.	DRAWING TITLE
CV-G1120	GRADING AND DRAINAGE STA HSR2 3294+00 TO STA HSR2 3307+00
CV-G1121	GRADING AND DRAINAGE STA HSR2 3307+00 TO STA HSR2 3320+00
CV-G1122	GRADING AND DRAINAGE STA HSR2 3320+00 TO STA HSR2 3333+00
CV-G1123	GRADING AND DRAINAGE STA HSR2 3333+00 TO STA HSR2 3346+00
CV-G1124	GRADING AND DRAINAGE STA HSR2 3346+00 TO STA HSR2 3359+00
CV-G1125	GRADING AND DRAINAGE STA HSR2 3359+00 TO STA HSR2 3372+00
CV-G1126	GRADING AND DRAINAGE STA HSR2 3372+00 TO STA HSR2 3385+00
CV-G1127	GRADING AND DRAINAGE STA HSR2 3385+00 TO STA HSR2 3398+00
CV-G1128	GRADING AND DRAINAGE STA HSR2 3398+00 TO STA HSR2 3411+00
CV-G1129	GRADING AND DRAINAGE STA HSR2 3411+00 TO STA HSR2 3424+00
CV-G1130	GRADING AND DRAINAGE STA HSR2 3424+00 TO STA HSR2 3437+00
CV-G1131	GRADING AND DRAINAGE STA HSR2 3437+00 TO STA HSR2 3450+00
CV-G1132	GRADING AND DRAINAGE STA HSR2 3450+00 TO STA HSR2 3463+00
CV-G1133	GRADING AND DRAINAGE STA HSR2 3463+00 TO STA HSR2 3476+00
CV-G1134	GRADING AND DRAINAGE STA HSR2 3476+00 TO STA HSR2 3489+00
CV-G1135	GRADING AND DRAINAGE STA HSR2 3489+00 TO STA HSR2 3502+00
CV-G1136	GRADING AND DRAINAGE STA HSR2 3502+00 TO STA HSR2 3515+00
CV-G1137	GRADING AND DRAINAGE STA HSR2 3515+00 TO STA HSR2 3528+00
CV-G1138	GRADING AND DRAINAGE STA HSR2 3528+00 TO STA HSR2 3541+00
CV-G1139	GRADING AND DRAINAGE STA HSR2 3541+00 TO STA HSR2 3554+00
CV-G1140	GRADING AND DRAINAGE STA HSR2 3554+00 TO STA HSR2 3567+00
CV-G1141	GRADING AND DRAINAGE STA HSR2 3567+00 TO STA HSR2 3580+00
CV-G1142	GRADING AND DRAINAGE STA HSR2 3580+00 TO STA HSR2 3593+00
CV-G1143	GRADING AND DRAINAGE STA HSR2 3593+00 TO STA HSR2 3606+00
CV-G1144	GRADING AND DRAINAGE STA HSR2 3606+00 TO STA HSR2 3619+00
CV-G1145	GRADING AND DRAINAGE STA HSR2 3619+00 TO STA HSR2 3632+00
CV-G1146	GRADING AND DRAINAGE STA HSR2 3632+00 TO STA HSR2 3645+00
CV-G1147	GRADING AND DRAINAGE STA HSR2 3645+00 TO STA HSR2 3658+00
CV-G1148	GRADING AND DRAINAGE STA HSR2 3658+00 TO STA HSR2 3671+00
CV-G1149	GRADING AND DRAINAGE STA HSR2 3671+00 TO STA HSR2 3684+00
CV-G1150	GRADING AND DRAINAGE STA HSR2 3684+00 TO STA HSR2 3697+00
CV-G3101	DRAINAGE TYPICAL SECTIONS
CV-G1301	GRADING AND DRAINAGE - LOCKHEED CHANNEL RELOCATION - SD 60+00 TO SD 72+00
CV-G1302	GRADING AND DRAINAGE - LOCKHEED CHANNEL RELOCATION - SD 72+00 TO SD 86+00
CV-G1303	GRADING AND DRAINAGE - LOCKHEED CHANNEL RELOCATION - SD 86+00 TO SD 100+00
CV-G1304	GRADING AND DRAINAGE - LOCKHEED CHANNEL RELOCATION - SD 100+00 TO SD 114+00
CV-G1305	GRADING AND DRAINAGE - LOCKHEED CHANNEL RELOCATION - SD 114+00 TO SD 123+33.38 & SD 58+20.01 TO 63+00
CV-G1306	GRADING AND DRAINAGE - LOCKHEED CHANNEL RELOCATION - SD 63+00 TO SD 77+00
CV-G1307	GRADING AND DRAINAGE - LOCKHEED CHANNEL RELOCATION - SD 77+00 TO SD 91+00
CV-G1308	GRADING AND DRAINAGE - LOCKHEED CHANNEL RELOCATION - SD 91+00 TO SD 105+00
ST-B3101	LOCKHEED CHANNEL MODIFICATION - CROSS SECTIONS
CV-G1400	GRADING AND DRAINAGE PROPOSED GOODWIN AVE STORM DRAIN REALIGNMENT

GRADING & DRAINAGE			
DRAWING NO.	DRAWING TITLE		
ST-B3421	GOODWIN AVE STORM DRAIN REALIGNMENT PLAN - CROSS SECTION		
CV-G6101	EARTHWORK QUANTITIES - SHEET 1 OF 6		
CV-G6102	EARTHWORK QUANTITIES - SHEET 2 OF 6		
CV-G6103	EARTHWORK QUANTITIES - SHEET 3 OF 6		
CV-G6104	EARTHWORK QUANTITIES - SHEET 4 OF 6		
CV-G6105	EARTHWORK QUANTITIES - SHEET 5 OF 6		
CV-G6106	EARTHWORK QUANTITIES - SHEET 6 OF 6		

	TRACTION POWER & COMMUNICATION
DRAWING NO.	DRAWING TITLE
TP-B0001	SYSTEM FACILITIES SITE PLAN
TP-04001	TRACTION POWER FACILITY SITE PLAN PROPOSED PARALLELING STATION
TP-04101	TRACTION POWER FACILITY SITE PLAN PROPOSED SWITCHING STATION
CO-F4001	COMMUNICATIONS SYSTEM SITE PLAN PROPOSED STANDALONE RADIO SITE - SHEET 1 OF 4
CO-F4002	COMMUNICATIONS SYSTEM SITE PLAN PROPOSED STANDALONE RADIO SITE - SHEET 2 OF 4
CO-F4003	COMMUNICATIONS SYSTEM SITE PLAN PROPOSED STANDALONE RADIO SITE - SHEET 3 OF 4
CO-F4004	COMMUNICATIONS SYSTEM SITE PLAN PROPOSED STANDALONE RADIO SITE - SHEET 4 OF 4

	AUTOMATIC TRAIN CONTROL
TC-B0001	HSR TRAIN CONTROL - INTERLOCKING SITE KEY MAP
TC-B0102	NON-HSR TRAIN CONTROL - NON HSR SIGNAL HOUSE KEY MAP
TC-04001	HSR TRAIN CONTROL SYSTEM - PROPOSED INTERLOCKING SITE - SHEET 1 OF 9
TC-04002	HSR TRAIN CONTROL SYSTEM - PROPOSED INTERLOCKING SITE - SHEET 2 OF 9
TC-04003	HSR TRAIN CONTROL SYSTEM - PROPOSED INTERLOCKING SITE - SHEET 3 OF 9
TC-04004	HSR TRAIN CONTROL SYSTEM - PROPOSED INTERLOCKING SITE - SHEET 4 OF 9
TC-04005	HSR TRAIN CONTROL SYSTEM - PROPOSED INTERLOCKING SITE - SHEET 5 OF 9
TC-04006	HSR TRAIN CONTROL SYSTEM - PROPOSED INTERLOCKING SITE - SHEET 6 OF 9
TC-04007	HSR TRAIN CONTROL SYSTEM - PROPOSED INTERLOCKING SITE - SHEET 7 OF 9
TC-04008	HSR TRAIN CONTROL SYSTEM - PROPOSED INTERLOCKING SITE - SHEET 8 OF 9
TC-04009	HSR TRAIN CONTROL SYSTEM - PROPOSED INTERLOCKING SITE - SHEET 9 OF 9
TC-04101	NON-HSR TRAIN CONTROL PROPOSED SIGNAL HOUSE SITE - SHEET 1 OF 10
TC-04102	NON-HSR TRAIN CONTROL PROPOSED SIGNAL HOUSE SITE - SHEET 2 OF 10
TC-04103	NON-HSR TRAIN CONTROL PROPOSED SIGNAL HOUSE SITE - SHEET 3 OF 10
TC-04104	NON-HSR TRAIN CONTROL PROPOSED SIGNAL HOUSE SITE - SHEET 4 OF 10
TC-04105	NON-HSR TRAIN CONTROL PROPOSED SIGNAL HOUSE SITE - SHEET 5 OF 10
TC-04106	NON-HSR TRAIN CONTROL PROPOSED SIGNAL HOUSE SITE - SHEET 6 OF 10
TC-D4107	NON-HSR TRAIN CONTROL PROPOSED SIGNAL HOUSE SITE - SHEET 7 OF 10
TC-D4108	NON-HSR TRAIN CONTROL PROPOSED SIGNAL HOUSE SITE - SHEET 8 OF 10
TC-D4109	NON-HSR TRAIN CONTROL PROPOSED SIGNAL HOUSE SITE - SHEET 9 OF 10
TC-D4110	NON-HSR TRAIN CONTROL PROPOSED SIGNAL HOUSE SITE - SHEET 10 OF 10

						DESIGNED BY C. CUSSON DRAWN BY C. CUSSON CHECKED BY C. LEE
REV	DATE	BY	СНК	APP	DESCRIPTION	IN CHARGE C. LEE DATE 08/27/2021

PEPD RECORD SET NOT FOR CONSTRUCTION





## CALIFORNIA HIGH-SPEED TRAIN PROJECT BURBANK TO LOS ANGELES

OPTION B REVISED ALIGNMENT - REVISED FINAL PEPD INDEX OF DRAWINGS VOLUME 3.4 - SHEET 4 OF 4

CONTRACT NO.
HSR14-39
DRAWING NO.
GE - AO414
SCALE
NO SCALE
SHEET NO.

GENERAL							
DRAWING NO.	DRAWING TITLE						
GE-A0500	COVER SHEET VOLUME 3.5						
GE-A0501	PROJECT LOCATION MAP VOLUME 3.5						
GE-A0510	INDEX OF VOLUMES						
GE-A0511	INDEX OF DRAWINGS VOLUME 3.5						
GE-D0501	VOLUME 3.5 - KEY MAP STATIONS AND TRACKSIDE ACCESS						
GE-B0501	BASIS OF DESIGN SUMMARY						
GE-C0501	ACRONYMS AND ABBREVIATIONS - SHEET 1 OF 5						
GE-C0502	ACRONYMS AND ABBREVIATIONS - SHEET 2 OF 5						
GE-C0503	ACRONYMS AND ABBREVIATIONS - SHEET 3 OF 5						
GE-C0504	ACRONYMS AND ABBREVIATIONS - SHEET 4 OF 5						
GE-C0505	ACRONYMS AND ABBREVIATIONS - SHEET 5 OF 5						
GE-C0511	SYMBOLS - SHEET 1 OF 2						
GE-C0512	SYMBOLS - SHEET 2 OF 2						
GE-B0511	GENERAL NOTES						
GE-D6501	TRACK SCHEMATIC						

	MAINTENANCE FACILITIES				
DRAWING NO.	DRAWING TITLE				
MY-D1101	CMF TRACK PLAN - SHEET 1 OF 4				
MY-D1102	CMF TRACK PLAN - SHEET 2 OF 4				
MY-D1103	CMF TRACK PLAN - SHEET 3 OF 4				
MY-D1104	CMF TRACK PLAN - SHEET 4 OF 4				
MY-D1201	CMF TRACK PROFILE - SHEET 1 OF 2				
MY-D1202	CMF TRACK PROFILE - SHEET 2 OF 2				
TT-E6118	CMF HORIZONTAL ALIGNMENT DATA - SHEET 1 OF 8				
TT-E6119	CMF HORIZONTAL ALIGNMENT DATA - SHEET 2 OF 8				
TT-E6120	CMF HORIZONTAL ALIGNMENT DATA - SHEET 3 OF 8				
TT-E6121	CMF HORIZONTAL ALIGNMENT DATA - SHEET 4 OF 8				
TT-E6122	CMF HORIZONTAL ALIGNMENT DATA - SHEET 5 OF 8				
TT-E6123	CMF HORIZONTAL ALIGNMENT DATA - SHEET 6 OF 8				
TT-E6124	CMF HORIZONTAL ALIGNMENT DATA - SHEET 7 OF 8				
TT-E6125	CMF HORIZONTAL ALIGNMENT DATA - SHEET 8 OF 8				
UT-C1001	CMF COMPOSITE UTILITIES PLAN - SHEET 1 OF 4				
UT-C1002	CMF COMPOSITE UTILITIES PLAN - SHEET 2 OF 4				
UT-C1003	CMF COMPOSITE UTILITIES PLAN - SHEET 3 OF 4				
UT-C1004	CMF COMPOSITE UTILITIES PLAN - SHEET 4 OF 4				

## **VOLUME 3.5 - GENERAL, MAINTENANCE FACILITIES & TRACKSIDE ACCESS**

	MAINTENANCE FACILITIES				
DRAWING NO.	DRAWING TITLE				
UT-D1640	CMF PROPOSED UTILITY RELOCATION PLAN - SHEET 1 OF 4				
UT-D1641	CMF PROPOSED UTILITY RELOCATION PLAN - SHEET 2 OF 4				
UT-D1642	CMF PROPOSED UTILITY RELOCATION PLAN - SHEET 3 OF 4				
UT-D1643	CMF PROPOSED UTILITY RELOCATION PLAN - SHEET 4 OF 4				
MY-D1001	CMF SITE CROSS SECTIONS - SHEET 1 OF 2				
MY-D1002	CMF SITE CROSS SECTIONS - SHEET 2 OF 2				
CV-R1101	ROADWAY - SHEET 1 OF 4				
CV-R1102	ROADWAY - SHEET 2 OF 4				
CV-R1103	ROADWAY - SHEET 3 OF 4				
CV-R1104	ROADWAY - SHEET 4 OF 4				
CV-S1101	CMF SITE IMPROVEMENTS - SHEET 1 OF 4				
CV-S1102	CMF SITE IMPROVEMENTS - SHEET 2 OF 4				
CV-S1103	CMF SITE IMPROVEMENTS - SHEET 3 OF 4				
CV-S1104	CMF SITE IMPROVEMENTS - SHEET 4 OF 4				
CV-D1101	CMF DEMOLITION - SHEET 1 OF 4				
CV-D1102	CMF DEMOLITION - SHEET 2 OF 4				
CV-D1103	CMF DEMOLITION - SHEET 3 OF 4				
CV-D1104	CMF DEMOLITION - SHEET 4 OF 4				

	TRACKSIDE ACCESS & EMERGENCY ACCESS				
DRAWING NO.	DRAWING TITLE				
CV-S5100	VEHICLE TRACK ACCESS - LOCATION PLAN				
CV-S5101	VEHICLE TRACK ACCESS - BUENA VISTA ST / LINCOLN ST HSR STA 3095+01				
CV-S5102	VEHICLE TRACK ACCESS - UPRR WYE TRACKS HSR STA 3161+20				
CV-S5103	VEHICLE TRACK ACCESS - ALLEN AVE HSR STA 3224+00				
CV-S5104	VEHICLE TRACK ACCESS - DORAN ST HSR STA 3325+00				
CV-S5105	VEHICLE TRACK ACCESS - GOODWIN AVE HSR 3387+00				
CV-S5106	VEHICLE TRACK ACCESS - VERDANT ST HSR STA 3412+60				
CV-S5107	VEHICLE TRACK ACCESS - MAIN ST HSR STA 3683+00				

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						CHECKED BY	1
						C. LEE IN CHARGE	ł
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REV	DATE	BY	СНК	APP	DESCRIPTION	08/27/2021	

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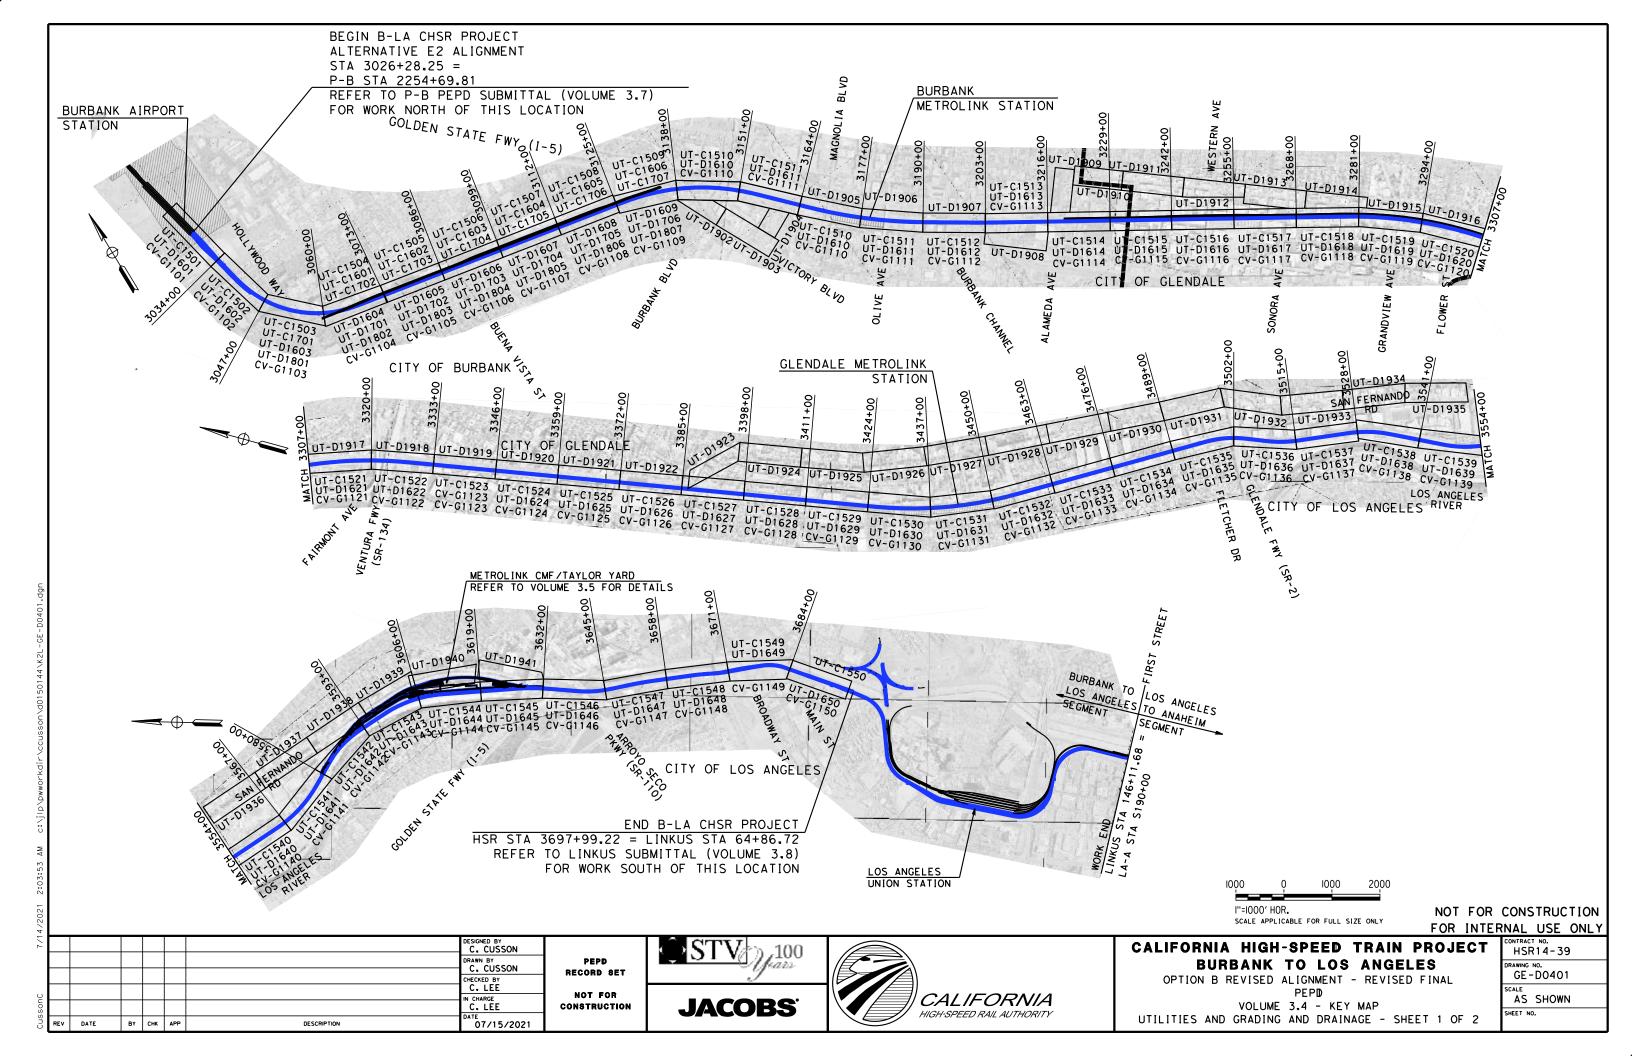
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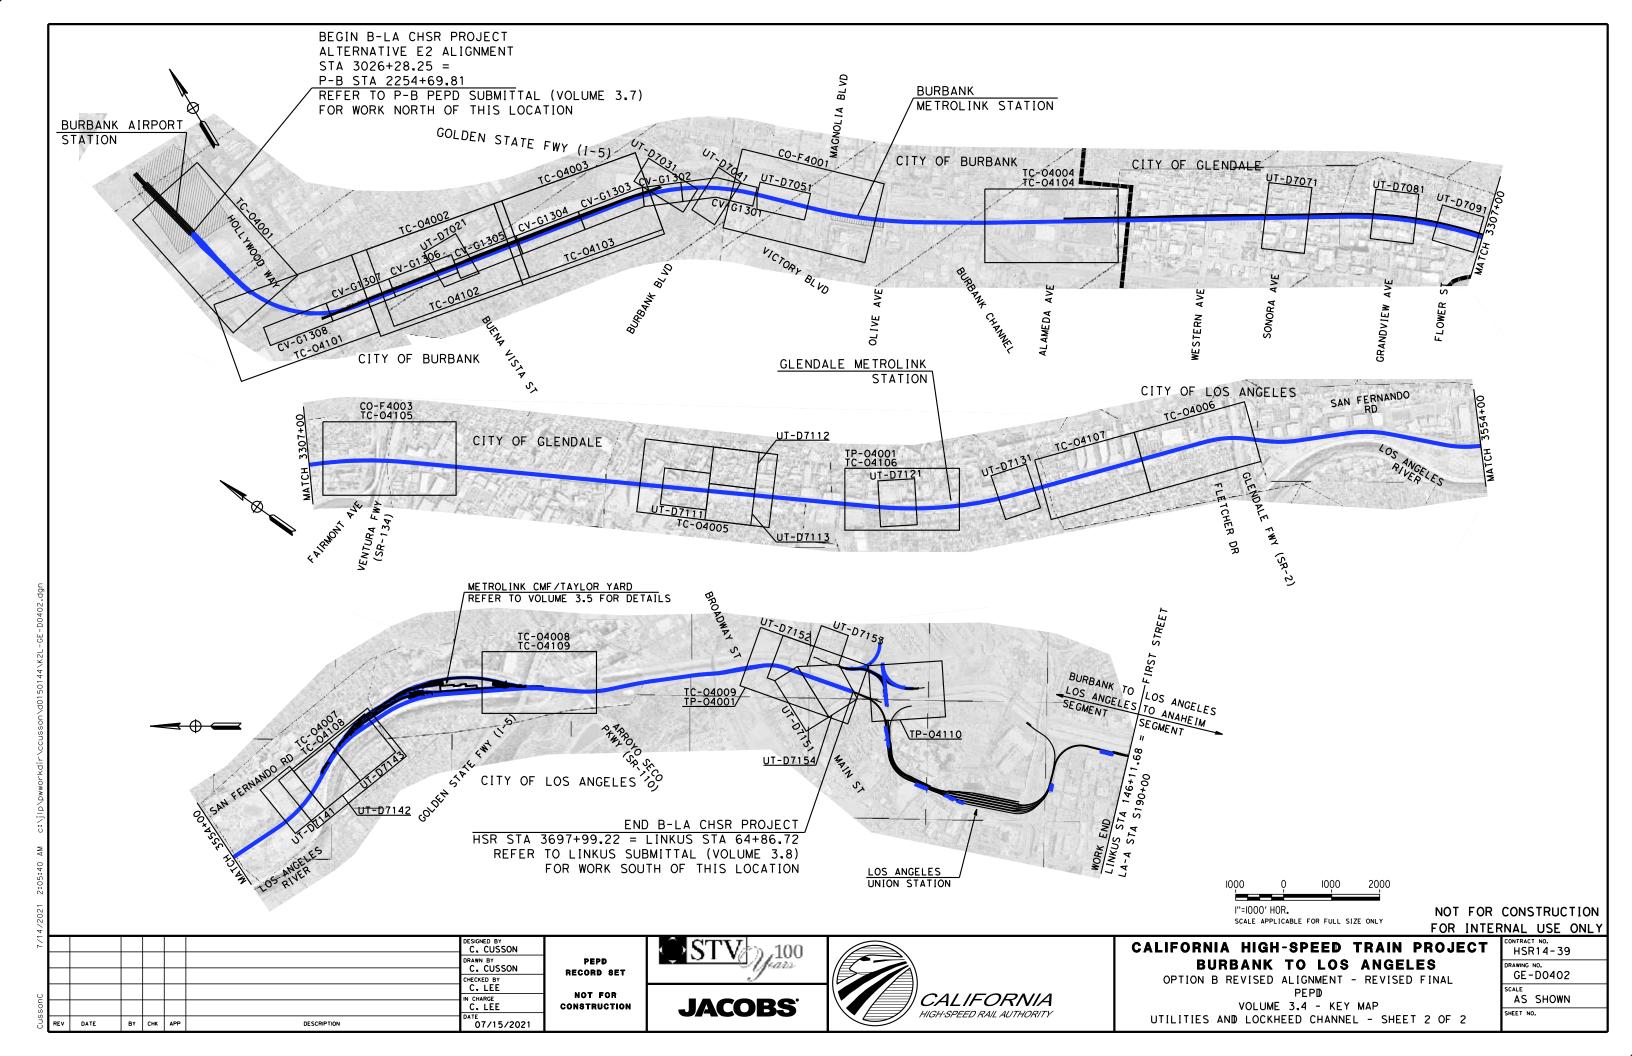




## CALIFORNIA HIGH-SPEED TRAIN PROJECT BURBANK TO LOS ANGELES

OPTION B REVISED ALIGNMENT - REVISED FINAL PEPD INDEX OF DRAWINGS VOLUME 3.5 - SHEET 1 OF 1 CONTRACT NO.
HSR14-39
DRAWING NO.
GE-A0511
SCALE
NO SCALE
SHEET NO.





#### **BASIS OF DESIGN SUMMARY**

#### THE BURBANK TO LOS ANGELES (B-LA) SEGMENT BEGINS SOUTH OF THE PROPOSED 5. ACCESS CONTROL BURBANK AIRPORT STATION IN A SUBSURFACE DEDICATED CORRIDOR, RUNS ALONG

THE B-LA CORRIDOR WILL BE FENCED WITH NO AT-GRADE CROSSINGS. INTRUSION PROTECTION AND/OR INTRUSION MONITORING WILL BE EMPLOYED WITH MITIGATIONS AS REQUIRED TO PROMOTE SAFE AND RELIABLE OPERATION.

#### TRACK ALIGNMENT

THE B-LA CORRIDOR IS PLANNED TO OPERATE AS A CLASS 7 SERVICE (SPEEDS UP TO 125 MPH) WITH NO AT-GRADE ROADWAY CROSSINGS.

#### 7. INTRUSION PROTECTION

INTRUSION DETECTION WILL BE PROVIDED AT LOCATIONS WHERE IT IS APPROPRIATE TO MITIGATE AN INTRUSION HAZARD BASED ON HAZARD ASSESSMENT AND REQUIREMENTS OF ADJACENT RAILROAD (UPRR).

#### THE BASIS OF DESIGN ELEMENTS THAT DIFFER BETWEEN BLENDED OPERATION AND 8. TERMINAL AND INTERMEDIATE STATION(S)

THE FOLLOWING STATION IN THE CORRIDOR IS DESIGNATED AS A TERMINAL STATION:

BURBANK AIRPORT STATION & LOS ANGELES UNION STATION

THERE WILL BE NO INTERMEDIATE HIGH SPEED RAIL STATION

#### 9. TRACK AND PLATFORM CONFIGURATION

STATION PASSENGER PLATFORMS ARE PLANNED FOR A LENGTH OF APPROXIMATELY 1410 FEET TO ACCOMMODATE A RANGE OF HIGH-SPEED TRAINSETS.

#### 10. VEHICLE STORAGE AND MAINTENANCE

UNDER CURRENT OPERATING ASSUMPTION, FLEET STORAGE, CLEANING, SERVICING, INSPECTION, MAINTENANCE, AND REPAIR REQUIREMENTS WILL BE SUPPORTED AT:

TERMINAL STORAGE AND MAINTENANCE FACILITY (LEVEL 1) THAT PROVIDES IN-SERVICE INSPECTION, CLEANING AND MAINTENANCE WITH A LOCATION IN PROXIMITY TO LOS ANGELES UNION STATION

STORAGE TRACKS FOR OVERNIGHT LAYUP AT LOS ANGELES UNION STATION.

CURRENT DESIGNS TO BE MODIFIED PER UPCOMING DISCUSSION WITH RDP.

#### 11. ADJACENT RAIL OPERATIONS

IN THE BURBANK TO LOS ANGELES CORRIDOR, THE AUTHORITY WILL OPERATE IN A SHARED RIGHT-OF-WAY CORRIDOR AND WILL SHARE TRACKS WITH OTHER PASSENGER TRAINS SOUTH OF DOWNTOWN BURBANK METROLINK STATION. FREIGHT TRAINS WILL NOT OPERATE ON HSR ELECTRIFIED TRACKS.

#### 12. SHARED RIGHT OF WAY (ROW)

GENERALLY, THE RIGHT-OF-WAY IS OWNED BY LA METRO ON THE VALLEY AND VENTURA SUBDIVSIONS, AND IS OWNED PARTIALLY BY THE FREIGHT RAILROAD (UPRR) ON THE VENTURA LINE. PASSENGER AND FREIGHT OPERATIONS OCCUR SIMULTANEOUSLY THROUGHOUT THE DAY ON PARALLEL ALIGNMENTS.

TRACK SEPARATION AND INTRUSION PROTECTION, AS DETERMINED THROUGH RISK-BASED ANALYSIS, WILL BE PROVIDED.

#### 13. DIAMOND (AT-GRADE) CROSSINGS

THE USE OF "OWL" DIAMOND CROSSINGS WILL BE NOT ALLOWED DUE TO HIGH VOLUME OF CROSSING TRACKS. THE HSR TRACKS WILL RUN ALONGSIDE THE WESTERN SIDE OF THE CMF BUILDING TO AVOID DIAMOND CROSSINGS.

#### 14. STRUCTURAL DESIGN

A.PEPD STRUCTURE DESIGN WILL BE BASED ON CHSTP CP 2-3 DESIGN CRITERIA MANUAL REV 2 DATED FEBRUARY, 2014.

B.DESIGN LIFE = 100 YEARS

#### 15. EXISTING PRIMARY TYPE 2 OVERHEAD STRUCTURES

A. WILL MEET THE NON-COLLAPSE PERFORMANCE FOR MAXIMUM CONSIDERED EARTHQUAKE (MCE).

B. TO REMAIN ELASTIC FOR OBE SPECTRA.

#### SYSTEM REQUIREMENTS

#### 1. SYSTEMS

DESIGN ELEMENTS RELATED TO ELECTRIFICATION/TRACTION POWER SUPPLY SYSTEM (TPSS), TRAIN CONTROL SYSTEMS AND COMMUNICATIONS ARE NOT PART OF THIS CONTRACT AND THESE DESIGN ELEMENTS WILL BE DESIGNED BY OTHERS.

ELEMENT LOCATIONS WILL BE DEFINED AS PART OF THIS CONTRACT.

NOT FOR CONSTRUCTION FOR INTERNAL USE ONLY

#### C. LEE C. CUSSON C. LEE N CHARGE CONSTRUCTION 08/27/2021 DATE BY CHK APP DESCRIPTION

THE VENTURA AND VALLEY SUBDIVISIONS IN A SHARED CORRIDOR, AND ENDS AT

LOS ANGELES UNION STATION (LAUS). FOR THE B-LA-A SEGMENT (LOSSAN CORRIDOR),

TO 'BLEND'HIGH SPEED WITH EXISTING RAIL SYSTEMS ON SHARED INFRASTRUCTURE

TO ACCELERATE AND BROADEN BENEFITS, IMPROVE EFFICIENCY, MINIMIZE COMMUNITY IMPACTS AND REDUCE CONSTRUCTION COST, THE TECHNICAL REQUIREMENTS NECESSARY

TO ALLOW JOINT OPERATION OF HIGH-SPEED RAIL, CONVENTIONAL PASSENGER RAIL, AND FREIGHT RAIL WITHIN THE BLENDED SYSTEM CORRIDOR BETWEEN BURBANK AND

1. TECHNICAL MEMORANDUM (TM) 0.3.1 BASIS OF DESIGN FOR BLENDED

OPERATION IN THE LA-A CORRIDOR, RO DATED MARCH 30, 2015.

TECHNICAL MEMORANDUM 0.3, BASIS OF DESIGN POLICY DOCUMENT,

THE DEDICATED HIGH-SPEED OPERATION ARE DEFINED IN THE TM 0.3.1. IT

IN ADDITION, THE FOLLOWING DESIGN POLICY MEMOS HAVE BEEN INITIATED

THE AUTHORITY HAS ESTABLISHED PERFORMANCE REQUIREMENTS TO GUIDE THE

THE REQUIREMENTS FOR MAJOR DESIGN ELEMENTS ARE LISTED BELOW:

THE RAILROAD OPERATORS AND RIGHT-OF-WAY OWNERS ARE:

DESIGN SPEED: MAXIMUM ALLOWED PER EXISTING ALIGNMENT/ROW CONSTRAINTS WITH A SPEED NOT TO EXCEED MAXIMUM OF 125 MPH.

NORTH OF CMF ACCESS ROAD, AND FROM DOWNEY BRIDGE TO LAUS,

THERE WILL BE NO AT-GRADE CROSSINGS IN THE B-LA SEGMENT. ALL

INTERSECTIONS WILL BE GRADE SEPARATED OR CLOSED.

16'-6" MINIMUM, EXCEPT FOR 15'-0" MINIMUM BETWEEN I-5 AND SR-134,

DEVELOPMENT OF THE HIGH-SPEED RAIL SYSTEM IN BLENDED CORRIDORS BASED ON THE FRA TIER STRUCTURE FOR PASSENGER SYSTEMS DESCRIBED IN THE

REQUIRED LEVEL OF INTEROPERABILITY BETWEEN THE PASSENGER AND

FREIGHT RAILROADS THAT OPERATE IN THE B-LA CORRIDOR WILL BE

IN ORDER TO ADDRESS THE REQUIREMENTS OF THE VARIOUS DESIGN ELEMENTS

THAT ARE NOT COVERED IN DETAIL IN THE TM 0.3.1 AND ARE BEING REVIEWED

SPECIFICALLY FOCUSES ON OBJECTIVES, PROCESSES, REQUIREMENTS, AND

ASSUMPTIONS THAT SUPPORT THE BLENDED OPERATION.

"HIGH-SPEED PASSENGER RAIL SAFETY STRATEGY (2009)."

LOS ANGELES UNION STATION (LAUS) ARE BASED ON:

R3 DATED JUNE 21, 2013

BY THE AUTHORITY.

INTEROPERABILITY

MAINTAINED.

AUTHORITY METROLINK

UNION PACIFIC RAILROAD

AMTRAK

3. TRACK CENTER SPACING

4. AT-GRADE CROSSING

2. DESIGN SPEEDS

INFRASTRUCTURE REQUIREMENTS

THE CALIFORNIA HIGH-SPEED RAIL AUTHORITY (AUTHORITY) HAS ADOPTED A STRATEGY

PEPD RECORD SET NOT FOR





CALIFORNIA HIGH-SPEED TRAIN PROJECT BURBANK TO LOS ANGELES

OPTION B REVISED ALIGNMENT - REVISED FINAL BASIS OF DESIGN SUMMARY

HSR14-39

GE-B0401 NO SCALE

SHEET NO.

	<u> </u>	(	B CONTINUED		(C CONTINUED)		(D CONTINUED)
@ AADT	AT AVERAGE ANNUAL DAILY TRAFFIC	BDP	BRIDGE DESIGN DETAILS (CALTRANS) BRIDGE DESIGN PRACTICE (CALTRANS)	CG CGS	CENTER OF GRAVITY CALIFORNIA GEOLOGICAL SURVEY	DBL DC	DOUBLE DIRECT CURRENT
AB	AGGREGATE BASE, ANCHOR BOLT	BDS BEC	BRIDGE DESIGN SPECIFICATIONS (CALTRANS) BURIED EARTH (GROUND) CONDUCTOR	CHNL CI	CHANNEL CAST IRON	DCMB DCP	DC DISTRIBUTION PANEL MAIN BREAKER DC DISTRIBUTION PANEL
ABBC ABM	ASBESTOS BONDED BITUMINOUS COATED AIR-BLOWN MORTAR	BEG BFA	BEGIN BYPASS FEEDER ANCHOR	CIC	COMMUNICATIONS INTERFACE CABINET CAST-IN-DRILLED-HOLE	DD	DOWNDRAIN, DEVICE DRIVER
ABN ABUT ABV	ABANDON ABUTMENT ABOVE	BITUM	BASIC IMPULSE INSULATION LEVEL BITUMINOUS BIKE LANE	CIF CIP C-I-P	COMMON INTERMEDIATE FORMAT CAST IRON PIPE CAST-IN-PLACE	DE L DEMO	DEAD END DELINEATOR DEMOLISH
AC	ABOVE ALTERNATING CURRENT, ASPHALT CONCRETE	BK	BACK BACKFILL	CIPCP CIS	CAST-IN-PLACE CAST-IN-PLACE CONCRETE PIPE CUSTOMER INFORMATION SIGN	DEMO DEPT DET	DEPARTMENT DE PARTMENT DE TOUR
ACB ACMB	ASPHALT CONCRETE BASE AC DISTRIBUTION PANEL MAIN BREAKER	BKR	BREAKER BASELINE	ciss cu	CAST-IN-STEEL-SHELL CONSTRUCTION JOINT	DF	DIRECT FIXATION, DRINKING FOUNTAIN
ACOUS ACP	ACOUSTICAL ASBESTOS CEMENT PIPE	BLDG BLKG	BUILDING BLOCKING	CJP CKT	COMPLETE JOINT PENETRATION CIRCUIT	DGA DHV	DOWN GUY ANCHOR DESIGN HOURLY VOLUME
ACR ACSR	ACCESS CONTROL ROOM ALUMINUM CONDUCTOR STEEL REINFORCED	BLST	BRIDGE-LOG MILE BALLAST	CL CL2	CLASS, CEMENT LINED CLASS 2	DI DIAG	DRAINAGE INLET DIAGONAL
AD ADJ	AREA DRAIN ADJACENT,	ВМ	BOULEVARD BENCHMARK	CL-6 CLG	CHAIN LINK FENCE (6 FT) CEILING	DIAPH DIFF	DIAPHRAGM DIFFERENTIAL
ADL	ADJUST, ADJUSTABLE ADDED DEAD LOAD	BN BND BOC	BACKBONE NETWORK BOUND BOTTOM OF CURB	CLK CLKG CLO	CHAIN LINK CAULKING CLOSET	DIM DIN DIP	DIMENSION DROP INLET DUCTILE IRON PIPE
ADP ADT	AC DISTRIBUTION PANEL AVERAGE DAILY TRAFFIC	BOCC BOS	BACK-UP OPERATIONAL CONTROL CENTER BOTTOM OF SLOPE	CLR	CLEAD	חוח	DIRECTION DISCONNECT
A&E AEC	ARCHITECTURAL AND ENGINEERING AERIAL EARTH (GROUND) CONDUCTOR	ВОТ	BOTTOM BOTTOM OF WALL	СМ	CONTROL MODULE, CORRUGATED METAL	DISP DIST	DISPENSER DISTANCE
AED AFC	AUTOMATED EXTERNAL DEFIBRILLATOR AUTOMATIC FARE COLLECTION	BR	BRIDGE, BRIDGE CURVE	CMF CMP	CENTRAL MAINTENANCE FACILITY CORRUGATED METAL PIPE	DISTR DMBB	DISTRIBUTION DOUBLE METAL BEAM BARRIER
AFES A/G	ALTERNATIVE FLARED END SECTION AT-GRADE	BRG BRKT	BEARING BRACKET	CMU CNTR	CLEAR, CLEARANCE CONTROL MODULE, CORRUGATED METAL CENTRAL MAINTENANCE FACILITY CORRUGATED METAL PIPE CONCRETE MASONRY UNIT COUNTER CLEANOUT, COUNTY	DN DNS	DOWN DOMAIN NAME SYSTEM
AGW AHD AL	AERIAL GROUND WIRE AHEAD ALUMINUM	BRS BRT BS	BROADBAND RADIO SYSTEM BUS RAPID TRANSIT BODY SPAN WIRE	COL	CLEANOUT, COUNTY COLUMN	DO DPDT DR	DOOR OPENING DOUBLE-POLE DOUBLE-THROW DRIVE
AL IGN AL T	ALIGNMENT ALIENATE	BSC	BASE STATION CONTROLLER BODY SPAN	COMM CONC	COMMUNICATIONS CONCRETE	DS	DOWNSPOUT, DISCONNECT SWITCH
AM ANC	ANTE MERIDIEM (TIME FROM MIDNIGHT TO NOON) ANCHOR	BT BTM	BUS TIE BOTTOM	COND	CONDUIT CONNECTOR.	DSC DSCW	DIFFERING SITE CONDITIONS
ANI ANN	AUTOMATIC NUMBER IDENTIFICATION ANNUNCIATOR	BTWN	BASE TRANSCEIVER STATION BETWEEN	CONST	CONNECTION CONSTRUCT, CONSTRUCTION	DSG DSHA	DIRECT SUSPENSION CONTACT WIRE DISCONNECT SWITCH GROUP DETERMINISTIC SEISMIC HAZARD ANALYSIS
ANS AP	AMBIENT NOISE SENSOR ALTERNATIVE PIPE	BVC BW	BEGINNING OF VERTICAL CURVE BARBED WIRE,	CONT	CONTINUOUS.	DST DTBB	DISTRICT DOUBLE THRIE BEAM BARRIER
APC APE APEFZ	ALTERNATIVE PIPE CULVERT AREA OF POTENTIAL EFFECTS ALQUIST-PRIOLO EARTHQUAKE FAULT ZONE	B/W BWA	BALANCE WEIGHT BLACK AND WHITE BALANCE WEIGHT ANCHOR	CONTR COORD	CONTINUATIÓN CONTRACTOR COORDINATE	DTM DVR DWG	DIGITAL TERRAIN MODEL DIGITAL VIDEO RECORDERS DRAWING
API APPRO	APPLICATION PROGRAMMING INTERFACE X APPROXIMATE	BWLAN	BROADBAND WIRELESS LOCAL AREA NETWORK BRONZE	CORR CP	CORRIDOR CONTROL POINT	DWY DXO	DRIVEWAY DOUBLE CROSSOVER
APU AR	ALTERNATIVE PIPE UNDERDRAIN ACCESS RESTRICTION	(	C	CPT	CONE PENETRATION TEST, CONTROL POWER TRANSFORMER		
ARCH ARS AS	ARCHITECTURAL ACCELERATION RESPONSE SPECTRUM AGGREGATE SUBBASE	С	CLOSE, CONDUIT.	CPU CR	CENTRAL PROCESSING UNIT CREEK, CONDUIT RISER	E <sub>o</sub>	APPLIED CANT
ASPH ASRP	ASPHALT ASPHALT ALUMINUM SPIRAL RIB PIPE		CONTACT, CONTROL	CRC CRCP	COMBINED RELAY AND CONTROL PANEL CONTINUOUS REINFORCED CONCRETE P	E₀ E₀ Favement E	UNBALANCED CANT EAST,
B ASSY	ASSEMBLY AUTOTRANSFORMER.	CA CAA CAB	CERTIFICATION ACCEPTANCE CABLE ANCHOR ASSEMBLY CABINET	CRSP CRZ	CONCRETED ROCK SLOPE PROTECTION CLEAR RECOVERY ZONE	E A E B	EASTÍNG EACH EASTBOUND,
S ATC	AUTOMATIC TENSIÓN AUTOMATIC TRAIN CONTROL	CADD CAH	CABINE! COMPUTER-AIDED DESIGN AND DRAFTING CONTROLLED ACCESS HIGHWAY	CS	CONTROL SWITCH, CURVE TO SPIRAL	EC	END OF BRIDGE END HORIZONTAL CURVE,
ATEL ATM	ADMINISTRATIVE TELEPHONE ALONG TRACK MOVEMENT, AUTOMATED TELLER MACHINE	CAI CALP	CUSTOMER ASSISTANCE INTERCOM CORRUGATED ALUMINUM PIPE	CSA CSG CSP	CONSTRUCTION STAGING AREA CASING CORRUGATED STEEL PIPE	ECR	ELECTRICAL CONDUCTOR END CURB RETURN
ATO ATO	AUTOMATIC TRAIN OPERATION AUTOMATIC TRAIN PROTECTION	CANT CAP	CANTILEVER CAPACITY.	CSPA CT	CORRUGATED STEEL PIPE ARCH CERAMIC TILE.	EE EF	EACH END EACH FACE
MALA TEM	ASPHALT TREATED PERMEABLE BASE ASPHALT TREATED PERMEABLE MATERIAL		CAPACITOÉ, CORRUGATED ALUMINUM PIPE CORRUGATED ALUMINUM PIPE ARCH		COURT, CURRENT TRANSFORMER/TRANSDUCER	EGS EHS E I	EMERGENCY GROUND SWITCH EXTRA HIGH STRENGTH EMERGENCY INTERCOM
위 ATR ATS	ABOVE TOP OF RAIL AUTOMATIC TRAIN SUPERVISION, AUTO TENSIONED SYSTEM	CAS	CONSTRUCTION AREA SIGN CATEGORY.	CTB CTPB	CEMENT TREATED BASE CEMENT TREATED PERMEABLE BASE	ĒJ	EXPANSION JOINT FTHERNET LAN
AUX AVE	AUXILIARY AUXILIARY AVENUE		CATEGORY SPECIFICATION FOR TWISTED PAIR CABLING	CTPM CTR CTSK	CEMENT TREATED PERMEABLE MATERIA CENTER COUNTERSUNK	ELĀST ELEC	ELASTOMERIC ELECTRICAL.
AVG AVL	AVERAGE AUTOMATIC VEHICLE LOCATION	CATP	CANTENARY FOUNDATION CANTENARY POLE	CTVT	COMBINED CURRENT TRANSFORMER AND VOLTAGE TRANSFORMER	ELECT	ELECTRIC ÉLECTROLIER
AWG	AMERICAN WIRE GAUGE	СВ	CATCH BASIN, CIRCUIT BREAKER, CONCRETE BARRIER	CTW CU	COUNTER WEIGHT TAIL WIRE COPPER	ELEV ELOCK EMB	ELEVATION ELECTRONIC LOCK EMBANKMENT
<u>₩</u>	B	CBTC CBW	COMMUNICATIONS BASED TRAIN CONTROL CONCRETE BLOCK WALL	CUL V CV	CUL VERT CURVE	EMC EMER	ELECTROMAGNETIC COMPATIBILITY FMFRGFNCY
 □ BAGR	BRIDGE APPROACH GUARD RAILING	C&C	CUT AND COVER CENTERLINE TO CENTERLINE, CENTER TO CENTER	CVR CW CWA	COVER CONTACT WIRE CONTACT WIRE ANCHOR	EMF EMI	ELECTROMAGNETIC FIELD ELECTROMAGNETIC INTERFERENCE
BAR BAT	BARRIER BATTERY BECINNING OF BRIDGE	CCO CCS	CONTRACT CHANGE ORDER	CWH CWR	CONTACT WIRE HEIGHT CONTINUOUSLY WELDED RAIL	EMS EMU ENCL	ELEMENT MANAGEMENT SYSTEM ELECTRIC MULTIPLE UNIT ENCLOSURE
86 BC BB BC BB BC	BEGINNING OF BRIDGE BACK-TO-BACK BEGINNING OF CURVE,	CCTV	CALIFORNIA COORDINATE SYSTEM CLOSED CIRCUIT TELEVISION COUPLING CAPACITOR VOLTAGE TRANSFORMER	CWT	COUNTER WEIGHT	ENCL	LNCLUSURE
BCR	BOLT CIRCLE BEGIN CURB RETURN	CEG CEM	CERTIFIED ENGINEERING GEOLOGIST CEMENT	D	DEPTH		
1/202/1 BD A	BOARD BI-DIRECTIONAL AMPLIFIER	CER C&G	COMMUNICATIONS EQUIPMENT ROOM CURB AND GUTTER	DB DBE	DESIGN-BUILD DESIGN BASIS EARTHQUAKE		NOT FOR CONSTRUCTION FOR INTERNAL USE ONLY
7/1/2		DESIGNED BY C. CUSSON	STV 100			CALIFORNIA HIGH	I-SPEED TRAIN PROJECT CONTRACT NO. HSR14-39
		C. CUSSON	PEPD RECORD SET				TO LOS ANGELES DRAWING NO.
ي		C. LEE IN CHARGE	NOT FOR		CALIFORNIA		PEPD SCALE
O REV DATE	BY CHK APP DESCRIPTION	C. LEE	construction JACOBS		HIGH-SPEED RAIL AUTHORITY		AND ABBREVIATIONS HEET 1 OF 5
O REY DATE	DESCRIPTION	07/15/202	<u>' I                                   </u>				

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1	ENGR	E CONTINUED	ГC	F CONTINUED  FINISHED SURFACE	⊔w∨	H CONTINUED	LWP	L CONTINUED
		ENGINEER, ENGINEERING	FS FTEL	FIRE TELEPHONE	HWY	HIGHWAY	LWP	LOWER WORKING POINT
	EOB EOD	EDGE OF DECK	FTG FTP	FOOTING FILE TRANSFER PROTOCOL				M
	EOS EOW	ELECTRICAL OPERATED BRIDGE END OF WALL	FTW FUT	FIXED END TAIL WIRE FUTURE	IB IBC	IMPENANCE BOND INTERNATIONAL BUILDING CODE	M1 M	CONVENTIONAL RAILWAY TRACK MEDIUM LOADING
	EP EPBM	EDGE OF PAVEMENT FARTH PRESSURE BALANCING MACHINE	FW FWY	FEEDER WIRE FREEWAY	IDS	INTRUSION DETECTION CODE	MAINT	MAINTENANCE
	EPR EQ	ETHYLENE PROPYLENE RUBBER EQUAL.			IIMP	INTERGRATED IMFORMATION MANAGEME	MAX	MATERIAL MAXIMUM
	EQN	EQUILATERAL EQUATION		G	IJ IJP	INSULATED JOINT INSULATED JOINT PLUG	MB MBB	METAL BEAM METAL BEAM BARRIER
	EQUIP	FOLIPMENT	G1	ENTRANCE GRADE, GRADE BEFORE CURVE	INSR INST	INSULATOR INSTANTANEOUS	MBGR MCC	METAL BEAM GUARD RAILING MAINTENANCE CONTROL CENTER
	ES	EDGE OF SHOULDER, EXTRA STRENGTH,	G2	EXIT GRADE, GRADE POST CURVE	INSUL INT	INSULATION INTERIOR	MČĒ MCR	MAXIMUM CONSIDERED EARTHQUAKE MASTER CONTROL ROOM
	ESA	ELECTRICAL SECTION ENVIRONMENTALLY SENSITIVE AREA	GALV GCL	GALVANIZED GRADING CONTROL LINE		INTER-LOCAL ACCESS AND TRANSPORT INVERT		MOBILE DATA SYSTEM MECHANICAL
	ESC ESEW	EMERGENCY SHOWER / EYE WASH	GD GHS	GRADE GALVANIZED HIGH STRENGTH	I/O IR	INPUT/OUTPUT IN-RUNNING (RIDING CONTACT WIRE)	MED MEM	MEDIAN MEMBRANE
	ESMT ETCS	EASEMENT EUROPEAN TRAIN CONTROL SYSTEM	GI	GENERAL INFORMATION	IRR	IRRIGATION	MESSGR	MESSENGER WIRE
	ETEL ETS	EMERGENCY TELEPHONE EMERGENCY TRIP SYSTEM	GIGE GIS	GIGABIT ETHERNET GAS INSULATED SWITCH,	I/S I/SJ	IN-SPAN IN-SPAN JUMPER	ME T MF R	METAL MANUFACURER
	ETW EVC	EDGE OF TRAVELED WAY END VERTICAL CURVE	GL	GEOGRAPHIC INFORMATIÓN SYSTEM GLASS			MH MHHW	MANHOLE MEAN HIGHEST HIGH WATER
	EW	EACH WAY, ENDWALL	G/L GMA	GROUND LINE GROUND MOTION ANALYSIS	1	J	MI MIN	MILD IRON MINIMUM
	EXC	EXCAVATION	GND GO-95	GROUND PUC GENERAL ORDER 95	JAN	JUMPER JANITOR	MISC MKR	MISCELLANEOUS MARKER
	EXIST EXP	EXISTING EXPANSION	GP GPS	GRADING PLANE GLOBAL POSITIONING SYSTEM	JB JCT	JUNCTION BOX JUNCTION _	ML MLLW	MAIN LINE MEAN LOWER LOW WATER
	EXPO EXWY	EXPRESSWAY	GR	GUARDRAIL, GROUND ROD	JP JT(S)	JOINT POLE JOINT(S)	MMIS	MAINTENANCE MANAGEMENT INFORMATION SYSTEM
	EXT	EXTERIOR, EXTENSION	GRP GRS	GLASS REINFORCED PLASTIC ROD			MO MOC	STRIEM MASONRY OPENING MOTOR OPERATED CONTRACTOR
			GRX	GALVANIZED RIGID STEEL GRADE CROSSING	1/1/	K (KILOVOLT	MOC MOD	MODIFIED,
		<u> </u>	GSHA GSP	GEOLOGIC AND SEISMIC HAZARDS ANALYSIS GALVANIZED STEEL PIPE	KV	KILOVOLT	MODC	MODIFY MOTOR OPERATED DISCONNECT SWITCH
	F A F A C P	FIRE ALARM FIRE ALARM CONTROL PANEL	GT GTGM	GENERAL INFORMATION GEOTECHNICAL TECHNICAL GUIDANCE		L	MOI MON	MAINTENANCE OF INFRASTRUCURE MONUMENT
1	FAS FB	FIRE ALARM SYSTEM FLAT BAR.	GTR	MANUAL (FHWA) GUTTER	L	LENGTH	MOP MOS	MOTOR OPERATED MANUALLY OPERATED SWITCH
1		FLOOR BEAM, FEEDER BREAKER	GW GYP	GUY WIRE GYPSUM	LA	LANDSCAPE ARCHITECT, LIGHTING ARRESTER,	MOV MOW	METAL-OXIDE VARISTOR MAINTENANCE OF WAY
	FBO FC	FURNISHED BY OTHERS	GYPBD	GYPSUM BOARD	LA-A	LOS ANGELES (CALIFORNIA, USA) LOS ANGELES TO ANAHEIM	MP MPA	MILEPOST MIDPOINT ANCHOR
	F&C FD	FARE COLLECTION FRAME AND COVER FLOOR DRAIN		Н	L AM L AN	LAMINATE LOCAL AREA NETWORK	MPH MPLS	MILES PER HOUR MULTI-PROTOCOL LABEL SWITCHING
	FDC FDN	FIRE DEPARTMENT CONNECTION FOUNDATION	HSR1/2 HAZ	HSR TRACK 1/2/ETC. HAZARDOUS	LA-SD LAT	LOS ANGELES TO SAN DIEGO LATITUDE	MR MSE	MOVEMENT RATING MECHANICALLY STABILIZED EMBANKEMENT
	FDP	FIBER DISTRIBUTION PANEL	НВ	HARDNESS BRINELL, HOSE BIBB	LAV LC	LAVATORY LENGTH OF CURVE.	MSF	MAINTENANCE AND STORAGE FACILITY
_	FDR FDU	FEEDER FIBER DISTRIBUTION UNIT	HC HD	HÀNDICÀP HARD DRAWN,	LCB	LENGTH OF CURVE, LANDSCAPE CONTRACTOR LEAN CONCRETE BASE	MSL MTD	MEAN SEA LEVEL MEMO TO DESIGNERS (CALTRANS),
2.dgr	FE FES	FIRE EXTINGUISHER FLARED END SECTION	HDG	HORIZONTAL DRAIN HOT DIP GALVANIZED	LCX LDBE	LEAKY COAXIAL RADIO CABLE LOWER-LEVEL DESIGN BASIS EARTHQU	IAKE MUL	MOUNTED MULLION
:0403	FF F/F	FILTER FABRIC FACE TO FACE	HDPE HDWE	HIGH DENSITY POLYETHYLENE HARDWARE	LED LF	LIGHT EMITTING DIODE LINEAR FEET	MVC MW	MINIMUM VERTICAL CLEARANCE MESSENGER WIRE
GE - C	FFJ FFL	FULL FEEDING JUMPER FINISHED FLOOR LEVEL	HDWL	HEADWALL	ĹĠ	LONG		N
(2L-	FG F&G	FINISHED GRADE FRAME AND GRATE	HE X HH	HEXAGONAL HANDHOLE,	LGT	LIGHT, LIGHTING		( N
44 / 4	FH FHC	FIRE HYDRANT FIRE HOSE CABINET	ні	HEAD HARDENED HIGH	LH LKR	LEFT-HAND LOCKER	N	NORTH, NORTHING
1501	FID FIG	FIRE INITIATING DEVICE FIGURE	HI-RAIL HM	HIGHWAY TO RAILROAD VEHICLE HOLLOW METAL HOT MIXED ASPHALT	LL LLT	LIGHT LOADING LAST LONG TIE	N/A NAVD	NOT APPLICABLE NORTH AMERICAN VERTICAL DATUM
0P\c	FIN FIRM	FINISH	HMA HMI	HOT MIXED ASPHALT HUMAN MACHINE INTERFACE HAND OPERATED	LN LO	LANE LOCKOUT	NB NBR	NORTHBOUND NONBRIDGING
ossi	FJ	FLOOD INSURANCE RATE MAPS FEEDER JUMPER	HO HOBAS	HAND OPERATED MANUF. CENTRIFUGALLY CAST GLASSFIBER REINF. PIPI	LOC E LOL	LOCATION LAYOUT LINE	NCL NDP	NO COLLAPSE PERFORMANCE LEVEL Nonlinear dynamic procedure
י/ככר.	FL FLB	FLOW LINE FLOOR BEAM	HOR HOV	HORIZONTAL HIGH-OCCUPANCY VEHICLE	LONG	LONGITUDE, LONGITUDINAL	NE C NE G	NATIONAL ELECTRICAL CODE NEGATIVE
žd.	FLH FLR	FLAT HEAD FLOOR	HP	HIGH POINT, HINGE POINT	LOS LOTB	LEVEL OF SERVICE LOGS OF TEST BORINGS	NEUT NE	NEUTRAL NEGATIVE FEEDER,
WOL	FNA FO	FIRE NOTIFICATION APPLIANCE FIBER OPTIC FIBER OPTIC CABLE,	HP&R HPS	HIGHWAY PLANTING AND RESTORATION HIGH PERFORMANCE STEEL	LP	LOW PROFILE LIGHT POLE	NGVD	NEGATIVE FEEDER, NEAR FACE NATIONAL GEODETIC VERTICAL DATUM
ام\ ا	FOC	FIBER OPTIC CABLE, FACE OF CURB	HR	HANDRAIL	LPL	LIGHT POLE	NI	NETWORK INTERFACE
:	FOCN FOF	FACE OF CURB FIBER OPTIC CABLING NETWORK FACE OF FINISH	HRL HS	HIGH RAIL LEVEL HIGH STRENGTH	LR LRFD	LOW RAIL LOAD AND RESISTANCE FACTOR DESIG	NIC NMS	NOT IN CONTRACT NETWORK MANAGEMENT SYSTEM
≥	FOP FOS	FACE OF POLE	H/SPAN HSR	HEADSPAN HIGH-SPEED RAIL	LRT LRV	LOAD AND RESISTANCE FACTOR DESIG LIGHT RAIL TRANSIT LIGHT RAIL VEHICLE LENGTH OF SPIRAL,	NO	NUMBER, NORMALLY OPEN
A 0C	FP FP	FACE OF STUDS, FACTOR OF SAFETY FULL PENETRATION	HST HT	HIGH-SPEED TRAIN HIGH TEMPERATURE	LS	LENGTH OF SPIRAL, LANDSCAPING, LUMP SUM	NOM NP	NOMINAL NETWORK PORT
:02:	FPLM FPRF	FULL SPAN PRECAST LAUNCHING FIRE PROOF	HTR HV	HEATER HIGH VOLTAGE	LT	LEFT		
2	FPS	FRAMES PER SECOND	HVAC HW	HEATING VENTING AND AIR CONDITIONING HIGH WATER	L V L V L	LOW VOLTAGE LEVEL		WAT FOR COMPTRICTION
/202	FR FREQ	FRAME FREQUENCY	HWT HWM	HIGH WATER TABLE HIGH WATER MARK	LVT	LOW VIBRATION TRACK		NOT FOR CONSTRUCTION FOR INTERNAL USE ONLY
7/14			DESIGNED BY  C. CUSSON			Т	CALIFORNIA HIGH	CONTRACT NO.
			DRAWN BY C. CUSSON	PEPD ST V				TO LOS ANGELES DRAWING NO.
			C. CUSSON  CHECKED BY  C. LEE	RECORD SET		<b>(1)</b>		ALIGNMENT - REVISED FINAL GE-C0402
onc			IN CHARGE C. LEE	NOT FOR CONSTRUCTION JACOBS		CALIFORNIA	ACRONYMS	AND ABBREVIATIONS NO SCALE
Sussi	REV DATE B	BY CHK APP DESCRIPTION	DATE 07/15/20	DACOBS		HIGH-SPEED RAIL AUTHORITY		EET 2 OF 5
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NPRM	NOTICE OF PROPOSED RULE MAKING	PPL	PREFORMED PERMEABLE LINER	RRR	RESURFACING, RESTORATION,	SSW	STEADY SPAN WIRE
NPS NR	NOMINAL PIPE SIZE NOT REGISTERED	PPP PR PRI	PERFORATED PLASTIC PIPE PAIR	RRRR	REHABILITATÍON (3R) RESURFACING, RESTORATION,	SSW SS ST	SANITARY SEWER SPIRAL TO TANGENT,
NS NT	NOT SUPPORTED NETWORK	PROP	PRIMARY RATE INTERFACE (ISDN SERVICE) PROPOSED	RRX	REHABILITATÍON, RECONSTRÚCTION (4R) RAILROAD GRADE CROSSING	STA	STREET STATION,
NTP	NOTICE TO PROCEED, NETWORK TIME PROTOCOL	PS	PARALLELING STATION, POINT OF SWITCH	R&S RSP	REMOVE AND SALVAGE ROCK SLOPE PROTECTION	STBB	STATIONÍNG SINGLE THRIE BEAM BARRIER
NTS	NOT TO SCALE NETWORK TIME SERVER	P/S PS	PRESTRESSED	RT	RESILIENT TILE, RIGHT	STD STC	STANDARD SINGLE TRACK CANTILEVER
	NETHONIC TIME SERVER	PSP PSTN	PARALLELING STATION PERFORATED STEEL PIPE PUBLIC SWITCHER THE PROPERTY OF T	RTE RTU	ROUTE REMOTE TERMINAL UNIT	STIFF STL	STIFFENER STEEL
	0	PSTTWS	PUBLIC SWITCHED TELEPHONE NETWORK PUBLIC SAFETY TRENCH AND TUNNEL	RW	RETAINING WALL	STOR	STORAGE
OA OBLR	OVERALL OBLITERATE	PSU PT	WIRELESS SYSTEM POWER_SUPPLY UNIT	R/W RWL	RIGHT-OF-WAY RAIN WATER LEADER	STP STR	SHIELDED TWISTED PAIR CABLE STRUCTURAL,
oc oc	ON CENTER, OVERCROSSING	PTC	POTENTIAL TRANSFORMER POSITIVE TRAIN CONTROL	RWY	RAILWAY	STS	STRUCTURE ´ SPIRAL TANGENT SPIRAL
000	OPERATIONS CONTROL CENTER	PTD/R PTEL	POSITIVE TRAIN CONTROL PAPER TOWEL DISPENSER AND RECEPTACLE PASSENGER ASSISTANCE TELEPHONE		S	STW SUPV	STATIC WIRE SUPERVISORY
OCS OF	OVERHEAD CONTACT SYSTEM OUTSIDE FACE	PTM PTT	PARKING TICKET MACHINE PUSH TO TALK	S	SOUTH,	SURF SUSP	SURFACING SUSPENDED
OF F OG	OFFSET ORIGINAL GROUND	PTZ PUE	PAN-TILT-ZOOM PUBLIC UTILITY EASEMENT	SAE	SLOPE´ STRUCTURE APPROACH EMBANKMENT	SW	SOUNDWALL, SOFTWARE
OH O-LA	OVERHEAD ORANGE COUNTY TO LOS ANGELES	PVC	POLYVINYL CHLORIDE, POINT OF VERTICAL CURVATURE	SALV SAPP	SALVAGE STRUCTURAL ALUMINUM PLATE PIPE	SWA SWAT	SINGLE WIRE ANCHOR SINGLE WIRE AUTO TENSIONED
0&M 0-0	OPERATIONS AND MAINTENANCE OUT TO OUT	PVI PVMT	POINT OF VERTICAL INTERSECTION PAVEMENT	SB SC	SOUTHBOUND SPIRAL TO CURVE,	SWF T SWGR	SINGLE WIRE - FIXED TERMINATION SWITCHGEAR
OOR OP	OUT-OF-RUNNING (NONRIDING CONTACT WIRE) OVERPASS	PVT	POINT OF VERTICAL TANGENCY	SCADA	SWITCH CARLE		SIDEWALK
OPL OPNG	OPERABILITY PERFORMANCE LEVEL OPENING	PWR	POWER	CCAT	SUPERVISORY CONTROL AND DATA AQUISI SIMPLE CATENARY - AUTO TENSION SUBSTATION CONTROL BUILDING	SWPPP SWR	STORM WATER POLLUTION PREVENTION PLAN SEWER
OPP ORS	OPPOSITE		0	SCC	STATION CONTROL CENTER SEAT COVER DISPENSER	SWT	SWITCHING STATION SWITCH
ÓSP	OPERATIONS RADIO SYSTEM OUTSIDE PLANT	gos	QUALITY OF SERVICE	SCF T	SIMPLE CATENARY - FIXED TENSION	SYM	SYMMETRICAL
OVERTEM	IP OVERTEMPERATURE	QT QTY	QUARRY TILE QUANTITY	SCB SCC SCD SCFT SCHD SCN SCPE	SCHEDULE SECURITY CLASSIFICATION NUMBERS SEISMIC CAPACITY AND PERFORMANCE EV	/AL IIA TION T	TDE AD
	P		R	SUSP	SLOTTED CORRUGATED STEEL PIPE	TAN	TREAD TANGENT
P-LA PA	PALMDALE TO LOS ANGELES PUBLIC ADDRESS	R	RADIUS,	SD SDB SDC_	STORM DRAIN System Duct Bank	TASAS T&B TBD	TRAFFIC ACCIDENT SUREILLANCE ANALYSIS SYSTEM TOP AND BOTTOM
PACIS	PUBLIC ADDRESS/CUSTOMER INFORMATION SYSTEM	RA	RED REMOTE ANNUNCIATOR	SDOF	SEISMIC DESIGN CRITERIA SINGLE DEGREE OF FREEDOM	TBD TBM TCL	TO BE DETERMINED TUNNEL BORING MACHINE
PAX	PASSENGER	R/A RAID	REDUTE ANNOUNCETOR ROCK ANCHOR REDUNDANT ARRAY OF INDEPENDENT DISKS	SE SECT	SUPER ELEVATION SECTION	TCL TC TCB	TRACK CENTERLINE TRAIN CONTROL
PB	PULL BOX, PUSH BUTTON (ON ELECTRICAL DIAGRAMS) PRIVATE BRANCH EXCHANGE	RB	REDUNDANI ARRAT OF INDEPENDENT DISKS RESILIENT BASE RAILBOUND MANGANESE FROG	SECTLEG SEM	SECTIONALIZING SEQUENTIAL EXCAVATION METHOD	TCC	TRAFFIC CONTROL BOX TRAIN CONTROL AND COMMUNICATIONS
PBX PC	PRECAST CONCRETE	RBM RC	REGIONAL CONSULTANT, REINFORCED CONCRETE	SEP	SEPARATION SERVICE	TCCR TCCT	TRAIN CONTROL AND COMMUNICATIONS ROOM TRACK CIRCUIT
PCC PCP	PORTLAND CEMENT CONCRETE PERFORATED CONCRETE PIPE	RCA RCB	REINFORCED CONCRETE REINFORCED CONCRETE ARCH REINFORCED CONCRETE BOX	SERV SF SF S	SPRING FROG SANTA FE SPRINGS	TCE TCP/IP	TEMPORARY CONSTRUCTION EASEMENT TRANSMISSION CONTROL PROTOCOL/INTERNET
PCPT PE	PIEZOCONE PENETROMETER TEST PORCELAIN ENAMEL	RCC	REGIONAL CONTROL CENTER	SG SHA	SUBGRADE SEISMIC HAZARDS ANALYSIS	TCR	PROTOCOL TRANSMISSION COMMUNICATIONS ROOM
PED PEPD	PEDESTRIAN PRELIMINARY ENGINEERING FOR	RCE RCP	REGISTERED CIVIL ENGINEER REINFORCED CONCRETE PIPE	SHLD SHS	SHOULDER STATE HIGHWAY SYSTEM	TD	TRANSMISSION COMMUNICATIONS ROOM TRENCH DRAIN, TIME DELAY
୍ଦି PERF	PROJECT DEFINITION PERFORATED	RCPA RD	REINFORCED CONCRETE PIPE ARCH ROAD,	SHT	SHEET	TDA	TIME DELAT TIRE DERIVED AGGREGATE TELECOMMUNICATIONS DEVICE FOR THE DEAF
PERM PET	PERMEABLE, PERMANENT POTENTIAL EQUALIZING JUMPER	R&D	ROOF DRAIN REMOVE AND DISPOSE	SI	SECTION INSULATOR, SITE INVESTIGATION	TDD TDM	TIME DIVISION MULTIPLEXING
PF PFDHA	POWER FACTOR PROBABILISTIC FAULT DISPLACEMENT	RDWY RE	ROADWAY RUNNING EDGE OF RAIL	SIG SIM	SIGNAL SIMILAR	TEL TEMP	TELEPHONE TEMPORARY
9	HAZARD ANALYSIS PROFILE GRADE LINE	REBAR RECT	CONCRETE REINFORCED BAR RECTANGULAR	SLAN SM	PASSENGER STATION LOCAL AREA NETWOR SELECTED MATERIAL SOLID MANGANESE FROG,	RK TERM TES	TERMINATION TRACTION ELECTRIFICATION SYSTEM
PGL PH	PHASE	REF	REFERENCE	SMF	SOLID MANGANESE FROG, SINGLE MODE FIBER	TESC TETEL	TEMPORARY EROSION AND SETTLEMENT CONTROL TRAIN EMERGENCY TELEPHONE/SPEAKERPHONE
64 PID PHE	POTHOLE PASSENGER INFORMATION DISPLAY	REFP RE INF	REFERENCE POINT REINFORCED, REINFORCEMENT,	SNF SNTP	SINGLE MODE FIBER SWING NOSE FROG SIMPLE NETWORK TIME PROTOCOL	TFE TG	TETRAFLOUROETHYLENE TOP OF GRADE
B D D D I D	POINT OF INTERSECTION TURNOUT PARTIAL JOINT PENETRATION	_	REINFORCING	SP SPC	SPARE SPECIAL	THK TIS	THICK TELEPHONE AND INTERCOM SYSTEM
PL	PLATE, PLACE	REL	RELOCATE, RELOCATED	SPEC SPKR	SPECIAL SPECIFICATION SPEAKER	TK	TRACK TENSION LENGTH
ÿng P/L PLAM	PROPERTY LINE PLASTIC LAMINATE	REM REPL	REMOTE REPLACEMENT	SPL	SAFETY PERFORMANCE LEVEL	TL TM TMP	TECHNICAL MEMORANDUM
PLAS PLC	PLASTER PROGRAMMABLE LOGIC CONTROLLER	REQD RESIL	REQUIRED RESILIENT	SPS SPST	SMALL PART STEELWORK SINGLE POLE SINGLE THROW	TO TO	TEMPERATURE TURNOUT,
Y PLYWD	PLYWOOD POST MILE.	RET REV	RETAINING REVISED,	SPT SQ	STANDARD PENETRATION TEST SQUARE	TOC	TELECOM OUTLET TOP OF CURB
PMS	POST MERIDIEM (TIME FROM NOON TO MIDNIGHT) PAVEMENT MANAGEMENT SYSTEM	RF	REVISION REVISION RADIO FREQUENCY	SR	SYSTEM REQUIREMENT, STATE ROUTE	TOG TOL_	TOP OF GRATE TOLERANCE
Ë PN	PAVING NOTCH	RFI	REQUEST FOR INFORMATION	SRRA SRSS	SAFETY ROADSIDE REST AREA SQUARE ROOT OF SUM OF SQUARES	TOLR TOF	TOP OF LOW RAIL TOP OF FOUNDATION
PNL PNT	PANEL POINT	RGS RH	RIGID GALVANIZED STEEL RIGHT-HAND	SS	SLOPE STAKE, SUBSTATION	TOF G TOP	TOP OF FINISH GRADE TOP OF PAVEMENT
PO POC	PULL OFF POINT OF CONNECTION	RM	RÉSTRICTED MANUAL, ROOM	S/SPAN SSI	STEADY SPAN SOLL STRUCTURE INTERACTION	TOR	TOP OF RAIL
POE POS	POINT OF ENDING POSITIVE	R-M RO	ROAD MIXED ROUGH OPENING	SSK SSPA	SERVICE SINK STRUCTURAL STEEL PLATE ARCH STRUCTURAL STEEL PLATE PIPE		
POTS PP	PLAIN ORDINARY TELEPHONE SERVICE PLASTIC PIPE,	ROW RP	RIGHT-OF-WAY RADIUS POINT	SSPP SSPPA	STRUCTURAL STEEL PLATE PIPE		
2021	POWER POLE	RR	RAILROAD, RUNNING RAIL	SSRP SST	STRUCTURAL STEEL PLATE PIPE STRUCTURAL STEEL PLATE PIPE ARCH STEEL SPIRAL RIB PIPE STAINLESS STEEL		NOT FOR CONSTRUCTION
/17	T T T	DESIGNED BY	^ CDX /		T T	ALIFORNIA	FOR INTERNAL USE ONLY
		C. CUSSOI	PEPD UNIT V	00	C		-SPEED TRAIN PROJECT HSR14-39 TO LOS ANGELES DRAWING NO.
		C. CUSSOI	RECORD SET				ALIGNMENT - REVISED FINAL GE-CO403
2		C. LEE	NOT FOR		CALIFORNIA		PEPD SCALE NO SCALE
O S REV DATE	BY CHK APP DESCRIPTION	C. LEE	construction JACOBS		HIGH-SPEED RAIL AUTHORITY		AND ABBREVIATIONS IEET 3 OF 5
O NET DATE	DESCRIPTION	07/15/2	V41				<b>L</b>

		T CONTINUED		(W CONTINUED)		(TRACK GEOMETRY - HORIZONTAL)		(UNITS OF MEASUREMENT)
	OS OT	TOP OF SLOPE TOP OF TIE,	W/ WA	WITH Work area	ВС	BEGIN HORIZONTAL CURVE	AC AMP	ACRES AMPERES
	O.M.	TOTAL TOP OF WALL	WB WC	WESTBOUND WATER CLOSET	CC CS	COMPOUND CURVE POINT OF CHANGE FROM CIRCULAR CURVE TO	SPIRAL BTU	BRITISH THERMAL UNIT
T T	P PB	TELEPHONE POLE, TRACTION POWER TREATED PERMEABLE BASE	WCS WD WLAN	WIRELESS COMMUNICAT WOOD WIRELESS LOCAL AREA	K1	TANGENT DISTANCE PF SHIFT PC REFERENCE TO THE TS	CAL CF	CALIPER CUBIC FEET
T	PD PF	TOILET PAPER DISPENSER TRACTION POWER FACILITY	WM W/O	WIRE MESH WITHOUT	K2	TANGENT DISTANCE PF SHIFT PT REFERENCE TO THE ST	CP CY	CANDLE POWER CUBIC YARD
Ť	PM PS	TREATED PERMEABLE MATERIAL TRACTION POWER SUPPLY SYSTEM	WP	WORK POINT, WOOD POLE	LC	LENGTH OF CIRCULAR CURVE	dB	DECIBEL
	PSS	TRACTION POWER SUBSTATION (INCLUDING PARALLEL AND SWITCHING STATIONS)	WPF WPC	WATERPROOF WAYSIDE POWER CUBIC		LENGTH OF SPIRAL FROM TS TO SC LENGTH OF SPIRAL FROM CS TO ST	DEG DIA	DEGREE DIAMETER
	/R RANS	TOP OF RAIL ELEVATION TRANSVERSE, TRANSITION	WR WRT WS	WIRE RUN WITH RESPECT TO WATER SURFACE,	LSc p1	LENGTH OF COMPOUND SPIRAL FROM CS TO SC OFFSET FROM INITIAL TANGENT TO PC OF THI	Eu	UNBALANCED SUPERELEVATION
	RK S	TRACK TRAFFIC SIGNAL.	WSP	WORK STATION WELDED STEEL PIPE	p2	SHIFTED CIRCLE OF SPIRALIZED CURVE OFFSET FROM INITIAL TANGENT TO PT OF THI		FARENHEIT FOOT,
		TANGENT TO SPIRAL, TUBULAR STEEL	WT WV	WEIGHT WATER VALVE	PC	SHIFTED CIRCLE OF SPIRALIZED CURVE POINT OF CURVATURE		FEET
T	SI SM SMP	TECHNICAL SPECIFICATIONS FOR INTEROPERABILITY TRAFFIC SYSTEMS MANAGEMENT TRAFFIC SYSTEMS MANAGEMENT PLAN	ww wwF	WINGWALL, WALKWAY WELDED WIRE FABRIC	PCC PF PI	POINT OF COMPOUND CURVE POINT OF FROG POINT OF INTERSECTION	g GA GAL	ACCELERATION DUE TO GRAVITY GAUGE GALLON
Ť	TC TEL	TWO TRACK CANTILEVER TRAIN EMERGENCY SPEAKERPHONE	WWJCL WWLOL	WELDED STEEL PIPE WINGWALL LAYOUT LIN	PITO	POINT OF INTERSECTION TURNOUT POINT ON HORIZONTAL CURVE POINT OF ENDING	GB GBPS	GIGABYTE GIGABITS PER SECOND
Т	V VS(S)	TELEVISION TICKET VENDING MACHINE(S)	WWM	WELDED WIRE MESH	POE POS	POINT ON SPIRAL	GHz	GIGAHERTZ
T,	W WC WT	TIE WIRE TIME WARNER CABLE TIME WARNER TELEPHONE		X	POVC POVT PRC	POINT ON VERTICAL CURVE POINT ON VERTICAL TANGENT POINT OF REVERSE CURVE	HR HT H <i>z</i>	HOUR HEIGHT HERTZ
	Ϋ́P	TYPICAL	X/CAT XD	CROSS CANTENARY TRANSDUCER	PRVC PS	POINT OF REVERSE VERTICAL CURVE POINT OF SWITCH	ID	INSIDE DIAMETER
		U	XFMR XO XOST	TRANSFORMER CROSSOVER CROSSOVER SPRING TE	PT	POINT OF TANGENT	IF IN	INSIDE FACE INCHES
U		UTILITY BOX UNIFORM BUILDING CODE	XSEC X/SPAN	CROSS SECTION CROSS SPAN	SC SPO SS	POINT OF CHANGE FROM SPIRAL TO CIRCULAR POINT ON ORIGIN OF COMPOUND SPIRAL POINT OF CHANGE BETWEEN SPIRALS	CURVE IR	INSIDE RADIUS KIPS (1000 POUNDS)
U	D	UNDERCROSSING UNDERDRAIN	XING XMITTER	CROSSING TRANSMITTER	SSC ST	SPIRAL TO SPIRAL POINT OF CURVATURE POINT OF CHANGE FROM SPIRAL TO TANGENT	KCMIL KHZ	THOUSAND CIRCULAR MILS KILOHERTZ
U	G GB	UNDERGROUND, UNDERGRADE UNDERGRADE BRIDGE			ŢĊ	POINT OF CHANGE FROM TANGENT TO CURVE	KSF KSI	KIPS PER SQUARE FOOT KIPS PER SQUARE INCH
U		USER INTERFACE UNINSULATED			TS Ts1 Ts2	POINT OF CHANGE FROM TANGENT TO SPIRAL TANGENT DISTANCE FROM TS TO PI TANGENT DISTANCE FROM ST TO PI	KV KVA KVAR	KILOVOLTS KILOVOLTS-AMPERE KILOVOLTS-AMPERE REACTIVE
U		UNLESS OTHERWISE NOTED UNDERPASS			Xs1	TANGENT DISTANCE FROM ST TO FI	KW KWH∠D	KILOWATT KILOWATT HOUR / DEMAND
U	PS R rEDAS	UNINTERRUPTIBLE POWER SUPPLY URINAL URGENT EARTHQUAKE DETECTION AND ALARM SYSTEM			Xs2	TANGENT OFFSET AT THE CS	L	LENGTH
U	SCS TIL	UNIFIED SOIL CLASSIFICATION SYSTEM UTILITY			Δ Δc	TOTAL CENTRAL ANGLE OF THE SPIRALIZED C CENTRAL ANGLE OF CIRCULAR CURVE (Lc) FRO SC TO CS	URVE LB DM LB/FT LF	POUNDS POUNDS PER FOOT
	TPUN WP	SHIELDED TWISTED PAIR UPPER WORKING POINT			Δc1	CENTRAL ANGLE OF FIRST CIRCULAR CURVE O COMPOUND CURVATURE		LINEAR FOOT METER
14.dgr		V			<b>Δ</b> c2	CENTRAL ANGLE OF SECOND CIRCULAR CURVE COMPOUND CURVATURE	OF MBPS MCM	MEGABITS PER SECOND THOUSAND CIRCULAR MILS
-C040		VELOCITY,			θs1	CENTRAL ANGLE OF SPIRAL LENGTH LS1 OR S	MH <i>z</i> SPIRAL mm /F MPH	MEGAHERTZ MILLIMETER MILCONER HOUR
Z - GE	AC	DESIGN SPEED, VALVE VOLTS ALTERNATING CURRENT			θs2	ANGLE OF FIRST SPIRAL IN SPIRALIZED CURV CENTRAL ANGLE OF SPIRAL LENGTH Ls2 OR S ANGLE OF SECOND SPIRAL IN SPIRALIZED CUF	FE MPH SPIRAL MVA RVE MW	MILES PER HOUR MEGAVOLT-AMPERE MEGAWATT
	AR	VARIABLE, VARIES			θsc	CENTRAL ANGLE OF COMPOUND SPIRAL OR COMPOUND SPIRAL ANGLE FROM CS TO SC	OD	OUTSIDE DIAMETER
1 <sub>5</sub>	CAT CE	VIRTUAL CONCETENATION VERTICAL CIRCULATION ELEMENT				(TRACK GEOMETRY - VERTICAL)	PSF	POUNDS PER SQUARE FOOT
~ V	CP CT CD	VITRIFIED CLAY PIPE VINYL COMPOSITION TILE VOLT DC			BVC	BEGIN VERTICAL CURVE	PSI PSIG	POUNDS PER SQUARE INCH POUNDS PER SQUARE INCH GAUGE
Sonos V	E ERT	VALUE ENGINEERING VERTICAL			Ea EVC	ACTUAL SUPERELEVATION END VERTICAL CURVE	SEC SF	SECOND SQUARE FEET
₽ V	EST IA	VESTIBULE VIADUCT			PCVC	POINT OF COMPOUND VERTICAL CURVE	SY TF	SQUARE YARD
	LAN MS	VIRTUAL LOCAL AREA NETWORK VARIABLE MESSAGE SIGN, VARIABLE MESSAGE SYSTEM			POVC POVT	POINT ON VERTICAL CURVE POINT ON VERTICAL TANGENT	VA	TRACK FEET  VOLTS
<u> </u>	OL	VOLTIMETER, VOLUME			PVI VC	POINT OF VERTICAL INTERSECTION	VAC VO	VOLT-AMPERE VOLATILE
V	OIP PN	VOICE OVER INTERNET PROTOCOL VIRTUAL PRIVATE NETWORK			VPI	VERTICAL CURVE VERTICAL POINT OF INTERSECTION	Y	YARDS
	RCS S T	VOICE RADIO COMMUNICATIONS SYSTEM VOLTAGE SWITCH VOLTAGE TRANSFORMER/TRANSDUCER					YR(S)	YEAR(S)
1:07:1	•							
% M		WEST,						NOT FOR CONSTRUCTION
14/20		พิโอัาห์						FOR INTERNAL USE ONLY
1		<del>                                      </del>	DESIGNED BY  C. CUSSON  DRAWN BY	PEPD	STV 100			HIGH-SPEED TRAIN PROJECT CONTRACT NO. HSR14-39
			C. CUSSON	RECORD SET	- Gears			ANK TO LOS ANGELES VISED ALIGNMENT - REVISED FINAL  ORANING NO.  GE-C0404
ouc			C. LEE IN CHARGE C. LEE	NOT FOR CONSTRUCTION	JACOBS'	CALIFORNIA		PEPD SCALE NO SCALE
SSN REV	DATE B	3Y CHK APP DESCRIPTION	DATE 07/15/20		UACOBS	HIGH-SPEED RAIL AUTHORITY		SHEET 4 OF 5

(AGENCIES/ORGANIZATIONS/REFERENCE)	(AGENCIES/ORGANIZATIONS/REFERENCE CONTINUED)	(SEGMENT/COUNTY CODES AND SUBDIVISIONS)
AAR ASSOCIATION OF AMERICAN RAILROADS  AASHTO AMERICAN ASSOCIATION OF STATE HIGHWAY  TRANSPORTATION OFFICIALS  ACI AMERICAN CONCRETE INSTITUTE  ADA AMERICAN WITH DISABILITIES ACT (FEBERAL)  AISC AMERICAN INSTITUTE OF STEEL CONSTRUCTION  AMTRAK NATIONAL RAILROAD PASSANGER CORPORATION  ANSI AMERICAN NATIONAL STANDARDS INSTITUTE  ANSS ADVANCED NATIONAL SEISMIC SYSTEM  APWA AMERICAN PUBLIC WORKS ASSOCIATION  AREA AMERICAN RAILWAY ENGINEERING ASSOCIATION  AREA AMERICAN RAILWAY ENGINEERING AND  MAINTENANCE-OF-WAY ASSOCIATION  ARTIC ANAHEIM REGIONAL TRANSPORTATION  INTERMODAL CENTER  ASCE AMERICAN SOCIETY OF CIVIL ENGINEERS  ASTM ASTM INTERNATIONAL,  AMERICAN SOCIETY OF TESTING AND MATERIALS  ATC APPLIED TECHNOLOGY COUNCIL  AUTHORITY CALIFORNIA HIGH-SPEED RAIL ATHORITY  AWS AMERICAN WELDING SOCIETY  BART BAY AREA RAPID TRANSIT DISTRICT  BDA BRIDGE DESIGN DETAILS (CALTRANS)  BDD BRIDGE DESIGN DETAILS (CALTRANS)  BDD BRIDGE DESIGN PRACTICE (CALTRANS)  BDD BRIDGE DESIGN SPECIFICATIONS (CALTRANS)  BRIDS BRIDGE DESIGN SPECIFICATIONS (CALTRANS)  BKLN BIKE LANE  BNSF BURLIGNTON NORTHERN SANTA FE RAILWAY,  BNSF RAILWAY  CALNET CALIFORNIA DEPARTMENT OF TRANSPORTATION  CBC CALIFORNIA DEPARTMENT OF TRANSPORTATION  CBC CALIFORNIA DEPARTMENT OF  TRANSPORTATION-BRIDGE DESIGN MANUAL  CCR CALIFORNIA DEPARTMENT OF  TRANSPORTATION-BRIDGE DESIGN CRITERIA  CCC CALIFORNIA HIGH-SPEED TRAIN OF HIGHWAY PATROL	NEMA NATIONAL ELECTRICAL MANUFACTURERS ASSOCIATION NENA ASTOCIATION NESC NATIONAL EMERGENGY NUMBER ASSOCIATION NIST NAME OF THE N	SEGMENT/COUNTY CODES AND SUBDIVISIONS  AJ ALTAMONT PASS BP BAKERSFIELD TO PALMDALE FB FRESNO TO BAKERSFIELD FJ SAN FRANCISCO TO SAN JOSE JM SAN JOSE TO MERCED LD LOS ANGELES TO SAN DIEGO LO LOS ANGELES TO SAN DIEGO CO CAPITAL SUBDIVISION PL PALMDALE TO LOS ANGELES SM SACRAMENTO TO MERCED  B BAY SUBDIVISION C CAPITAL SUBDIVISION D DESERT SUBDIVISION J SAN JACINTO SUBDIVISION S SIERRA SUBDIVISION TONGVA SUBDIVISION TONGVA SUBDIVISION S SIERRA SUBDIVISION TONGVA SUBDIVISION ALA ALAMEDA ALP ALPINE AMA AMADOR BUIT BUTTE CAL CALAVERAS CC CONTRA COSTA CCOL COLUSA DN DEL NORTE ED EL DORAMO FRE FRESNO GLE GLENN HUM HUMBOLT IMP IMPERIAL INY INYO KER KERN KIN KINGS LA LOS ANGELES LAK LASE LASSEN MAD MADERA KIN KINGS LA LASSEN MEN MENDOCINO MON MONOC MON MONTEREY MADA NEV MENCED MAN MARIN NAPA NEV NEVADA ORA ORA SANTA BARBARA SEB SANTA BARBARA SEB SANTA BARBARA SEB SANTA CALUZ SD SAN JOAOUN SON SAN JOAOUN SON SON SAN JOAOUN SON SAN JOAOUN SON SAN JOAOUN SON SAN JOAOUN SON SON SAN JOAOUN SON
NAAQS NATIONAL AMBIENT AIR QUALITY STANDARDS NAC NOISE ABATEMENT CRITERIA NBSSR NOISE BARRIER SCOPE SUMMARY REPORT	DESIGNED BY C. CUSSON DRAWN BY PEPD  DESIGNED BY C. CUSSON PEPD	CALI
	C. CUSSON  CHECKED BY  C, LEE	O

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							DRAWN BY
7/1							DESIGNED BY C. CUSSON

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CONSTRUCTION






## CALIFORNIA HIGH-SPEED TRAIN PROJECT BURBANK TO LOS ANGELES

OPTION B REVISED ALIGNMENT - REVISED FINAL PEPD ACRONYMS AND ABBREVIATIONS SHEET 5 OF 5

HSR	14-39
GE-0	o. CO405
SCALE NO S	SCALE

SHEET NO.

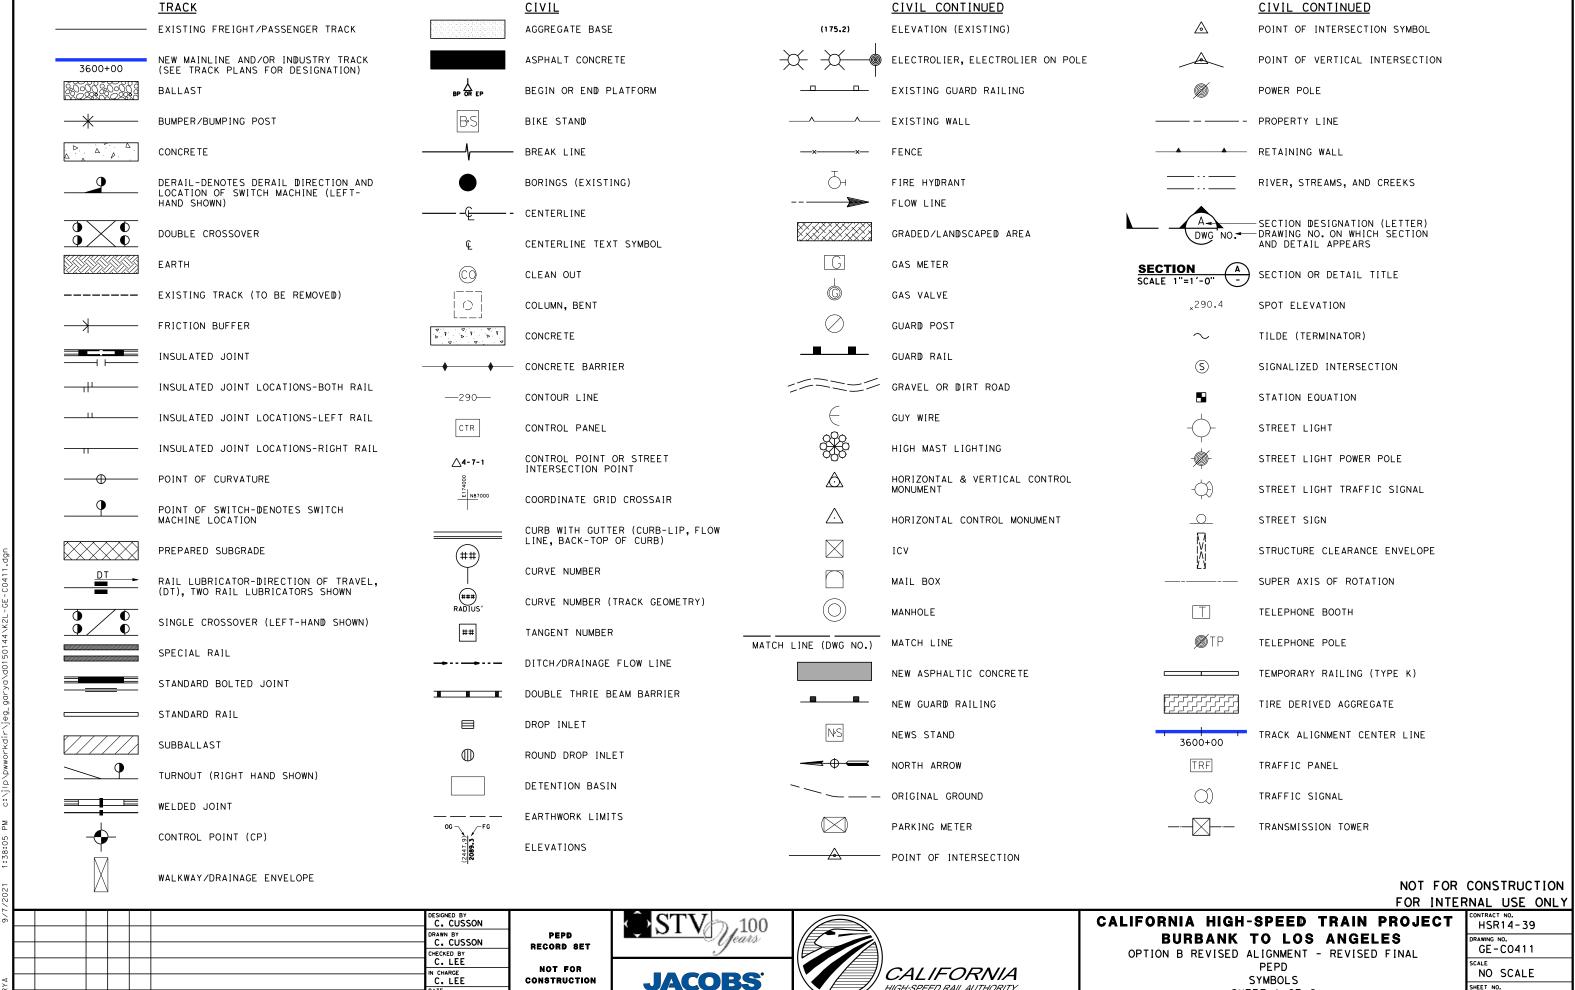

DATE

BY CHK APP


DESCRIPTION

08/27/2021

HIGH-SPEED RAIL AUTHORITY

SHEET NO.

SHEET 1 OF 2

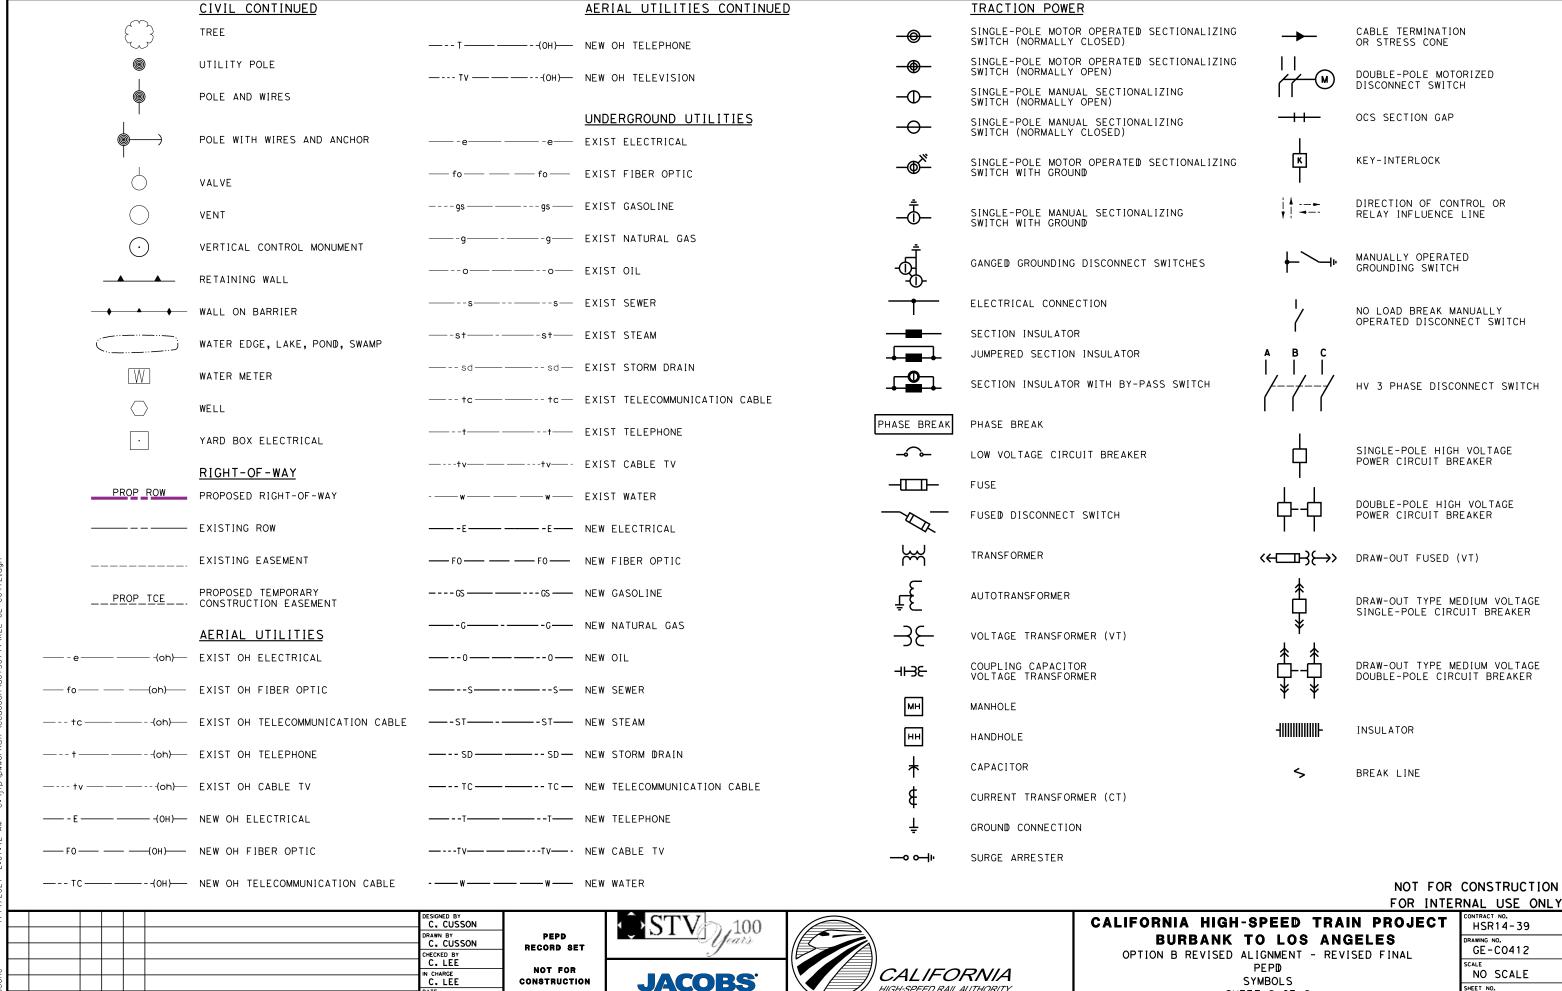

HIGH-SPEED RAIL AUTHORITY

CONSTRUCTION

07/15/2021

DATE

BY CHK APP

DESCRIPTION

PEPD SYMBOLS SHEET 2 OF 2

NO SCALE SHEET NO.

#### VOLUME 3.1

- 1. FOR UPRR ALIGNMENTS, SEE "TT-D1500" SHEETS.
- 2. FOR GRADE SEPARATION DETAILS, SEE VOLUME 3.
- 3. FOR AERIAL STRUCTURE DETAILS, SEE VOLUME 2.
- 4. RAIL ALIGNMENT BETWEEN MAIN STREET, UNION STATION, AND 1ST STREET IS BEING DESIGNED BY METRO'S LINKUS TEAM. THE ALIGNMENT THAT IS SHOWN IS BASED ON LATEST COORDINATION WITH THEIR TEAM, SHOWN FOR REFERENCE ONLY AND SUBJECT TO CHANGE.
- SCRRA TURNOUT GEOMETRY IS BASED ON THE 2009 EDITION OF THE SCRRA ENGINEERING STANDARDS.
- PROPOSED FENCE, WHERE INDICATED ON PLANS, REPRESENT AN ACCESS CONTROL WALL WITH FENCE. REFER TO TM 2.8.2 FOR ACCESS CONTROL FOR HIGH-SPEED RAIL RIGHT-OF-WAY AND FACILITIES.
- 7. FOR TUNNEL INFORMATION, SEE TUNNEL PLANS IN VOLUME 2.

#### VOLUME 3.2

- I. FOR TRACK INFORMATION, SEE TRACK PLANS IN VOLUME 1.
- FOR RIGHT-OF-WAY INFORMATION, SEE RIGHT-OF-WAY PLANS IN VOLUME 1.
- 3. FOR BRIDGE INFORMATION, SEE STRUCTURAL PLANS IN VOLUME 3.
- 4. FOR UTILITY INFORMATION, SEE UTILITY PLANS IN VOLUME 4.
- 5. FOR GRADING INFORMATION, SEE GRADING PLANS IN VOLUME 4.
- 6. FOR DRAINAGE INFORMATION, SEE DRAINAGE PLANS IN VOLUME 4.
- 7. FOR SYSTEM INFORMATION, SEE SYSTEM PLANS IN VOLUME 4.
- B. FOR TRENCH INFORMATION, SEE STRUCTURAL PLANS IN VOLUME 4.
- 9. ACCESS DETERRING SOLID BARRIER RAILING TO BE INSTALLED ON ALL EXISTING AND PROPOSED OVERHEAD BRIDGE STRUCTURES CROSSING HSR TRACKS PER RDP DIRECTIVE NO. 0006.

#### VOLUME 3.3

- 1. FOR TRACK INFORMATION, SEE TRACK PLANS IN VOLUME 1.
- 2. FOR RIGHT-OF-WAY INFORMATION, SEE RIGHT-OF-WAY PLANS IN VOLUME 1.
- 3. FOR AERIAL STRUCTURE INFORMATION, SEE STRUCTURAL PLANS IN VOLUME 2.
- 4. FOR RETAINING WALL INFORMATION, SEE RETAINING WALL PLANS IN VOLUME 2.
- 5. FOR UTILITY INFORMATION, SEE UTILITY PLANS IN VOLUME 4.
- 6. FOR GRADING INFORMATION, SEE GRADING PLANS IN VOLUME 4.
  7. FOR DRAINAGE INFORMATION, SEE DRAINAGE PLANS IN VOLUME 4.
- 8. FOR SYSTEM INFORMATION, SEE SYSTEM PLANS IN VOLUME 4.
- 9. FOR TRENCH INFORMATION, SEE STRUCTURAL PLANS IN VOLUME 4.
- 10. ACCESS DETERRING SOLID BARRIER RAILING TO BE INSTALLED ON ALL EXISTING AND PROPOSED OVERHEAD BRIDGE STRUCTURES CROSSING HSR TRACKS PER RDP DIRECTIVE NO. 0006.
- 11. FINAL DESIGN PROJECT TO COMPLY WITH NFPA 1901 (2016 EDITION) SECTION 12.3.2.3 FOR ALL GRADE SEPARATION AND STREET IMPROVEMENTS.
- 12. FINAL STREET IMPROVEMENT DESIGN TO MAINTAIN FIRE DEPARTMENT AND PEDESTRIAN ACCESS.

#### VOLUME 3.4

#### EXISTING COMPOSITE UTILITY NOTES:

- 1. FOR TRACK INFORMATION, SEE TRACK PLANS IN VOLUME 1.
- 2. UTILITY CONFLICTS ON CROSSING STREETS AT EXISTING GRADE SEPARATIONS ARE ANTICIPATED.
- ONLY THE FOLLOWING UTILITIES SHALL BE CONSIDERED MAJOR AND ARE IDENTIFIED IN THE UTILITY CONFLICTS MATRIX ON THE DRAWINGS.
  - A. WET UTILITIES:
    - I. SEWER, WATER, STORM DRAIN GREATER THAN OR EQUALTO 12".
  - II. ALL OIL LINES.
    - III. ALL FUEL (GASOLINE) LINES.
  - B. DRY UTILITIES:
    - I. ALL GAS LINES.
    - II. ALL FIBER OPTIC LINES.
    - III. ALL ELECTRIC LINES GREATER THAN 240V.
    - IV. ALL DUCT BANKS WITH 6 OR MORE DUCTS.
  - V. EXCLUDE INDIVIDUAL TELEPHONE, CABLE LINES.
    C. ALL OTHER CONFLICTS ARE CONSIDERED MINOR AND ARE NOT SHOWN IN
  - THE UTILITY CONFLICT MATRIX.
  - D. UTILITIES AT GRADE SEPARATIONS ARE NOT SHOWN IN THE UTILITY CONFLICTS MATRIX EVEN IF THEY FALL UNDER THE ABOVE CRITERIA SINCE VOLUMES 3 & 4 OFFER MORE SPECIFIC AND ACCURATE INFORMATION REGARDING THE DESIGN.

#### VOLUME 3.4 (CONT.)

- 4. REFER TO TRACK PLANS, VOLUME 1 AND PROPOSED UTILITY PLANS, VOLUME 4, FOR VERTICAL UTILITY CONFLICTS.
- 5. ADJUST UTILITY MANHOLES TO GRADE WHERE IMPACTIED BY EARTHWORK OR STREET IMPROVEMENTS.
- 6. USE LACTMA STANDARD DRAWINGS (2010) FOR TEMPORARY SUPPORT OF UTILITIES IMPACTED BY CUT AND FILL OPERATIONS.

#### GRADING AND DRAINAGE NOTES:

 CONTOUR GRADING ALONG THE HSR TRACKS IS BASED ON THE TOP OF SUBGRADE ELEVATIONS. BALLAST IS NOT INCLUDED

**GENERAL NOTES** 

 FOR RETAINING WALL INFORMATION, SEE RETAINING WALL PLANS IN VOLUME 2.

#### VOLUME 3.5

- 1. FOR MAIN LINE TRACK INFORMATION, SEE TRACK PLANS IN VOLUME 1.
- 2. FOR RIGHT-OF-WAY INFORMATION, SEE RIGHT-OF-WAY PLANS IN VOLUME 1.
- 3. FOR BRIDGE INFORMATION, SEE STRUCTURAL PLANS IN VOLUME 3.
- 4. FOR UTILITY INFORMATION, SEE UTILITY PLANS IN VOLUME 4.
- 5. FOR GRADING INFORMATION WITHIN MAIN LINE ROW, SEE GRADING PLANS IN VOLUME 4.
- 6. FOR DRAINAGE INFORMATION WITHIN MAIN LINE ROW, SEE DRAINAGE PLANS IN VOLUME 4.
- 7. FOR SYSTEM INFORMATION, SEE SYSTEM PLANS IN VOLUME 4.

#### VOLUME 3.6

1. CONSTRUCTION PHASING PROVIDED FOR PROPOSED WORK SOUTH OF HSR BURBANK STATION TO MAIN STREET. PHASING OF HSR BURBANK STATION AND LINKUS PROJECT NOT INCLUDED AS PART OF THIS SUBMITTAL

#### VOLUME 3.7

1. HSR BURBANK STATION CONCEPT DESIGN PROVIDED AS REFERENCE TO WORK PROPOSED AS PART OF THE PALMDALE TO BURBANK SEGMENT. FINAL DESIGN COORDINATION REQUIRED AT INTERFACE SOUTH OF STATION.

#### VOLUME 3.8

- LINKUS DESIGN PROVIDED AS REFERENCE TO WORK SOUTH OF MAIN STREET EXTENDING INTO LA UNION STATION.
- 2. FINAL DESIGN COORDINATION REQUIRED AT INTERFACE WEST OF MISSION TOWER BRIDGE. PROPOSED TRACK DESIGN BASED ON BEST AVAILABLE INFORMATION AT TIME OF DESIGN.

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PEPD RECORD SET

CONSTRUCTION







## CALIFORNIA HIGH-SPEED TRAIN PROJECT BURBANK TO LOS ANGELES

OPTION B REVISED ALIGNMENT - REVISED FINAL PEPD GENERAL NOTES AWING NO.
GE-B0411

NO SCALE

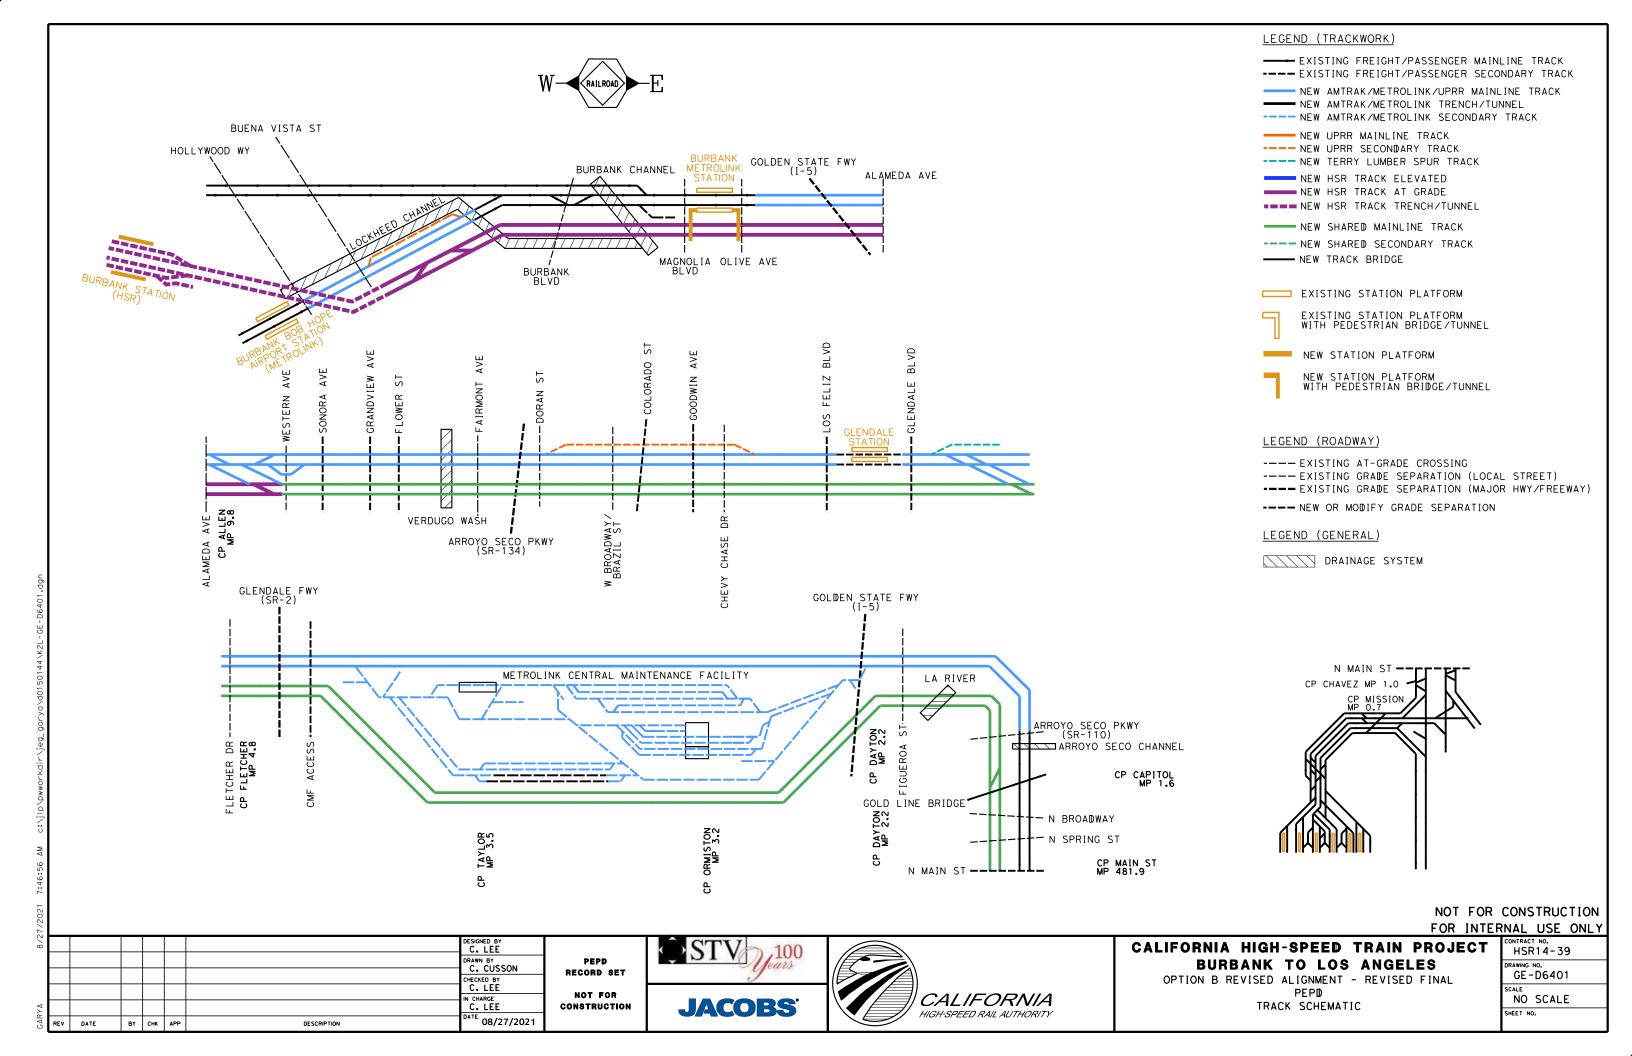

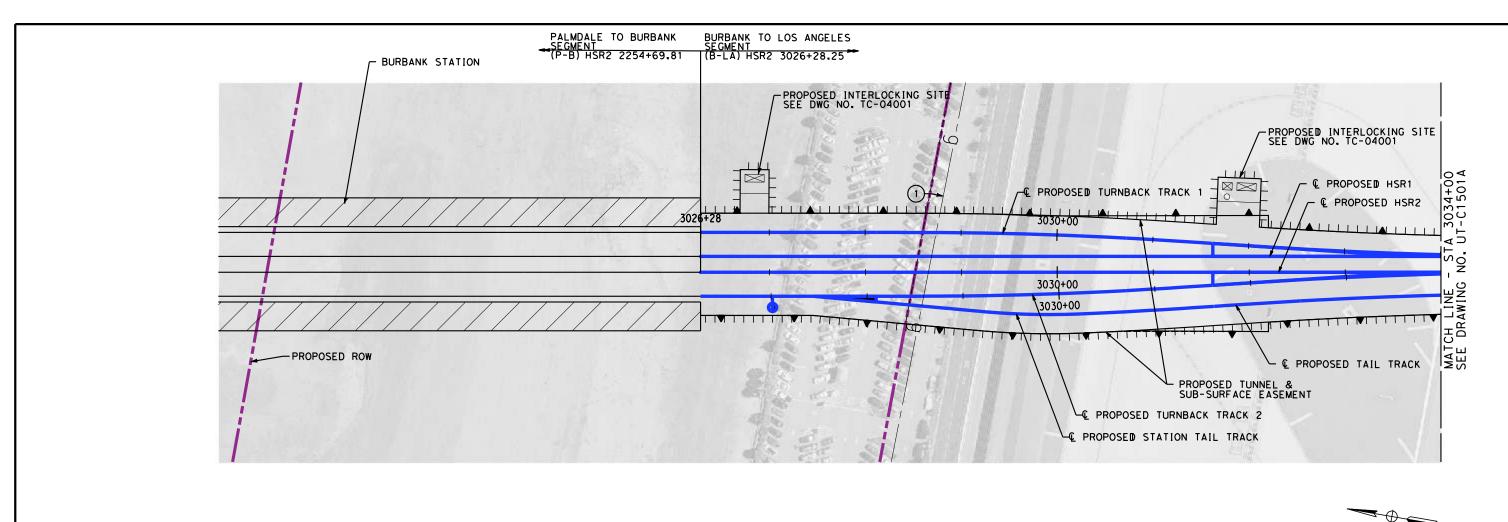

No.	TYPE OF UTILITY	SIZE / MATERIAL	LOCATION	OWNER	DISPOSITION
1	GAS	GAS LINE	STA 3028+59	SC GAS	RELOCATE

NOTE: NO UTILITY AS-BUILT INFORMATION HAS BEEN PROVIDED BY THE AIRPORT AUTHORITY.

50 0 50 100

I"=50' HOR.

SCALE APPLICABLE FOR FULL SIZE ONLY

NOT FOR CONSTRUCTION FOR INTERNAL USE ONLY

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			CHECKED BY	RE
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		<u> </u>	DESIGNED BY R. PETERS	
				R. PETERS  DRAWN BY C. CUSSON  CHECKED BY M. REIFER  IN CHARGE

PEPD RECORD SET NOT FOR CONSTRUCTION





## CALIFORNIA HIGH-SPEED TRAIN PROJECT BURBANK TO LOS ANGELES

OPTION B REVISED ALIGNMENT - REVISED FINAL PEPD COMPOSITE UTILITIES PLAN HSR2 3026+28 TO HSR2 3034+00

CONTRACT NO. HSR14-39
ORAWING NO. UT-C1501
SCALE AS SHOWN
SHEET NO.

No.	TYPE OF UTILITY	SIZE / MATERIAL	LOCATION	OWNER	DISPOSITION
1					

NOTE: NO UTILITY AS-BUILT INFORMATION HAS BEEN PROVIDED BY THE AIRPORT AUTHORITY.

50 0 50 100

I"=50' HOR.

SCALE APPLICABLE FOR FULL SIZE ONLY

NOT FOR CONSTRUCTION FOR INTERNAL USE ONLY

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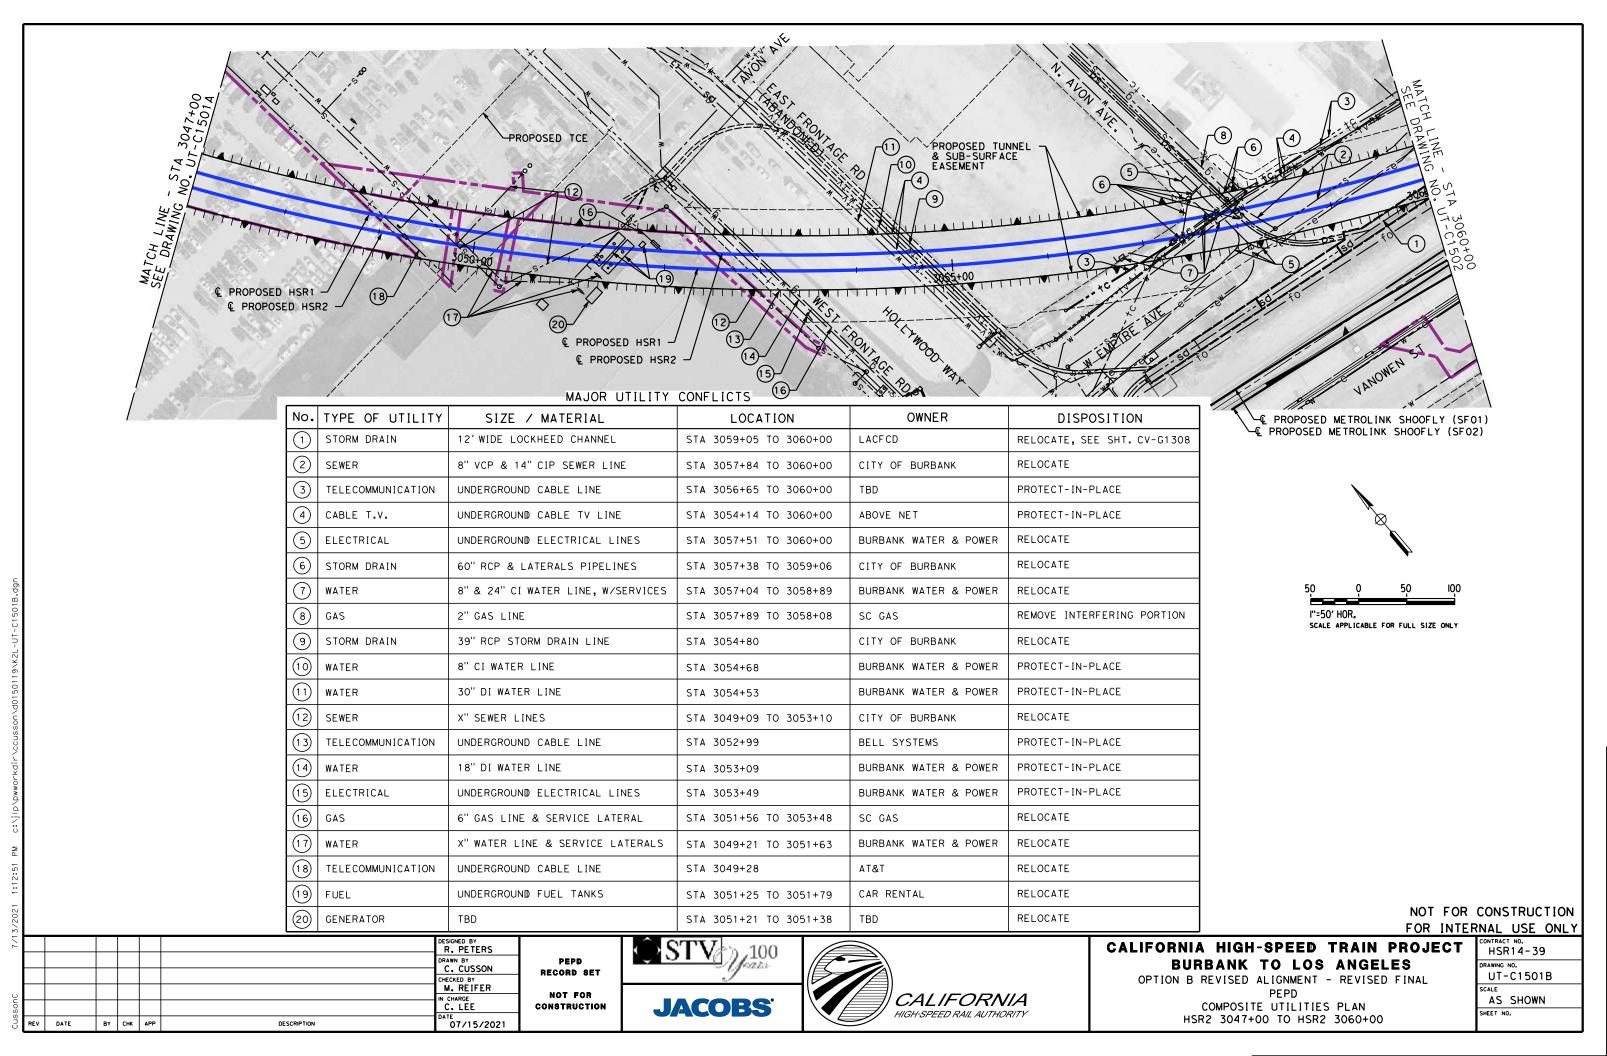



## CALIFORNIA HIGH-SPEED TRAIN PROJECT BURBANK TO LOS ANGELES

OPTION B REVISED ALIGNMENT - REVISED FINAL PEPD

COMPOSITE UTILITIES PLAN
HSR2 3034+00 TO HSR2 3047+00

<u>. H</u>	MAL USE ONLY
	CONTRACT NO. HSR14-39
	DRAWING NO. UT-C1501A
	SCALE AS SHOWN
	SHEET NO.



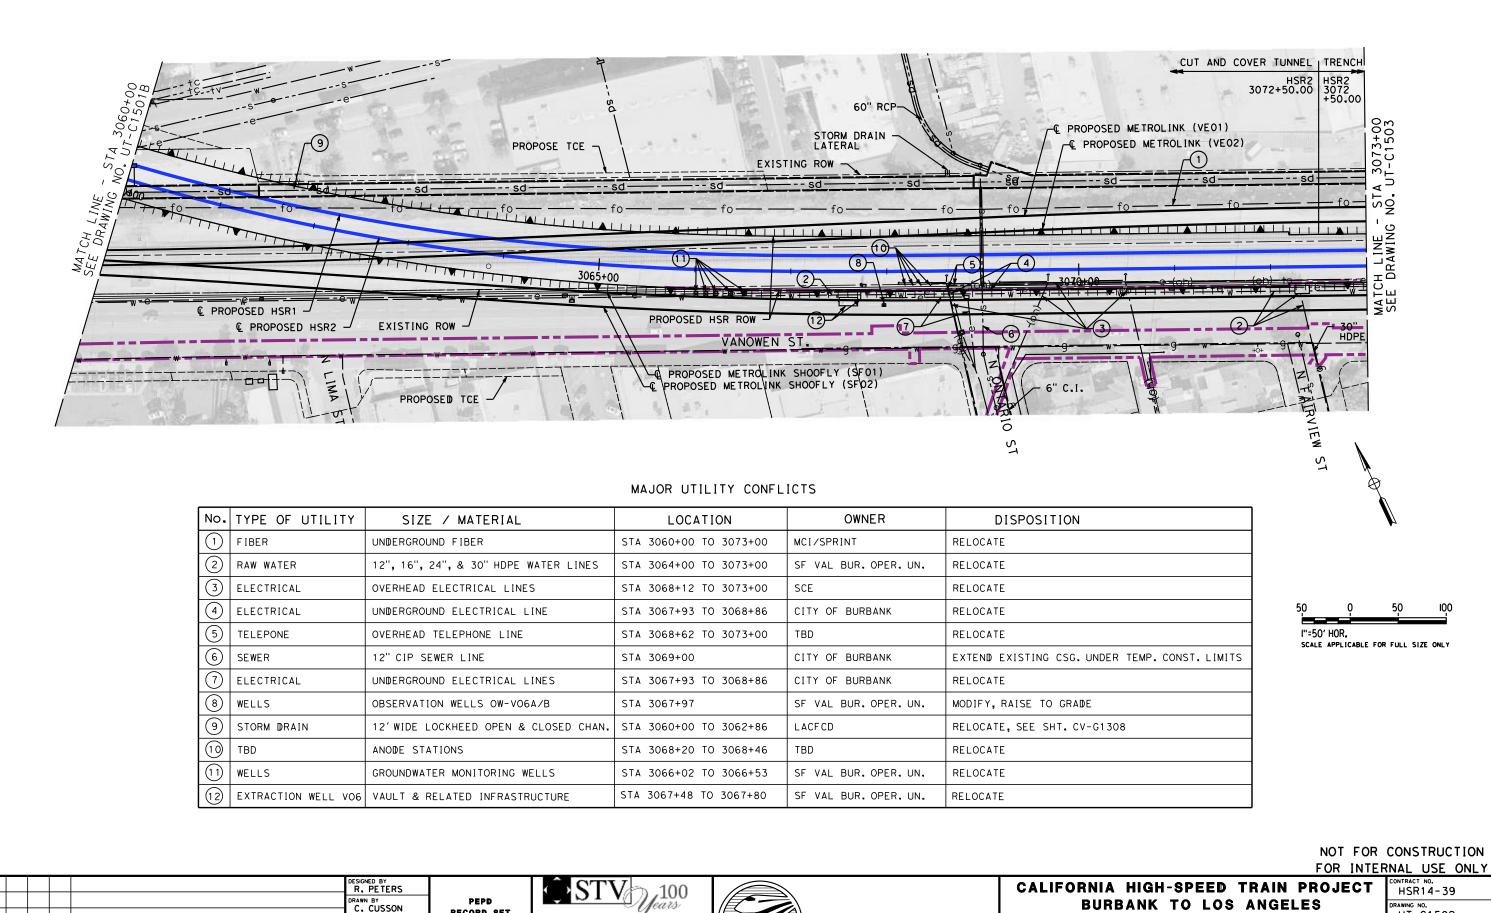

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CHECKED BY
M. REIFER

<sup>6</sup> 08/27/2021

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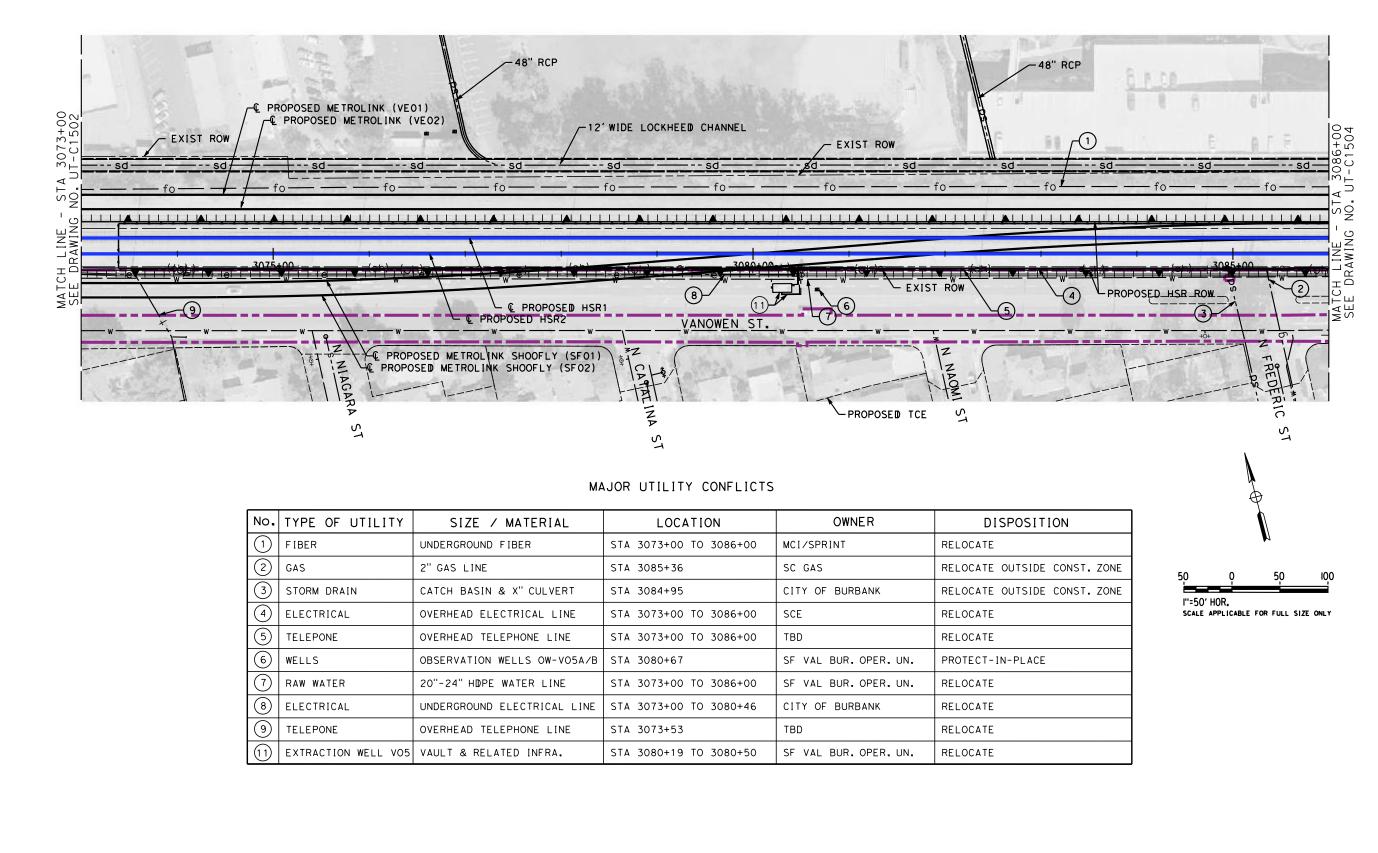




## BURBANK TO LOS ANGELES

OPTION B REVISED ALIGNMENT - REVISED FINAL COMPOSITE UTILITIES PLAN HSR2 3060+00 TO HSR2 3073+00

CONTRACT NO. HSR14-39
UT-C1502
AS SHOWN
SHEET NO.



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							DRAWN BY C. CUSSON	
7/1							DESIGNED BY  R. PETERS	

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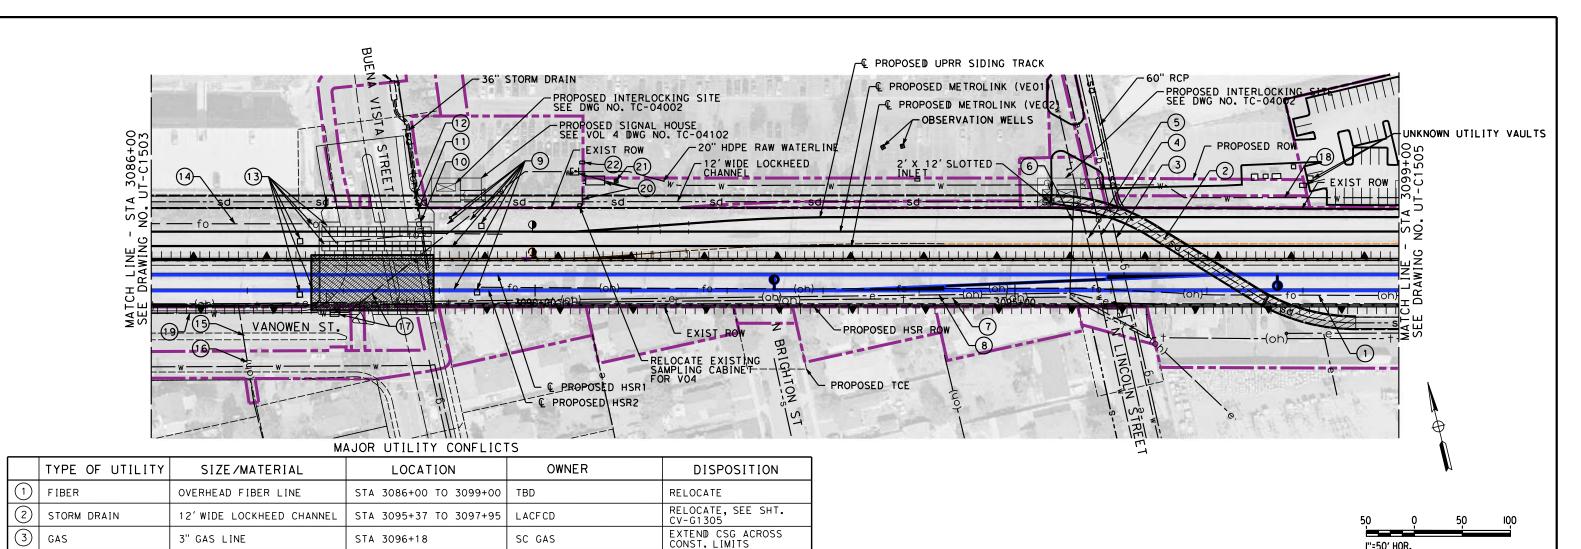


## CALIFORNIA HIGH-SPEED TRAIN PROJECT BURBANK TO LOS ANGELES

OPTION B REVISED ALIGNMENT - REVISED FINAL PEPD

COMPOSITE UTILITIES PLAN
HSR2 3073+00 TO HSR2 3086+00

CONTRACT NO. HSR14-39
UT-C1503
SCALE
AS SHOWN
SHEET NO.



MAJOR UTILITY CONFLICTS
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	TYPE OF UTILITY	SIZE/MATERIAL	LOCATION	OWNER	DISPOSITION
18	RAW WATER	20" HDPE WATER LINE	STA 3096+68 TO 3099+00	SF VAL BUR. OPER. UN.	RELOCATE
19	RAW WATER	22" HDPE WATER LINE	STA 3086+00 TO 3087+96	SF VAL BUR. OPER. UN.	RELOCATE
20	EXTRACTION WELL VO4	WELLS & RELATED INFRA.	STA 3090+44 TO 3090+87	SF VAL BUR. OPER. UN.	PROTECT-IN-PLACE WELL/ RELOCATE RELATED INFRA.
21)	WELLS	OBSERV. WELLS OW-VO4A/B	STA 3090+84	SF VAL BUR. OPER. UN.	PROTECT-IN-PLACE
22	ELECTRICAL	VAULT	STA 3090+49	CITY OF BUR.	PROTECT-IN-PLACE

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4	ELECTRICAL	UNDERGROUND ELEC. DUCTS	STA 3096+03	SCE	EXTEND CSG UNDER PROP LOCKHEED CHANNEL
5	WATER	20" WATER LINE	STA 3095+88	CITY OF BURBANK	EXTEND CSG ACROSS CONST. LIMITS
6	ELECTRICAL	QUEEN POLE	STA 3095+58	SCE	RELOCATE
7	TELECOMMUNICATION	OVERHEAD CABLE LINE	STA 3086+00 TO 3099+00	TBD	RELOCATE
8	ELECTRICAL	OVERHEAD ELECTRICAL LINE	STA 3086+00 TO 3099+00	SCE	RELOCATE
9	RAIL	RAIL UTILITIES	STA 3089+00 TO 3090+00	TBD	RELOCATE
10	ELECTRICAL	OVERHEAD ELECTRICAL LINE	STA 3088+93	SCE	RELOCATE
11	TELEPHONE	OVERHEAD TELEPHONE LINE	STA 3088+93	TBD	RELOCATE
12	TELECOMMUNICATION	OVERHEAD CABLE LINE	STA 3088+93	TBD	RELOCATE
13	RAIL	RAIL UTILITIES	STA 3087+00 TO 3088+00	TBD	RELOCATE
14	FIBER	UNDERGROUND FIBER	STA 3086+00 TO 3090+00	MCI/SPRINT	RELOCATE
15	TELEPHONE	OVERHEAD TELEPHONE LINE	STA 3086+92	TBD	RELOCATE
16	ELECTRICAL	OVERHEAD ELECTRICAL LINE	STA 3086+92	SCE	RELOCATE
(17)	RAW WATER	20" STEEL WATER LINE &	STA 3088+34	SF VAL BUR. OPER. UN.	RELOCATE PIPE & VALVE,

STA 3096+18

REFER TO PROPOSED UTILITY RELOCATION DWG. NO. UT-D7021 & UT-D7022 FOR UTILITY INFORMATION AT ROADWAY IMPROVEMENT

3" GAS LINE

R. PETERS DRAWN BY CHECKED BY
M. REIFER IN CHARGE DATE BY CHK APP DESCRIPTION 07/15/2021

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SC GAS





### NOT FOR CONSTRUCTION FOR INTERNAL USE ONLY CALIFORNIA HIGH-SPEED TRAIN PROJECT


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SCALE APPLICABLE FOR FULL SIZE ONLY

BURBANK TO LOS ANGELES OPTION B REVISED ALIGNMENT - REVISED FINAL COMPOSITE UTILITIES PLAN

HSR2 3086+00 TO HSR2 3099+00

CONTRACT NO. HSR14-39	
DRAWING NO.	
UT-C1504	
SCALE	
AS SHOWN	
SHEET NO.	

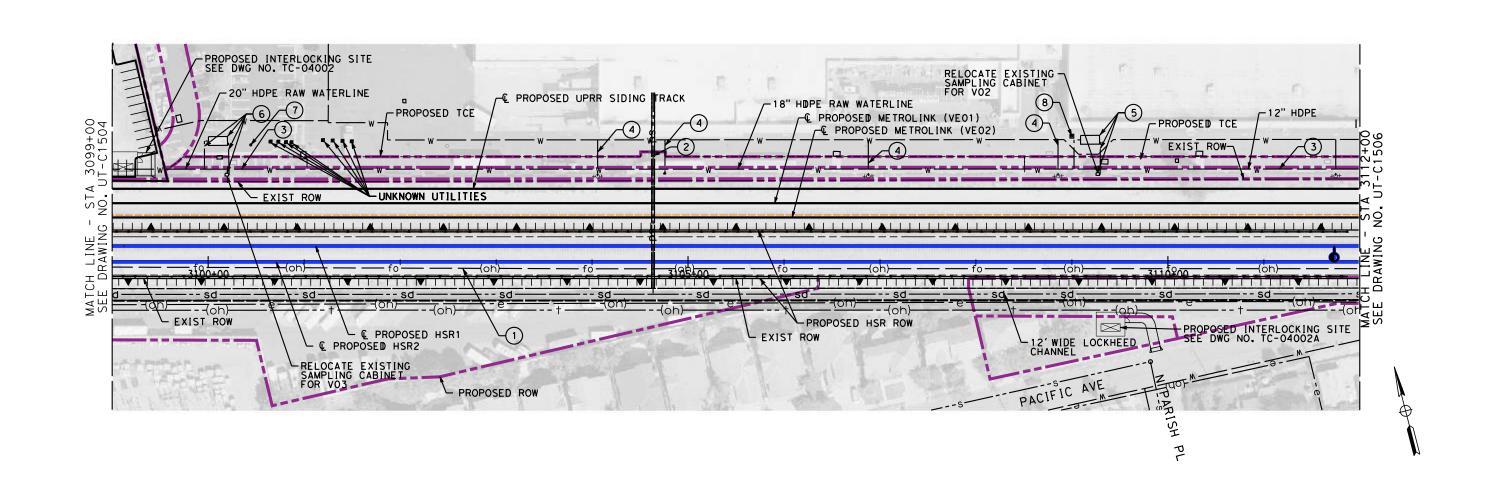

No.	TYPE OF UTILITY	SIZE / MATERIAL	LOCATION	OWNER	DISPOSITION
1	FIBER	OVERHEAD FIBER LINE	STA 3099+00 TO 3112+00	TBD	RELOCATE OUTSIDE ROW
2	STORM DRAIN	36" RCP	STA 3104+64	TBD	JOIN REALIGNED CHANNEL
3	RAW WATER	12", 18", & 20" HDPE	STA 3099+00 TO 3112+00	SF VAL BUR. OPER. UN.	RELOCATE
4	WATER - FIRE	WATER LINE FIXTURES	STA 3104+06 TO 3111+75	TBD	RELOCATE
5	EXTRACTION WELL VO2	WELLS & RELATED INFRA.	STA 3109+02 TO 3109+30	SF VAL BUR. OPER. UN.	PROTECT-IN-PLACE WELLS/ RELOCATE RELATED INFRA.
6	EXTRACTION WELL VO3	WELLS & RELATED INFRA.	STA 3099+96 TO 3100+22	SF VAL BUR. OPER. UN.	PROTECT-IN-PLACE WELLS/ RELOCATE RELATED INFRA.
7	WELLS	OBSERVATION WELLS OW-VO3A/B-R	STA 3100+44	SF VAL BUR. OPER. UN.	PROTECT-IN-PLACE
8	WELLS	OBSERVATION WELLS OW-VO2A/B-R	STA 3109+00	SF VAL BUR. OPER. UN.	PROTECT-IN-PLACE

NOT FOR CONSTRUCTION FOR INTERNAL USE ONLY

I"=50' HOR.

SCALE APPLICABLE FOR FULL SIZE ONLY

						DESIGNED BY R. PETERS	
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						IN CHARGE C. LEE	c
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## CALIFORNIA HIGH-SPEED TRAIN PROJECT BURBANK TO LOS ANGELES

OPTION B REVISED ALIGNMENT - REVISED FINAL PEPD
COMPOSITE UTILITIES PLAN
HSR2 3099+00 TO HSR2 3112+00

CONTRACT NO. HSR14-39	
DRAWING NO.	
UT-C1505	
SCALE	
AS SHOWN	
SHEET NO.	

	TYPE OF UTILITY	SIZE/MATERIAL	LOCATION	OWNER	DISPOSITION
1	FIBER	OVERHEAD FIBER LINE	STA 3112+00 TO 3125+00	TBD	RELOCATE
2	STORM DRAIN	36" RCP	STA 3121+14	TBD	JOIN REALIGNED CHANNEL
3	RAW WATER	12" HDPE WATER LINE	STA 3112+00 TO 3117+08	SF VAL BUR. OPER. UN.	RELOCATE
4	WATER	WATER LINE FIXTURES	STA 3116+31 TO 3121+43	TBD	RELOCATE
5	ELECTRICAL	UNDERGROUND ELECTRICAL	STA 3117+07 TO 3122+18	CITY OF BURBANK	RELOCATE
6	WATER	8" DI WATER LINE	STA 3122+34 TO 3125+00	TBD	RELOCATE
7	WELLS	OBSERVATION WELLS B-1-CW11/12	STA 3123+34 TO 3123+55	SF VAL BUR. OPER. UN.	RELOCATE
8	EXTRACTION WELL VO1	WELL & RELATED INFRA.	STA 3116+81 TO 3117+10	SF VAL BUR. OPER. UN.	PROTECT-IN-PLACE WELL/ RELOCATE RELATED INFRA.
9	WELLS	OBSERVATION WELLS OW-VO1A/B-R	STA 3116+82	SF VAL BUR. OPER. UN.	PROTECT-IN-PLACE

I"=50' HOR. SCALE APPLICABLE FOR FULL SIZE ONLY

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## CALIFORNIA HIGH-SPEED TRAIN PROJECT BURBANK TO LOS ANGELES

OPTION B REVISED ALIGNMENT - REVISED FINAL PEPD

COMPOSITE UTILITIES PLAN
HSR2 3112+00 TO HSR2 3125+00

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CONTRACT NO. HSR14-39
DRAWING NO.
UT-C1506
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SCALE
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SHEET NO.

	MAJOR UTILITY CONFLICTS						
No.	TYPE OF UTILITY	SIZE / MATERIAL	LOCATION	OWNER	DISPOSITION		
1	STORM DRAIN	12' WIDE LOCKHEED CHANNEL	STA 3125+00 TO 3138+00	LACFCD	RELOCATE SEE CV-G1302, CV-G1303		
2	FIBER	4-2" HDPE DUCTS	STA 3131+69 TO 3138+00	QWEST (CENTURY LINK)	RELOCATE		
3	ELECTRICAL	OVERHEAD POWER LINE	STA 3128+82 TO 3138+00	SCE	RELOCATE		
4	WATER	X" WATER LINE	STA 3137+05	BURBANK WATER & POWER	RELOCATE		
(5)	GAS	3" GAS LINE	STA 3137+00	SC GAS	RELOCATE		
6	FIBER	OVERHEAD FIBER LINE	STA 3125+00 TO 3137+18	TBD	RELOCATE		
7	TELEPHONE	OVERHEAD PHONE LINE	STA 3128+82 TO 3138+00	AT&T	RELOCATE		
8	SEWER	8" VCP SEWER LINE	STA 3135+02	CITY OF BURBANK	RELOCATE AND ADD CSG FROM ROW TO ROW		
9	TELEPHONE	OVERHEAD PHONE LINE	STA 3135+00	AT&T	RELOCATE		
10	ELECTRICAL	OVERHEAD POWER LINE	STA 3135+00	SCE	RELOCATE		
11)	ELECTRICAL	OVERHEAD POWER LINE	STA 3130+87	SCE	RELOCATE		
12	STORM DRAIN	36" CMP	STA 3128+84	LACFCD	JOIN REALIGNED CHANNEL		
13	WATER	8" AND 12" DI WATER LINE	STA 3125+00 TO 3126+45	TBD	REL. 8" AND EXTEND CASING ON 12"		
14)	STORM DRAIN	TBD	STA 3128+55	TBD	RELOCATE		
15	TELEPHONE	UNDERGROUND TELECOMMICATION LINE	STA 3129+42	AT&T	RELOCATE		
16	ELECTRICAL	ELECTRICAL CABINET	STA 3129+64	TBD	RELOCATE		
REFE	R TO PROPOSED UTILIT	TY RELOCATION DWG. NO. UT-17021	FOR UTILITY INFORMATION A	T ROADWAY IMPROVEMENT			

NOT FOR CONSTRUCTION

I"=50' HOR.

SCALE APPLICABLE FOR FULL SIZE ONLY

	R. PETERS	
	RAWN BY C. CUSSON	
_	HECKED BY	1
	M. REIFER	

DESCRIPTION

IN CHARGE

07/15/2021

PEPD RECORD SET NOT FOR CONSTRUCTION





## CALIFORNIA HIGH-SPEED TRAIN PROJECT BURBANK TO LOS ANGELES

OPTION B REVISED ALIGNMENT - REVISED FINAL COMPOSITE UTILITIES PLAN HSR2 3125+00 TO HSR2 3138+00

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ROJECT	CONTRACT NO. HSR14-39
I <b>S</b> Inal	DRAWING NO. UT-C1507
	SCALE AS SHOWN
	SHEET NO.

DATE

BY CHK APP

No. TYPE OF UTILITY SIZE / MATERIAL OWNER DISPOSITION LOCATION 8" VCP SEWER LINE STA 3140+86 CITY OF BURBANK ADD CSG FROM ROW TO RET. WALL SEWER WATER 16" WATER LINE STA 3141+35 BURBANK WATER & POWER ADD CSG FROM ROW TO RET. WALL (3) RELOCATE, SEE SHT. CV-G1301 STORM DRAIN 12' WIDE LOCKHEED CHANNEL STA 3140+11 TO 3151+00 LACFCD (4) 15" VCP SEWER LINE STA 3146+73 CITY OF BURBANK SEWER RELOCATE, ADD CASING STORM DRAIN STA 3147+48 TO 3151+00 72" STORM DRAIN LACFCD RELOCATE (6) STORM DRAIN LACFCD STA 3141+79 60" STORM DRAIN PROTECT, SEE SHT. CV-G1301 FOR EXTENSION  $\overline{7}$ SEWER 24" VCP STA 3149+04 TO 3151+00 CITY OF BURBANK RELOCATE (8) WATER 12" DUCTICLE IRON STA 3147+55 CITY OF BURBANK RELOCATE INTERFERING PORTION WITH NEW S.D. ELECTRICAL OVERHEAD POWER LINE STA 3138+00 TO 3151+00 SCE RELOCATE

REFER TO PROPOSED UTILITY RELOCATION DWG. NO. UT-D7041 FOR UTILITY INFORMATION AT ROADWAY IMPROVEMENT

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## CALIFORNIA HIGH-SPEED TRAIN PROJECT BURBANK TO LOS ANGELES OPTION B REVISED ALIGNMENT - REVISED FINAL

OPTION B REVISED ALIGNMENT - REVISED FINAL PEPD

COMPOSITE UTILITIES PLAN
HSR2 3138+00 TO HSR2 3151+00

CONTRACT NO. HSR14-39	
DRAWING NO.	
UT-C1508	
SCALE	
AS SHOWN	
SHEET NO.	

MAJOR UTILITY CONFLICTS						
No.	TYPE OF UTILITY	SIZE / MATERIAL	LOCATION	OWNER	DISPOSITION	
1	FIBER	4-2" HDPE DUCTS	STA 3151+00 TO 3164+00	QWEST(CENTURY LINK)	RELOCATE	
2	FIBER	4-2" HDPE DUCTS	STA 3151+00 TO 3164+00	MCI(VERIZON)-AT&T-SPRINT	RELOCATE	
3	STORM DRAIN	12' WIDE LOCKHEED CHANNEL	STA 3151+00 TO 3153+81	LACFCD	RELOCATE, SEE SHT. CV-G1301	
4	STORM DRAIN	28' WIDE BURBANK CHANNEL	STA 3152+60 TO 3154+62	LACFCD	PROTECT-IN-PLACE	
5	WATER	16" DIP	STA 3156+75	BURBANK WATER & POWER	RELOCATE AND ADD CSG FROM ROW TO ROW	
6	GAS	12" GAS LINE	STA 3151+00 TO 3164+00	SC GAS	RELOCATE	
7	SEWER	3-12" VCP	STA 3152+82 TO 3152+95	CITY OF BURBANK	RELOCATE	
8	SEWER	24" VCP	STA 3151+00 TO 3154+00	CITY OF BURBANK	RELOCATE	
9	SEWER	12" VCP	STA 3152+00 TO 3153+55	CITY OF BURBANK	RELOCATE	
10	SEWER	18" VCP	STA 3152+70 TO 3155+00	CITY OF BURBANK	PROTECT-IN-PLACE	
11)	STORM DRAIN	60" CMP & OPEN CONC. CHANNEL	STA 3162+95	LACFCD	REPLACE OPEN SECTION WITH PIPE, ADD CSG FROM ROW TO ROW	
12	ELECTRICAL	OH-ELECTRICAL	STA 3151+00 TO 3154+39	SCE	RELOCATE	
13	CABLE	OH-CABLE	STA 3159+38	TBD	PROTECT-IN-PLACE	
14)	ELECTRICAL	OH-ELECTRICAL	STA 3162+51	SCE	RELOCATE	

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I"=50' HOR. SCALE APPLICABLE FOR FULL SIZE ONLY

REFER TO PROPOSED UTILITY RELOCATION DWG. NO. UT-D7051 FOR UTILITY INFORMATION AT ROADWAY IMPROVEMENT

NOT FOR CONSTRUCTION FOR INTERNAL USE ONLY

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ر							M. REIFER IN CHARGE	
2							C. LEE	CO
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## CALIFORNIA HIGH-SPEED TRAIN PROJECT BURBANK TO LOS ANGELES

OPTION B REVISED ALIGNMENT - REVISED FINAL PEPD COMPOSITE UTILITIES PLAN HSR2 3151+00 TO HSR2 3164+00

NAL USE ONL
CONTRACT NO. HSR14-39
DRAWING NO. UT-C1509
SCALE AS SHOWN
SHEET NO.

No.	TYPE OF UTILITY	SIZE / MATERIAL	LOCATION	OWNER	DISPOSITION
1	GAS	12" GAS LINE	STA 3164+00 TO TBD	SC GAS	RELOCATE
2	STORM DRAIN	54" STORM DRAIN	STA 3170+16	LACFCD	PROTECT-IN-PLACE
3	TELEPHONE	OVERHEAD PHONE LINE	STA 3170+93	AT&T	RELOCATE UNDERGROUND WITH CSG
4	WATER	12" SHARING 100' OF 18" CSG	STA 3170+79	BURBANK WATER & POWER	PROTECT-IN-PLACE
5	GAS (ABAN)	6" GAS LINE	STA 3170+66	SC GAS	PROTECT-IN-PLACE
6	STORM DRAIN	84" RCP	STA 3170+73	LACFCD	PROTECT-IN-PLACE
7	WATER	20" SHARING 100' OF 30" CSG	STA 3174+30	BURBANK WATER & POWER	RELOCATE

NOT FOR CONSTRUCTION FOR INTERNAL USE ONLY

7.13							DESIGNED BY	
							R. PETERS  DRAWN BY C. CUSSON	
							CHECKED BY M. REIFER	1
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## CALIFORNIA HIGH-SPEED TRAIN PROJECT BURBANK TO LOS ANGELES

OPTION B REVISED ALIGNMENT - REVISED FINAL PEPD COMPOSITE UTILITIES PLAN HSR2 3164+00 TO HSR2 3177+00

CONTRACT NO. HSR14-39
DRAWING NO. UT-C1510
SCALE
AS SHOWN
SHEET NO.

No.	TYPE OF UTILITY	SIZE / MATERIAL	LOCATION	OWNER	DISPOSITION
1	OIL	20" OIL LINE	STA 3143+00 TO 3684+00	PACIFIC PIPELINE	RELOCATE
2	FIBER	4-2" HDPE DUCTS	STA 3143+00 TO 3684+00	QWEST(CENTURY LINK)	RELOCATE
3	FIBER	4-2" HDPE DUCTS	STA 3143+00 TO 3684+00	MCI(VERIZON)-AT&T-SPRINT	RELOCATE
4	FIBER	4-2" HDPE DUCTS	STA 3143+00 TO 3684+00	QWEST-MFS-METRO	RELOCATE
(5)	ELECTRICAL	IN-BRIDGE POWER LINE	STA 3182+03 AND 3182+65	SCE	PROTECT-IN-PLACE
6	STORM DRAIN	60" STORM DRAIN	STA 3182+07	LACFCD	PROTECT-IN-PLACE
7	TELEPHONE	IN-BRIDGE PHONE LINE	STA 3182+07	AT&T	PROTECT-IN-PLACE
8	STORM DRAIN	102" STORM DRAIN	STA 3182+85	LACFCD	PROTECT-IN-PLACE
9	GAS (ABAN)	8" GAS LINE	STA 3182+60	SC GAS	REMOVE
10	ELECTRICAL	IN-BRIDGE POWER LINE	STA 3182+34	TBD	PROTECT-IN-PLACE

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						DESIGNED BY R. PETERS DRAWN BY	
						C. CUSSON  CHECKED BY  M. REIFER	F
						IN CHARGE C. LEE DATE	C
REV	DATE	ВΥ	СНК	APP	DESCRIPTION	07/15/2021	

PEPD RECORD SET NOT FOR CONSTRUCTION





## CALIFORNIA HIGH-SPEED TRAIN PROJECT BURBANK TO LOS ANGELES

OPTION B REVISED ALIGNMENT - REVISED FINAL COMPOSITE UTILITIES PLAN HSR2 3177+00 TO HSR2 3190+00

	CONTRACT NO. HSR14-39
	UT-C1511
ı	SCALE
	AS SHOWN
	SHEET NO.
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No.	TYPE OF UTILITY	SIZE / MATERIAL	LOCATION	OWNER	DISPOSITION
1	OIL	20" OIL LINE	STA 3143+00 TO 3684+00	PACIFIC PIPELINE	RELOCATE
2	FIBER	4-2" HDPE DUCTS	STA 3143+00 TO 3684+00	QWEST(CENTURY LINK)	RELOCATE
3	FIBER	4-2" HDPE DUCTS	STA 3143+00 TO 3684+00	MCI(VERIZON)-AT&T-SPRINT	RELOCATE
4	FIBER	4-2" HDPE DUCTS	STA 3143+00 TO 3684+00	QWEST-MFS-METRO	RELOCATE
5	WATER	41" SHARING 100' OF 48" CSG	STA 3194+50	MWD	EXTEND CSG FROM ROW TO ROW
6	SEWER	10" SEWER LINE	STA 3194+65	CITY OF BURBANK	ADD CSG FROM ROW TO ROW
7	GAS	12" GAS LINE	STA 3194+48	SC GAS	ADD CSG FROM ROW TO ROW
8	STORM DRAIN	90" STORM DRAIN	STA 3194+75	LACFCD	PROTECT-IN-PLACE
9	WATER	10" IN 100' OF 18" CSG	STA 3194+65	BURBANK WATER & POWER	EXTEND CSG FROM ROW TO ROW
10	WATER	18" IN 100' OF 24" CSG	STA 3202+30	BURBANK WATER & POWER	EXTEND CSG FROM ROW TO ROW
11)	SEWER	12" VCP SEWER LINE	STA 3202+40	CITY OF BURBANK	ADD CSG FROM ROW TO ROW

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							R. PETERS  DRAWN BY C. CUSSON	
							CHECKED BY M. REIFER	1
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## CALIFORNIA HIGH-SPEED TRAIN PROJECT BURBANK TO LOS ANGELES

OPTION B REVISED ALIGNMENT - REVISED FINAL COMPOSITE UTILITIES PLAN HSR2 3190+00 TO HSR2 3203+00

CONTRACT NO. HSR14-39					
DRAWING NO.					
UT-C1512					
SCALE					
AS SHOWN					
SHEET NO.					

No.	TYPE OF UTILITY	SIZE / MATERIAL	LOCATION	OWNER	DISPOSITION
1	OIL	20" OIL LINE	STA 3143+00 TO 3684+00	PACIFIC PIPELINE	RELOCATE
2	FIBER	4-2" HDPE DUCTS	STA 3143+00 TO 3684+00	QWEST	RELOCATE
3	FIBER	4-2" HDPE DUCTS	STA 3143+00 TO 3684+00	MCI(VERIZON)-AT&T-SPIRNT	RELOCATE
4	FIBER	4-2" HDPE DUCTS	STA 3143+00 TO 3684+00	QWEST-MFS-METRO	RELOCATE

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## CALIFORNIA HIGH-SPEED TRAIN PROJECT BURBANK TO LOS ANGELES

OPTION B REVISED ALIGNMENT - REVISED FINAL PEPD COMPOSITE UTILITIES PLAN HSR2 3203+00 TO HSR2 3216+00

HSR14-39
DRAWING NO.
UT-C1513
SCALE
AS SHOWN
SHEET NO.

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No.	TYPE OF UTILITY	SIZE / MATERIAL	LOCATION	OWNER	DISPOSITION	
1	OIL	20" OIL LINE	STA 3143+00 TO 3684+00	PACIFIC PIPELINE	RELOCATE	
2	FIBER	4-2" HDPE DUCTS	STA 3143+00 TO 3684+00	QWEST(CENTURY LINK)	RELOCATE	
3	FIBER	4-2" HDPE DUCTS	STA 3143+00 TO 3684+00	MCI(VERIZON)-AT&T-SPRINT	RELOCATE	
4	FIBER	4-2" HDPE DUCTS	STA 3143+00 TO 3684+00	QWEST- MFS-METRO	RELOCATE	
5	GAS (ABAN)	26" GAS	STA 3177+00 TO 3289+00	SC GAS	REMOVE	
6	TELEPHONE	OVERHEAD CABLE	HEAD CABLE STA 3220+00 TO 3242+27 TBD		PROTECT-IN-PLACE	
7	OVERHEAD POWER LINE	OVERHEAD CABLE	STA 3217+98/ ALAMEDA AVE.	GLENDALE W & P	RAISE/RELOCATE	
8	TELEPHONE	OVERHEAD CABLE	STA 3217+98/ ALAMEDA AVE.	TBD	RAISE/RELOCATE	
9	GAS	4" GAS IN 100' OF 8" CSG	STA 3220+00/ ALAMEDA AVE.	SC GAS	RELOCATE	
10	STORM DRAIN	72" STORM DRAIN	STA 3118+40/ ALAMEDA AVE.	GLENDALE DPW	PROTECT-IN-PLACE	
(1)	STORM DRAIN	12" STORM DRAIN	STA 3118+80/ ALAMEDA AVE.	GLENDALE DPW	PROTECT-IN-PLACE	
(12)	WATER	12" CI IN 100' OF 21" CSG	STA 3219+20/ ALAMEDA AVE.	BURBANK WATER & POWER	PROTECT-IN-PLACE	
(3)	STORM DRAIN	48" STORM DRAIN	STA 3219+20/ ALAMEDA AVE.	GLENDALE DPW	PROTECT-IN-PLACE	
14)	SEWER	12" VCP SEWER	STA 3219+20/ ALAMEDA AVE.	GLENDALE DPW	PROTECT-IN-PLACE	
(15)	WATER	8" WATER	STA 3224+17 TO 3228+36	CITY OF BURBANK	PROTECT-IN-PLACE	
16	WATER	8" CI SHARING 66' OF 36" CSG	STA 3228+41/ E LINDEN AVE.	CITY OF BURBANK	EXTEND CSG FROM ROW TO ROW	
17)	SEWER	8" VCP SHARING 66' OF 36" CSG	STA 3228+42/ E LINDEN AVE.	CITY OF BURBANK	EXTEND CSG FROM ROW TO ROW	

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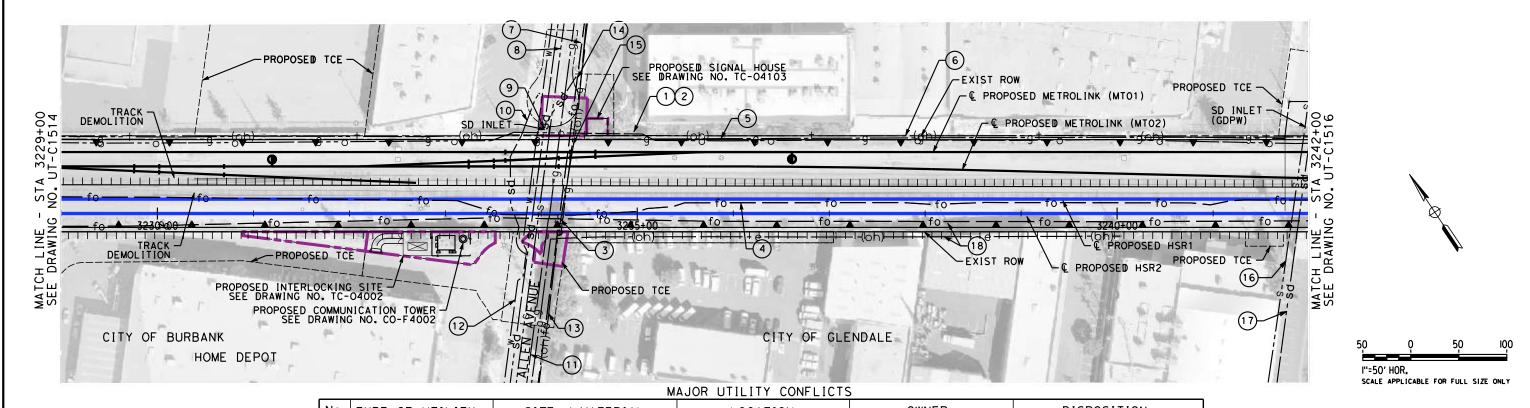




## CALIFORNIA HIGH-SPEED TRAIN PROJECT BURBANK TO LOS ANGELES

OPTION B REVISED ALIGNMENT - REVISED FINAL PEPD COMPOSITE UTILITIES PLAN HSR2 3216+00 TO HSR2 3229+00

CONTRACT NO. HSR14-39
UT-C1514
SCALE
AS SHOWN
SHEET NO.



No.	TYPE OF UTILITY	SIZE / MATERIAL	LOCATION	OWNER	DISPOSITION
1	OIL	20" OIL LINE	STA 3143+00 TO 3684+00	PACIFIC PIPELINE	RELOCATE
2	FIBER	4-2" HDPE DUCTS	STA 3143+00 TO 3684+00	QWEST(CENTURY LINK)	RELOCATE
3	FIBER	4-2" HDPE DUCTS	STA 3143+00 TO 3684+00	MCI(VERIZON)-AT&T-SPRINT	RELOCATE
4	FIBER	4-2" HDPE DUCTS	STA 3143+00 TO 3684+00	QWEST-MFS-METRO	RELOCATE
5	GAS (ABAN)	26" GAS	STA 3220+00 TO 3289+00	SC GAS	REMOVE
6	TELEPHONE	OVERHEAD CABLE	STA 3220+00 TO 3242+22	TBD	PROTECT-IN-PLACE
7	FIBER	OVERHEAD CABLE	STA 3230+22/ ALLEN AVE.	CHARTER	RELOCATE
8	SEWER	8" VCP IN CSG	STA 3233+98/ ALLEN AVE.	GLENDALE DPW	EXTEND CSG FROM ROW TO ROW
9	STORM DRAIN	33" RCP 4' COVER	STA 3233+91/ ALLEN AVE.	GLENDALE DPW	EXTEND CSG FROM ROW TO ROW
10	STORM DRAIN	3'X10' RCB	STA 3233+73/ ALLEN AVE.	GLENDALE DPW	ADD CSG FROM ROW TO ROW
11)	GAS	30" H GAS IN 83' OF 36" CSG	STA 3234+09/ ALLEN AVE.	SC GAS	RELOCATE
12	WATER	12" DIP	STA 3233+85/ ALLEN AVE.	GLENDALE W & P	EXTEND CSG FROM ROW TO ROW
13	ELECTRICAL	OVERHEAD WIRE	STA 3230+22/ ALLEN AVE.	GLENDALE W & P	RELOCATE UNDERGROUND
14)	UG FIBER	IN CSG	STA 3234+20/ ALLEN AVE.	AT&T	RELOCATE
15)	GAS	4" IN 80' OF 8" CSG	STA 3234+23/ ALLEN AVE.	SC GAS	RELOCATE
16	SEWER	8" VCP IN 6" CONCRETE CSG	STA 3241+83/ THOMPSON AVE.	GLENDALE DPW	PROTECT-IN-PLACE
17	STORM DRAIN	30" RCP	STA 3241+91/ THOMPSON AVE.	GLENDALE DPW	ADD CSG FROM ROW TO ROW
18	ELECTRICAL	ELECT. METER/POLE	STA 3238+22	SO. PACIFIC RR	RELOCATE

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## CALIFORNIA HIGH-SPEED TRAIN PROJECT BURBANK TO LOS ANGELES

OPTION B REVISED ALIGNMENT - REVISED FINAL COMPOSITE UTILITIES PLAN HSR2 3229+00 TO HSR2 3242+00

CONTRACT NO. HSR14-39
DRAWING NO. UT-C1515
AS SHOWN
SHEET NO.

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No.	TYPE OF UTILITY	SIZE / MATERIAL	LOCATION	OWNER	DISPOSITION
1	OIL	20" OIL LINE	STA 3143+00 TO 3684+00	PACIFIC PIPELINE	RELOCATE
2	FIBER	4-2" HDPE DUCTS	STA 3143+00 TO 3684+00	QWEST(CENTURY LINK)	RELOCATE
3	FIBER	4-2" HDPE DUCTS	STA 3143+00 TO 3684+00	QWEST-MFS-METRO	RELOCATE
4	FIBER	4-2" HDPE DUCTS	STA 3143+00 TO 3684+00	MCI/VERIZON-AT&T-SPRINT	RELOCATE
5	GAS (ABAN)	26" GAS	STA 3220+00 TO 3289+00	SC GAS	REMOVE
6	STORM DRAIN	33" RCP	STA 3249+29/ WESTERN AVE.	GLENDALE DPW	ADD CASING FROM ROW TO ROW RELOCATE MANHOLE
7	SEWER	8" VCP IN 15" STEEL CSG	STA 3249+37/ WESTERN AVE.	GLENDALE DPW	PROTECT-IN-PLACE
8	FIBER	SLACK COIL	STA 3249+66/ WESTERN AVE.	ZAYO	EXTEND CSG FROM ROW TO ROW
9	WATER	12" WATER	STA 3249+58/ WESTERN AVE.	GLENDALE W & P	EXTEND CSG FROM ROW TO ROW
10	STORM DRAIN	18" RCP	STA 3249+34/ WESTERN AVE.	GLENDALE DPW	PROTECT-IN-PLACE
11	STORM DRAIN	18" RCP	STA 3249+19/ WESTERN AVE.	GLENDALE DPW	ADD CASING FROM ROW TO ROW
12	STORM DRAIN	24" RCP	STA 3249+19/ WESTERN AVE.	GLENDALE DPW	ADD CASING FROM ROW TO ROW
13	OIL	8" OIL	STA 3249+70/ WESTERN AVE.	EXXON MOBIL	ADD CASING FROM ROW TO ROW

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### CALIFORNIA HIGH-SPEED TRAIN PROJECT BURBANK TO LOS ANGELES

OPTION B REVISED ALIGNMENT - REVISED FINAL PEPD COMPOSITE UTILITIES PLAN HSR2 3242+00 TO HSR2 3255+00

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CONTRACT NO. HSR14-39
DRAWING NO. UT-C1516
SCALE AS SHOWN
SHEET NO.

No.	TYPE OF UTILITY	SIZE / MATERIAL	LOCATION	OWNER	DISPOSITION
1	OIL	20" OIL LINE	STA 3143+00 TO 3429+61	PACIFIC PIPELINE	RELOCATE
2	FIBER	4-2" HDPE DUCTS	STA 3143+00 TO 3429+61	QWEST(CENTURY LINK)	RELOCATE
3	FIBER	4-2" HDPE DUCTS	STA 3143+00 TO 3437+92	MCI(VERIZON)-AT&T-SPRINT	RELOCATE
4	FIBER	4-2" HDPE DUCTS	STA 3143+00 TO 3625+00	QWEST-MFS-METRO	RELOCATE
5	GAS (ABAN)	26" GAS	STA 3220+00 TO 3289+00	SC GAS	REMOVE
6	STORM DRAIN	36" RCP 5' COVER	STA 3265+31/ SONORA AVE.	GLENDALE DPW	RELOCATE
7	SEWER	8" VCP	STA 3265+38/ SONORA AVE.	GLENDALE DPW	RELOCATE
8	GAS	4" GAS IN 8" CSG	STA 3265+42/ SONORA AVE.	SC GAS DISTRIBUTION	RELOCATE S/E OF SONORA AND PROTECT IN PLACE
9	TBD	OVERHEAD CABLE	STA 3265+71/ SONORA AVE.	TBD	RELOCATE UNDERGROUND
10	ELECTRICAL	OVERHEAD WIRE	STA 3265+71/ SONORA AVE.	GLENDALE W & P	RELOCATE UNDERGROUND
11)	TELEPHONE	OVERHEAD CABLE	STA 3265+71/ SONORA AVE.	TBD	RELOCATE UNDERGROUND
12	WATER	12" IN CSG	STA 3265+61/ SONORA AVE.	GLENDALE W & P	RELOCATE S/E OF SONORA AND PROTECT IN PLACE
13	UG FIBER DUCTS	IN 100' OF 12" CSG	STA 3265+65/ SONORA AVE.	LEVEL 3	LOWER AND PROTECT IN PLACE

REFER TO PROPOSED UTILITY RELOCATION DWG. NO. UT-D7071 FOR UTILITY INFORMATION AT ROADWAY IMPROVEMENT

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## CALIFORNIA HIGH-SPEED TRAIN PROJECT BURBANK TO LOS ANGELES

OPTION B REVISED ALIGNMENT - REVISED FINAL PEPD COMPOSITE UTILITIES PLAN HSR2 3255+00 TO HSR2 3268+00

CONTRACT NO. HSR14-39	
DRAWING NO. UT-C1517	
AS SHOWN	
SHEET NO.	

No.	TYPE OF UTILITY	SIZE / MATERIAL	LOCATION	OWNER	DISPOSITION
1	OIL	20" OIL LINE	STA 3143+00 TO 3429+61	PACIFIC PIPELINE	TO BE RELOCATED OUTSIDE ROW
2	FIBER	4-2" HDPE DUCTS	STA 3143+00 TO 3429+61	QWEST(CENTURY LINK)	TO BE RELOCATED OUTSIDE ROW
3	FIBER	4-2" HDPE DUCTS	STA 3143+00 TO 3437+92	MCI(VERIZON)-AT&T-SPRINT	TO BE RELOCATED
4	FIBER	4-2" HDPE DUCTS	STA 3143+00 TO 3625+00	QWEST-MFS-METRO	TO BE RELOCATED
5	GAS (ABAN)	26" GAS	STA 3216+00 TO 3289+00	SC GAS	TO BE REMOVED
6	ELECTRICAL POLES	N/A	MULTIPLE LOCATIONS	TBD	PROTECT IN PLACE

NOT FOR CONSTRUCTION FOR INTERNAL USE ONLY

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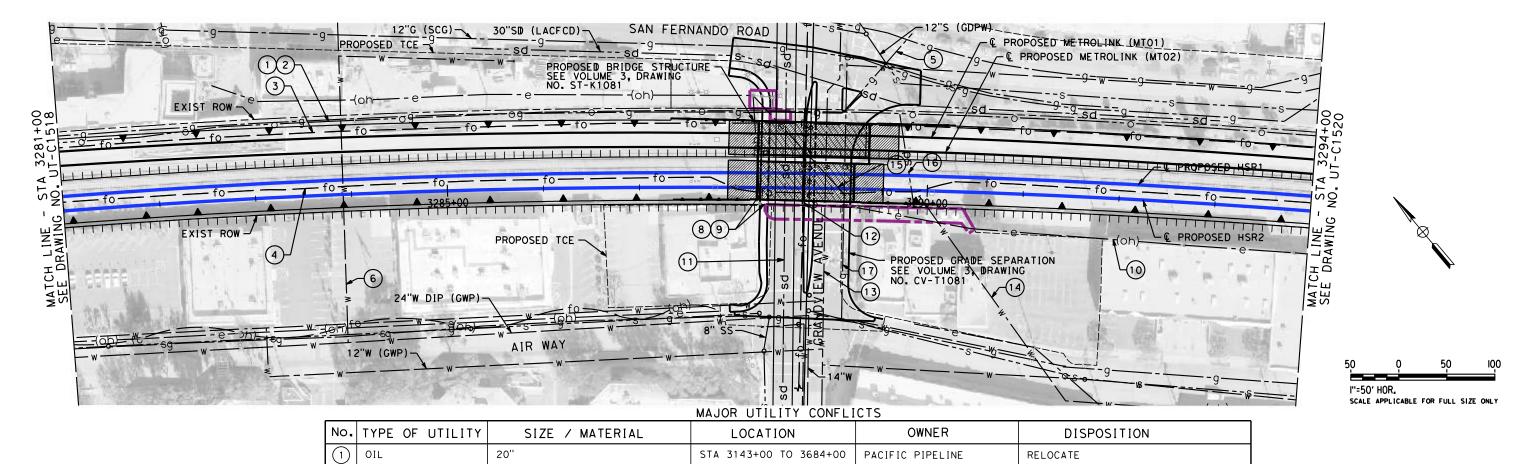




# CALIFORNIA HIGH-SPEED TRAIN PROJECT BURBANK TO LOS ANGELES

OPTION B REVISED ALIGNMENT - REVISED FINAL PEPD COMPOSITE UTILITIES PLAN HSR2 3268+00 TO HSR2 3281+00

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DRAWING NO.	
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SHEET NO.	



No.	TYPE OF UTILITY	SIZE / MATERIAL	LOCATION	OWNER	DISPOSITION
1	OIL	20"	STA 3143+00 TO 3684+00	PACIFIC PIPELINE	RELOCATE
2	FIBER	4-2" HDPE DUCTS	STA 3143+00 TO 3684+00	QWEST(CENTURY LINK)	RELOCATE
3	FIBER	4-2" HDPE DUCTS	STA 3143+00 TO 3684+00	MCI(VERIZON)-AT&T-SPRINT	RELOCATE
4	FIBER	4-2" HDPE DUCTS	STA 3143+00 TO 3684+00	QWEST-MFS-METRO	RELOCATE
5	(ABAN)	26" GAS	STA 3216+00 TO 3289+00	SC GAS	TO BE REMOVED
6	WATER	36" STEEL	STA 3283+92/ WILLARD AVE.	GLENDALE W & P	ADD 48" STEEL CASING FROM ROW TO ROW
7	NOT USED				
8	ELECTRICAL	GUY WIRE	STA 3288+26/ GRANDVIEW AVE.	GLENDALE W & P	REMOVE
9	ELECTRICAL	GUY WIRE	STA 3288+26 TO 3289+20	GLENDALE W & P	REMOVE
10	ELECTRICAL	99 KV OVERHEAD	STA 3290+47 TO 3302+64	GLENDALE W & P	PROTECT-IN-PLACE
11)	STORM DRAIN	20×12 RCB	STA 3288+52/ GRANDVIEW AVE.	LOS ANGELES CO. FCD	PROTECT-IN-PLACE
12	FIBER	IN 100' OF 12" STEEL CSG	STA 3288+71/ GRANDVIEW AVE.	LEVEL 3	RELOCATE/ENCASE WITH 100'OF 12" STEEL ALONG GRANDVIEW AVENUE
13	WATER	12" IN CSG	STA 3288+94/ GRANDVIEW AVE.	GLENDALE W & P	PROTECT-IN-PLACE
14)	WATER	16" PIPE (ABANDONED)	STA 3290+00/ GRANDVIEW AVE.	GLENDALE W & P	ABANDONED, REMOVE INTERFERING PORTION
15)	ELECTRICAL	99 KV OVERHEAD	STA 3288+20 TO 3290+47/ GRANDVIEW AVE.	GLENDALE W & P	RELOCATE UNDERGROUND
16	STORM DRAIN	42" CULVERT (ABAN)	STA 3289+85	LOS ANGELES CO. FCD	REMOVE INTERFERING PORTIONS
17	GAS	12" GAS LINE	STA 3289+13	SOUTHERN CALIFORNIA GAS	ADD/EXTEND CASING FROM ROW TO ROW

REFER TO PROPOSED UTILITY RELOCATION DWG. NO. UT-D7081 FOR UTILITY INFORMATION AT ROADWAY IMPROVEMENT

R. PETERS DRAWN BY M. REIFER IN CHARGE DATE BY CHK APP DESCRIPTION 07/15/2021

PEPD RECORD SET NOT FOR CONSTRUCTION





### NOT FOR CONSTRUCTION FOR INTERNAL USE ONLY CALIFORNIA HIGH-SPEED TRAIN PROJECT

BURBANK TO LOS ANGELES OPTION B REVISED ALIGNMENT - REVISED FINAL COMPOSITE UTILITIES PLAN HSR2 3281+00 TO HSR2 3294+00

CONTRACT NO. HSR14-39
DRAWING NO.
UT-C1519
SCALE
AS SHOWN
SHEET NO.

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No.	TYPE OF UTILITY	SIZE / MATERIAL	LOCATION	OWNER	DISPOSITION
1	OIL	20" OIL LINE	STA 3143+00 TO 3684+00	PACIFIC PIPELINE	RELOCATE
2	FIBER	4-2" HDPE DUCTS	STA 3143+00 TO 3684+00	QWEST(CENTURY LINK)	RELOCATE
3	FIBER	4-2" HDPE DUCTS	STA 3143+00 TO 3684+00	MCI(VERIZON)-AT&T-SPRINT	RELOCATE
4	FIBER	4-2" HDPE DUCTS	STA 3143+00 TO 3684+00	QWEST-MFS-METRO	RELOCATE
6	STORM DRAIN	6.5W×10H RCB - CULVERT	STA 3304+53/ ALMA ST.	LACFCD	REMOVE CULVERT AND EXTEND 72" RCB ACROSS ROW
7	GAS	6" GAS LINE	STA 3295+00 TO 3310+00	SCG	RELOCATE AND ALIGN WITH SAN FERNANDO ROAD
8	WATER LINE	12" WATER LINE	STA 3295+00 TO 3310+00	GLENDALE W&P	RELOCATE AND ALIGN WITH SAN FERNANDO ROAD
9	SEWER	21" VCP	STA 3295+00 TO 3310+00	GDPW	RELOCATE
10	STORM DRAIN	72" RCB	STA 3304+53/ ALMA ST.	LACFCD	PROTECT-IN-PLACE

REFER TO PROPOSED UTILITY RELOCATION DWG, NO. UT-D7091 FOR UTILITY INFORMATION AT ROADWAY IMPROVEMENT

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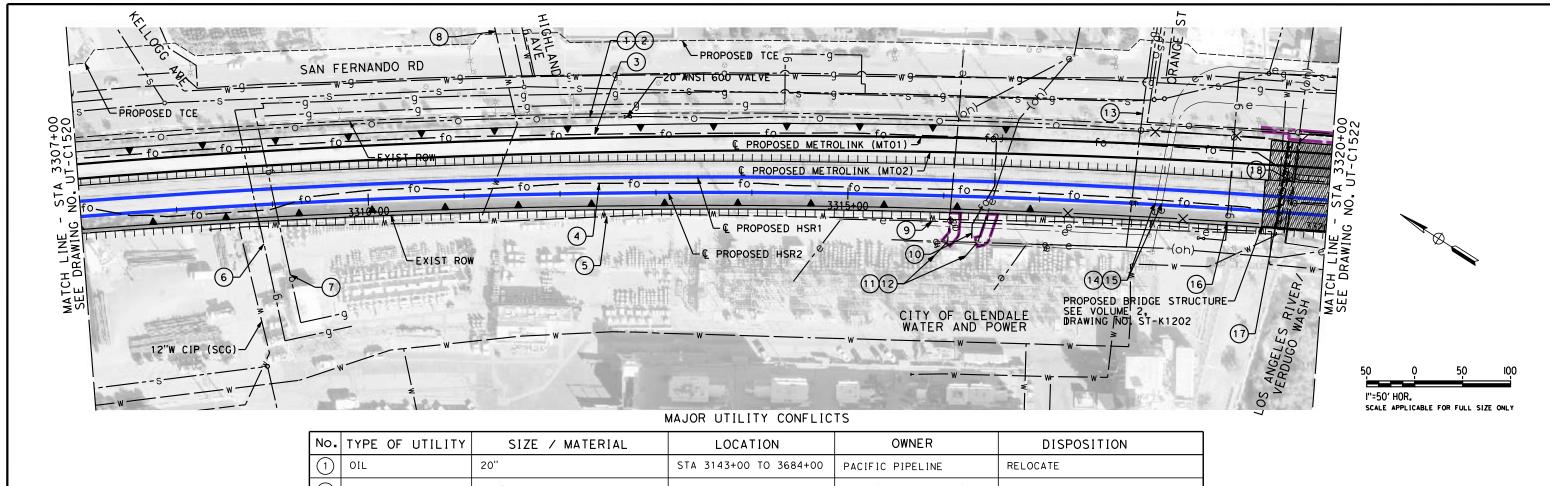




# CALIFORNIA HIGH-SPEED TRAIN PROJECT BURBANK TO LOS ANGELES

OPTION B REVISED ALIGNMENT - REVISED FINAL PEPD COMPOSITE UTILITIES PLAN HSR2 3294+00 TO HSR2 3307+00

CONTRACT NO. HSR14-39
DRAWING NO. UT-C1520
SCALE AS SHOWN
SHEET NO.



No.	TYPE OF UTILITY	SIZE / MATERIAL	LOCATION	OWNER	DISPOSITION
1	OIL	20"	STA 3143+00 TO 3684+00	PACIFIC PIPELINE	RELOCATE
2	FIBER	4-2" HDPE DUCTS	STA 3143+00 TO 3684+00	QWEST(CENTURY LINK)	RELOCATE
3	FIBER	4-2" HDPE DUCTS	STA 3143+00 TO 3684+00	MCI(VERIZON)-AT&T-SPRINT	RELOCATE
4	FIBER	4-2" HDPE DUCTS	STA 3143+00 TO 3684+00	QWEST-MFS-METRO	RELOCATE
(5)	RECYCLE WATER	16" CML STEEL	STA 3308+62 TO 3319+44	GLENDALE W & P	RELOCATE
6	GAS H	8" IN 63' OF CSG	STA 3308+82/ KELLOGG AVE.	SC GAS DISTRIBUTION	EXTEND CASING FROM ROW TO ROW
7	GAS H	8" IN 44' OF CSG	STA 3309+03/ KELLOGG AVE.	SC GAS DISTRIBUTION	EXTEND CASING FROM ROW TO ROW
8	RECYCLED WATER	16" CML STEEL IN 30" STEEL CSG	STA 3311+27/ HIGHLAND AVE.	GLENDALE W & P	EXTEND CASING FROM ROW TO ROW
9	ELECTRICAL	99 KV OVERHEAD	STA 3314+93 TO 3320+57	GLENDALE W & P	PROTECT-IN-PLACE
10	FIBER	UNDERGROUND	STA 3316+46/ GRANGE ST.	PACIFIC BELL/AT&T	EXTEND CASING FROM ROW TO ROW
11)	ELECTRICAL	115 KV OVERHEAD	STA 3316+08/ GRANGE ST.	GLENDALE W & P	RAISE/RELOCATE
12	ELECTRICAL	115 KV OVERHEAD	STA 3316+51/ GRANGE ST.	GLENDALE W & P	RAISE/RELOCATE
13	GAS	12" IN 40' OF CSG	STA 3317+96/ GRANGE ST.	SCG	EXTEND CASING FROM ROW TO ROW
14)	ELECTRICAL	9-6"DUCTS IN 43'OF 36"DIA CSG	STA 3318+21/ GRANGE ST.	GLENDALE W & P	EXTEND CASING FROM ROW TO ROW
15)	ELECTRICAL	9-6"DUCTS IN 43'OF 36"DIA CSG	STA 3318+27/ GRANGE ST.	GLENDALE W & P	EXTEND CASING FROM ROW TO ROW
16	GAS	14" IN 80' OF 33" CSG	STA 3319+00/ GRANGE ST.	SCHOLL CANYON	EXTEND CASING FROM ROW TO ROW
17	WATER	12" IN 80' OF 24" CMP CSG	STA 3319+49/ GRANGE ST.	GLENDALE W & P	EXTEND CASING FROM ROW TO ROW
18	ELECTRICAL	99 KV OVERHEAD	STA 3319+58/ GRANGE ST.	GLENDALE W & P	RAISE/RELOCATE

REFER TO PROPOSED UTILITY RELOCATION DWG. NO. UT-D7092 FOR UTILITY INFORMATION AT ROADWAY IMPROVEMENT

DESCRIPTION

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RECORD SET

NOT FOR
CONSTRUCTION

R. PETERS

DRAWN BY

M. REIFER

07/15/2021

IN CHARGE

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### CALIFORNIA HIGH-SPEED TRAIN PROJECT BURBANK TO LOS ANGELES

OPTION B REVISED ALIGNMENT - REVISED FINAL PEPD

COMPOSITE UTILITIES PLAN
HSR2 3307+00 TO HSR2 3320+00

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No.	TYPE OF UTILITY	SIZE / MATERIAL	LOCATION	OWNER	DISPOSITION			
1	OIL	20" OIL LINE	STA 3143+00 TO 3684+00	PACIFIC PIPELINE	RELOCATE			
2	FIBER	4-2" HDPE DUCTS	STA 3143+00 TO 3684+00	QWEST(CENTURY LINK)	RELOCATE			
3	FIBER	4-2" HDPE DUCTS	STA 3143+00 TO 3684+00	MCI(VERIZON)-AT&T-SPRINT	RELOCATE			
4	FIBER	4-2" HDPE DUCTS	STA 3143+00 TO 3684+00	QWEST-MFS-METRO	RELOCATE			
5	ELECTRICAL	99 KV OVERHEAD	STA 3321+57/ FAIRMONT AVE.	GLENDALE W & P	RAISE/RELOCATE			
6	SEWER	30" VCP IN 60" RCP & 7" CONCRETE CSG	STA 3320+76/ FAIRMONT AVE.	GLENDALE W & P	ADD CASING FROM ROW TO ROW			
7	RECYCLED WATER	16" CML STEEL	STA 3319+44 TO 3320+78	GLENDALE W & P	PROTECT-IN-PLACE			
8	WATER	8" IN CSG	STA 3326+01/ DORAN ST.	GLENDALE W & P	EXTEND CSG FROM ROW TO ROW			
9	GAS	3" IN 62' OF 4" CSG	STA 3326+28/ DORAN ST.	SC GAS	PROTECT-IN-PLACE AND EXTEND CASING			
10	SEWER	8" VCP IN CONCRETE CSG	STA 3326+28/ DORAN ST.	CITY OF LOS ANGELES	PROTECT-IN-PLACE			
(1)	OIL	14" OIL LINE	STA 3326+22/ DORAN ST.	PACIFIC PIPELINE	ADD CASING FROM ROW TO ROW			
12	SEWER	36" GAUGE STRUCTURE	STA 3325+33 TO 3325+60 DORAN ST.	CITY OF LOS ANGELES	PROTECT-IN-PLACE			
13	SEWER	24" VCP	STA 3325+00 TO 3326+38	CITY OF LOS ANGELES	PROTECT-IN-PLACE			

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### CALIFORNIA HIGH-SPEED TRAIN PROJECT BURBANK TO LOS ANGELES

OPTION B REVISED ALIGNMENT - REVISED FINAL PEPD COMPOSITE UTILITIES PLAN HSR2 3320+00 TO HSR2 3333+00

CONTRACT NO. HSR14-39
DRAWING NO. UT-C1522
SCALE AS SHOWN
SHEET NO.

No.	TYPE OF UTILITY	SIZE / MATERIAL	LOCATION	OWNER	DISPOSITION
1	OIL	20"	STA 3143+00 TO 3684+00	PACIFIC PIPELINE	RELOCATE
2	FIBER	4-2" HDPE DUCTS	STA 3143+00 TO 3684+00	QWEST(CENTURY LINK)	RELOCATE
3	FIBER	4-2" HDPE DUCTS	STA 3143+00 TO 3684+00	MCI(VERIZON)-AT&T-SPRINT	RELOCATE
4	FIBER	4-2" HDPE DUCTS	STA 3143+00 TO 3684+00	QWEST-MFS-METRO	RELOCATE
5	TELEPHONE	2-4"CONDUIT IN 100'OF IRON PIPE	STA 3338+67/ W CALIFORNIA AVE.	AT&T	RELOCATE, ADD CSG ROW TO ROW
6	STORM DRAIN	30" RCB	STA 3343+63/ SALEM ST.	METRO	EXTEND CASING
7	SEWER	18" DIP IN 202' OF 30" STL CSG	STA 3344+45 TO 3344+77/ SPERRY ST./SALEM ST.	GLENDALE DPW	PROTECT-IN-PLACE

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### CALIFORNIA HIGH-SPEED TRAIN PROJECT BURBANK TO LOS ANGELES

OPTION B REVISED ALIGNMENT - REVISED FINAL PEPD COMPOSITE UTILITIES PLAN HSR2 3333+00 TO HSR2 3346+00

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CONTRACT N	0.	
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DRAWING NO.		
UT-C	1523	3
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SHEET NO.		

No.	TYPE OF UTILITY	SIZE / MATERIAL	LOCATION	OWNER	DISPOSITION
1	OIL	20" OIL LINE	STA 3143+00 TO 3684+00	PACIFIC PIPELINE	RELOCATE
2	FIBER	4-2" HDPE DUCTS	STA 3143+00 TO 3684+00	QWEST(CENTURY LINK)	RELOCATE
3	FIBER	4-2" HDPE DUCTS	STA 3143+00 TO 3684+00	MCI(VERIZON)-AT&T-SPRINT	RELOCATE
4	FIBER	4-2" HDPE DUCTS	STA 3143+00 TO 3684+00	QWEST-MFS-METRO	RELOCATE
(5)	STORM DRAIN	48" RCP	STA 3346+04/ W WILSON AVE.	CITY OF LOS ANGELES	PROTECT IN PLACE
6	GAS	4" IN 6" CSG	STA 3351+25/ BROADWAY ST./BRAZIL ST.	SC GAS TRANSMISSION	RELOCATE, ADD CSG FROM ROW TO ROW
7	STORM DRAIN	51" RCP	STA 3354+81/ IVY ST.	LOS ANGELES CO. FCD	PROTECT-IN-PLACE
8	SEWER	15" VCP	STA 3347+67/ WILSON AVE.	GLENDALE DPW	PROTECT-IN-PLACE

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## CALIFORNIA HIGH-SPEED TRAIN PROJECT BURBANK TO LOS ANGELES

OPTION B REVISED ALIGNMENT - REVISED FINAL PEPD COMPOSITE UTILITIES PLAN HSR2 3346+00 TO HSR2 3359+00

CONTRACT NO. HSR14-39
DRAWING NO.
UT-C1524
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SCALE
AS SHOWN
SHEET NO.

No.	TYPE OF UTILITY	SIZE / MATERIAL	LOCATION	OWNER	DISPOSITION
1	OIL	20" OIL LINE	STA 3143+00 TO 3684+00	PACIFIC PIPELINE	RELOCATE
2	FIBER	4-2" HDPE DUCTS	STA 3143+00 TO 3684+00	QWEST(CENTURY LINK)	RELOCATE
3	FIBER	4-2" HDPE DUCTS	STA 3143+00 TO 3684+00	MCI(VERIZON)-AT&T-SPRINT	RELOCATE
4	FIBER	4-2" HDPE DUCTS	STA 3143+00 TO 3684+00	QWEST- MFS-METRO	RELOCATE
5	GAS	2" IN CSG	STA 3368+87/ COLORADO BLVD.	SC GAS DISTRIBUTION	PROTECT-IN-PLACE AND ADD CASING
6	SEWER	21" VCP IN CONCRETE CSG	STA 3369+23/ COLORADO BLVD.	GLENDALE DPW	ADD CSG FROM ROW TO ROW
7	SEWER	30" VCP	STA 3369+29/ COLORADO BLVD.	GLENDALE DPW	PROTECT-IN-PLACE
8	STORM DRAIN	30" RCP	STA 3370+76/ COLORADO ST. FWY EXT	CALTRANS	PROTECT-IN-PLACE
9	SEWER	36" HOBAS IN 72" STEEL CSG AND CHEMICAL GROUTING	STA 3371+84/ COLORADO BLVD.	GLENDALE DPW	RELOCATE

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## CALIFORNIA HIGH-SPEED TRAIN PROJECT BURBANK TO LOS ANGELES

OPTION B REVISED ALIGNMENT - REVISED FINAL PEPD COMPOSITE UTILITIES PLAN HSR2 3359+00 TO HSR2 3372+00

CONTRACT NO. HSR14-39
DRAWING NO.
UT-C1525
SCALE
AS SHOWN
SHEET NO.

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No.	TYPE OF UTILITY	SIZE / MATERIAL	LOCATION	OWNER	DISPOSITION
1	OIL	20" OIL LINE	STA 3143+00 TO 3684+00	PACIFIC PIPELINE	RELOCATE
2	FIBER	4-2" HDPE DUCTS	STA 3143+00 TO 3684+00	QWEST (CENTURYLINK)	RELOCATE
3	FIBER	4-2" HDPE DUCTS	STA 3143+00 TO 3684+00	MCI(VERIZON)-AT&T-SPRINT	RELOCATE
4	FIBER	4-2" HDPE DUCTS	STA 3143+00 TO 3684+00	QWEST-MFS-METRO	RELOCATE
5	SEWER	30" VCP IN CSG	STA 3372+03/ W ELK AVE.	GLENDALE DPW	EXTEND CSG FROM ROW TO ROW
6	SEWER	21" VCP IN CSG	STA 3372+19/ W ELK AVE.	CRESCENTA VALLEY	PROTECT IN PLACE
7	STORM DRAIN	48" RCP	STA 3373+59/ W ELK AVE.	LOS ANGELES CO. FCD	ADD CSG FROM ROW TO ROW
8	TELEPHONE	ABAN CONDUIT	STA 3384+77/ RIVERDALE DR.	PACIFIC BELL/AT&T	PROTECT IN PLACE
9	GAS	4" IN 73' OF 20" CSG	STA 3372+54/ W ELK AVE.	SCG	EXTEND CSG FROM ROW TO ROW
10	GAS	4" IN 73' OF 20" CSG	STA 3372+54/ W ELK AVE.	SCG	EXTEND CSG FROM ROW TO ROW

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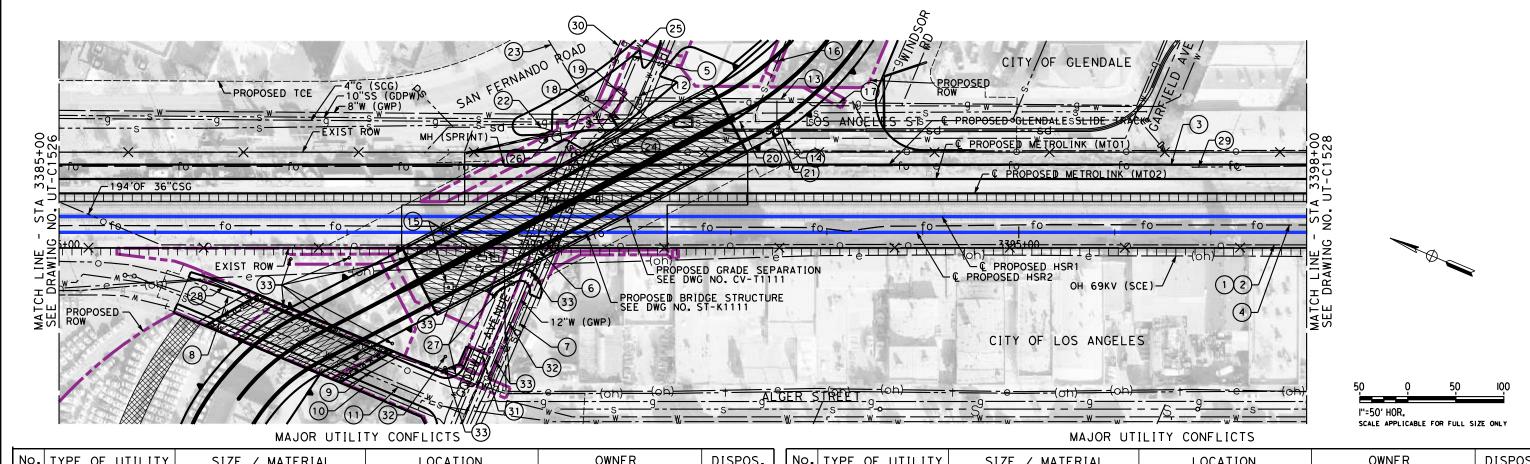


# CALIFORNIA HIGH-SPEED TRAIN PROJECT BURBANK TO LOS ANGELES

OPTION B REVISED ALIGNMENT - REVISED FINAL PEPD

COMPOSITE UTILITIES PLAN
HSR2 3372+00 TO HSR2 3385+00

CONTRACT NO. HSR14-39
DRAWING NO. UT-C1526
SCALE CLIOWAL
AS SHOWN
SHEET NO.



No.	TYPE OF UTILITY	SIZE / MATERIAL	LOCATION	OWNER	DISPOS.
1	OIL	20" IN 194' OF 36" CSG	STA 3143+00 TO 3684+00	PACIFIC PIPELINE	RELOCATE
2	FIBER	4-2" HDPE DUCTS	STA 3143+00 TO 3684+00	QWEST (CENTURYLINK)	RELOCATE
3	FIBER	UNDERGROUND DUCTS IN CSG	STA 3143+00 TO 3684+00	MCI(VERIZON)-AT&T-SPRINT	RELOCATE
4	FIBER	4-2" HDPE DUCTS	STA 3143+00 TO 3684+00	QWEST-MFS-METRO	RELOCATE
(5)	RECYCLE WATER	30" CML STEEL IN 42" CSG	STA 3389+89 GOODWIN AVE.	GLENDALE W & P	RELOCATE
6	GAS	6" IN 100' OF 10" CSG	STA 3390+07/ GOODWIN AVE.	SC GAS TRANSMISSION	RELOCATE
7	STORM DRAIN	10'WX12'H RCB	STA 3390+20/ GOODWIN AVE.	LOS ANGELES CO. FCD	RELOCATE
8	OIL	14" OIL	STA 3318+00 TO 3427+00	KELLY WATSON	RELOCATE
9	WATER	20" WATER	STA 3386+02 TO 3490+47	LADWP	RELOCATE
10	WATER	12" WATER	STA 3386+02 TO 3490+47	LADWP	RELOCATE
11)	SEWER	8"	STA 3386+02 TO 3490+47	CITY OF LOS ANGELES	RELOCATE
12	WATER	6" CIP	STA 3390+99 TO 3391+14	GLENDALE W & P	RELOCATE
13	WATER	8" DIP	STA 3390+80 TO 3393+40	GLENDALE W & P	RELOCATE
14)	RECYCLED WATER	8" PVC C900	STA 3390+36 TO 3393+00	GLENDALE W & P	RELOCATE
15)	EXTRACTION WELL GS-04	WELL/ELEC. PANEL/TRANSFORMER/ PIPING	STA 3389+00 TO 3389+57	BURBANK OPERABLE UNIT	RELOCATE
16	SEWER	8" VCP	STA 3392+25 TO 3393+00	GLENDALE DPW	RELOCATE
17	GAS	4"	STA 3391+00 TO 3393+35	SCG	RELOCATE
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No.	TYPE OF UTILITY	SIZE / MATERIAL	LOCATION	OWNER	DISPOS.
18	SEWER	10"	STA 3390+75 TO 3392+26	GLENDALE DPW	RELOCATE
19	SEWER	36" HOBAS IN 72" STL CSG & FLUME	STA 3390+00 TO 3391+61	GLENDALE DPW	RELOCATE
20	SEWER	36" VCP	STA 3391+61 TO 3493+00	GLENDALE DPW	RELOCATE
21	STORM DRAIN	27" RCP	STA 3391+93 TO 3393+00	GLENDALE DPW	REMOVE
22	STORM DRAIN	45" RCP	STA 3390+00 TO 3390+45	GLENDALE DPW	RELOCATE
23	STORM DRAIN	21" RCP (2 EA)	STA 3390+59 TO 3390+70	GLENDALE DPW	RELOCATE
24)	STORM DRAIN	21" RCP (2 EA) ABANDONED	STA 3390+75 TO 3390+90	GLENDALE DPW	REMOVE
25)	SEWER	8" VCP	STA 3390+75 TO 3390+90	GLENDALE DPW	RELOCATE
26	STORM DRAIN	21" RCP ABANDONED	STA 3390+00 TO 3391+27	GLENDALE DPW	REMOVE
27)	ELECTRICAL	OVERHEAD ELECTRICAL LINE	STA 3386+53 TO 3391+41	SCE	RELOCATE
28	TELEPHONE	OVERHEAD TELEPHONE LINE	STA 3386+53 TO 3389+65	TBD	RELOCATE
29	TELEPHONE	OVERHEAD CABLE	STA 3396+80 TO 3398+00	TBD	RELOCATE
30	GAS	2"	STA 3390+58	SCG	PROTECT
31)	GAS	3"	STA 3389+91	SCG	RELOCATE
32	WELLS	GROUNDWATER MONITORING WELL GS-MW3B & GS-P20	STA 3389+02 & 3389+69	GLENDALE DPW	PROTECT
33	WELLS	SOIL VAPOR MONITORING WELLS SVP-1 THRU, 11	STA 3387+34 TO 3389+94	GLENDALE DPW	REMOVE WHERE IN CONFLICT

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# CALIFORNIA HIGH-SPEED TRAIN PROJECT BURBANK TO LOS ANGELES

OPTION B REVISED ALIGNMENT - REVISED FINAL PEPD COMPOSITE UTILITIES PLAN HSR2 3385+00 TO HSR2 3398+00

 HAL OSL OIL
CONTRACT NO. HSR14-39
DRAWING NO.
UT-C1527
SCALE
AS SHOWN
SHEET NO.

No.	TYPE OF UTILITY	SIZE / MATERIAL	LOCATION	OWNER	DISPOSITION
1	OIL	20"	STA 3143+00 TO 3684+00	PACIFIC PIPELINE	RELOCATE
2	FIBER	4-2" HDPE DUCTS	STA 3143+00 TO 3684+00	QWEST (CENTURYLINK)	RELOCATE
3	FIBER	UNDERGROUND DUCTS IN CSG	STA 3143+00 TO 3684+00	MCI(VERIZON)-AT&T-SPRINT	RELOCATE
4	FIBER	4-2" HDPE DUCTS	STA 3143+00 TO 3684+00	QWEST-MFS-METRO	RELOCATE
5	GAS	2" IN 80' OF 4" CSG	STA 3404+53 CHEVY CHASE DR.	SC GAS DISTRIBUTION	EXTEND CASING FROM ROW TO ROW REALIGN PASS PED. CROSSING
6	SEWER	33" VCP IN 67' OF 60" RCP CSG	STA 3404+55/ CHEVY CHASE DR.	GLENDALE DPW	EXTEND CASING FROM ROW TO ROW
7	SEWER	18" VCP IN CSG	STA 3404+64/ CHEVY CHASE DR.	GLENDALE DPW	PROTECT-IN-PLACE
8	TELEPHONE	2 DUCTS	STA 3404+82/ CHEVY CHASE DR.	TBD	TO BE ENCASED FROM ROW TO ROW
9	OIL	14" OIL	STA 3318+00 TO 3427+00	KELLY WATSON	PROTECT-IN-PLACE
10	TELEPHONE	OVERHEAD CABLE	STA 3398+00 TO 3404+35 STA 3408+77 TO 3411+00	TBD	RELOCATE
11	ELECTRICAL	OVERHEAD ELECTRICAL LINE	STA 3303+19 TO 3404+75	SCE	RELOCATE
12	STORM DRAIN SYSTEM	TBD	STA 3404+04 TO 3405+13	LA CO. DEP. OF PUBLIC W.	RELOCATE

REFER TO PROPOSED UTILITY RELOCATION DWG, NO. UT-D7113 FOR UTILITY INFORMATION AT ROADWAY IMPROVEMENT

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						DRAWN BY C. CUSSON	١.
						DESIGNED BY R. PETERS	

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### CALIFORNIA HIGH-SPEED TRAIN PROJECT BURBANK TO LOS ANGELES

OPTION B REVISED ALIGNMENT - REVISED FINAL PEPD COMPOSITE UTILITIES PLAN HSR2 3398+00 TO HSR2 3411+00

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CONTRACT NO.	
HSR14-39	
DRAWING NO.	
UT-C1528	
SCALE	
AS SHOWN	
SHEET NO.	

No.	TYPE OF UTILITY	SIZE / MATERIAL	LOCATION	OWNER	DISPOSITION
1	OIL	20" IN 125' OF 24" CSG	STA 3143+00 TO 3684+00	PACIFIC PIPELINE	RELOCATE
2	FIBER	4-2" HDPE DUCTS IN 125' OF CSG	STA 3143+00 TO 3684+00	QWEST (CENTURYLINK)	RELOCATE
3	FIBER	UNDERGROUND DUCTS IN CSG	STA 3143+00 TO 3684+00	MCI(VERIZON)-AT&T-SPRINT	RELOCATE
4	FIBER	4-2" HDPE DUCTS	STA 3143+00 TO 3684+00	QWEST- MFS-METRO	RELOCATE
5	STORM DRAIN	18" RCB - 2 CULVERTS	STA 3414+79/ VERDANT ST.	METRO	EXTEND CULVERTS TO COVER TRACKS
6	ELECTRICAL	69 KV OVERHEAD	STA 3420+06 TO 3429+52	SCE	RELOCATE
7	OIL	14" OIL	STA 3318+00 TO 3427+00	KELLY WATSON	PROTECT-IN-PLACE
8	TELEPHONE	OVERHEAD CABLE	STA 3411+00 TO 3422+35	TBD	RELOCATE

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| DESIGNED BY | R. PETERS | DRAWN BY | C. CUSSON | CHECKED BY | M. REIFER | IN CHARGE | C. LEE | DATE | BY CHK APP | DESCRIPTION | DATE | O7/15/2021

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# CALIFORNIA HIGH-SPEED TRAIN PROJECT BURBANK TO LOS ANGELES

OPTION B REVISED ALIGNMENT - REVISED FINAL PEPD COMPOSITE UTILITIES PLAN HSR2 3411+00 TO HSR2 3424+00

CONTRACT NO. HSR14-39	
UT-C1529	
SCALE	
AS SHOWN	
SHEET NO.	

No.	TYPE OF UTILITY	SIZE / MATERIAL	LOCATION	OWNER	DISPOSITION
(1)	OIL	20"	STA 3143+00 TO 3684+00	PACIFIC PIPELINE	RELOCATE
	OIL	20	314 3143100 10 3004100	TACH IC THEETNE	RELOCATE
2	FIBER	4-2" HDPE DUCTS IN 125' OF CSG	STA 3143+00 TO 3684+00	QWEST (CENTURYLINK)	RELOCATE
3	FIBER	4-2" HDPE DUCTS	STA 3143+00 TO 3684+00	MCI(VERIZON)-AT&T-SPRINT	RELOCATE
4	FIBER	4-2" HDPE DUCTS	STA 3143+00 TO 3684+00	QWEST-MFS-METRO	RELOCATE
5	WATER	12" IN 98' OF 24" CSG	STA 3426+81/ FERNANDO CT.	GLENDALE W&P	EXTEND CSG FROM ROW TO ROW RELOCATE POINT OF CONNECTION
6	STORM DRAIN	45" RCP	STA 3430+60/ LOS FELIZ BLVD.	CITY OF LOS ANGELES	RELOCATE, ADD CATCH BASINS TO TIE INTO EXISTING
7	STORM DRAIN	45" RCP	STA 3430+66/ LOS FELIZ BLVD.	CITY OF LOS ANGELES	RELOCATE, ADD CATCH BASINS TO TIE INTO EXISTING
8	ELECTRICAL	69 KV	STA 3413+43 TO 3429+52	SCE	RELOCATE
9	OIL	14" OIL	STA 3318+00 TO 3427+00	KELLY WATSON	PROTECT-IN-PLACE
10	TELEPHONE	OVERHEAD CABLE	STA 3424+00 TO 3437+00	TBD	PROTECT-IN-PLACE
11	SEWER	TBD	STA 3429+61 TO 3431+00	TBD	RELOCATE

REFER TO PROPOSED UTILITY RELOCATION DWG. NO. UT-D7121 FOR UTILITY INFORMATION AT ROADWAY IMPROVEMENT

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## CALIFORNIA HIGH-SPEED TRAIN PROJECT BURBANK TO LOS ANGELES

OPTION B REVISED ALIGNMENT - REVISED FINAL PEPD COMPOSITE UTILITIES PLAN HSR2 3424+00 TO HSR2 3437+00

CONTRACT NO. HSR14-39	
DRAWING NO.	
UT-C1530	
SCALE	
AS SHOWN	
SHEET NO.	

No.	TYPE OF UTILITY	SIZE / MATERIAL	LOCATION	OWNER	DISPOSITION
1	OIL	20" OIL LINE	STA 3143+00 TO 3684+00	PACIFIC PIPELINE	RELOCATE
2	FIBER	4-2" HDPE DUCTS IN 125' OF CSG	STA 3143+00 TO 3684+00	QWEST (CENTURYLINK)	RELOCATE
3	FIBER	4-2" HDPE DUCTS	STA 3143+00 TO 3684+00	MCI(VERIZON)-AT&T-SPRINT	RELOCATE
4	FIBER	4-2" HDPE DUCTS	STA 3143+00 TO 3684+00	QWEST-MFS-METRO	RELOCATE
(5)	STORM DRAIN	12' RCP	STA 3438+13/ S CENTRAL AVE.	LOS ANGELES CO. FCD	PROTECT-IN-PLACE

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## CALIFORNIA HIGH-SPEED TRAIN PROJECT BURBANK TO LOS ANGELES

OPTION B REVISED ALIGNMENT - REVISED FINAL PEPD COMPOSITE UTILITIES PLAN HSR2 3437+00 TO HSR2 3450+00

CONTRACT NO. HSR14-39
DRAWING NO.
UT-C1531
SCALE
AS SHOWN
SHEET NO.

	TYPE OF UTILITY	SIZE/MATERIAL	LOCATION	OWNER	DISPOSITION
1	OIL	20" IN 122' OF 36" CSG	STA 3143+00 TO 3684+00	PACIFIC PIPELINE	RELOCATE
2	FIBER	4-2" HDPE DUCTS IN CSG	STA 3143+00 TO 3684+00	QWEST (CENTURYLINK)	RELOCATE
3	FIBER	4-2" HDPE DUCTS	STA 3143+00 TO 3684+00	MCI(VERIZON)-AT&T-SPRINT	RELOCATE
4	FIBER	4-2" HDPE DUCTS	STA 3143+00 TO 3684+00	QWEST-MFS-METRO	RELOCATE
5	STORM DRAIN	18" RCP	STA 3452+85/ GLENDALE BLVD.	METRO	EXTEND AND ENCASE ROW TO ROW
6	STORM DRAIN	24" RCP	STA 3454+79/ GLENDALE BLVD.	CITY OF LOS ANGELES	RELOCATE
7	STORM DRAIN	24" RCP	STA 3455+65/ GLENDALE BLVD.	CITY OF LOS ANGELES	RELOCATE
8	FIBER	UNGROUND FIBER CABLE	3454+36	AT&T	PROTECT-IN-PLACE
9	SD PUMP HOUSE	13' x 16'	STA 3454+39 TO 3454+55	CITY OF LOS ANGELES	PROTECT-IN-PLACE

REFER TO PROPOSED UTILITY RELOCATION DWG, NO. UT-D7131 FOR UTILITY INFORMATION AT ROADWAY IMPROVEMENT

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## CALIFORNIA HIGH-SPEED TRAIN PROJECT BURBANK TO LOS ANGELES

OPTION B REVISED ALIGNMENT - REVISED FINAL COMPOSITE UTILITIES PLAN HSR2 3450+00 TO HSR2 3463+00

CONTRACT NO. HSR14-39
DRAWING NO.
UT-C1532
SCALE
AS SHOWN
SHEET NO.

	TYPE OF UTILITY	SIZE/MATERIAL	LOCATION	OWNER	DISPOSITION
1	OIL	20" IN 122' OF 36" CSG	STA 3143+00 TO 3684+00	PACIFIC PIPELINE	RELOCATE
2	FIBER	4-2" HDPE DUCTS IN CSG	STA 3143+00 TO 3684+00	QWEST (CENTURYLINK)	RELOCATE
3	FIBER	4-2" HDPE DUCTS	STA 3143+00 TO 3684+00	MCI(VERIZON)-AT&T-SPRINT	RELOCATE
4	FIBER	4-2" HDPE DUCTS	STA 3143+00 TO 3684+00	QWEST-MFS-METRO	RELOCATE
5	SEWER	10" HDPE	STA 3468+32/ TYBURN ST.	GLENDALE DPW	ADD CSG FROM ROW TO ROW
6	WATER	12" IN 16" STL CSG	STA 3468+20/ TYBURN ST.	LADWP-W	PROTECT-IN-PLACE
7	STORM DRAIN	18" RCP	STA 3468+46/ TYBURN ST.	CITY OF LOS ANGELES	PROTECT-IN-PLACE
8	GAS	6" IN 115' OF 16" CSG	STA 3468+38/ TYBURN ST.	SC GAS DISTRIBUTION	PROTECT-IN-PLACE
9	ELECTRICAL	OVERHEAD WIRE	STA 3468+57/ TYBURN ST.	LADWP-P	RAISE/RELOCATE
(10)	ELECTRICAL	OVERHEAD WIRE	STA 3463+00 TO 3480+51	GLENDALE W & P	PROTECT-IN-PLACE

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## CALIFORNIA HIGH-SPEED TRAIN PROJECT BURBANK TO LOS ANGELES

OPTION B REVISED ALIGNMENT - REVISED FINAL PEPD COMPOSITE UTILITIES PLAN HSR2 3463+00 TO HSR2 3476+00

	TYPE OF UTILITY	SIZE/MATERIAL	LOCATION	OWNER	DISPOSITION
1	OIL	20" OIL LINE	STA 3143+00 TO 3684+00	PACIFIC PIPELINE	RELOCATE
2	FIBER	4-2" HDPE DUCTS IN CSG	STA 3143+00 TO 3684+00	QWEST (CENTURYLINK)	RELOCATE
3	FIBER	4-2" HDPE DUCTS IN CSG	STA 3143+00 TO 3684+00	MCI(VERIZON)-AT&T-SPRINT	RELOCATE
4	FIBER	4-2" HDPE DUCTS IN CSG	STA 3143+00 TO 3684+00	QWEST-MFS-METRO	RELOCATE
5	ELECTRICAL	OVERHEAD WIRE	STA 3463+49 TO 3480+51	LADWP-P	PROTECT-IN-PLACE

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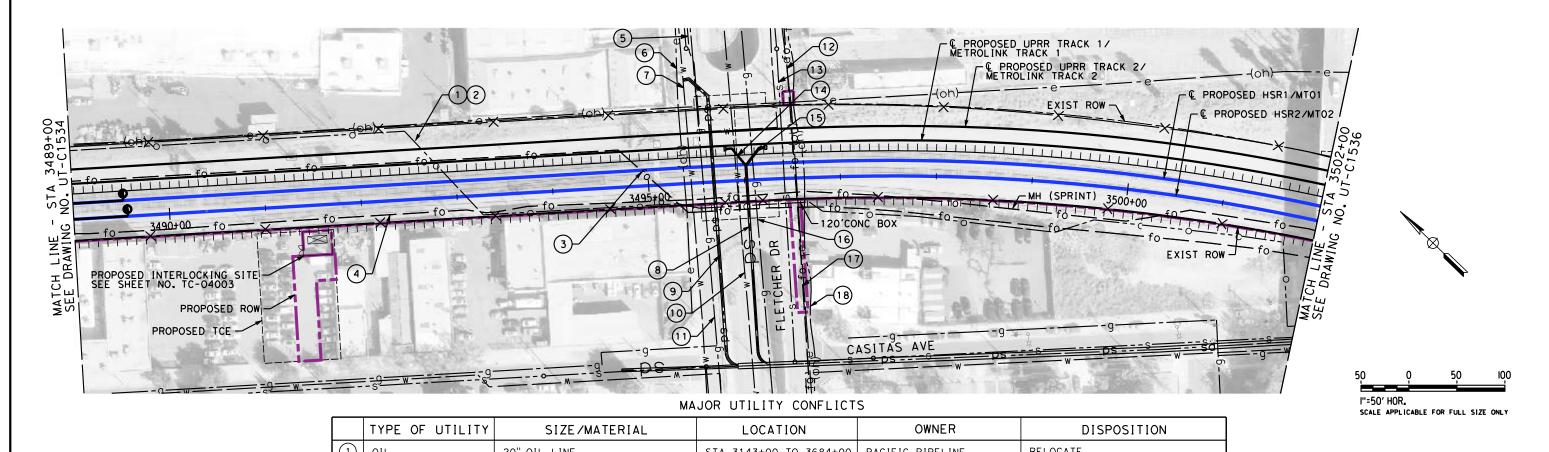




# CALIFORNIA HIGH-SPEED TRAIN PROJECT BURBANK TO LOS ANGELES

OPTION B REVISED ALIGNMENT - REVISED FINAL PEPD

COMPOSITE UTILITIES PLAN
HSR2 3476+00 TO HSR2 3489+00



	TYPE OF UTILITY	SIZE/MATERIAL	LOCATION	OWNER	DISPOSITION
1	OIL	20" OIL LINE	STA 3143+00 TO 3684+00	PACIFIC PIPELINE	RELOCATE
2	FIBER	4-2" HDPE DUCTS IN CSG	STA 3143+00 TO 3684+00	QWEST (CENTURYLINK)	RELOCATE
3	FIBER	4-2" HDPE DUCTS IN CSG	STA 3143+00 TO 3684+00	MCI(VERIZON)-AT&T-SPRINT	RELOCATE
4	FIBER	4-2" HDPE DUCTS IN CSG	STA 3143+00 TO 3684+00	QWEST-MFS-METRO	RELOCATE
5	WATER	6" WWJCL	STA 3496+41/ FLETCHER DR.	LADWP	RELOCATE
6	ELECTRICAL	OVERHEAD WIRE	STA 3495+42/ FLETCHER DR.	LADWP	PROTECT-IN-PLACE
7	WATER	70" WWJCL	STA 3495+48/ FLETCHER DR.	LADWP	PROTECT-IN-PLACE
8	RCP SD	24" RCP	STA 3496+06/ FLETCHER DR.	CITY OF LOS ANGELES	PROTECT-IN-PLACE
9	RCP SD	30" RCP	STA 3495+72/ FLETCHER DR.	CITY OF LOS ANGELES	PROTECT-IN-PLACE
10	WATER	30" DIP IN 40" CSG	STA 3495+96/ FLETCHER DR.	LADWP	PROTECT-IN-PLACE
11)	GAS	6" IN CSG	STA 3495+61/ FLETCHER DR.	SC GAS DISTRIBUTION	ADD CASING FROM ROW TO ROW
12	ELECTRICAL	69 KV OVERHEAD	STA 3496+58/ FLETCHER DR.	LADWP	PROTECT-IN-PLACE
13	SEWER	8" VCP IN CSG	STA 3496+45/ FLETCHER DR.	CITY OF LOS ANGELES	PROTECT-IN-PLACE
14)	STORM DRAIN	18" RCP	STA 3496+06/ FLETCHER DR.	CITY OF LOS ANGELES	PROTECT-IN-PLACE
15	STORM DRAIN	24" RCP	STA 3496+06/ FLETCHER DR.	CITY OF LOS ANGELES	PROTECT-IN-PLACE
16	GAS H	4" IN 8" CSG	STA 3496+14/ FLETCHER DR.	SC GAS DISTRIBUTION	PROTECT-IN-PLACE
17	FIBER	OVERHEAD CABLE	STA 3496+58/ FLETCHER DR.	TBD	RELOCATE UNDERGROUND, ADD CASING ROW TO ROW
18	TELEPHONE	OVERHEAD CABLE	STA 3496+58/ FLETCHER DR.	AT&T LOCAL	RELOCATE UNDERGROUND, ADD CASING ROW TO ROW

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# CALIFORNIA HIGH-SPEED TRAIN PROJECT BURBANK TO LOS ANGELES

OPTION B REVISED ALIGNMENT - REVISED FINAL PEPD COMPOSITE UTILITIES PLAN HSR2 3489+00 TO HSR2 3502+00

CONTRACT NO. HSR14-39
DRAWING NO. UT-C1535
SCALE AS SHOWN
SHEET NO.

	TYPE OF UTILITY	SIZE/MATERIAL	LOCATION	OWNER	DISPOSITION
$(\overline{-})$	OIL	20" STL PIPE	STA 3143+00 TO 3684+00	PACIFIC PIPELINE	RELOCATE
2	FIBER	4-2" HDPE DUCTS IN CSG	STA 3143+00 TO 3684+00	QWEST (CENTURYLINK)	RELOCATE
3	FIBER	4-2" HDPE DUCTS IN CSG	STA 3143+00 TO 3684+00	MCI(VERIZON)-AT&T-SPRINT	RELOCATE
4	FIBER	4-2" HDPE DUCTS IN CSG	STA 3143+00 TO 3684+00	QWEST-MFS-METRO	RELOCATE
(5)	SEWER	8" VCP	STA 3505+41	CITY OF LOS ANGELES	PROTECT-IN-PLACE
6	SEWER	15" VCP ABAN	STA 3505+50 TO 3506+00	CITY OF LOS ANGELES	PROTECT-IN-PLACE
7	SEWER	12" VCP ABAN IN CSG	STA 3507+54	CITY OF LOS ANGELES	PROTECT-IN-PLACE
8	STORM DRAIN	10W×12H RCB	STA 3513+66	LOS ANGELES CO. FCD	PROTECT-IN-PLACE

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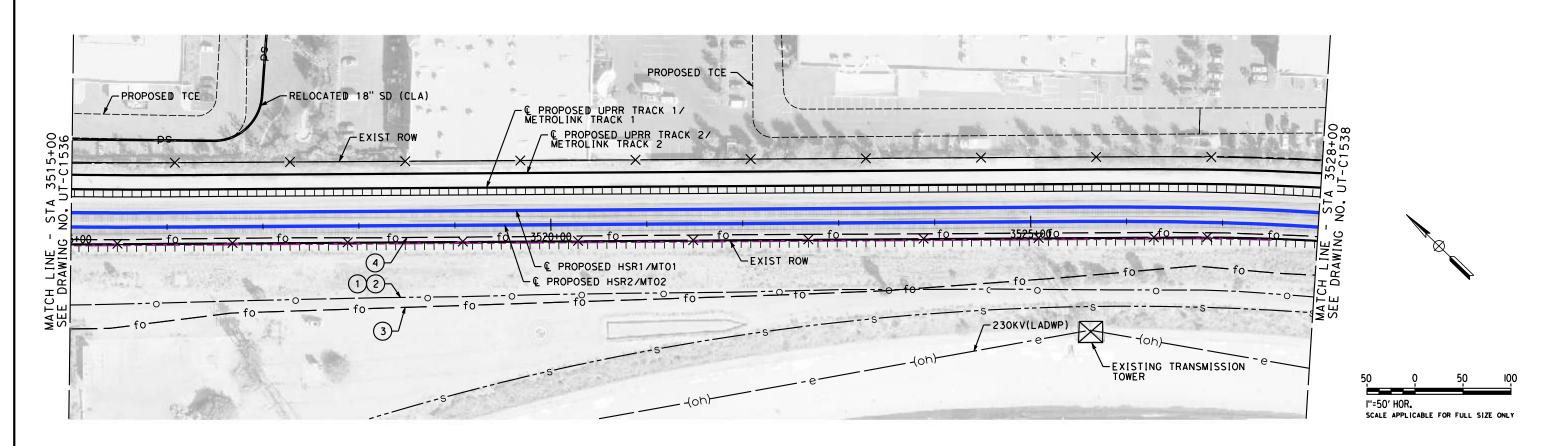


# CALIFORNIA HIGH-SPEED TRAIN PROJECT BURBANK TO LOS ANGELES

OPTION B REVISED ALIGNMENT - REVISED FINAL PEPD

COMPOSITE UTILITIES PLAN
HSR2 3502+00 TO HSR2 3515+00

CONTRACT NO. HSR14-39
DRAWING NO.
UT-C1536
SCALE
AS SHOWN
SHEET NO.



	TYPE OF UTILITY	SIZE/MATERIAL	LOCATION	OWNER	DISPOSITION
(1)	OIL	20" STL PIPE	STA 3143+00 TO 3684+00	PACIFIC PIPELINE	RELOCATE
(2)	FIBER	4-2" HDPE DUCTS IN CSG	STA 3143+00 TO 3684+00	QWEST (CENTURYLINK)	RELOCATE
3	FIBER	4-2" HDPE DUCTS IN CSG	STA 3143+00 TO 3684+00	MCI(VERIZON)-AT&T-SPRINT	RELOCATE
4	FIBER	4-2" HDPE DUCTS IN CSG	STA 3143+00 TO 3684+00	QWEST-MFS-METRO	RELOCATE

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# CALIFORNIA HIGH-SPEED TRAIN PROJECT BURBANK TO LOS ANGELES

OPTION B REVISED ALIGNMENT - REVISED FINAL
PEPD
COMPOSITE UTILITIES PLAN
HSR2 3515+00 TO HSR2 3528+00

CONTRACT NO. HSR14-39
DRAWING NO.
UT-C1537
SCALE
AS SHOWN
SHEET NO.

	TYPE OF UTILITY	SIZE/MATERIAL	LOCATION	OWNER	DISPOSITION
1	OIL	20" STL PIPE	STA 3413+00 TO 3684+00	PACIFIC PIPELINE	RELOCATE
2	FIBER	4-2" HDPE DUCTS IN CSG	STA 3413+00 TO 3684+00	QWEST (CENTURYLINK)	RELOCATE
3	FIBER	4-2" HDPE DUCTS IN CSG	STA 3413+00 TO 3684+00	MCI(VERIZON)-AT&T-SPRINT	RELOCATE
4	FIBER	4-2" HDPE DUCTS IN CSG	STA 3413+00 TO 3684+00	QWEST-MFS-METRO	RELOCATE
5	SEWER	12' INTERCEPTOR	STA 3532+61	TBD	PROTECT-IN-PLACE
6	STORM DRAIN	12'RC ARCH	STA 3534+36	TBD	PROTECT-IN-PLACE
7	STORM DRAIN	10W×10H RCB	STA 3539+08	LOS ANGELES CO. FCD	PROTECT-IN-PLACE

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# CALIFORNIA HIGH-SPEED TRAIN PROJECT BURBANK TO LOS ANGELES

OPTION B REVISED ALIGNMENT - REVISED FINAL PEPD

COMPOSITE UTILITIES PLAN
HSR2 3528+00 TO HSR2 3541+00

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	CONTRACT NO.
	HSR14-39
	DRAWING NO.
	UT-C1538
	SCALE
	AS SHOWN
	SHEET NO.

	TYPE OF UTILITY	SIZE/MATERIAL	LOCATION	OWNER	DISPOSITION
1	OIL	20" STL PIPE	STA 3413+00 TO 3684+00	PACIFIC PIPELINE	RELOCATE
2	FIBER	4-2" HDPE DUCTS IN CSG	STA 3413+00 TO 3684+00	QWEST (CENTURYLINK)	RELOCATE
3	FIBER	4-2" HDPE DUCTS IN CSG	STA 3413+00 TO 3684+00	MCI(VERIZON)-AT&T-SPRINT	RELOCATE
4	FIBER	4-2" HDPE DUCTS IN CSG	STA 3413+00 TO 3684+00	QWEST-MFS-METRO	RELOCATE
5	STORM DRAIN	5.5W × 3.75H RCB	STA 3546+59	LOS ANGELES CO. FCD	PROTECT-IN-PLACE

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# CALIFORNIA HIGH-SPEED TRAIN PROJECT BURBANK TO LOS ANGELES

OPTION B REVISED ALIGNMENT - REVISED FINAL
PEPD
COMPOSITE UTILITIES PLAN
HSR2 3541+00 TO HSR2 3554+00

CONTRACT NO. HSR14-39	
DRAWING NO.	
UT-C1539	
SCALE	
AS SHOWN	
SHEET NO.	

	TYPE OF UTILITY	SIZE/MATERIAL	LOCATION	OWNER	DISPOSITION
1	OIL	20" STL PIPE	STA 3456+37 TO 3660+00	PACIFIC PIPELINE	RELOCATE
2	FIBER	4-2" HDPE DUCTS IN CSG	STA 3456+37 TO 3660+00	QWEST (CENTURYLINK)	RELOCATE
3	FIBER	4-2" HDPE DUCTS IN CSG	STA 3448+20 TO 3660+00	MCI(VERIZON)-AT&T-SPRINT	RELOCATE
4	FIBER	4-2" HDPE DUCTS IN CSG	STA 3220+00 TO 3625+00	QWEST-MFS-METRO	RELOCATE
5	OIL	10" ABAN	STA 3551+61 TO 3635+00	KINDER MORGAN	REMOVE INTERFERING PORTIONS
6	GAS	6" IN 8" CSG	STA 3562+36	SC GAS	PROTECT-IN-PLACE

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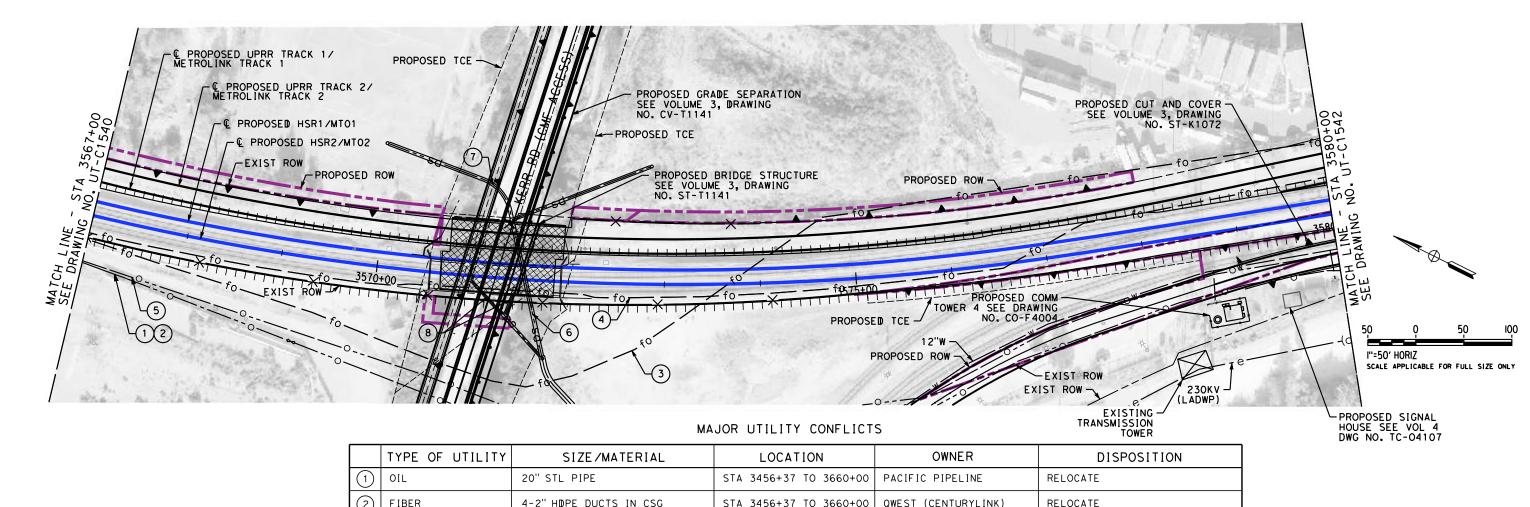


# CALIFORNIA HIGH-SPEED TRAIN PROJECT BURBANK TO LOS ANGELES

OPTION B REVISED ALIGNMENT - REVISED FINAL PEPD

COMPOSITE UTILITIES PLAN
HSR2 3554+00 TO HSR2 3567+00

CONTRACT NO. HSR14-39	
DRAWING NO.	
UT-C1540	
SCALE	
AS SHOWN	
SHEET NO.	



	TYPE OF UTILITY	SIZE/MATERIAL	LOCATION	OWNER	DISPOSITION
1	OIL	20" STL PIPE	STA 3456+37 TO 3660+00	PACIFIC PIPELINE	RELOCATE
2	FIBER	4-2" HDPE DUCTS IN CSG	STA 3456+37 TO 3660+00	QWEST (CENTURYLINK)	RELOCATE
3	FIBER	4-2" HDPE DUCTS IN CSG	STA 3448+20 TO 3660+00	MCI(VERIZON)-AT&T-SPRINT	RELOCATE
4	FIBER	4-2" HDPE DUCTS IN CSG	STA 3220+00 TO 3625+00	QWEST-MFS-METRO	RELOCATE
(5)	OIL	10" ABAN	STA 3551+61 TO 3635+00	KINDER MORGAN	REMOVE INTERFERING PORTIONS
6	STORM DRAIN	48" RCP	STA 3571+37 TO 3571+55	CITY OF LOS ANGELES	PROTECT IN PLACE
7	STORM DRAIN	42" RCP	STA 3571+07 TO 3571+37	CITY OF LOS ANGELES	PROTECT IN PLACE
8	STORM DRAIN	30" RCP & CATCH BASINS	STA 3570+96 TO 3571+75	CITY OF LOS ANGELES	PROTECT IN PLACE SD REPLACE CATCH BASINS

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# CALIFORNIA HIGH-SPEED TRAIN PROJECT BURBANK TO LOS ANGELES

OPTION B REVISED ALIGNMENT - REVISED FINAL
PEPD
COMPOSITE UTILITIES PLAN
HSR2 3567+00 TO HSR2 3580+00

CONTRACT NO.
HSR14-39
DRAWING NO.
UT-C1541
SCALE
AS SHOWN
SHEET NO.

	TYPE OF UTILITY	SIZE/MATERIAL	LOCATION	OWNER	DISPOSITION
1	OIL	20" STL PIPE	STA 3456+37 TO 3660+00	PACIFIC PIPELINE	RELOCATE
2	FIBER	4-2" HDPE DUCTS IN CSG	STA 3456+37 TO 3660+00	QWEST (CENTURYLINK)	RELOCATE
3	FIBER	2-4" HDPE DUCTS IN CSG	STA 3448+20 TO 3660+00	MCI(VERIZON)-AT&T-SPRINT	RELOCATE
4	FIBER	4-2" HDPE DUCTS IN CSG	STA 3220+00 TO 3625+00	QWEST-MFS-METRO	RELOCATE
5	OIL	10" ABAN	STA 3551+61 TO 3635+00	KINDER MORGAN	REMOVE INTERFERING PORTIONS
6	STORM DRAIN	48" RCP	STA 3582+92 TO 3583+50	LACFCD	ENCASE UNDER ACCESS ROAD
7	WATER	12"	STA 3576+75 TO 3626+50	LADWP	RELOCATE

REFER TO VOLUME 5 SHEETS UT-1001 TO UT-1004 FOR CMF UTILITY IMPROVEMENTS.

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# CALIFORNIA HIGH-SPEED TRAIN PROJECT BURBANK TO LOS ANGELES

OPTION B REVISED ALIGNMENT - REVISED FINAL PEPD COMPOSITE UTILITIES PLAN HSR2 3580+00 TO HSR2 3593+00

HSR14-39							
DRAWING NO.							
UT-C1542							
SCALE							
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	TYPE OF UTILITY	SIZE/MATERIAL	LOCATION	OWNER	DISPOSITION
1	OIL	20" STL PIPE	STA 3456+37 TO 3660+00	PACIFIC PIPELINE	RELOCATE
2	FIBER	4-2" HDPE DUCTS IN CSG	STA 3456+37 TO 3660+00	QWEST (CENTURYLINK)	RELOCATE
3	FIBER	2-4" HDPE DUCTS IN CSG	STA 3448+20 TO 3660+00	MCI(VERIZON)-AT&T-SPRINT	RELOCATE
4	FIBER	4-2" HDPE DUCTS IN CSG	STA 3220+00 TO 3625+00	QWEST-MFS-METRO	RELOCATE
5	OIL	10" ABAN	STA 3551+61 TO 3635+00	KINDER MORGAN	REMOVE INTERFERING PORTIONS
6	ELECTRICAL	230 KV	STA 3604+33 TO 3605+58	LADWP	PROTECT-IN-PLACE
7	SEWER	TBD	STA 3593+55 TO 3603+00	SCRRA	RELOCATE
8	WATER	TBD	STA 3593+77 TO 3603+86	SCRRA	RELOCATE
9	WATER	TBD	STA 3578+75 TO 3610+07	SCRRA	RELOCATE
10	SEWER	TBD	STA 3593+51 TO 3603+04	SCRRA	RELOCATE INTERFERING PORTIONS

REFER TO VOLUME 5 SHEETS UT-1001 TO UT-1004 FOR CMF UTILITY IMPROVEMENTS.

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# CALIFORNIA HIGH-SPEED TRAIN PROJECT BURBANK TO LOS ANGELES

OPTION B REVISED ALIGNMENT - REVISED FINAL
PEPD
COMPOSITE UTILITIES PLAN
HSR2 3593+00 TO HSR2 3606+00

CONTRACT NO. HSR14-39
DRAWING NO.
UT-C1543
SCALE
AS SHOWN
SHEET NO.

	TYPE OF UTILITY	SIZE/MATERIAL	LOCATION	OWNER	DISPOSITION
1	OIL	20" IN 110' OF 36" CSG	STA 3456+37 TO 3660+00	PACIFIC PIPELINE	RELOCATE
2	FIBER	4-2" HDPE DUCTS IN CSG	STA 3456+37 TO 3660+00	QWEST (CENTURYLINK)	RELOCATE
3	FIBER	2-4" HDPE DUCTS IN CSG	STA 3448+20 TO 3660+00	MCI(VERIZON)-AT&T-SPRINT	RELOCATE
4	FIBER	4-2" HDPE DUCTS IN CSG	STA 3220+00 TO 3625+00	QWEST-MFS-METRO	RELOCATE
5	OIL	10" ABAN	STA 3551+61 TO 3635+00	KINDER MORGAN	REMOVE INTERFERING PORTIONS
6	STORM DRAIN	81" RCP	STA 3609+43/ POPLAR ST.	LACFCD	PROTECT-IN-PLACE
7	STORM DRAIN	63" RCP	STA 3612+53/ MC CLURE ST.	CITY OF LOS ANGELES	PROTECT-IN-PLACE
8	WATER	8" WATER IN 12" CSG	STA 3610+06	CITY OF LOS ANGELES	PROTECT-IN-PLACE

REFER TO VOLUME 5 SHEETS UT-1001 TO UT-1004 FOR CMF UTILITY IMPROVEMENTS.

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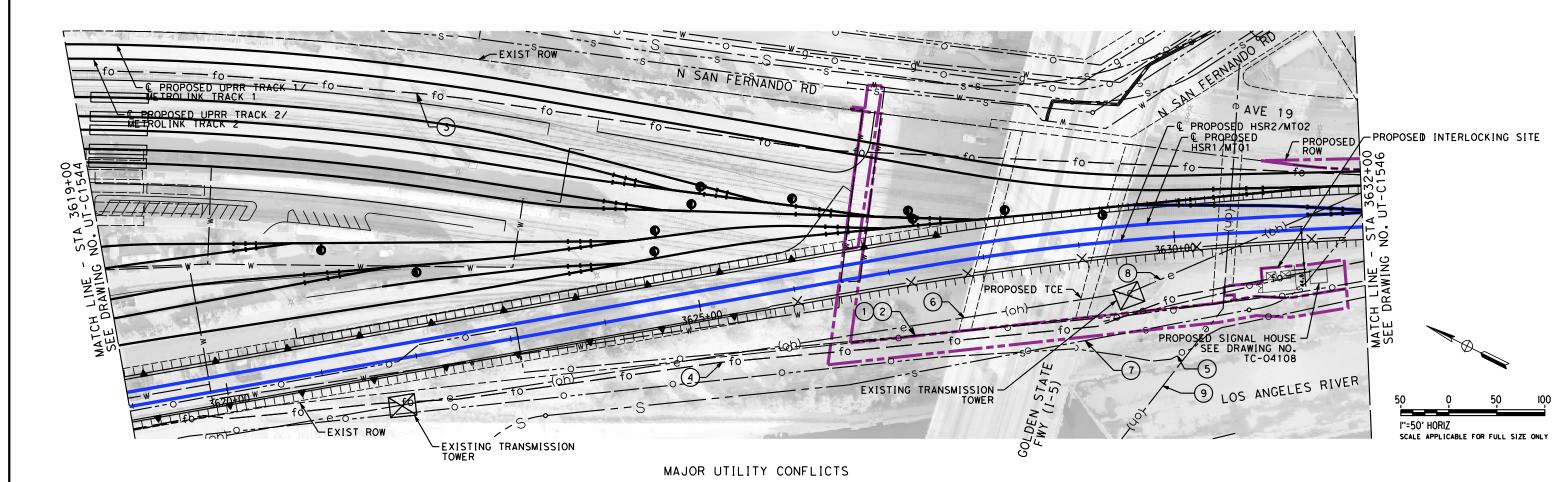




## CALIFORNIA HIGH-SPEED TRAIN PROJECT BURBANK TO LOS ANGELES

OPTION B REVISED ALIGNMENT - REVISED FINAL PEPD COMPOSITE UTILITIES PLAN HSR2 3606+00 TO HSR2 3619+00

CONTRACT NO. HSR14-39
DRAWING NO.
UT-C1544
SCALE
AS SHOWN
SHEET NO.



	TYPE OF UTILITY	SIZE/MATERIAL	LOCATION	OWNER	DISPOSITION
1	OIL	20" IN 110' OF 36" CSG	STA 3456+37 TO 3660+00	PACIFIC PIPELINE	RELOCATE
2	FIBER	4-2" HDPE DUCTS IN CSG	STA 3456+37 TO 3660+00	QWEST (CENTURY LINK)	RELOCATE
3	FIBER	2-4" HDPE DUCTS IN CSG	STA 3448+20 TO 3660+00	MCI(VERIZON)-AT&T-SPRINT	RELOCATE
4	FIBER	4-2" HDPE DUCTS IN CSG	STA 3220+00 TO 3625+00	QWEST-MFS-METRO	RELOCATE
5	OIL	10" ABAN	STA 3551+61 TO 3635+00	KINDER MORGAN	REMOVE INTERFERING PORTIONS
6	ELECTRICAL	230 KV	STA 3631+16 TO 3631+88	LADWP	PROTECT-IN-PLACE
7	SEWER	48" RCP	STA 3624+81 TO 3632+88	CITY OF LOS ANGELES	PROTECT-IN-PLACE
8	ELECTRICAL	230 KV	STA 3624+81 TO 3632+88	LADWP	PROTECT-IN-PLACE
9	ELECTRICAL	OVERHEAD ELECTRICAL	STA 3630+56	TBD	RAISE/RELOCATE

REFER TO VOLUME 5 SHEETS UT-1001 TO UT-1004 FOR CMF UTILITY IMPROVEMENTS.

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# CALIFORNIA HIGH-SPEED TRAIN PROJECT BURBANK TO LOS ANGELES

OPTION B REVISED ALIGNMENT - REVISED FINAL
PEPD
COMPOSITE UTILITIES PLAN
HSR2 3619+00 TO HSR2 3632+00

CONTRACT NO. HSR14-39
DRAWING NO.
UT-C1545
SCALE
AS SHOWN
SHEET NO.

	TYPE OF UTILITY	SIZE/MATERIAL	LOCATION	OWNER	DISPOSITION
1	OIL	20" IN CSG	STA 3456+37 TO 3660+00	PACIFIC PIPELINE	RELOCATE
2	FIBER	4-2" HDPE DUCTS IN CSG	STA 3456+37 TO 3660+00	QWEST (CENTURYLINK)	RELOCATE
3	FIBER	2-4" HDPE DUCTS IN CSG	STA 3448+20 TO 3660+00	MCI(VERIZON)-AT&T-SPRINT	RELOCATE
4	FIBER	4-2" HDPE DUCTS IN CSG	STA 3220+00 TO 3660+00	QWEST-MFS-METRO	RELOCATE
5	OIL	10" ABAN	STA 3636+62 TO 3688+00	KINDER MORGAN	REMOVE INTERFERING PORTIONS
6	ELECTRICAL	230 KV	STA 3624+81 TO 3632+88	LADWP	PROTECT-IN-PLACE
7	SEWER	48" RCP	STA 3631+88	CITY OF LA	PROTECT-IN-PLACE
8	STORM DRAIN	TBD	STA 3634+15/ FIGUEROA ST.	CITY OF LA	PROTECT-IN-PLACE
9	GAS	6"	STA 3634+38/ FIGUEROA ST.	SC GAS	PROTECT-IN-PLACE
10	WATER	40" IN 48" WWJ CSG	STA TBD/ FIGUEROA ST.	LADWP	PROTECT-IN-PLACE

NOT FOR CONSTRUCTION FOR INTERNAL USE ONLY

REV	DATE	BY	СНК	APP	DESCRIPTION	07/15/2021	
REV						C. LEE	C
ي 📗						M. REIFER IN CHARGE	
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						DRAWN BY C. CUSSON	Ι.
						DESIGNED BY  R. PETERS	

PEPD RECORD SET NOT FOR CONSTRUCTION





# CALIFORNIA HIGH-SPEED TRAIN PROJECT BURBANK TO LOS ANGELES

OPTION B REVISED ALIGNMENT - REVISED FINAL
PEPD
COMPOSITE UTILITIES PLAN
HSR2 3632+00 TO HSR2 3645+00

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	DRAWING	NO.	
	UT-	-C1546	,
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	TYPE OF UTILITY	SIZE/MATERIAL	LOCATION	OWNER	DISPOSITION
1	OIL	20" IN CSG	STA 3456+37 TO 3660+00	PACIFIC PIPELINE	RELOCATE
2	FIBER	4-2" HDPE DUCTS IN CSG	STA 3456+37 TO 3660+00	QWEST (CENTURYLINK)	RELOCATE
3	FIBER	2-4" HDPE DUCTS IN CSG	STA 3448+20 TO 3660+00	MCI(VERIZON)-AT&T-SPRINT	RELOCATE
4	ELECTRICAL	230 KV	STA 3636+62 TO 3660+00	LADWP	PROTECT-IN-PLACE
5	WATER	30" IN 40" STL CSG	STA 3654+62	LADWP	PROTECT-IN-PLACE
6	WATER	30" IN 40" STL CSG	STA 3654+68	LADWP	PROTECT-IN-PLACE

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| DESIGNED BY | R. PETERS | DRAWN BY | C. CUSSON | CHECKED BY | M. REIFER | IN CHARGE | C. LEE | C. LEE | DATE | BY CHK APP | DESCRIPTION | DATE | O7/15/2021

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# CALIFORNIA HIGH-SPEED TRAIN PROJECT BURBANK TO LOS ANGELES

OPTION B REVISED ALIGNMENT - REVISED FINAL
PEPD
COMPOSITE UTILITIES PLAN
HSR2 3645+00 TO HSR2 3658+00

CONTRACT NO. HSR14-39
DRAWING NO.
UT-C1547
SCALE
AS SHOWN
SHEET NO.

	TYPE OF UTILITY	SIZE/MATERIAL	LOCATION	OWNER	DISPOSITION
1	OIL	20" IN CSG	STA 3456+37 TO 3660+00	PACIFIC PIPELINE	RELOCATE
2	FIBER	4-2" HDPE DUCTS IN CSG	STA 3456+37 TO 3660+00	QWEST (CENTURY LINK)	RELOCATE
3	FIBER	2-4" HDPE DUCTS IN CSG	STA 3448+20 TO 3660+00	MCI(VERIZON)-AT&T-SPRINT	RELOCATE
4	ELECTRICAL	230 KV	STA 3636+62 TO 3660+00	LADWP	RELOCATE/RAISE
5	OIL	6" ABAN CONC SLURRY	STA 3663+29 TO 3688+00	MOBIL	REMOVE INTERFERING PORTIONS
6	OIL	10" ABAN CONC SLURRY	STA 3663+29 TO 3688+00	MOBIL	REMOVE INTERFERING PORTIONS
7	STORM DRAIN	66" RCP	STA 3667+68/ BROADWAY ST.	CITY OF LOS ANGELES	PROTECT-IN-PLACE
8	WATER	16" IN 24" STL CSG	STA 3668+99/ BROADWAY ST.	LADWP	PROTECT-IN-PLACE
9	OIL	8" ABAN CONC SLURRY	STA 3660+00 TO 3663+26	MOBIL	REMOVE INTERFERING PORTIONS

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cns	REV	DATE	BY	СНК	APP	DESCRIPTION 07/15/	/2021

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### CALIFORNIA HIGH-SPEED TRAIN PROJECT BURBANK TO LOS ANGELES

OPTION B REVISED ALIGNMENT - REVISED FINAL PEPD

COMPOSITE UTILITIES PLAN
HSR2 3658+00 TO HSR2 3671+00

CONTRACT NO. HSR14-39
DRAWING NO.
UT-C1548
SCALE
AS SHOWN
SHEET NO.

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	TYPE OF UTILITY	SIZE/MATERIAL	LOCATION	OWNER	DISPOSITION
1	FIBER	TBD	STA 3674+33/ N SPRING ST.	AT&T	PROTECT-IN-PLACE
2	STORM DRAIN	16" VCP	STA 3674+74/ N SPRING ST.	CITY OF LOS ANGELES	PROTECT-IN-PLACE
3	STORM DRAIN	12" VCP	STA 3677+80/ NAUD ST.	CITY OF LOS ANGELES	PROTECT-IN-PLACE
4	OIL	6" ABAN CONC SLURRY	STA 3663+29 TO 3688+00	MOBIL	REMOVE
5	OIL	10" ABAN CONC SLURRY	STA 3663+29 TO 3688+00	MOBIL	REMOVE
6	FIBER	2-1.5" HDPE IN 6" STL CSG	STA 3684+71	LEVEL 3	RELOCATE TO NEW BRIDGE TO TIE-IN AT EACH END
7	ELECTRICAL	230 KV OH	STA 3673+24 TO 3688+00	LADWP	PROTECT-IN-PLACE
8	FIBER	4" COMMUNICATION LINE	TBD (LIMITS UNKNOWN)	METROLINK	RELOCATE
9	FIBER	4" COMMUNICATION LINE	TBD (LIMITS UNKNOWN)	METROLINK	RELOCATE
10	FIBER	4" COMMUNICATION LINE	TBD (LIMITS UNKNOWN)	METROLINK	RELOCATE
(11)	GAS	6" GAS (ABANDONED)	STA 3674+32/ N SPRING ST.	SCG	REMOVE INTERFERING REGIONS
12	WATER	10" WATER (ABANDONED)	STA 3674+31/ N SPRING ST.	DWPWS	REMOVE INTERFERING REGIONS

REFER TO PROPOSED UTILITY RELOCATION DWG. NO. UT-D7151 AND DWG UT-D7152 FOR UTILITY INFORMATION AT ROADWAY IMPROVEMENT

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CONSTRUCTION





# CALIFORNIA HIGH-SPEED TRAIN PROJECT BURBANK TO LOS ANGELES

OPTION B REVISED ALIGNMENT - REVISED FINAL
PEPD
COMPOSITE UTILITIES PLAN
HSR2 3671+00 TO HSR2 3684+00

CONTRACT NO. HSR14-39
DRAWING NO.
UT-C1549
SCALE
AS SHOWN
SHEET NO.

	TYPE OF UTILITY	SIZE/MATERIAL	LOCATION	OWNER	DISPOSITION
1	OIL	6" ABAN CONC SLURRY	STA 3663+29 TO 3688+00	MOBIL	PROTECT-IN-PLACE
2	OIL	10" ABAN CONC SLURRY	STA 3663+29 TO 3688+00	MOBIL	PROTECT-IN-PLACE
3	ELECTRICAL	230 KV	STA 3673+24 TO 3688+00	LADWP	PROTECT-IN-PLACE
4	ELECTRICAL	OH-LIGHTING	STA 3684+46	LADWP	RAISE & RELOCATE

REFER TO PROPOSED UTILITY RELOCATION DWG. NO. UT-D7151 AND DWG UT-D7152 FOR UTILITY INFORMATION AT ROADWAY IMPROVEMENT

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# CALIFORNIA HIGH-SPEED TRAIN PROJECT BURBANK TO LOS ANGELES

OPTION B REVISED ALIGNMENT - REVISED FINAL
PEPD
COMPOSITE UTILITIES PLAN
HSR2 3684+00 TO HSR2 3697+00

HSR14-39
DRAWING NO.
UT-C1550
SCALE
AS SHOWN
SHEET NO.

	TYPE OF UTILITY	SIZE/MATERIAL	LOCATION	OWNER	DISPOSITION
1	RAW WATER	12" HDPE WATER LINE	SF 3214+06 TO 3218+00	SF VAL BUR. OPER. UN.	RELOCATE
2	WATER	24" STL IN 60" OF 36" STL CSG	SF 3211+29	BURBANK WATER & POWER	PROTECT-IN-PLACE
3	GAS	6" GAS LINE	SF 3211+32	SC GAS	PROTECT-IN-PLACE
4	ELECTRICAL	4 ELECTRIC DUCTS	SF 3211+19	BURBANK WATER & POWER	PROTECT-IN-PLACE
(5)	TELEPHONE	24 TELEPHONE DUCTS	SF 3211+22	TBD	PROTECT-IN-PLACE
6	WATER	30" IN 42" STL CSG	SF 3212+79	BURBANK WATER & POWER	EXTEND CSG
7	ELECTRICAL	UNDERGROUND ELECTRICAL LINE	SF 3214+35 TO 3218+00	CITY OF BURBANK	RELOCATE
8	EXTRACTION WELL VO7	VAULT & RELATED INFRASTRUCTURE	SF 3214+06 TO 3214+34	SF VAL BUR. OPER. UN.	PROTECT-IN-PLACE
9	FIBER	TBD	SF 3211+23	TBD	PROTECT-IN-PLACE
10	SEWER	TBD	SF 3211+86 TO 3212+21	TBD	PROTECT-IN-PLACE
(1)	WELLS	OBSERVATION WELLS OW-VO7A/B	SF 3213+97	SF VAL BUR. OPER. UN.	PROTECT-IN-PLACE

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#### CALIFORNIA HIGH-SPEED TRAIN PROJECT BURBANK TO LOS ANGELES

OPTION B REVISED ALIGNMENT - REVISED FINAL PEPD COMPOSITE UTILITIES PLAN SF 3211+43.44 TO SF 3218+00

CONTRACT NO. HSR14-39
UT-C1601
AS SHOWN
SHEET NO.

No.	TYPE OF UTILITY	SIZE / MATERIAL	LOCATION	OWNER	DISPOSITION
	WELLS	GROUNDWATER MONITORING WELLS	STA 3222+56 TO 3223+07	SF VAL BUR. OPER. UN.	RELOCATE
(2)	RAW WATER	12", 16", 24", & 30" HDPE WATER LINES	STA 3218+00 TO 3231+00	SF VAL BUR. OPER. UN.	RELOCATE
3	ELECTRICAL	OVERHEAD ELECTRICAL LINES	STA 3225+18 TO 3231+00	SCE	RELOCATE
4	ELECTRICAL	UNDERGROUND ELECTRICAL LINE	STA 3218+00 TO 3231+00	CITY OF BURBANK	RELOCATE
5	TELEPONE	OVERHEAD TELEPHONE LINE	STA 3225+18 TO 3231+00	TBD	RELOCATE
6	SEWER	12" CIP SEWER LINE	STA 3225+56	CITY OF BURBANK	EXTEND EXISTING CSG. UNDER TEMP. CONST. LIMITS
7	ELECTRICAL	UNDERGROUND ELECTRICAL LINES	STA 3224+48 TO 3225+48	CITY OF BURBANK	RELOCATE
8	WELLS	OBSERVATION WELLS OW-VO6A/B	STA 3224+53	SF VAL BUR. OPER. UN.	MODIFY, RAISE TO GRADE
9	TBD	ANODE STATIONS	STA 3224+75 TO 3225+02	TBD	RELOCATE
(0)	TELEPHONE	OVERHEAD TELEPHONE	STA 3230+26	TBD	RELOCATE
11	EXTRACTION WELL VO6	VAULT & RELATED INFRASTRUCTURE	STA 3224+03 TO 3224+34	SF VAL BUR, OPER. UN.	RELOCATE
12	RAW WATER	JUNCTION VAULT & RELATED INFRA.	STA 3228+89	SF VAL BUR. OPER. UN.	RELOCATE

REFER TO PROPOSED UTILITY RELOCATION DWG. NO. UT-D7021 FOR UTILITY INFORMATION AT ROADWAY IMPROVEMENT

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#### CALIFORNIA HIGH-SPEED TRAIN PROJECT BURBANK TO LOS ANGELES

OPTION B REVISED ALIGNMENT - REVISED FINAL COMPOSITE UTILITIES PLAN SF 3218+00 TO SF 3231+00

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	CONTRACT NO. HSR14-39
	UT-C1602
	SCALE
	AS SHOWN
	SHEET NO.

No.	TYPE OF UTILITY	SIZE / MATERIAL	LOCATION	OWNER	DISPOSITION
1	FIBER	UNDERGROUND FIBER	STA 3231+00 TO 3244+00	MCI/SPRINT	RELOCATE
2	GAS	2" GAS LINE	STA 3241+93	SC GAS	RELOCATE OUTSIDE CONST. ZONE
3	STORM DRAIN	CATCH BASIN & X" CULVERT	STA 3241+52	CITY OF BURBANK	RELOCATE OUTSIDE CONST. ZONE
4	ELECTRICAL	OVERHEAD ELECTRICAL LINE	STA 3231+00 TO 3244+00	SCE	RELOCATE
5	TELEPONE	OVERHEAD TELEPHONE LINE	STA 3231+00 TO 3244+00	TBD	RELOCATE
6	WELLS	OBSERVATION WELLS OW-VO5A/B	STA 3237+27	SF VAL BUR. OPER. UN.	PROTECT-IN-PLACE
7	RAW WATER	20"-24" HDPE WATER LINE	STA 3231+00 TO 3244+00	SF VAL BUR. OPER. UN.	RELOCATE
8	ELECTRICAL	UNDERGROUND ELECTRICAL LINE	STA 3231+00 TO 3237+00	CITY OF BURBANK	RELOCATE
9	EXTRACTION WELL VO5	VAULT & RELATED INFRA.	STA 3236+76 TO 3238+39	SF VAL BUR. OPER. UN.	RELOCATE

REFER TO PROPOSED UTILITY RELOCATION DWG, NO. UT-D7022 FOR UTILITY INFORMATION AT ROADWAY IMPROVEMENT

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## DESIGNED BY R, PETERS DRAWN BY C. CUSSON CHECKED BY M, REIFER IN CHARGE C. LEE

DESCRIPTION

BY CHK APP

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07/15/2021






#### CALIFORNIA HIGH-SPEED TRAIN PROJECT BURBANK TO LOS ANGELES

OPTION B REVISED ALIGNMENT - REVISED FINAL PEPD

COMPOSITE UTILITIES PLAN

SF 3231+00 TO SF 3244+00

HSR14-39
UT-C1603
AS SHOWN
SHEET NO.

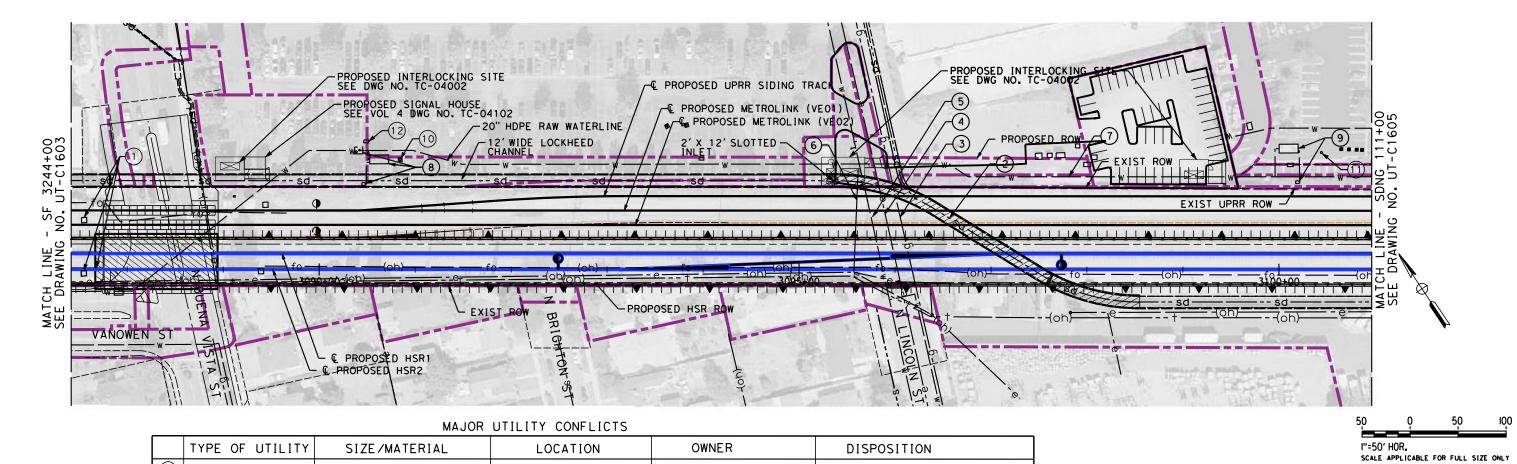

	MAJOR UTILITY CONFLICTS										
	TYPE OF UTILITY	SIZE/MATERIAL	LOCATION	OWNER	DISPOSITION						
1	RAIL	RAIL UTILITIES	STA 3244+13 TO 3244+26	TBD	RELOCATE						
2	STORM DRAIN	12' WIDE LOCKHEED CHANNEL	STA 105+27 TO 111+00	LACFCD	RELOCATE, SEE SHT. CV-G1305						
3	GAS	3" GAS LINE	STA 106+04	SC GAS	EXTEND CSG ACROSS CONST. LIMITS						
4	ELECTRICAL	UNDERGROUND ELEC. DUCTS	STA 105+89	SCE	EXTEND CSG ACROSS CONST. LIMITS						
(5)	WATER	20" WATER LINE	STA 105+74	CITY OF BURBANK	EXTEND CSG ACROSS CONST. LIMITS						
6	ELECTRICAL	QUEEN POLE	STA 105+64	SCE	RELOCATE						
7	RAW WATER	20" HDPE WATER LINE	STA 106+60 TO 111+00	SF VAL BUR. OPER. UN.	RELOCATE						
8	EXTRACTION WELL VO4	WELL & RELATED INFRA.	STA 100+40 TO 100+79	SF VAL BUR. OPER. UN.	PROTECT-IN-PLACE WELL/ RELOCATE RELATED INFRA.						
9	EXTRACTION WELL VO3	WELL & RELATED INFRA.	STA 109+98 TO 110+25	SF VAL BUR. OPER. UN.	PROTECT-IN-PLACE WELL/ RELOCATE RELATED INFRA.						
10	WELLS	OBSERV. WELLS OW-VO4A/B	STA 100+91	SF VAL BUR. OPER. UN.	PROTECT-IN-PLACE						
11)	WELLS	OBSERV. WELLS OW-VO3A/B-R	STA 110+47	SF VAL BUR. OPER. UN.	PROTECT-IN-PLACE						
(12)	ELECTRICAL	VAULT	STA 100+52	CITY OF BURBANK	PROTECT-IN-PLACE						

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#### CALIFORNIA HIGH-SPEED TRAIN PROJECT BURBANK TO LOS ANGELES

OPTION B REVISED ALIGNMENT - REVISED FINAL PEPD COMPOSITE UTILITIES PLAN SF 3244+00 TO SDNG 111+00

ONTRACT NO. HSR14-39
RAWING NO.
UT-C1604
CALE
AS SHOWN
HEET NO.

No.	TYPE OF UTILITY	SIZE / MATERIAL	LOCATION	OWNER	DISPOSITION
1	STORM DRAIN	36" RCP	STA 114+67	TBD	JOIN REALIGNED CHANNEL
2	RAW WATER	12", 18", & 20" HDPE	STA 111+00 TO 124+00	SF VAL BUR. OPER. UN.	RELOCATE
3	WATER - FIRE	WATER LINE FIXTURES	STA 114+09 TO 121+78	TBD	RELOCATE
4	EXTRACTION WELL VO2	WELL & RELATED INFRA.	STA 119+04 TO 119+32	SF VAL BUR. OPER. UN.	PROTECT-IN-PLACE WELLS/ RELOCATE RELATED INFRA.
5	WELLS	OBSERVATION WELLS OW-VO2A/B-R	STA 1190+03	SF VAL BUR. OPER. UN.	PROTECT-IN-PLACE

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# | DESIGNED BY | R. PETERS | DRAWN BY | C. CUSSON | CHECKED BY | M. REIFER | IN CHARGE | C. LEE | DATE | BY CHK | APP | DESCRIPTION | DATE | DA

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#### CALIFORNIA HIGH-SPEED TRAIN PROJECT BURBANK TO LOS ANGELES

OPTION B REVISED ALIGNMENT - REVISED FINAL PEPD

COMPOSITE UTILITIES PLAN
SDNG 111+00 TO SDNG 124+00

HSR14-39
DRAWING NO.
UT-C1605
SCALE
AS SHOWN
SHEET NO.

	TYPE OF UTILITY	SIZE/MATERIAL	LOCATION	OWNER	DISPOSITION
1	STORM DRAIN	36" RCP	STA 131+17	TBD	JOIN REALIGNED CHANNEL
2	RAW WATER	12" HDPE WATER LINE	STA 124+00 TO 126+85	SF VAL BUR. OPER. UN.	RELOCATE
3	WATER	WATER LINE FIXTURES	STA 126+34 TO 131+44	TBD	RELOCATE
4	ELECTRICAL	UNDERGROUND ELECTRICAL	STA 127+14 TO 131+15	CITY OF BURBANK	RELOCATE
(5)	WATER	8" DI WATER LINE	STA 132+25 TO 135+00	TBD	RELOCATE
6	WELLS	OBSERVATION WELLS B-1-CW11/12	STA 133+39 TO 133+57	SF VAL BUR. OPER. UN.	RELOCATE
7	EXTRACTION WELL VO1	WELL & RELATED INFRA.	STA 126+82 TO 127+11	SF VAL BUR. OPER. UN.	PROTECT-IN-PLACE WELL/ RELOCATE RELATED INFRA.
8	WELLS	OBSERVATION WELLS OW-VO1A/B-R	STA 126+85	SF VAL BUR. OPER. UN.	PROTECT-IN-PLACE

REFER TO LOCKHEED CHANNEL RELOCATION DWG. NO. CV-G1301 TO CV-G1308 FOR PROPOSED DESIGN

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#### CALIFORNIA HIGH-SPEED TRAIN PROJECT BURBANK TO LOS ANGELES

OPTION B REVISED ALIGNMENT - REVISED FINAL COMPOSITE UTILITIES PLAN SDNG 124+00 TO SDNG 133+02.62


CONTRACT NO. HSR14-39
DRAWING NO. UT-C1606
AS SHOWN
SHEET NO.

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No.	TYPE OF UTILITY	SIZE / MATERIAL	LOCATION	OWNER	DISPOSITION
1	WELLS	OBSERVATION WELLS OW-VO7A/B	STA 3214+00	SF VAL BUR. OPER. UN.	PROTECT-IN-PLACE
2	EXTRACTION WELL VO7	VAULT & RELATED INFRASTRUCTURE	STA 3214+08 TO 3214+38	SF VAL BUR, OPER, UN,	PROTECT-IN-PLACE

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#### CALIFORNIA HIGH-SPEED TRAIN PROJECT BURBANK TO LOS ANGELES

OPTION B REVISED ALIGNMENT - REVISED FINAL PEPD COMPOSITE UTILITIES PLAN VEO1, VEO2 3215+72.96 TO VEO1, VEO2 3218+00

HSR14-39
DRAWING NO. UT-C1701
SCALE AS SHOWN
SHEET NO.

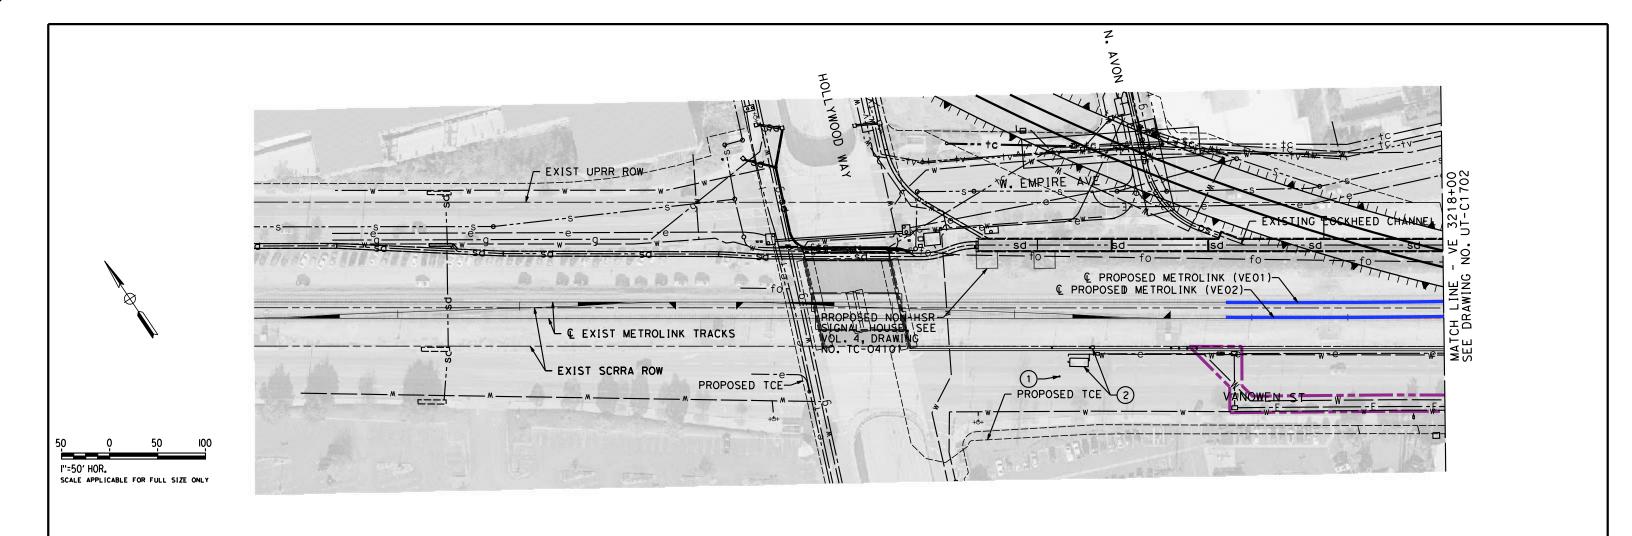No.	TYPE OF UTILITY	SIZE / MATERIAL	LOCATION	OWNER	DISPOSITION
1	FIBER	UNDERGROUND FIBER	STA 3224+15 TO 3231+00	MCI/SPRINT	RELOCATE
2	WELLS	OBSERVATION WELLS OW-VO6A/B	STA 3224+55	SF VAL BUR. OPER. UN.	PROTECT-IN-PLACE
3	WELLS	GROUNDWATER MONITORING WELLS	STA 3222+59 TO 3223+10	SF VAL BUR. OPER. UN.	RELOCATE
4	EXTRACTION WELL VO6	VAULT & RELATED INFRASTRUCTURE	STA 3224+06 TO 3224+37	SF VAL BUR. OPER. UN.	RELOCATE
5	RAW WATER	12", 16", 24", & 30" HDPE WATER LINES	STA 3218+00 TO 3231+00	SF VAL BUR. OPER. UN.	RELOCATE
6	RAW WATER	JUNCTION VAULT AND RELATED INFRA.	STA 3228+89	SF VAL BUR. OPER. UN.	RELOCATE

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#### CALIFORNIA HIGH-SPEED TRAIN PROJECT BURBANK TO LOS ANGELES

OPTION B REVISED ALIGNMENT - REVISED FINAL PEPD COMPOSITE UTILITIES PLAN VEO1, VEO2 3218+00 TO VEO1, VEO2 3231+00

HSR14-39	
DRAWING NO.	
UT-C1702	
SCALE	
AS SHOWN	
SHEET NO.	

No.	TYPE OF UTILITY	SIZE / MATERIAL	LOCATION	OWNER	DISPOSITION
1	FIBER	UNDERGROUND FIBER	STA 3231+00 TO 3244+00	MCI/SPRINT	RELOCATE
2	WELLS	OBSERVATION WELLS OW-VO5A/B	STA 3237+25	SF VAL BUR. OPER. UN.	PROTECT-IN-PLACE
3	EXTRACTION WELL VO5	VAULT & RELATED INFRA.	STA 3236+77 TO 3237+09	SF VAL BUR. OPER. UN.	RELOCATE
4	RAW WATER	20" TO 24" HDPE WATER LINE	STA 3231+00 TO 3244+00	SF VAL BUR. OPER. UN.	RELOCATE

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| DESIGNED BY R. PETERS | DRAWN BY | C. CUSSON | C. CU

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#### CALIFORNIA HIGH-SPEED TRAIN PROJECT BURBANK TO LOS ANGELES

OPTION B REVISED ALIGNMENT - REVISED FINAL PEPD

COMPOSITE UTILITIES PLAN
VEO1, VEO2 3231+00 TO VEO1, VEO2 3244+00

CONTRACT NO. HSR14-39
DRAWING NO. UT-C1703
SCALE AS SHOWN
SHEET NO.

MAJOR	UTIL	ITY	CONFL	ICTS

	TYPE OF HITH LITY		- CONTROL	OWNED	DICROCITION
	TYPE OF UTILITY	SIZE/MATERIAL	LOCATION	OWNER	DISPOSITION
1	STORM DRAIN	12' WIDE LOCKHEED CHANNEL	STA 3251+82 TO 3257+00	LACFCD	RELOCATE, SEE SHT. CV-G1305
2	GAS	3" GAS LINE	STA 3252+66	SC GAS	EXTEND CSG ACROSS CONST. LIMITS
3	ELECTRICAL	UNDERGROUND ELEC. DUCTS	STA 3252+51	SCE	EXTEND CSG ACROSS CONST. LIMITS
4	WATER	20" WATER LINE	STA 3252+35	CITY OF BURBANK	EXTEND CSG ACROSS CONST. LIMITS
5	ELECTRICAL	QUEEN POLE	STA 3252+18	SCE	RELOCATE
6	RAIL	RAIL UTILITIES	STA 3245+58 TO 3246+05	TBD	RELOCATE
7	ELECTRICAL	OVERHEAD ELECTRICAL LINE	STA 3245+43	SCE	RELOCATE
8	TELEPHONE	OVERHEAD TELEPHONE LINE	STA 3245+42	TBD	RELOCATE
9	TELECOMMUNICATION	OVERHEAD CABLE LINE	STA 3245+42	TBD	RELOCATE
10	RAIL	RAIL UTILITIES	STA 3244+10 TO 3244+46	TBD	RELOCATE
11	RAW WATER	20" STEEL WATER LINE & VALVE	STA 3245+51	SF VAL BUR. OPER. UN.	RELOCATE PIPE & VALVE, ADD CASING
12	RAW WATER	20" HDPE WATER LINE	STA 3253+15 TO 3257+00	SF VAL BUR. OPER. UN.	RELOCATE
13	EXTRACTION WELL VO4	WELL & RELATED INFRA.	STA 3247+03 TO 3247+31	SF VAL BUR. OPER. UN.	PROTECT-IN-PLACE WELL/ RELOCATE RELATED INFRA.
14	EXTRACTION WELL VO3	WELL & RELATED INFRA.	STA 3256+54 TO 3256+80	SF VAL BUR. OPER. UN.	PROTECT-IN-PLACE WELL/ RELOCATE RELATED INFRA.
15)	WELLS	OBSERV. WELLS OW-VO4A/B	STA 3247+43	SF VAL BUR. OPER. UN.	PROTECT-IN-PLACE
16	ELECTRICAL	VAULT	STA 3247+07	CITY OF BURBANK	PROTECT-IN-PLACE
17	ELECTRICAL	CABINETS/TRANSFORMER	STA 3254+05 TO 3254+36	TBD	PROTECT-IN-PLACE

NOT FOR CONSTRUCTION FOR INTERNAL USE ONLY

I"=50' HOR.

SCALE APPLICABLE FOR FULL SIZE ONLY

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(/)							DESIGNED BY R. PETERS	
						R. PETERS	DRAWN BY C. CUSSON	
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ssor							C. LEE	C
S	REV	DATE	BY	СНК	APP	DESCRIPTION	07/15/2021	

PEPD RECORD SET NOT FOR CONSTRUCTION





#### CALIFORNIA HIGH-SPEED TRAIN PROJECT BURBANK TO LOS ANGELES

OPTION B REVISED ALIGNMENT - REVISED FINAL COMPOSITE UTILITIES PLAN VEO1, VEO2 3244+00 TO VEO1, VEO2 3257+00

CONTRACT NO. HSR14-39
UT-C1704
SCALE AS SHOWN
SHEET NO.

No.	TYPE OF UTILITY	SIZE / MATERIAL	LOCATION	OWNER	DISPOSITION
1	STORM DRAIN	36" RCP	STA 3261+22	TBD	JOIN REALIGNED CHANNEL
2	RAW WATER	12", 18", & 20" HDPE	STA 3257+00 TO 3270+00	SF VAL BUR. OPER. UN.	RELOCATE
3	WATER - FIRE	WATER LINE FIXTURES	STA 3260+64 TO 3268+33	TBD	RELOCATE
4	EXTRACTION WELL VO2	WELL & RELATED INFRA.	STA 3265+61 TO 3265+88	SF VAL BUR. OPER. UN.	PROTECT-IN-PLACE WELL/ RELOCATE RELATED INFRA.
5	WELLS	OBSERVATION WELLS OW-VO3A/B-R	STA 3257+02	SF VAL BUR. OPER. UN.	PROTECT-IN-PLACE
6	WELLS	OBSERVATION WELLS OW-VO2A/B-R	STA 3265+58	SF VAL BUR, OPER, UN.	PROTECT-IN-PLACE

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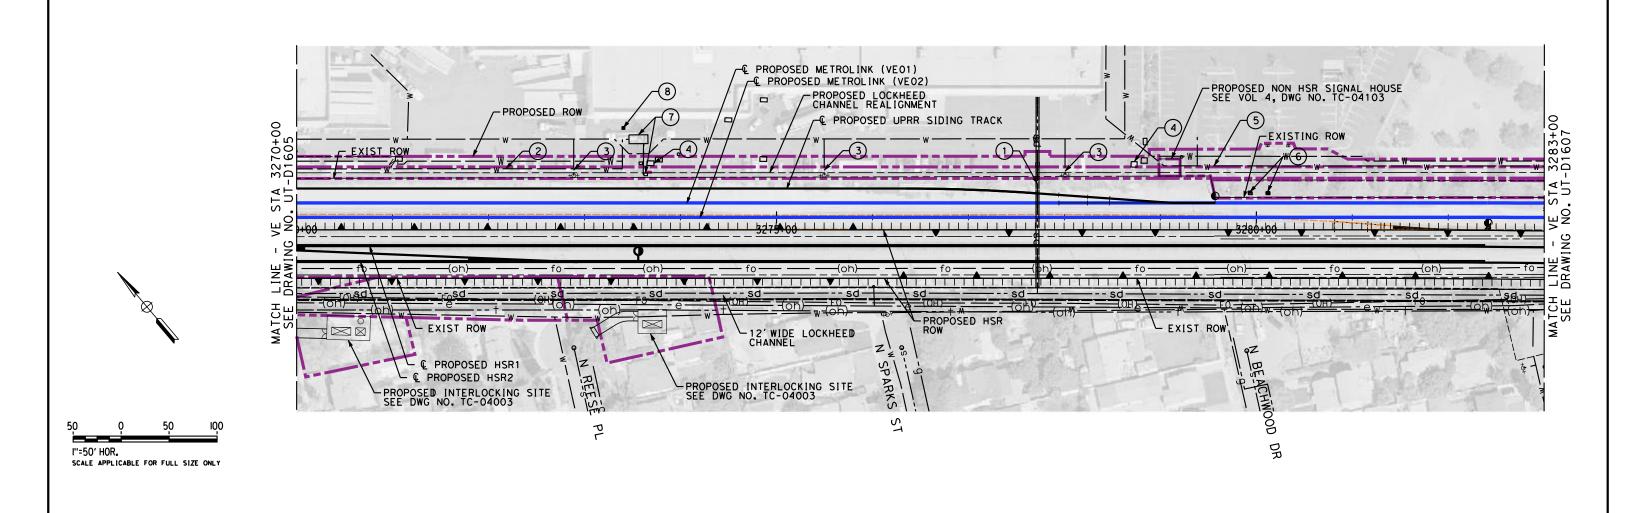


#### CALIFORNIA HIGH-SPEED TRAIN PROJECT BURBANK TO LOS ANGELES

OPTION B REVISED ALIGNMENT - REVISED FINAL PEPD

COMPOSITE UTILITIES PLAN VEO1, VEO2 3270+00

HSR14-39	
DRAWING NO.	
UT-C1705	
SCALE	
AS SHOWN	
SHEET NO.	



	TYPE OF UTILITY	SIZE/MATERIAL	LOCATION	OWNER	DISPOSITION
1	STORM DRAIN	36" RCP	STA 3277+72	TBD	JOIN REALIGNED CHANNEL
2	RAW WATER	12" HDPE WATER LINE	STA 3270+00 TO 3273+40	SF VAL BUR. OPER. UN.	RELOCATE
3	WATER	WATER LINE FIXTURES	STA 3272+89 TO 3278+01	TBD	RELOCATE
4	ELECTRICAL	UNDERGROUND ELECTRICAL	STA 3273+65 TO 3278+76	CITY OF BURBANK	RELOCATE
5	WATER	8" DI WATER LINE	STA 3278+84 TO 3283+00	TBD	RELOCATE
6	WELLS	OBSERVATION WELLS B-1-CW11/12	STA 3279+93 TO 3280+12	SF VAL BUR. OPER. UN.	RELOCATE
7	EXTRACTION WELL VO1	WELLS & RELATED INFRA.	STA 3273+37 TO 3273+66	SF VAL BUR. OPER. UN.	PROTECT-IN-PLACE WELLS/ RELOCATE RELATED INFRA.
8	WELLS	OBSERVATION WELLS OW-VO1A/B-R	STA 3273+40	SF VAL BUR. OPER. UN.	PROTECT-IN-PLACE

REFER TO LOCKHEED CHANNEL RELOCATION DWG. NOT FOR CONSTRUCTION NO. CV-G1301 TO CV-G1308 FOR PROPOSED DESIGN FOR INTERNAL USE ONLY

### CALIFORNIA HIGH-SPEED TRAIN PROJECT BURBANK TO LOS ANGELES

OPTION B REVISED ALIGNMENT - REVISED FINAL PEPD COMPOSITE UTILITIES PLAN VEO1, VEO2 3270+00 TO VEO1, VEO2 3283+00

HSR14-39	
DRAWING NO.	
UT-C1706	
SCALE	
AS SHOWN	
SHEET NO.	


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						DRAWN BY C. CUSSON	F
						CHECKED BY M. REIFER	•
						IN CHARGE C. LEE	C
REV	DATE	BY	СНК	APP	DESCRIPTION	07/15/2021	

PEPD
RECORD SET

NOT FOR
CONSTRUCTION





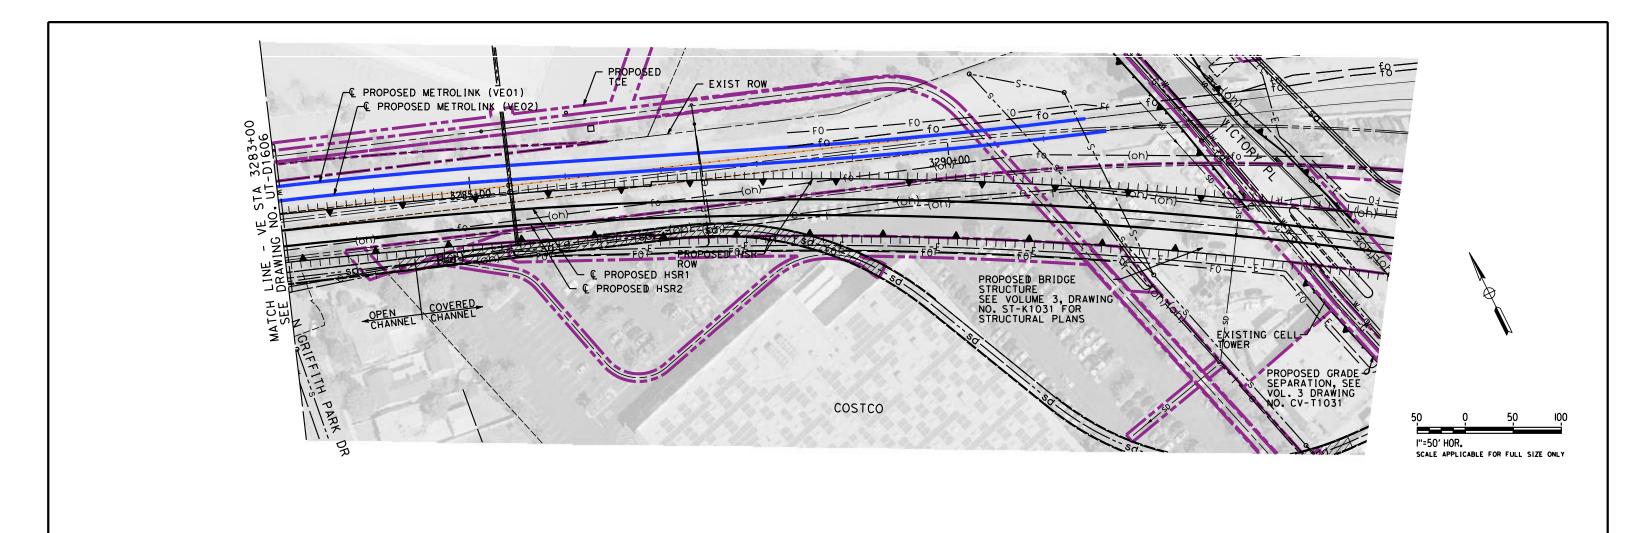

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#### CALIFORNIA HIGH-SPEED TRAIN PROJECT BURBANK TO LOS ANGELES

OPTION B REVISED ALIGNMENT - REVISED FINAL PEPD PROPOSED UTILITIES RELOCATION PLAN

VEO1, VEO2 3283+00 TO VEO1, VEO2 3291+65.95

HSR14-39	
UT-C1707	
AS SHOWN	
SHEET NO.	

	TYPE OF UTILITY	SIZE/MATERIAL	LOCATION	OWNER	DISPOSITION
(-)	SEWER	24" VCP	UPRR-1 2+94.41	CITY OF LOS ANGELES	ENCASE
2	SEWER	54" CONCRETE PIPE	UPRR-1 2+70.62	CITY OF LOS ANGELES	ENCASE
3	SEWER	12" VCP	UPRR-1 2+72.02	CITY OF LOS ANGELES	PROTECT-IN-PLACE
4	SEWER	24" VCP	UPRR 43+96.22	CITY OF LOS ANGELES	PROTECT-IN-PLACE
(5)	SEWER	8" VCP (ABAN)	STA N/A	CITY OF LOS ANGELES	PROTECT-IN-PLACE
6	STORM DRAIN	27" UNREINFORCED CONCRETE PIPE	UPRR-1 3+18.80	LACFCD	PROTECT-IN-PLACE
7	STORM DRAIN	108" RCP	UPRR 43+55.52	CITY OF LOS ANGELES	ENCASE
(8)	OH ELECTRIC	230 kV	MT01(B) 5+46.28	LADWP	PROTECT-IN-PLACE
9	OIL	10" OIL LINE	UPRR-1 3+18.80	TBD	EXTEND CASING

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							DESIGNED BY R. PETERS	
							DRAWN BY	PEPD
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ږ							M. REIFER	NOT FOR
500							C. LEE	CONSTRUCTION
ő	REV	DATE	BY	СНК	APP	DESCRIPTION	07/15/2021	





#### CALIFORNIA HIGH-SPEED TRAIN PROJECT BURBANK TO LOS ANGELES

OPTION B REVISED ALIGNMENT - REVISED FINAL COMPOSITE UTILITIES PLAN MT01 52+80 TO MT01 40+00

CONTRACT NO. HSR14-39
DRAWING NO.
UT-C1801
01-01001
SCALE
AS SHOWN
K5 51101114
SHEET NO.

	TYPE OF UTILITY	SIZE/MATERIAL	LOCATION	OWNER	DISPOSITION
1	SEWER	54" CONCRETE PIPE	SEE PREVIOUS SHEET	CITY OF LOS ANGELES	PROTECT-IN-PLACE
2	SEWER	24" VCP	MTO1 41+31	CITY OF LOS ANGELES	PROTECT-IN-PLACE
3	OH ELECTRIC	230 kV	MT01 42+03	LADWP	PROTECT-IN-PLACE
4	STORM DRAIN	108" RCP	SEE PREVIOUS SHEET	CITY OF LOS ANGELES	PROTECT-IN-PLACE
(5)	STORM DRAIN	96" CHANNEL	MTO1(B) 8+24	LACFCD	PROTECT-IN-PLACE
6	OIL	8" ABAN CONC SLURRY	MTO1(B) 8+79	MOBIL	REMOVE
7	OH ELECTRIC	230 kV	MTO1(B) 8+69	LADWP	PROTECT-IN-PLACE
8	STORM DRAIN	72" RCP	MTO1(B) 8+24	CITY OF LOS ANGELES	PROTECT-IN-PLACE
9	OIL	8" ABAN CONC SLURRY	MTO1(B) 9+46	MOBIL	REMOVE

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						DESIGNED BY  R. PETERS	
						DRAWN BY C. CUSSON	R
						CHECKED BY M. REIFER	
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REV	DATE	ВΥ	СНК	APP	DESCRIPTION	DATE 07/15/2021	

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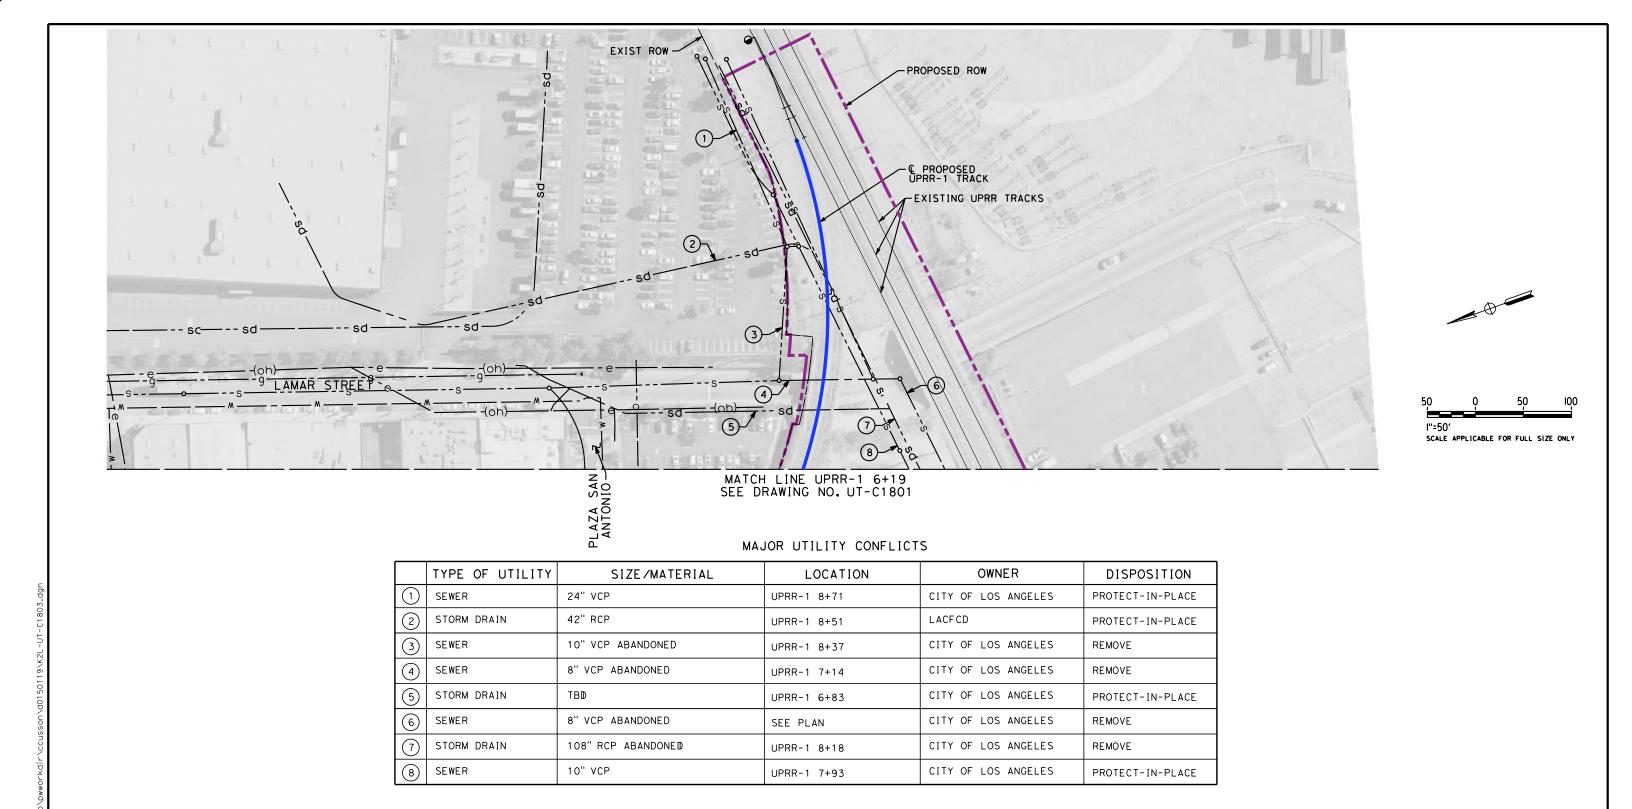


#### CALIFORNIA HIGH-SPEED TRAIN PROJECT BURBANK TO LOS ANGELES

OPTION B REVISED ALIGNMENT - REVISED FINAL PEPD

COMPOSITE UTILITIES PLAN
MT01 40+00 TO MT01 35+27

ONTRACT NO. HSR14-39	
RAWING NO.	
UT-C1802	
CALE	
AS SHOWN	
HEET NO.	



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						DRAWN BY C. CUSSON CHECKED BY	Ri
						M. REIFER IN CHARGE C. LEE	co
REV	DATE	ВΥ	СНК	APP	DESCRIPTION	DATE 07/15/2021	

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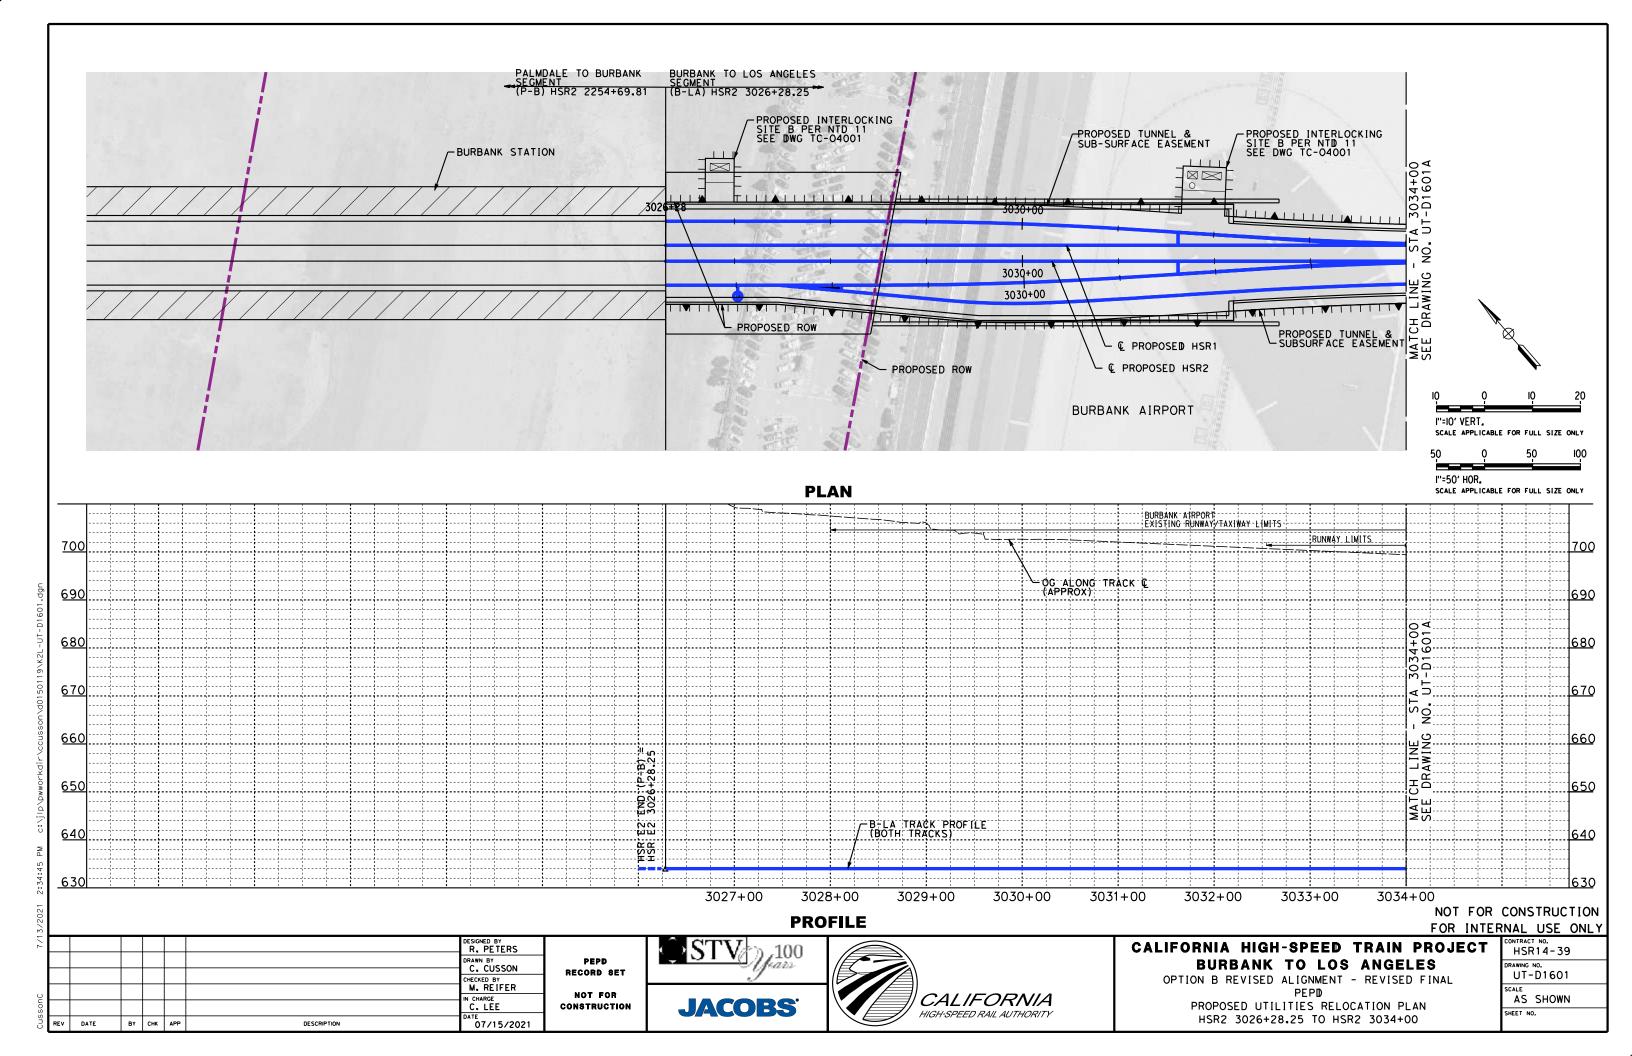
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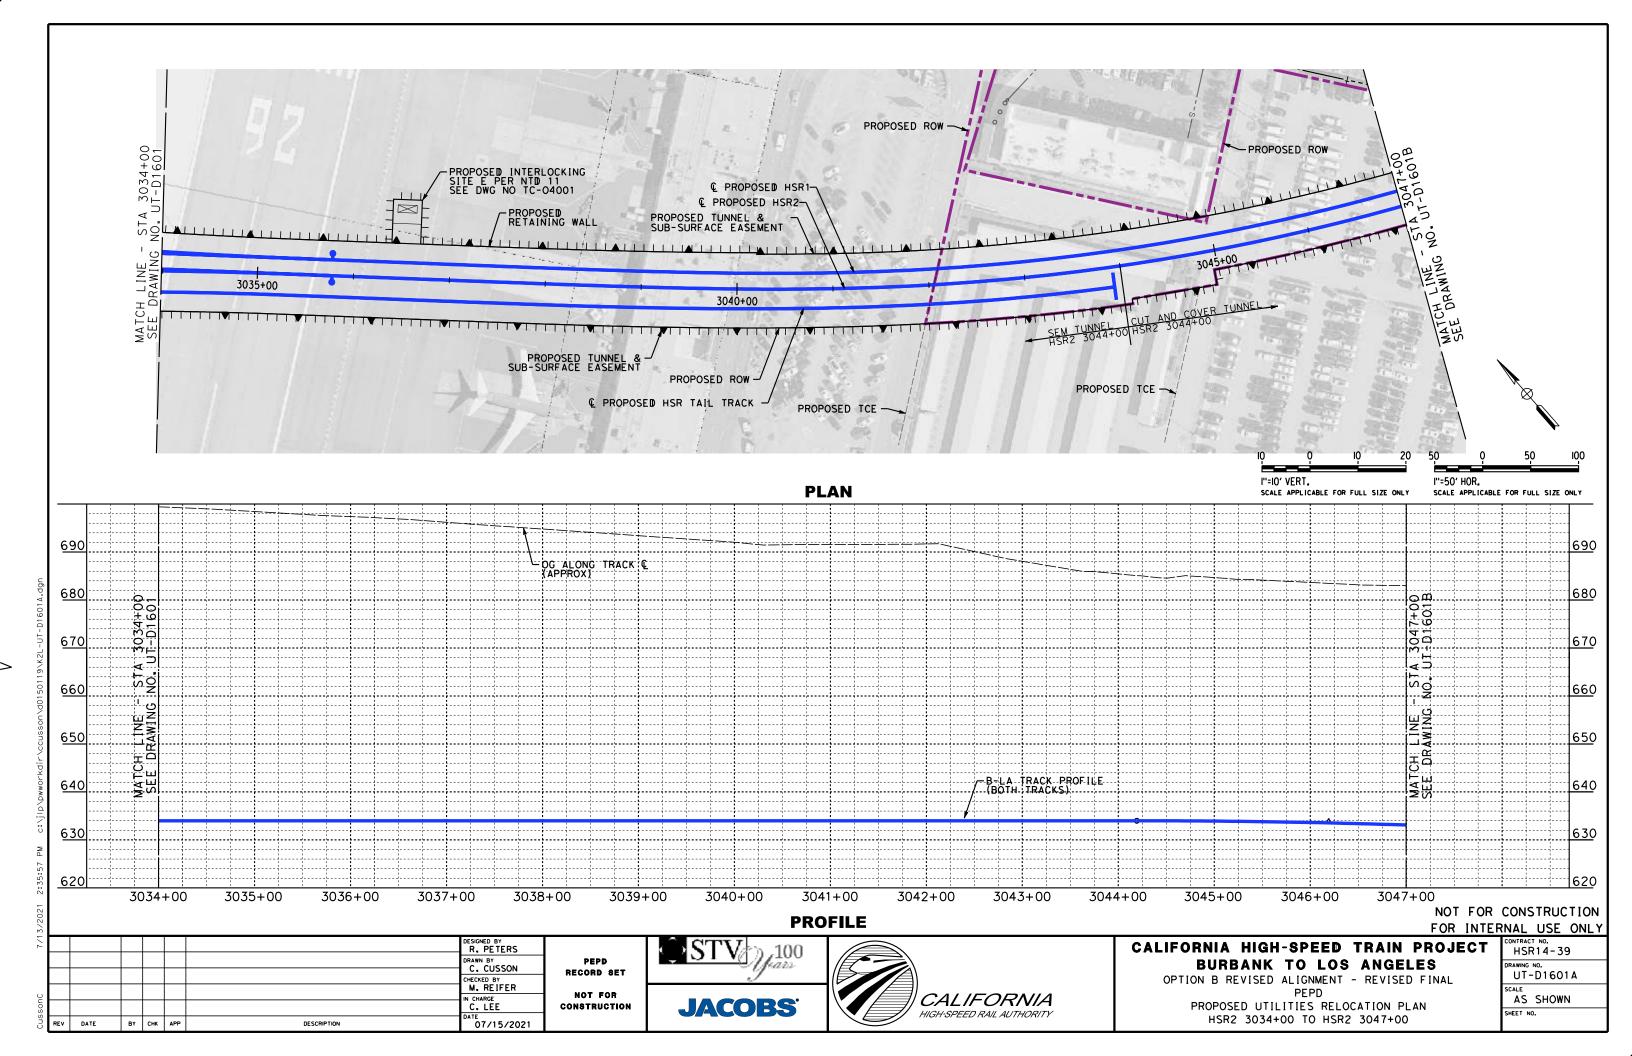
OPTION B REVISED ALIGNMENT - REVISED FINAL PEPD


COMPOSITE UTILITIES PLAN


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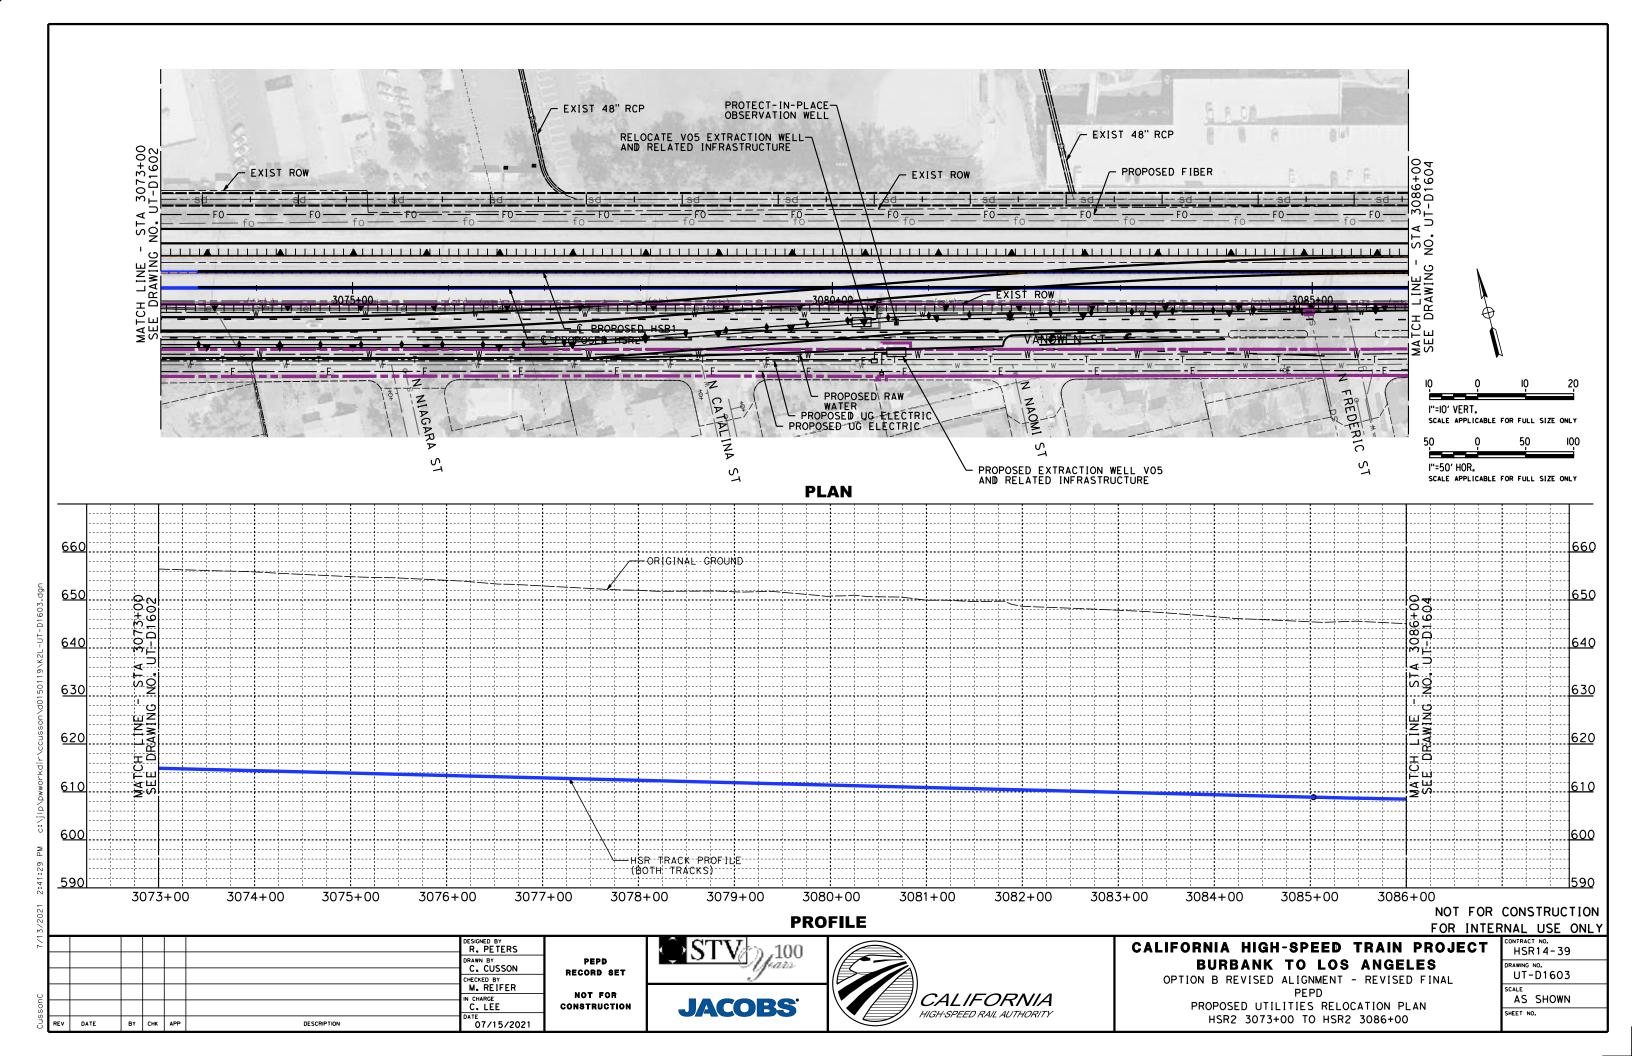
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AS SHOWN					
SHEET NO.					










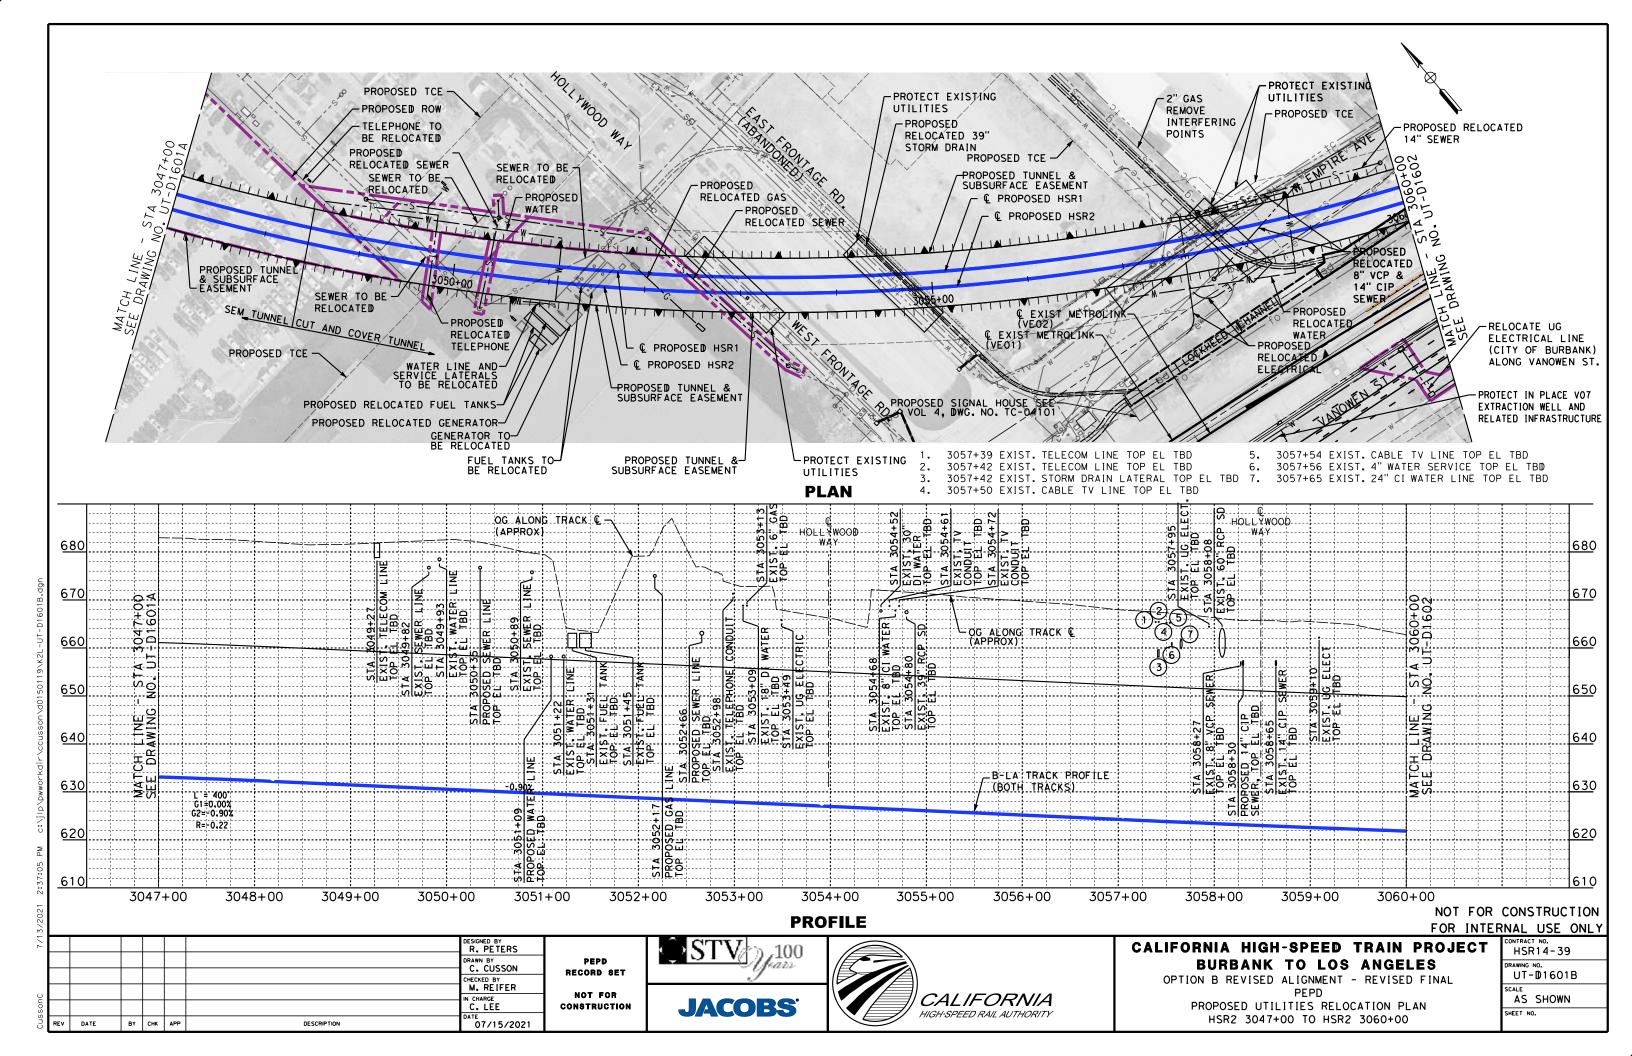


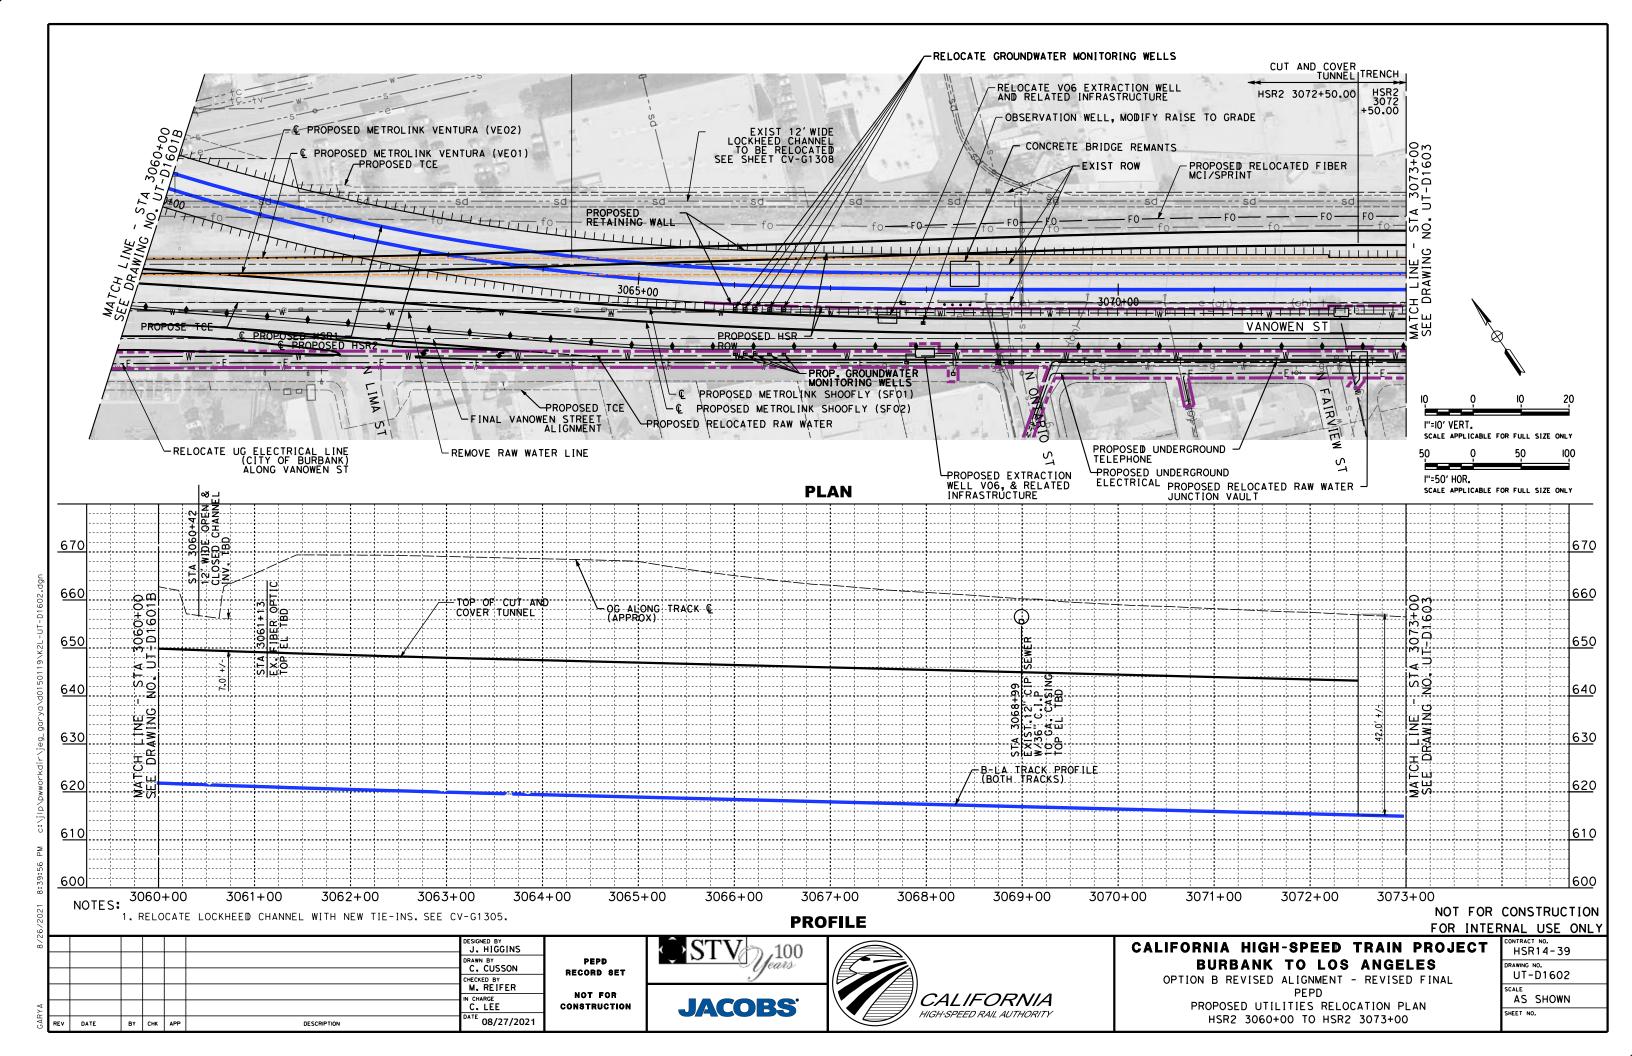


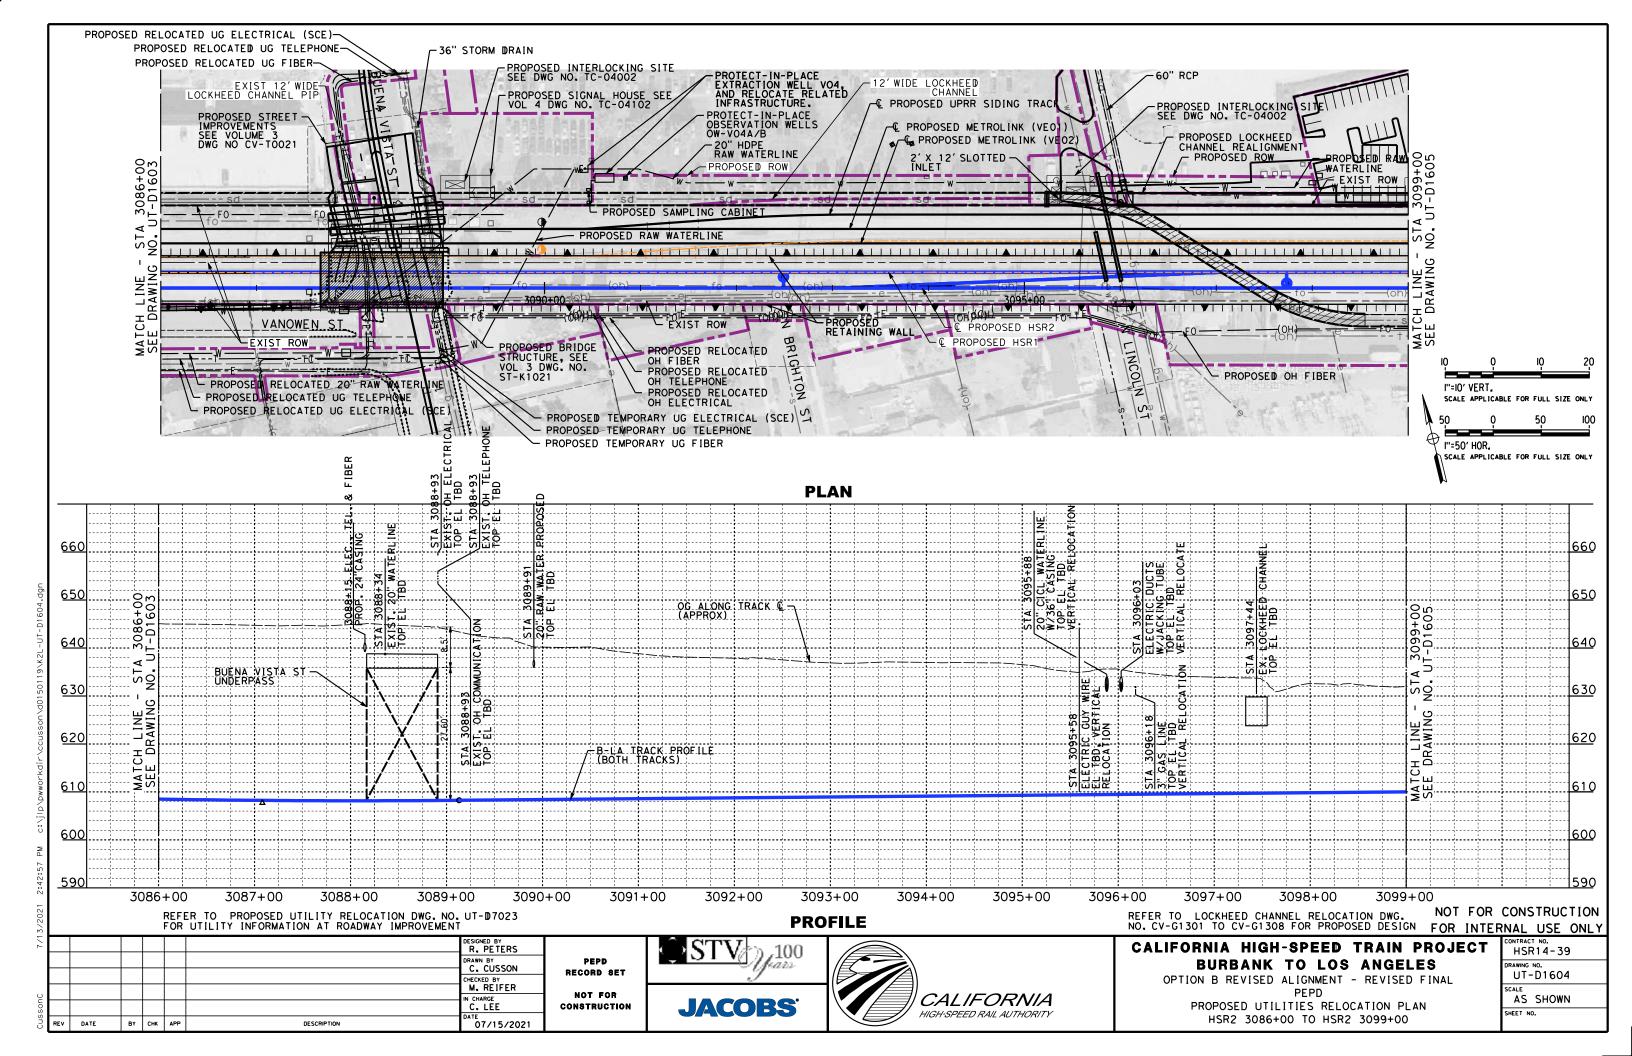


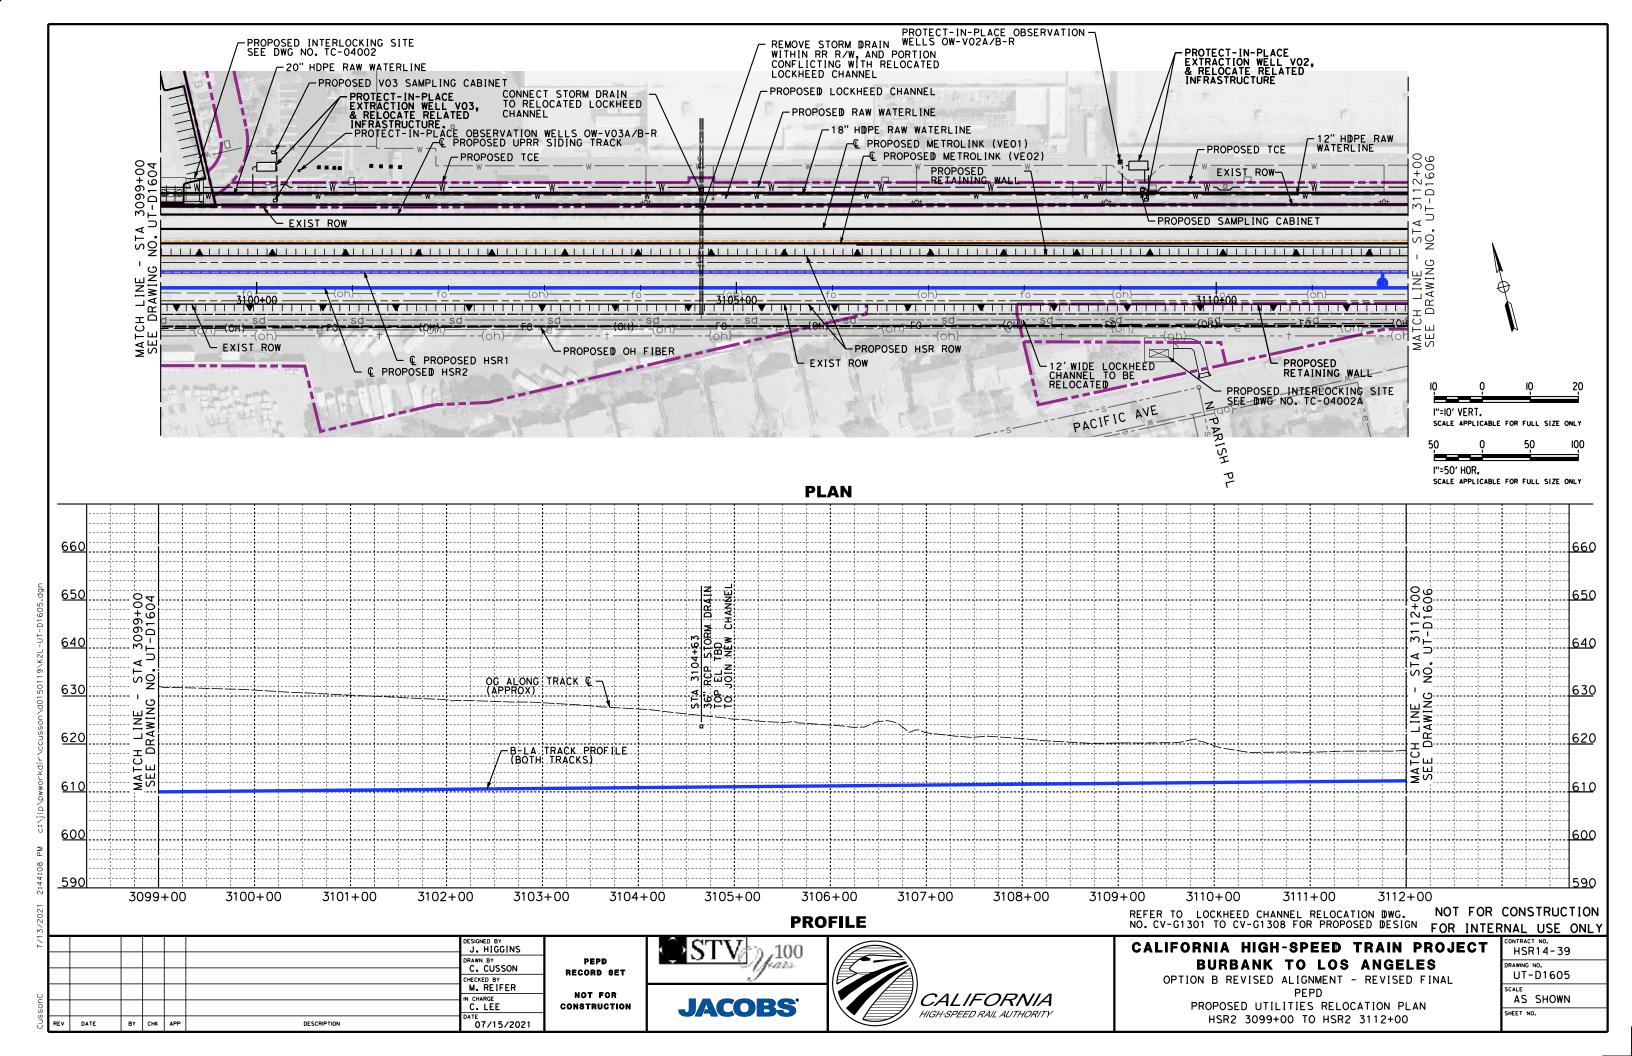


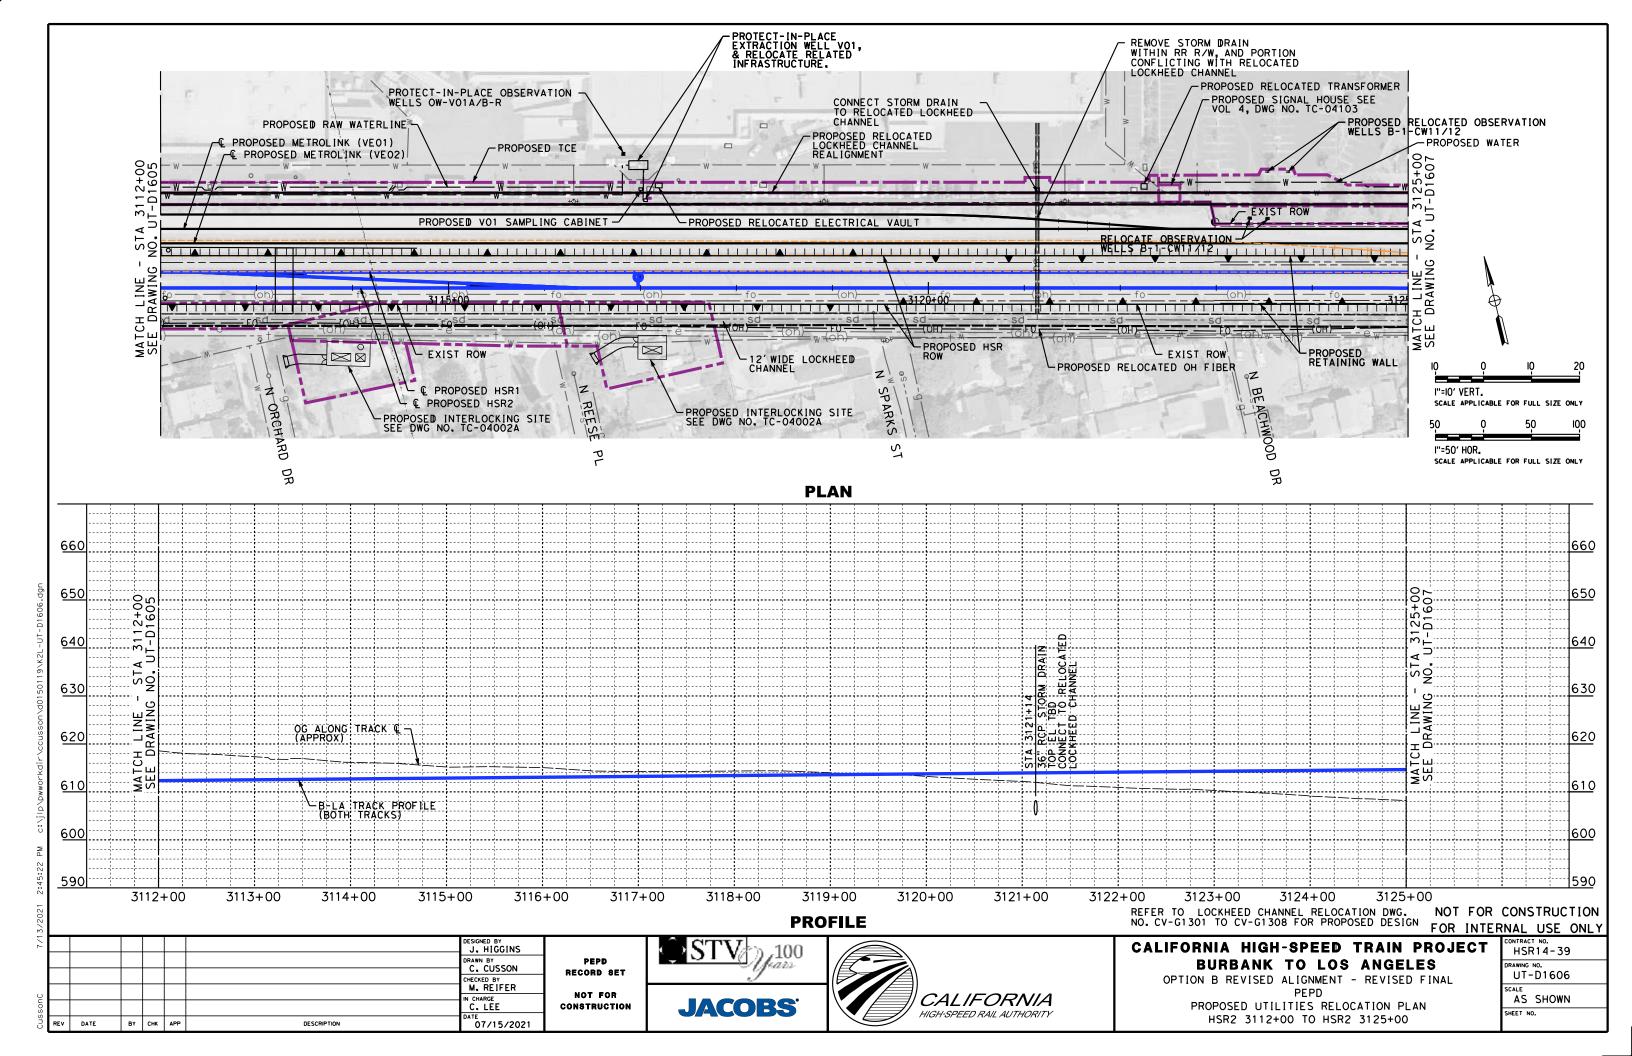


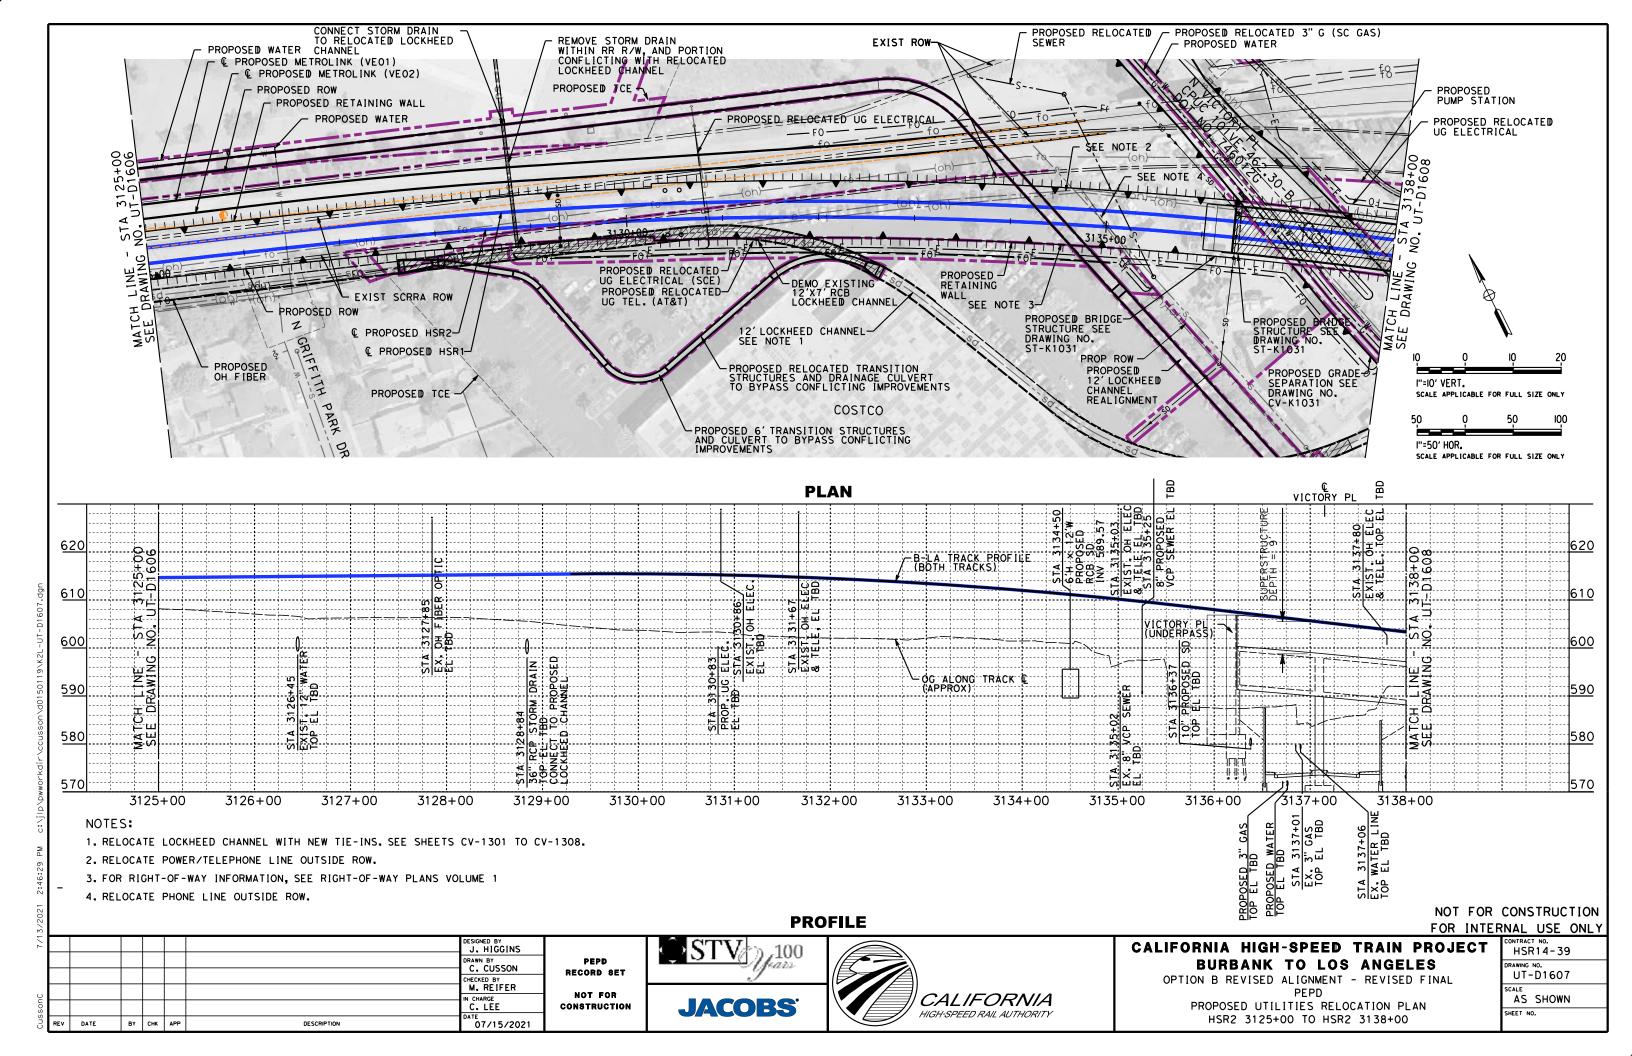


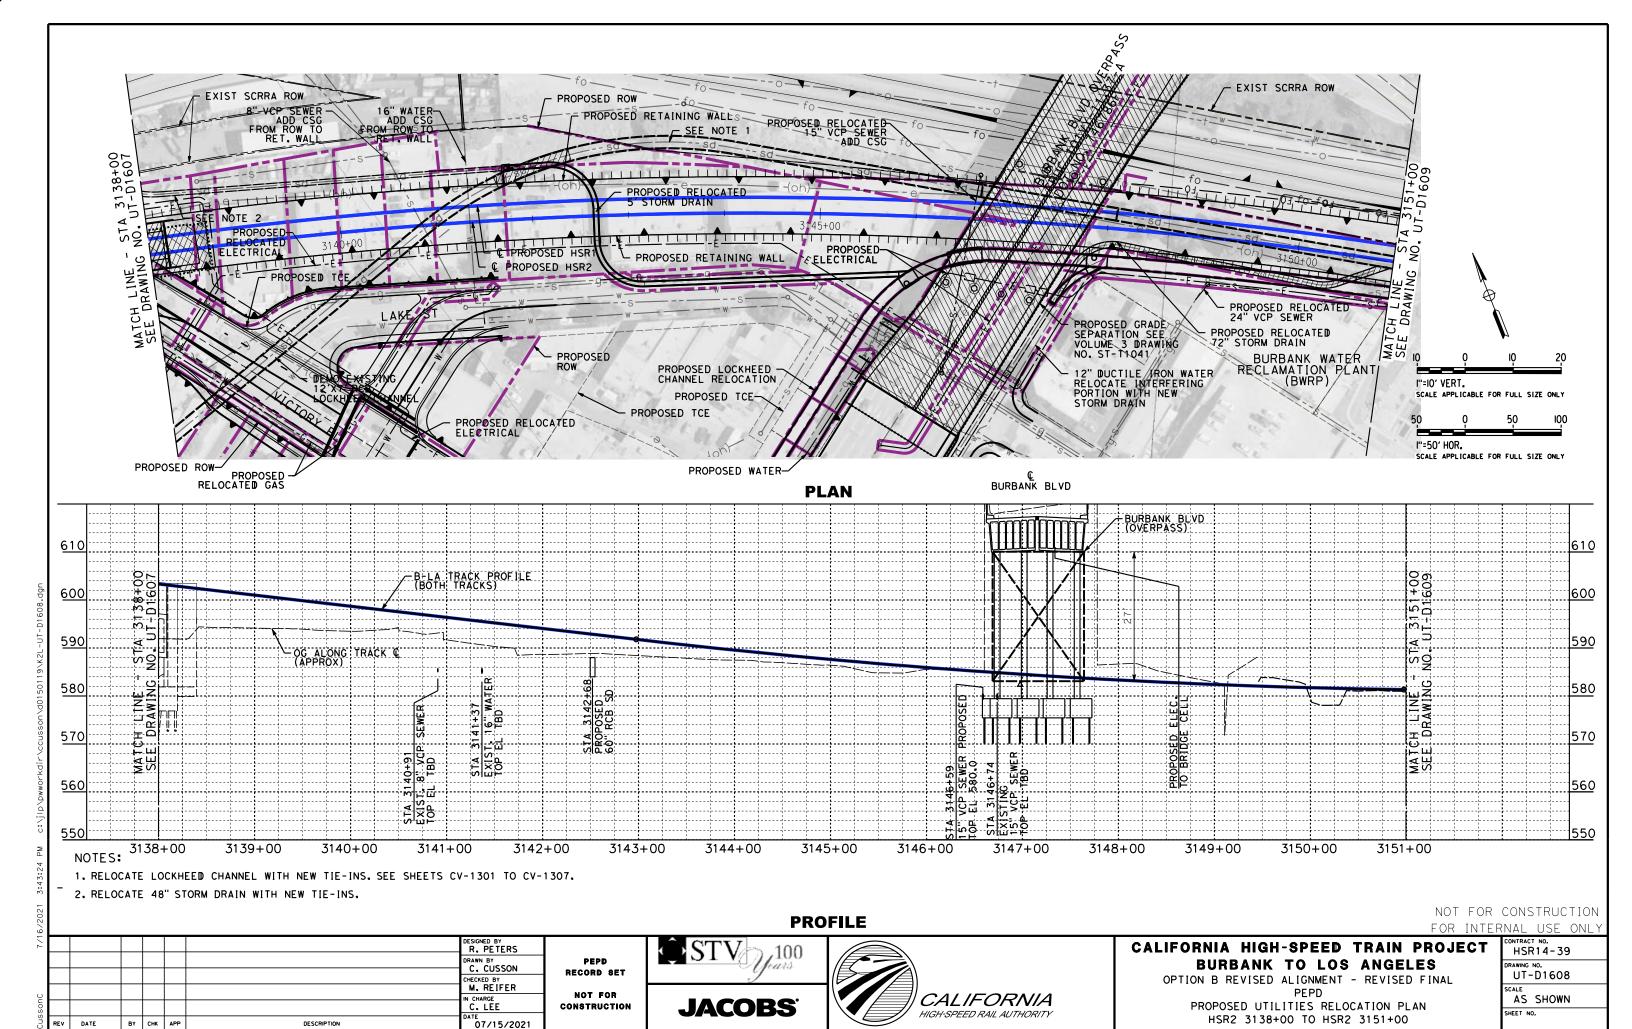


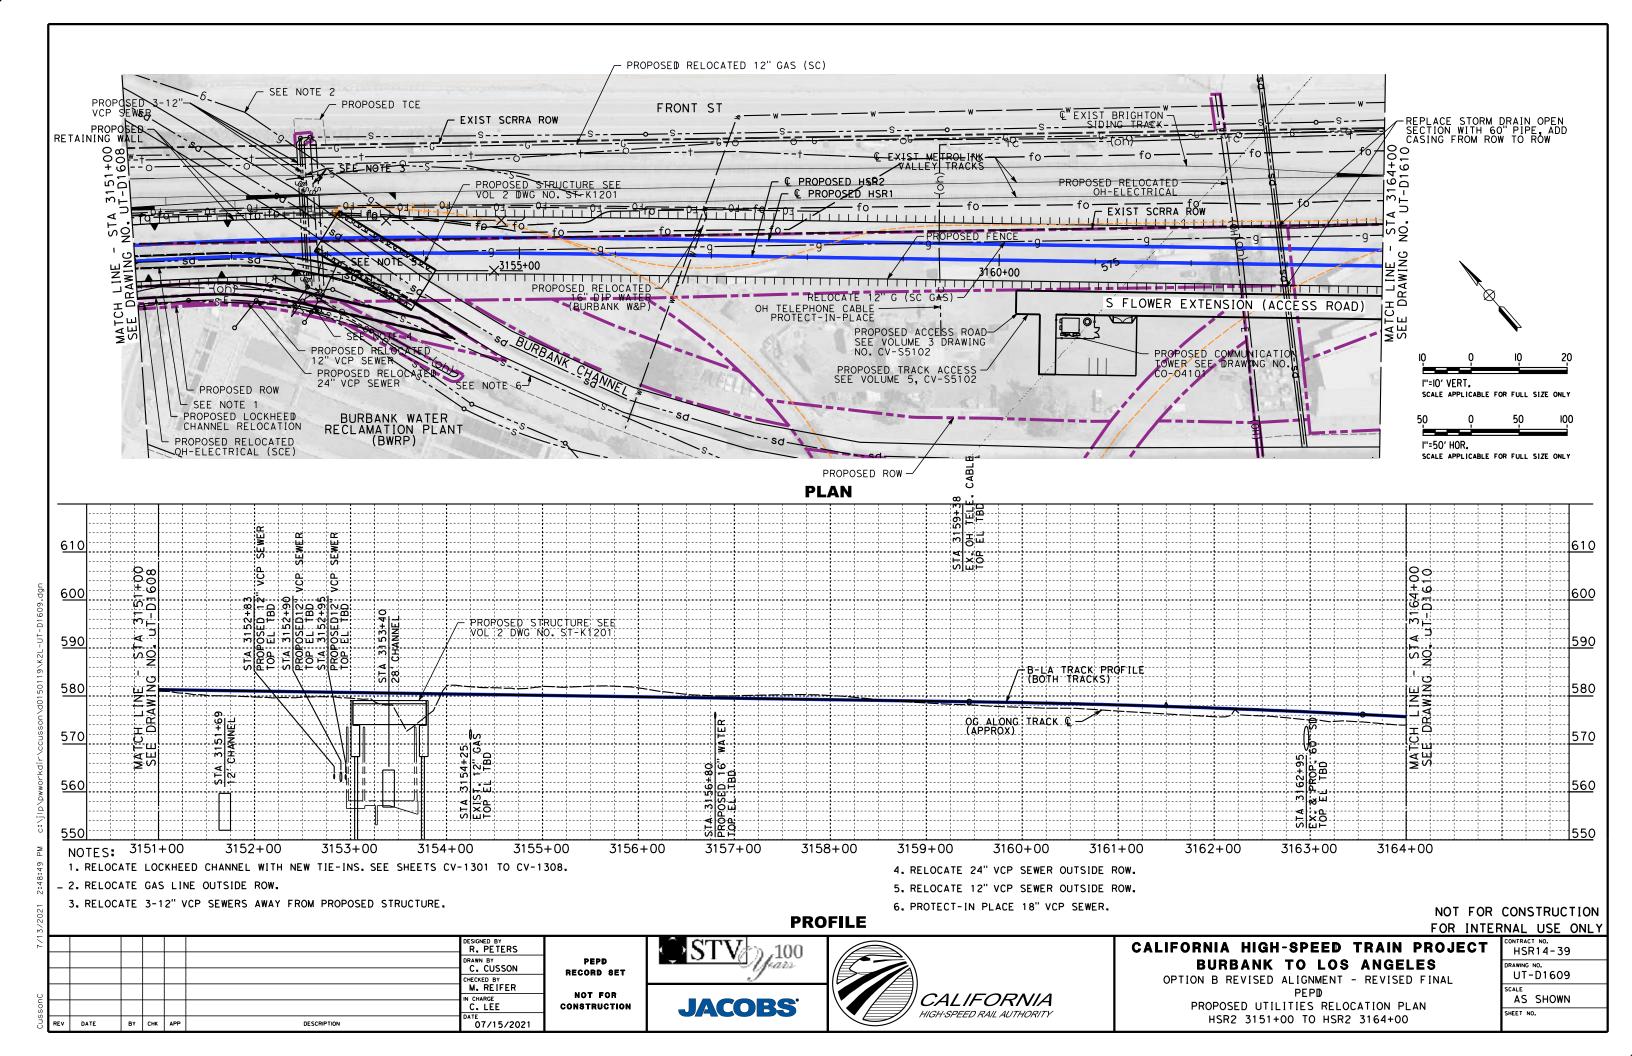


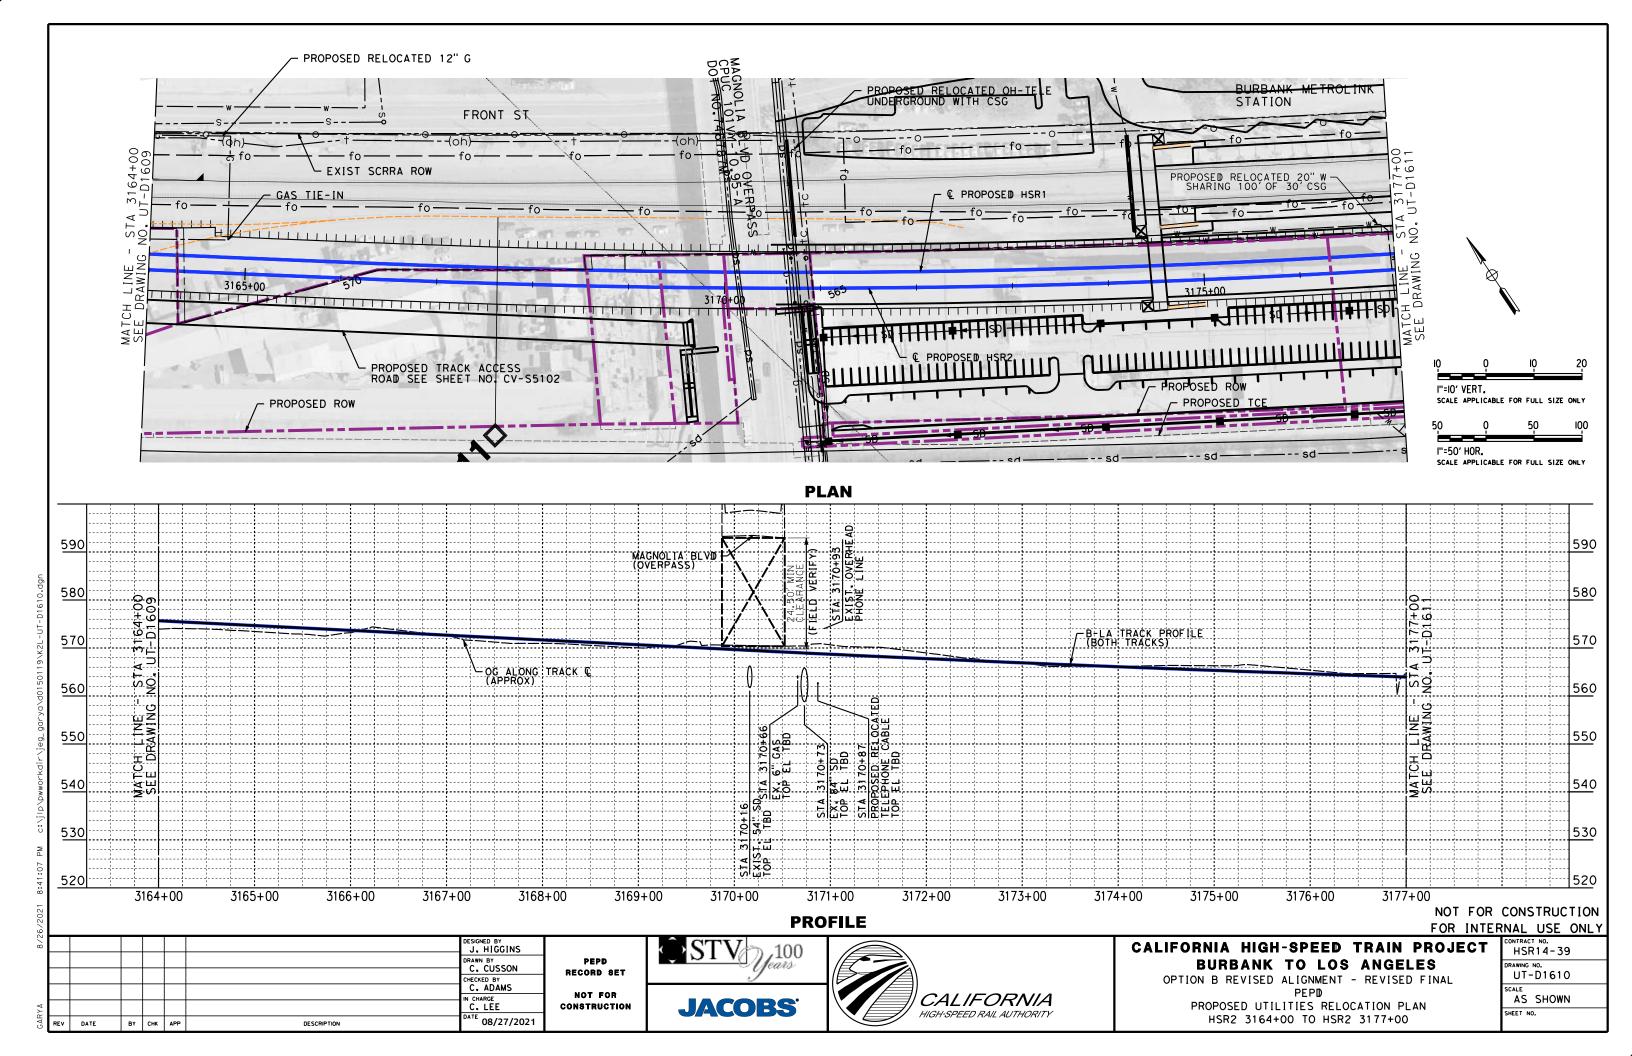


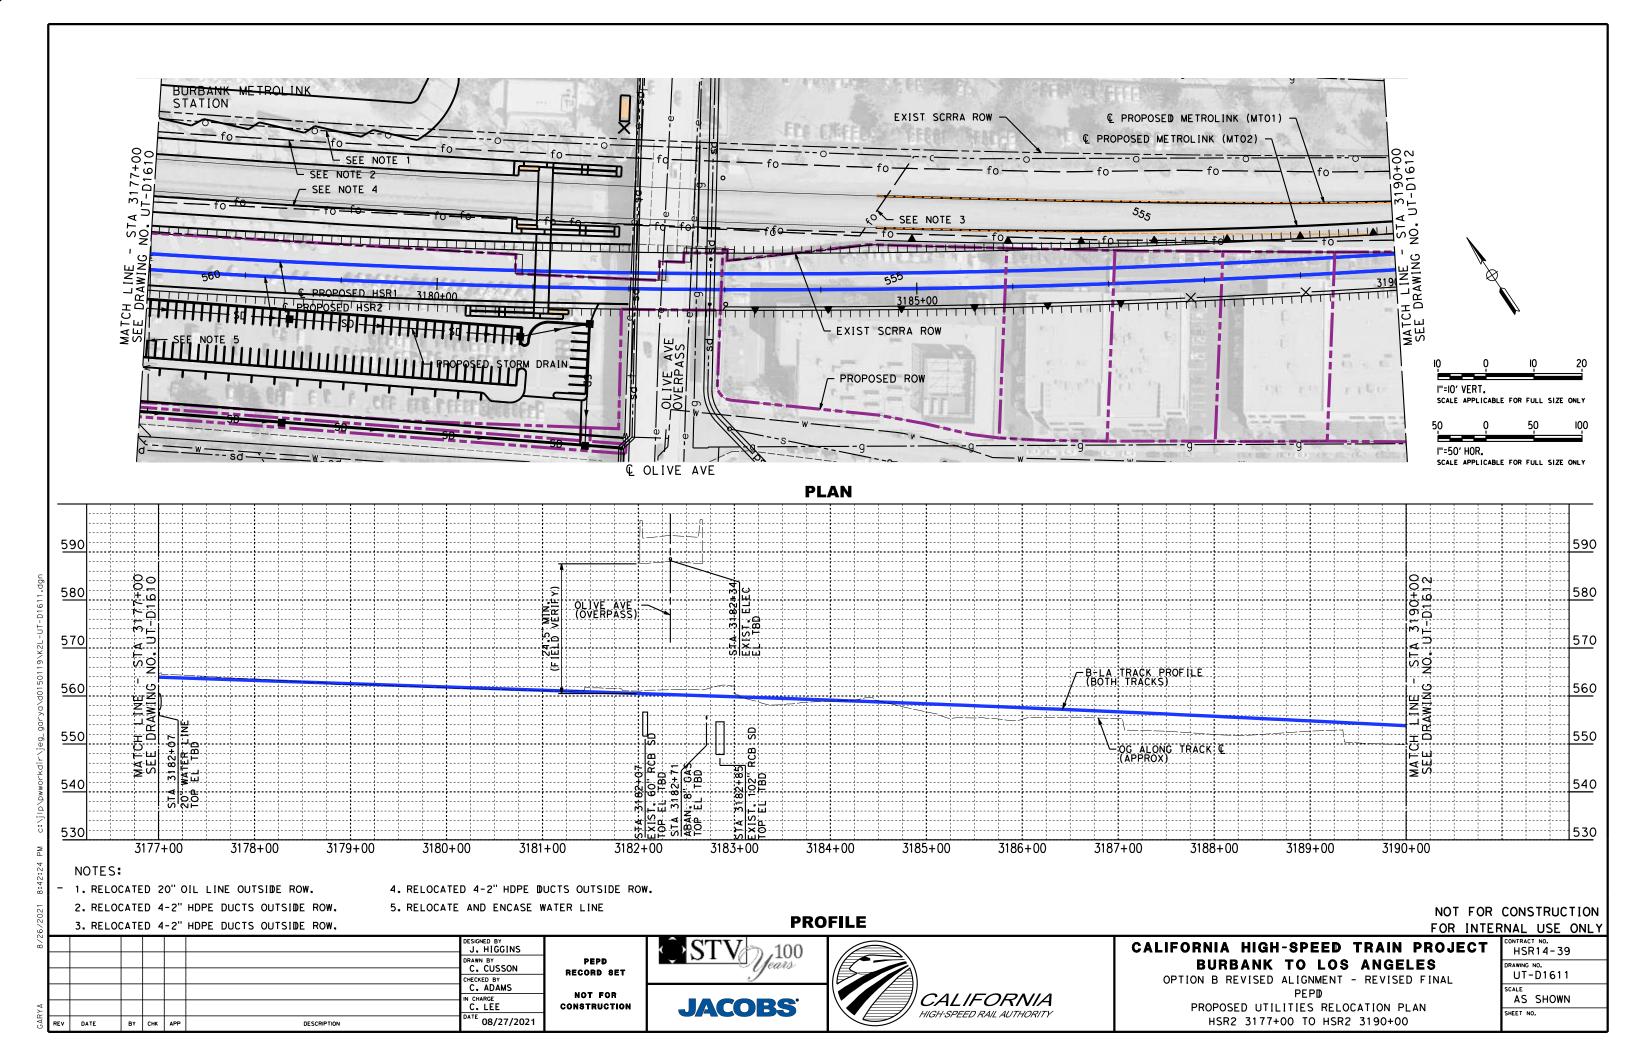


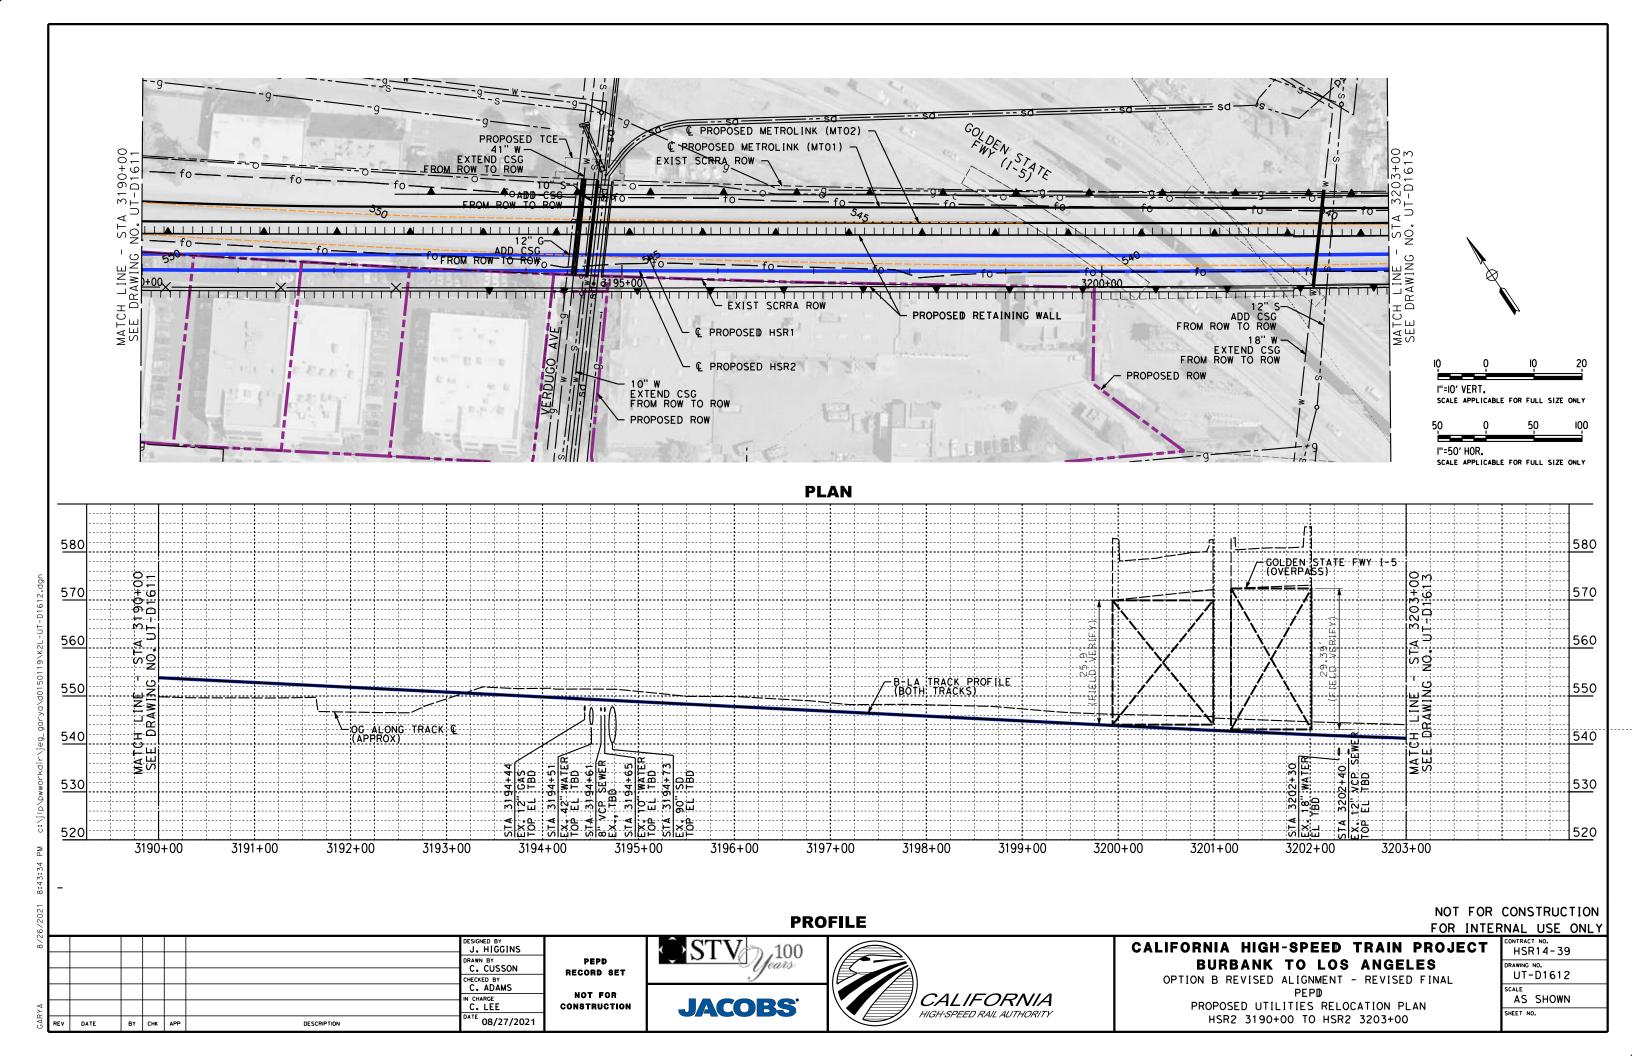


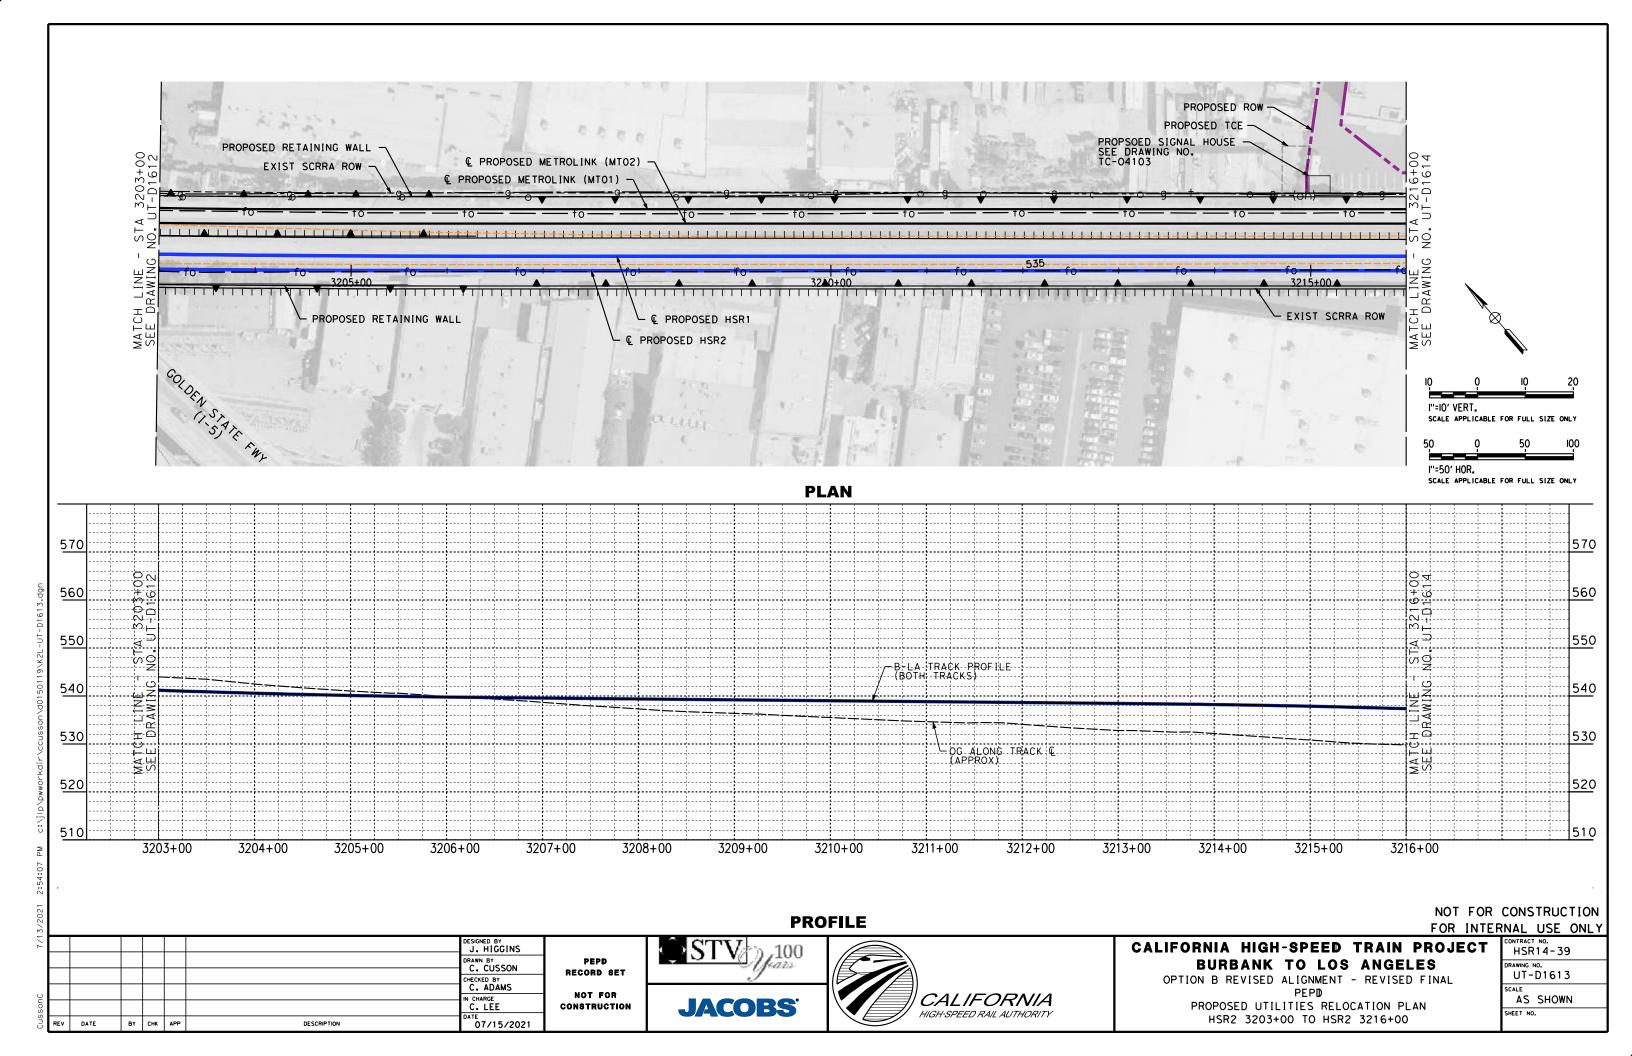


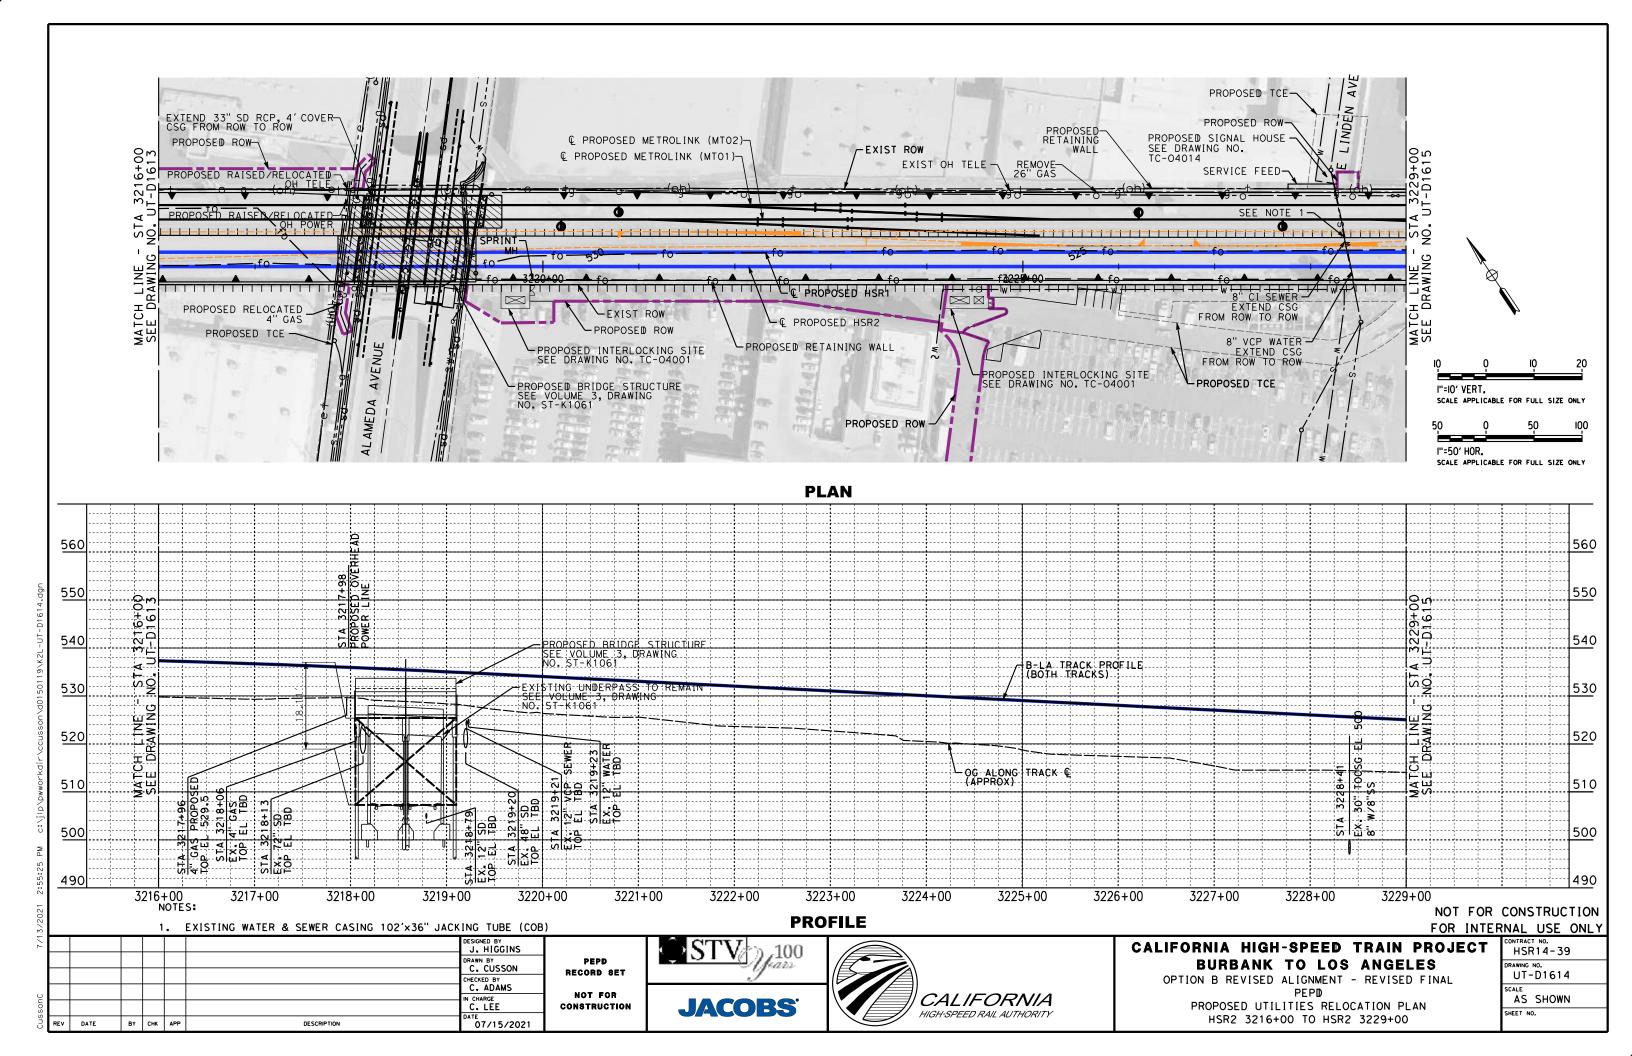


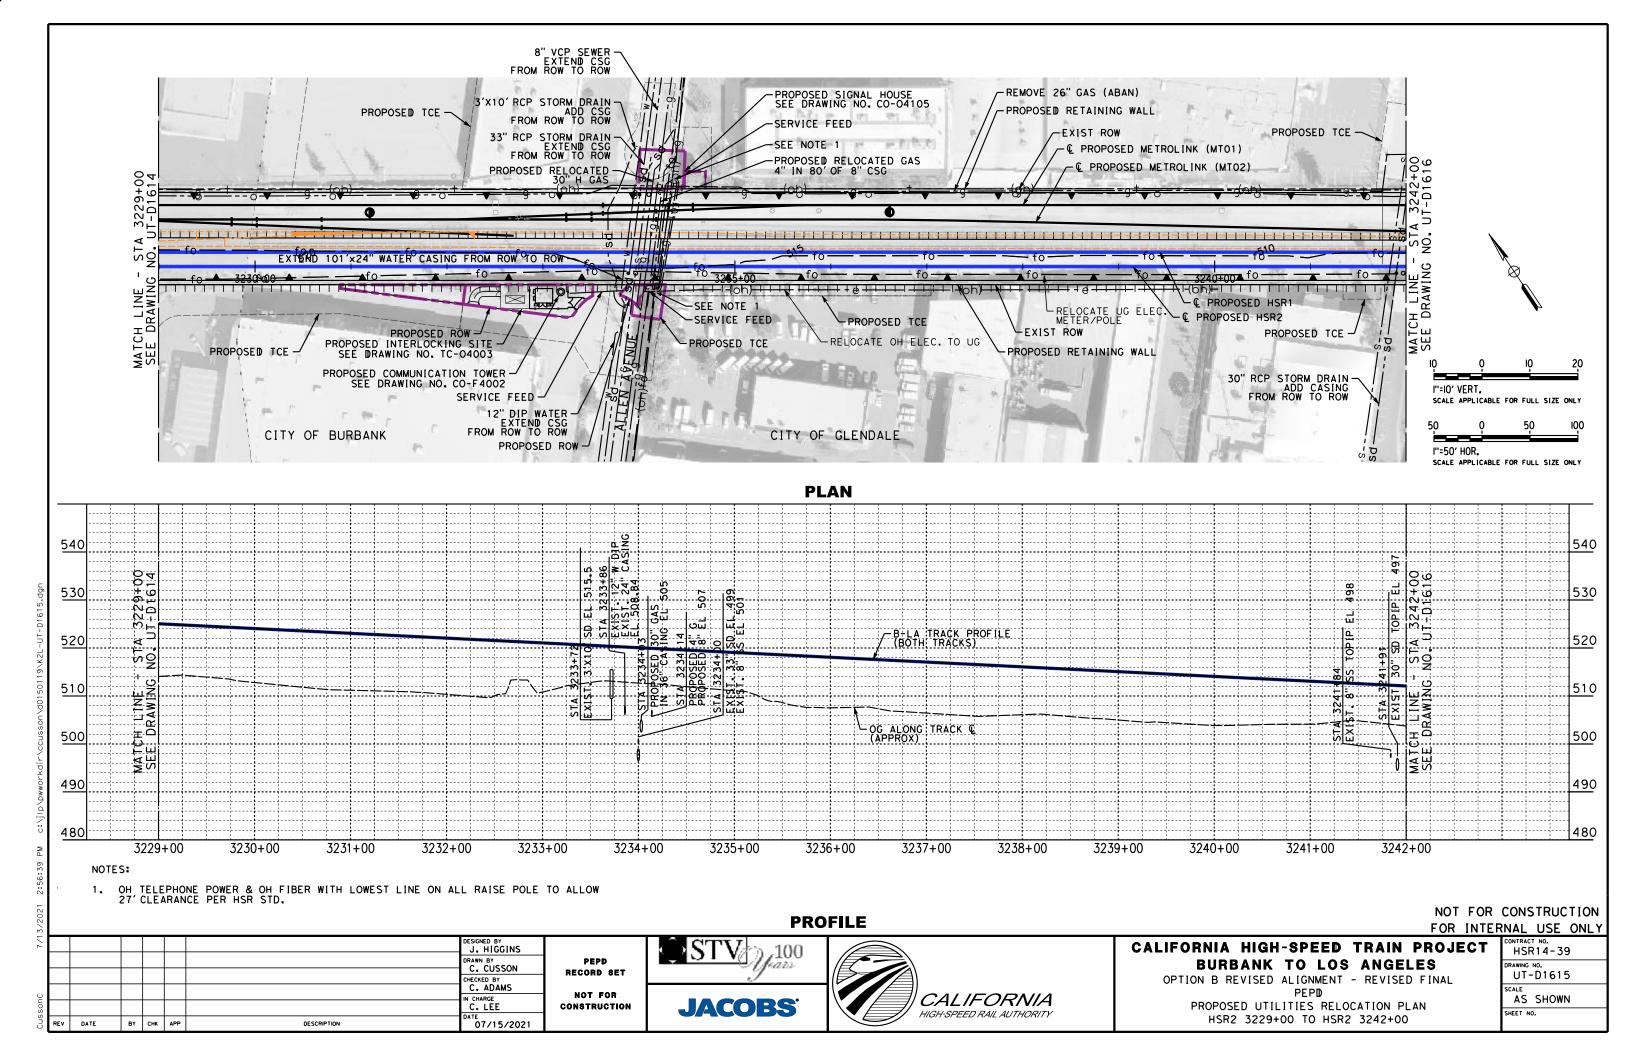


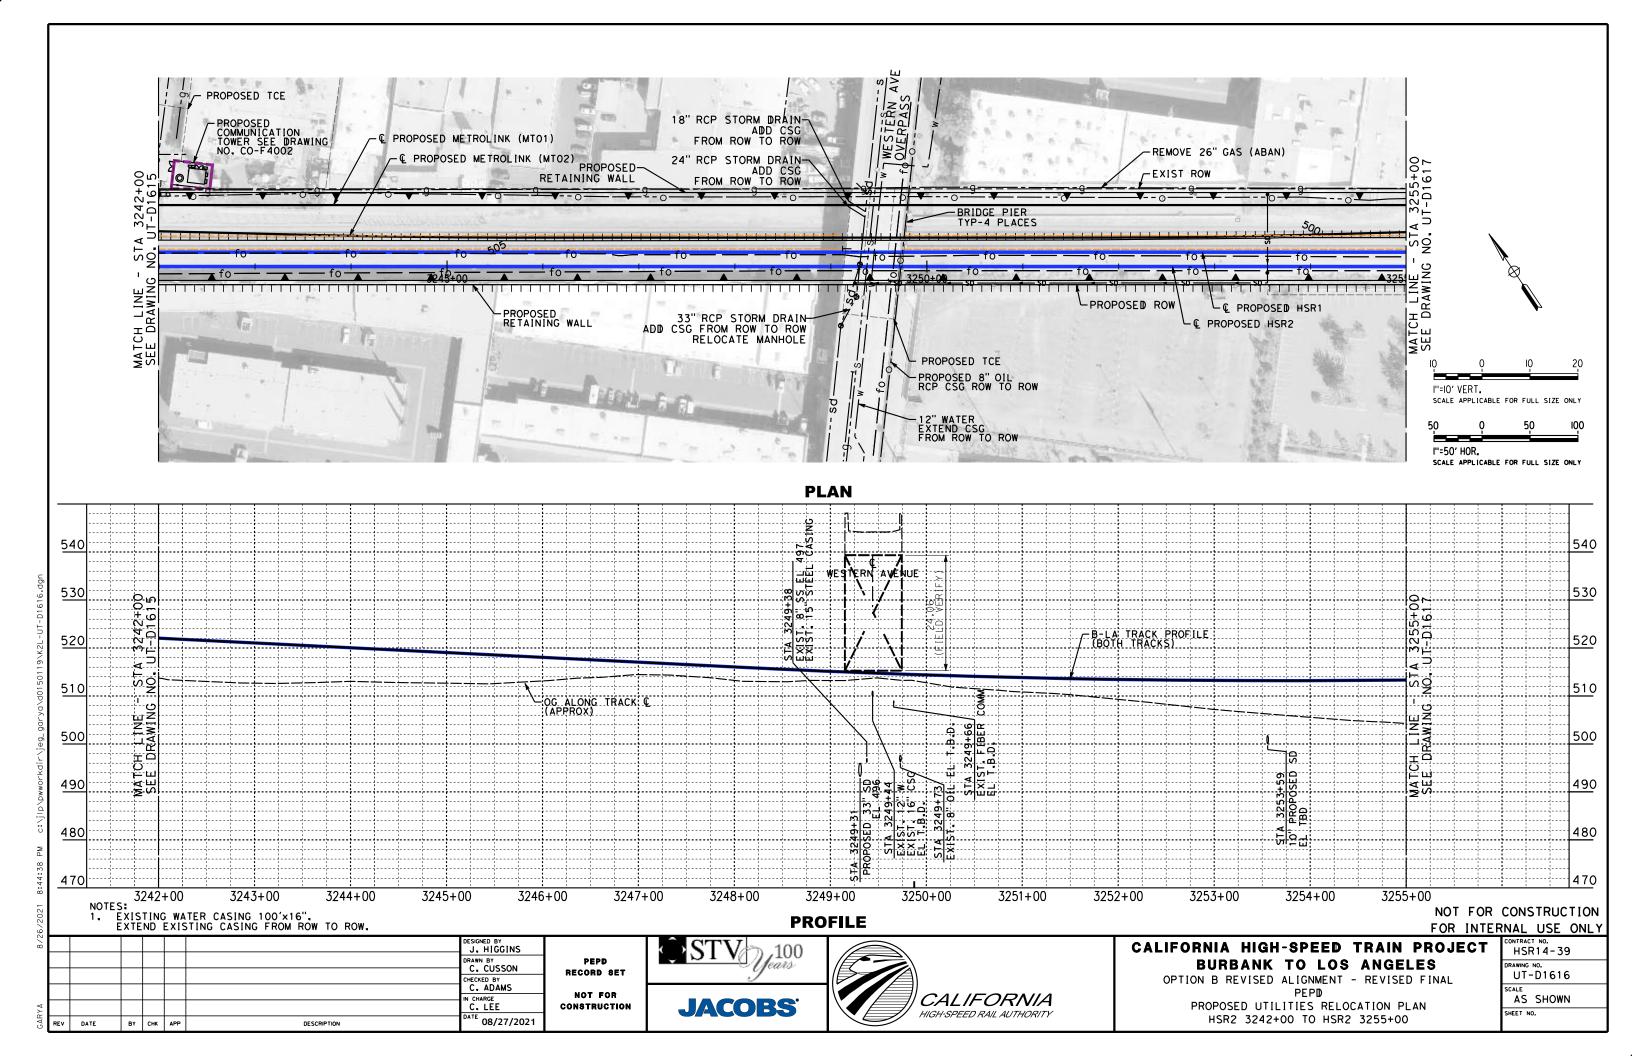


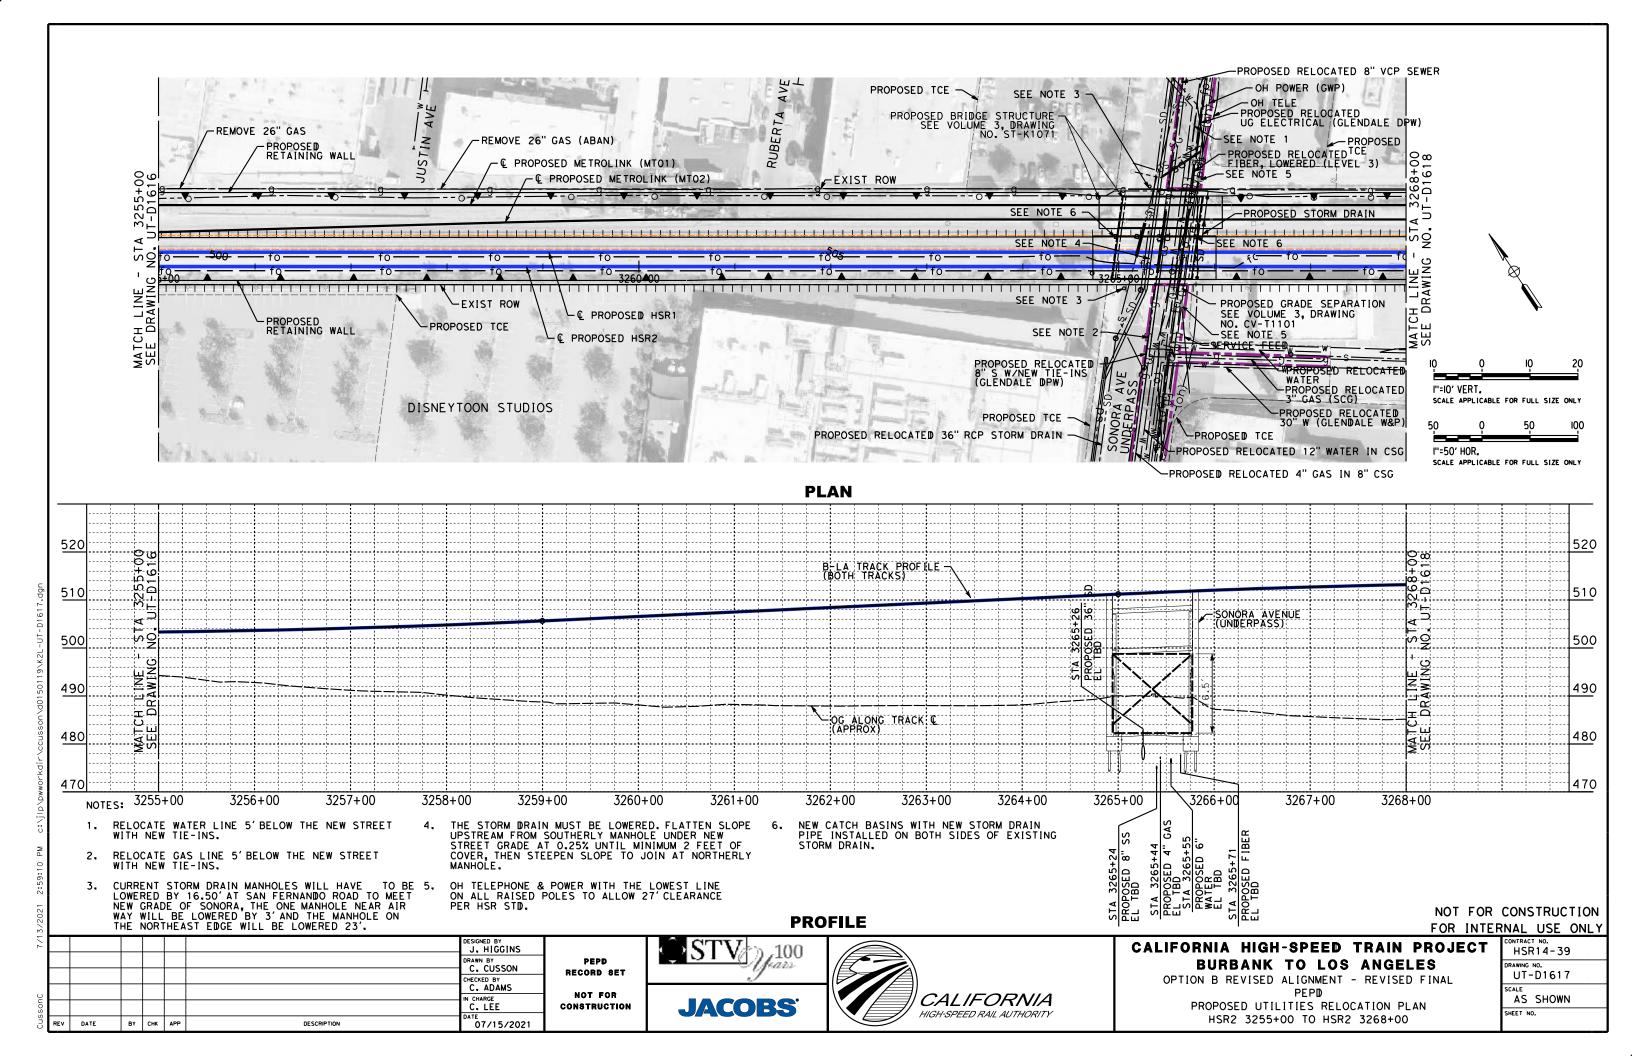


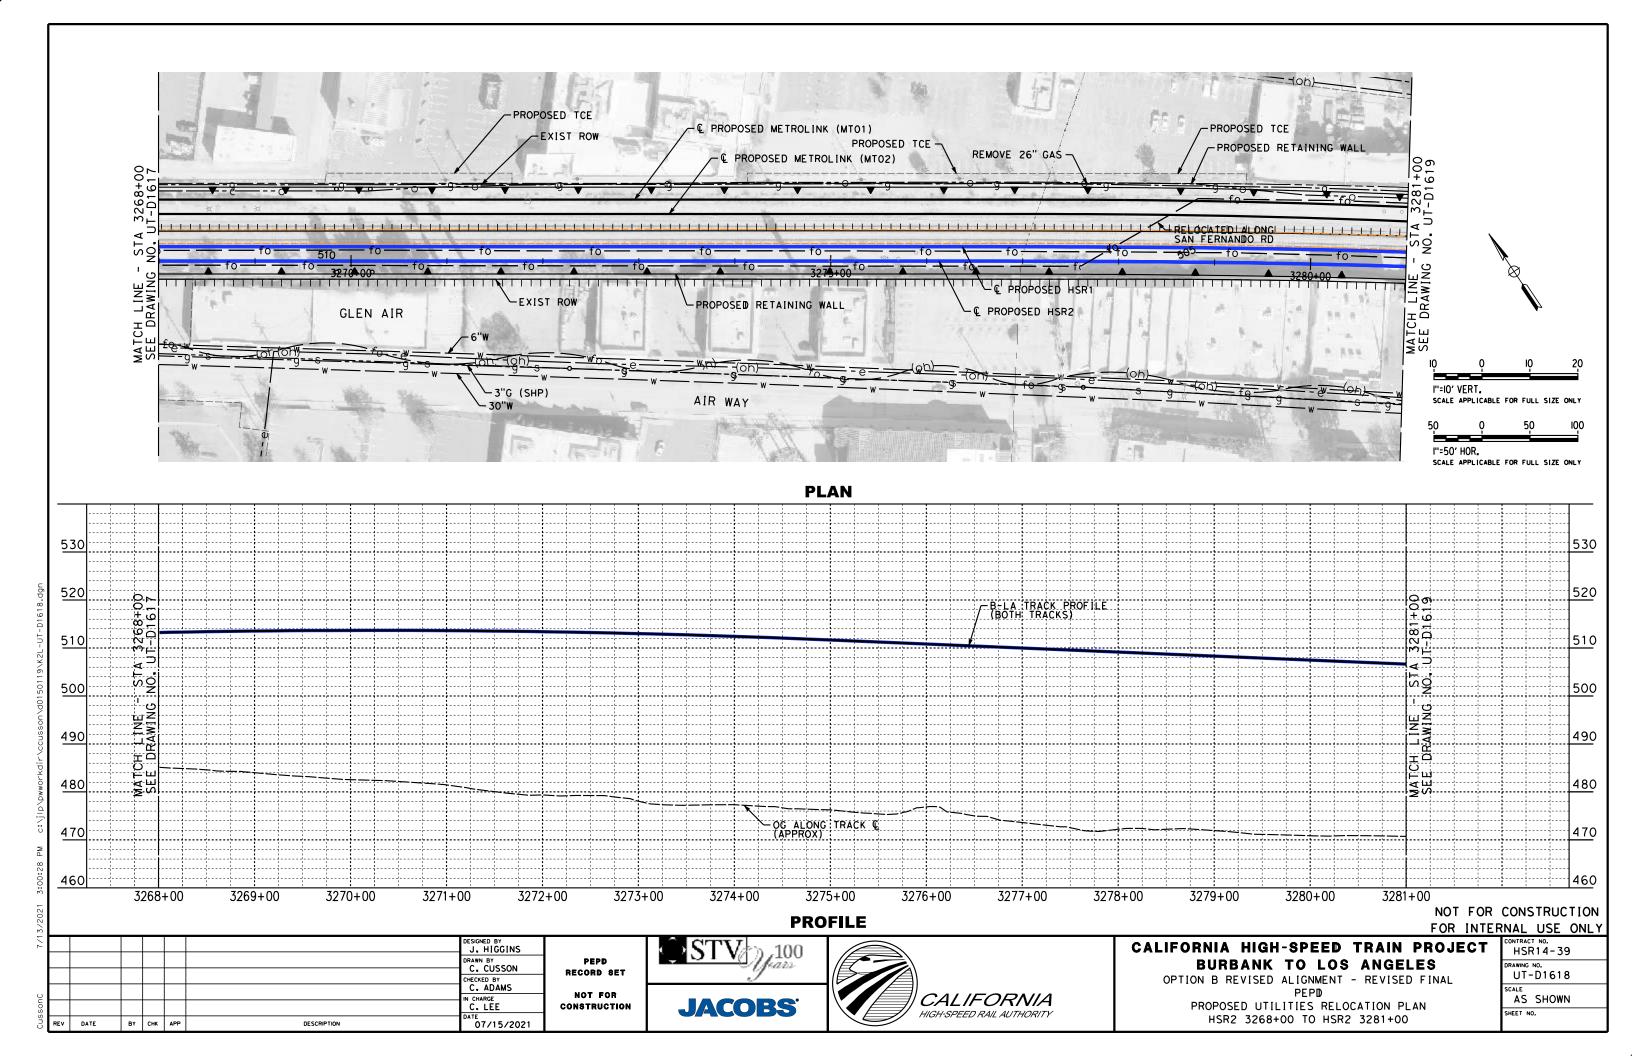


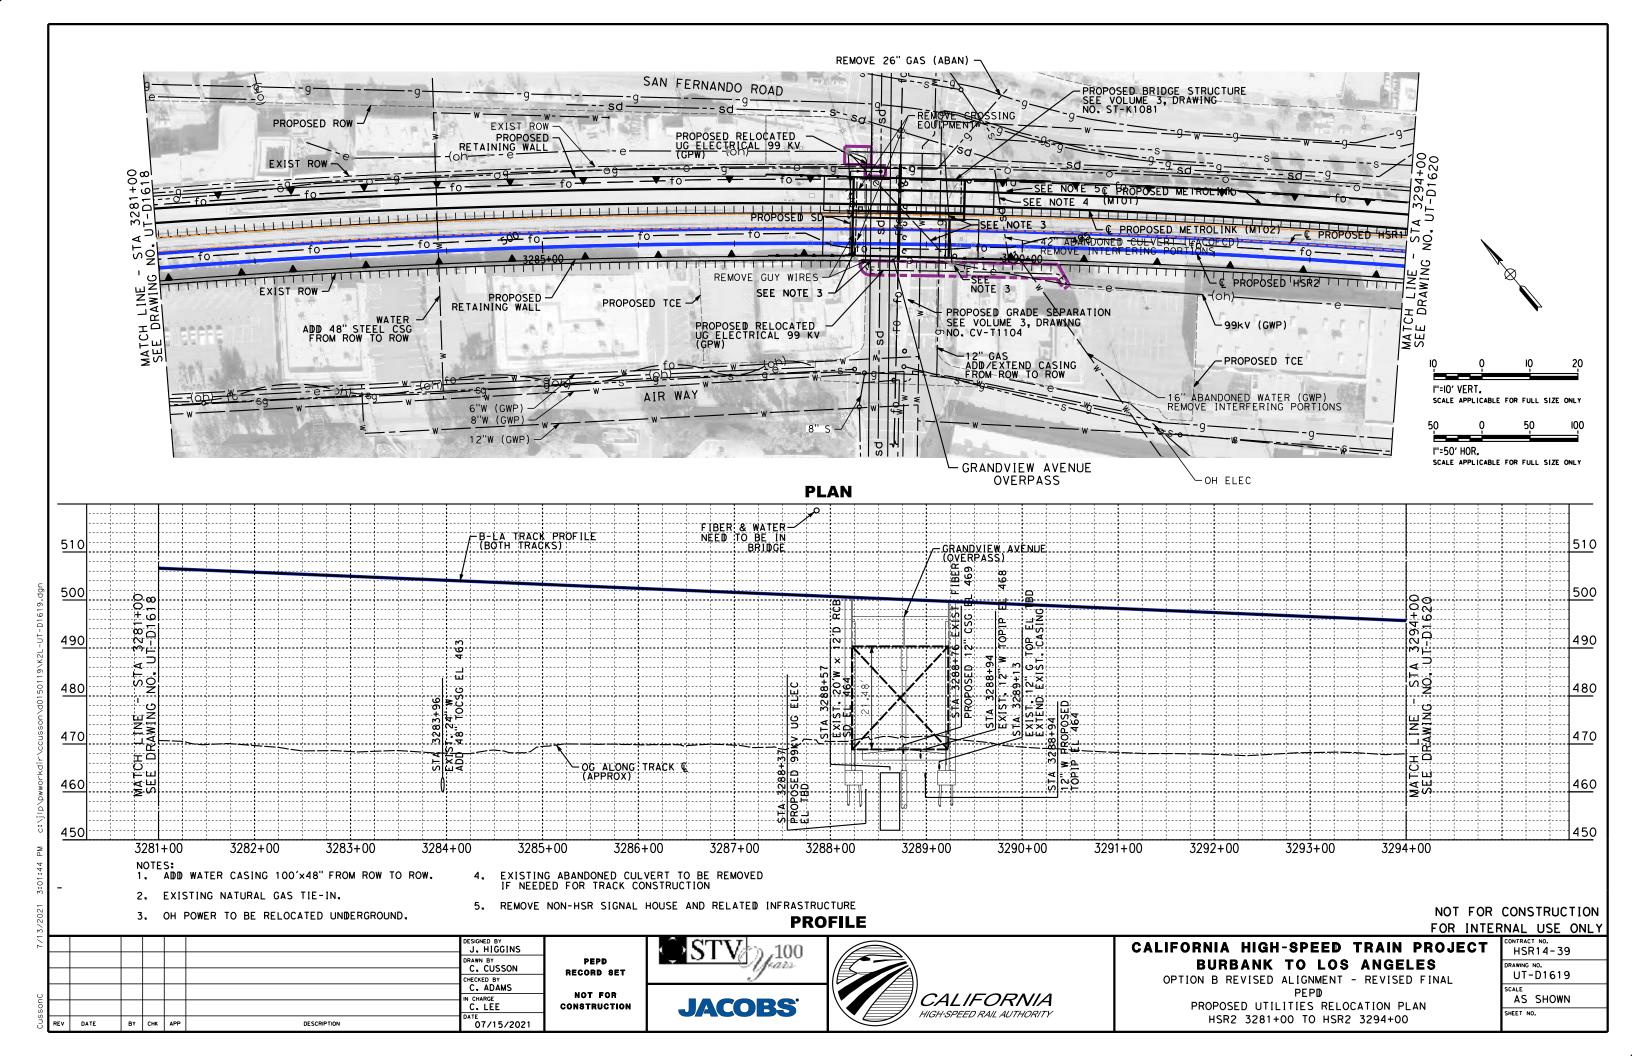


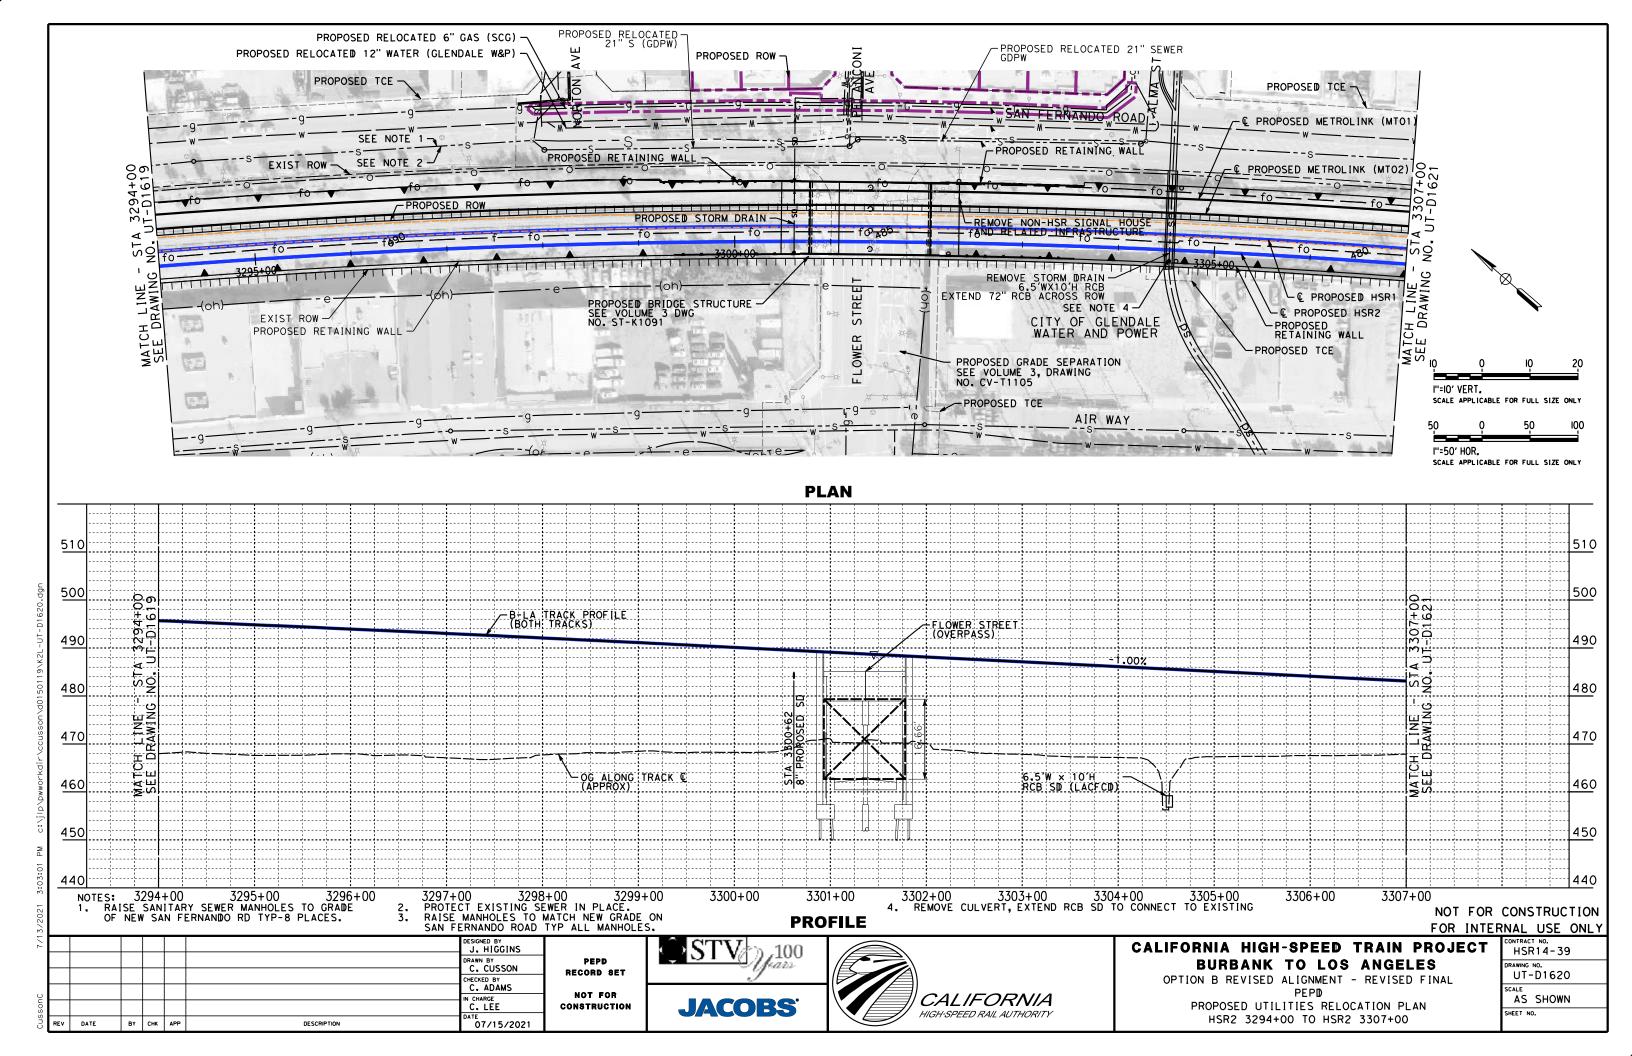


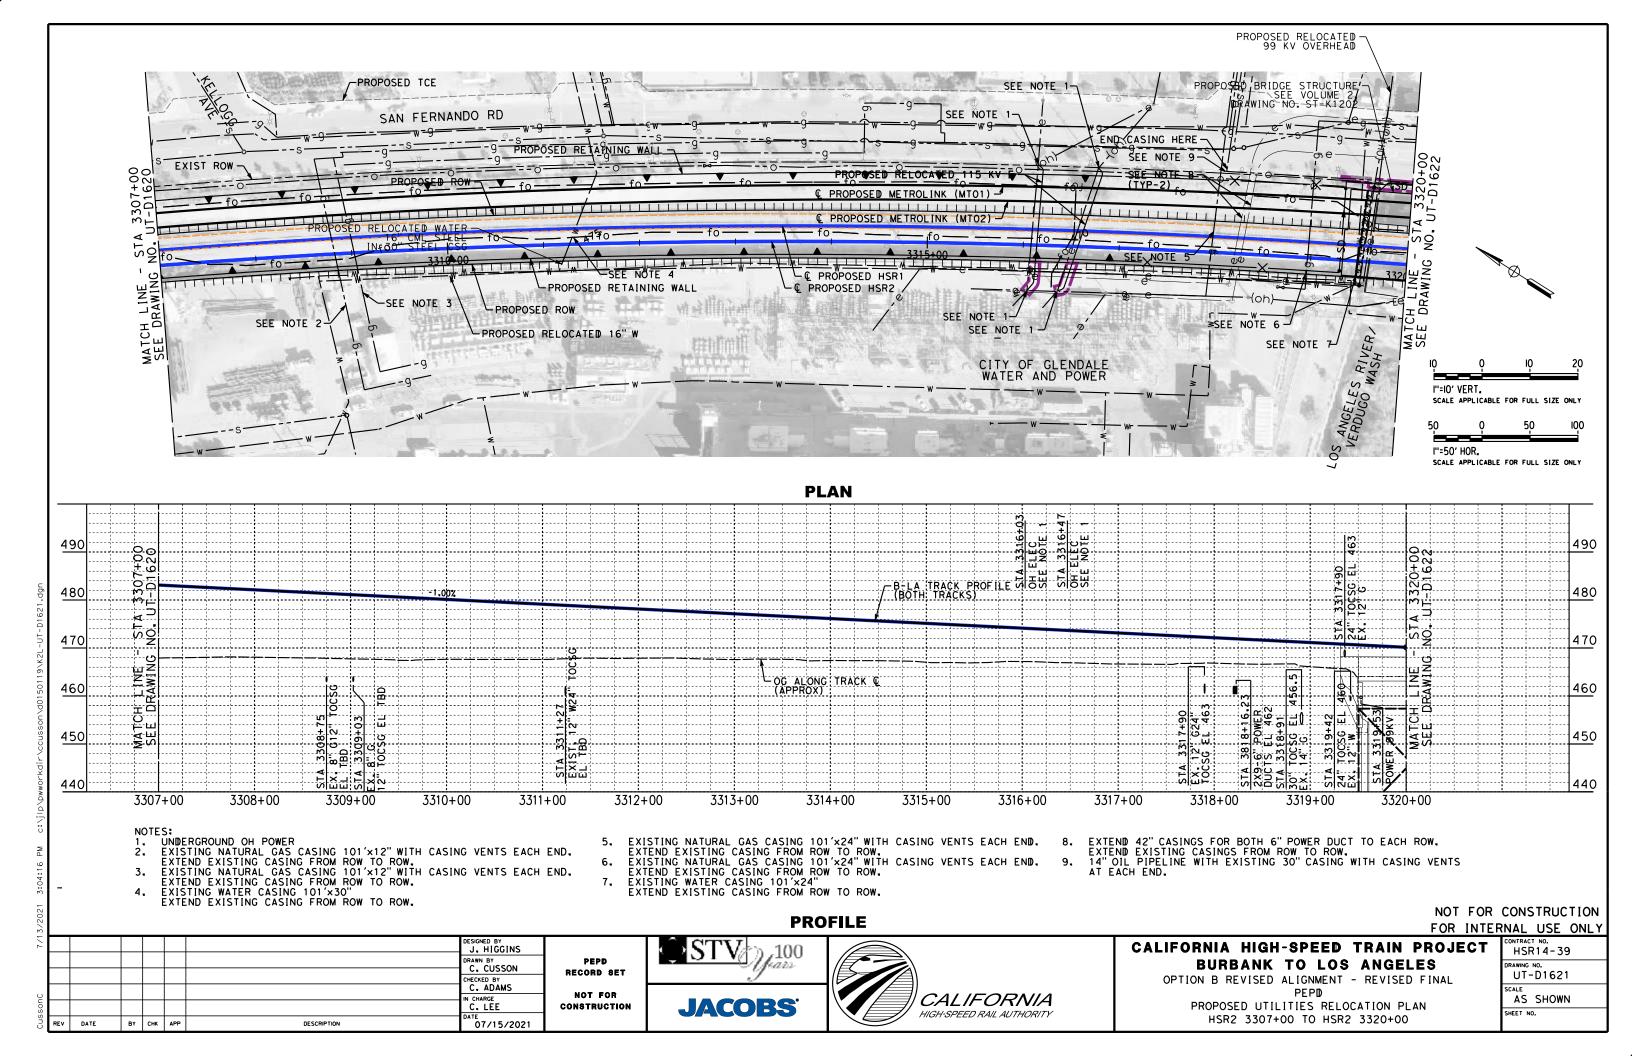


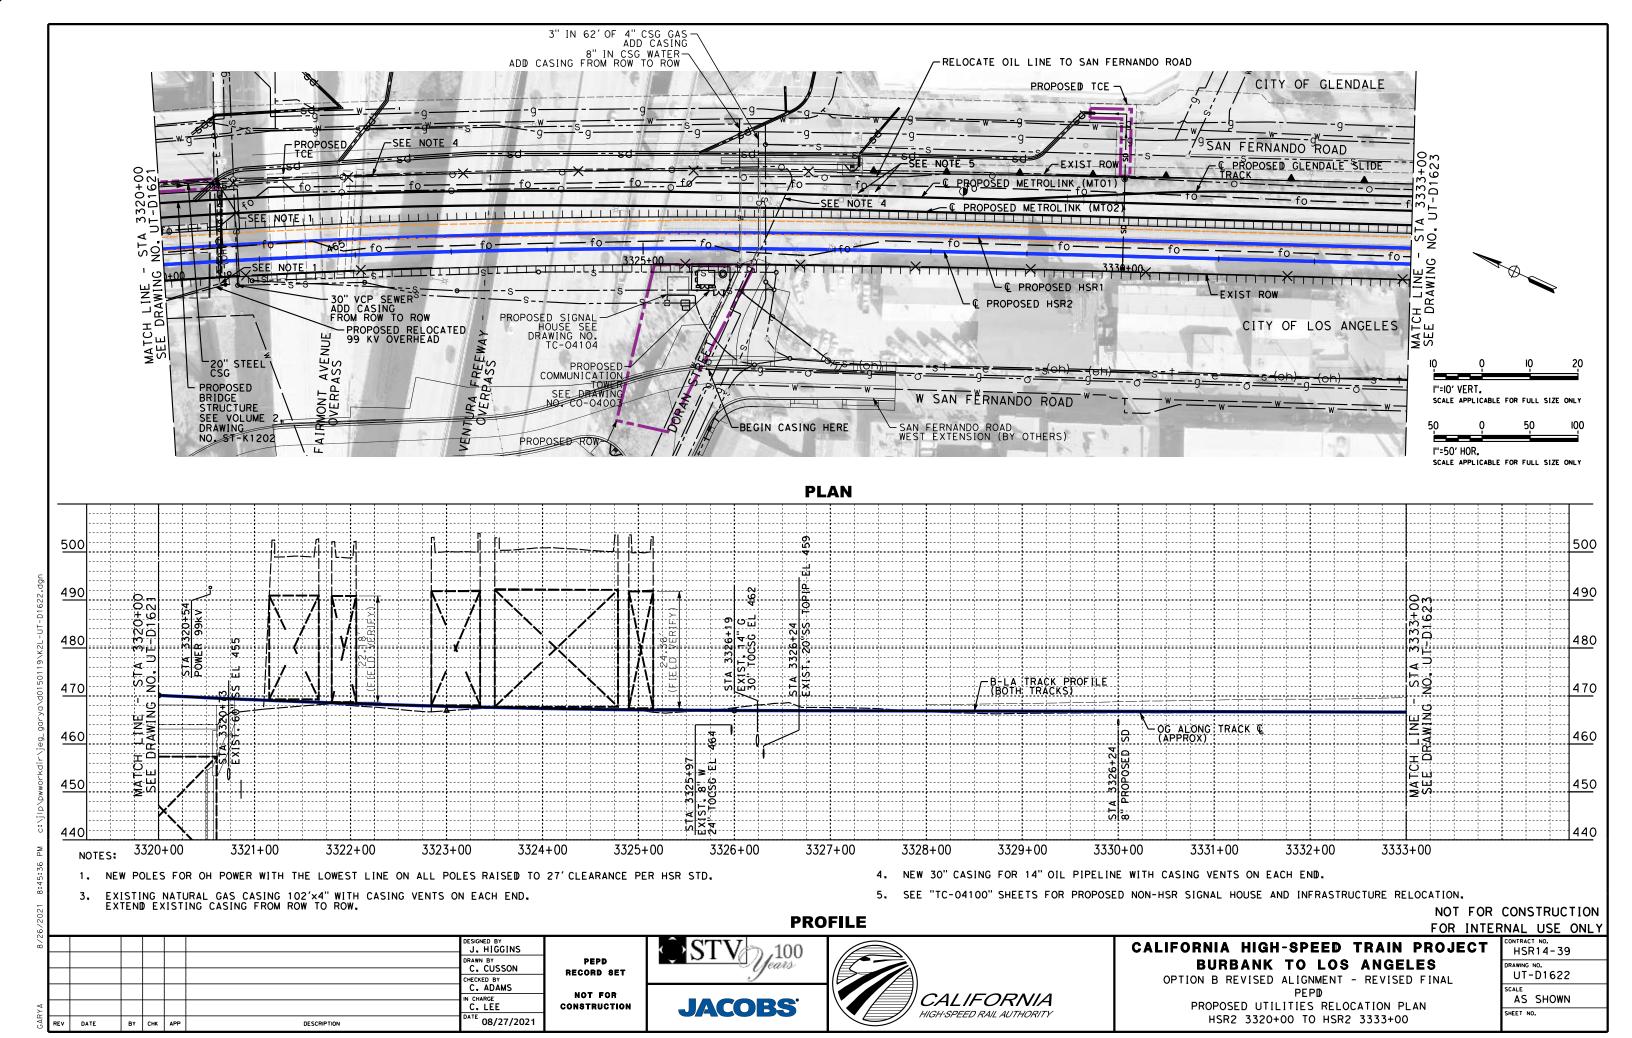


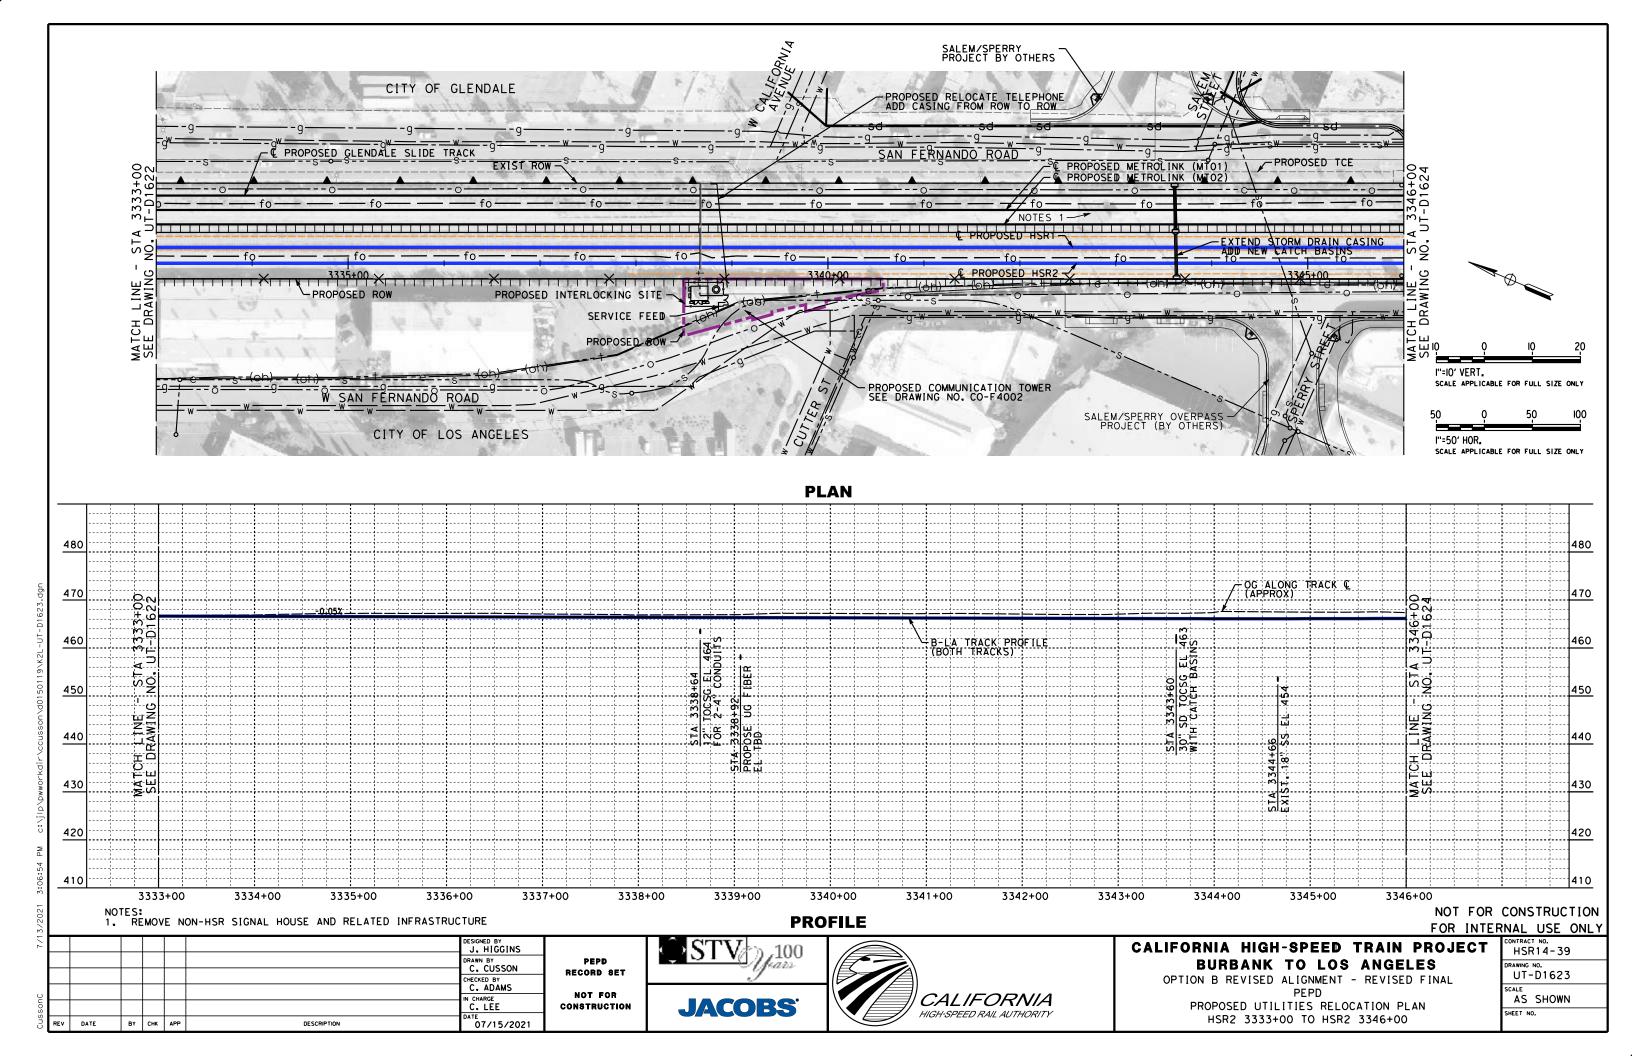


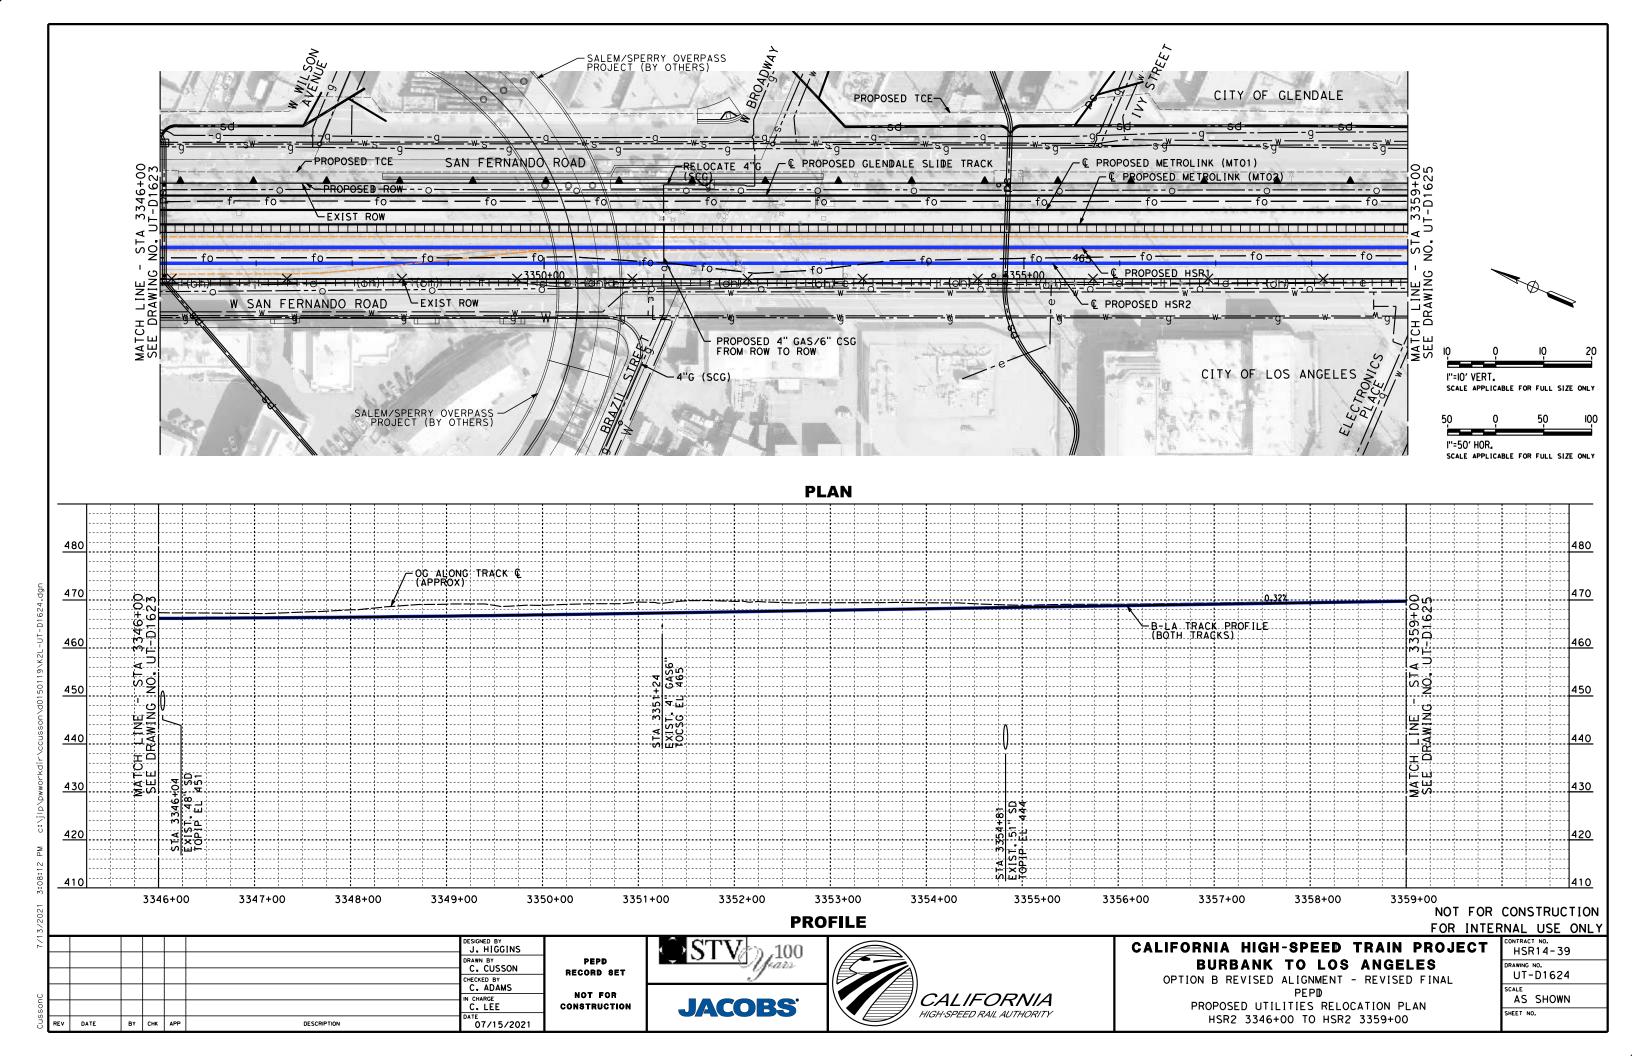


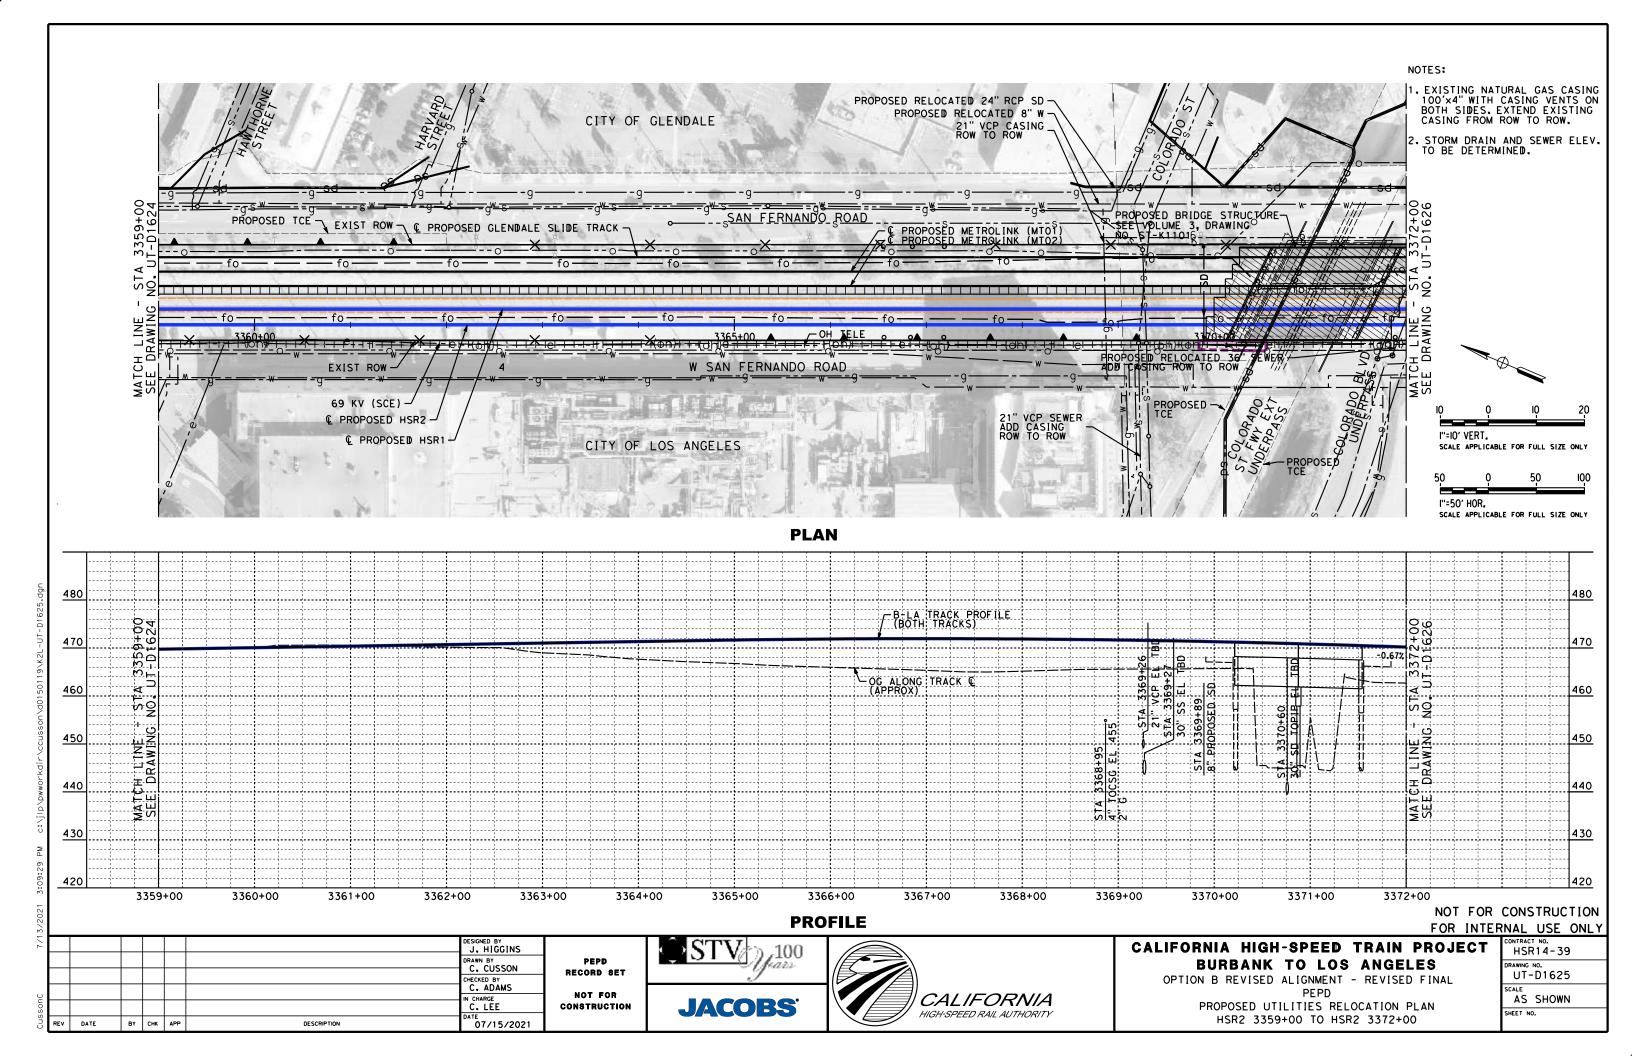


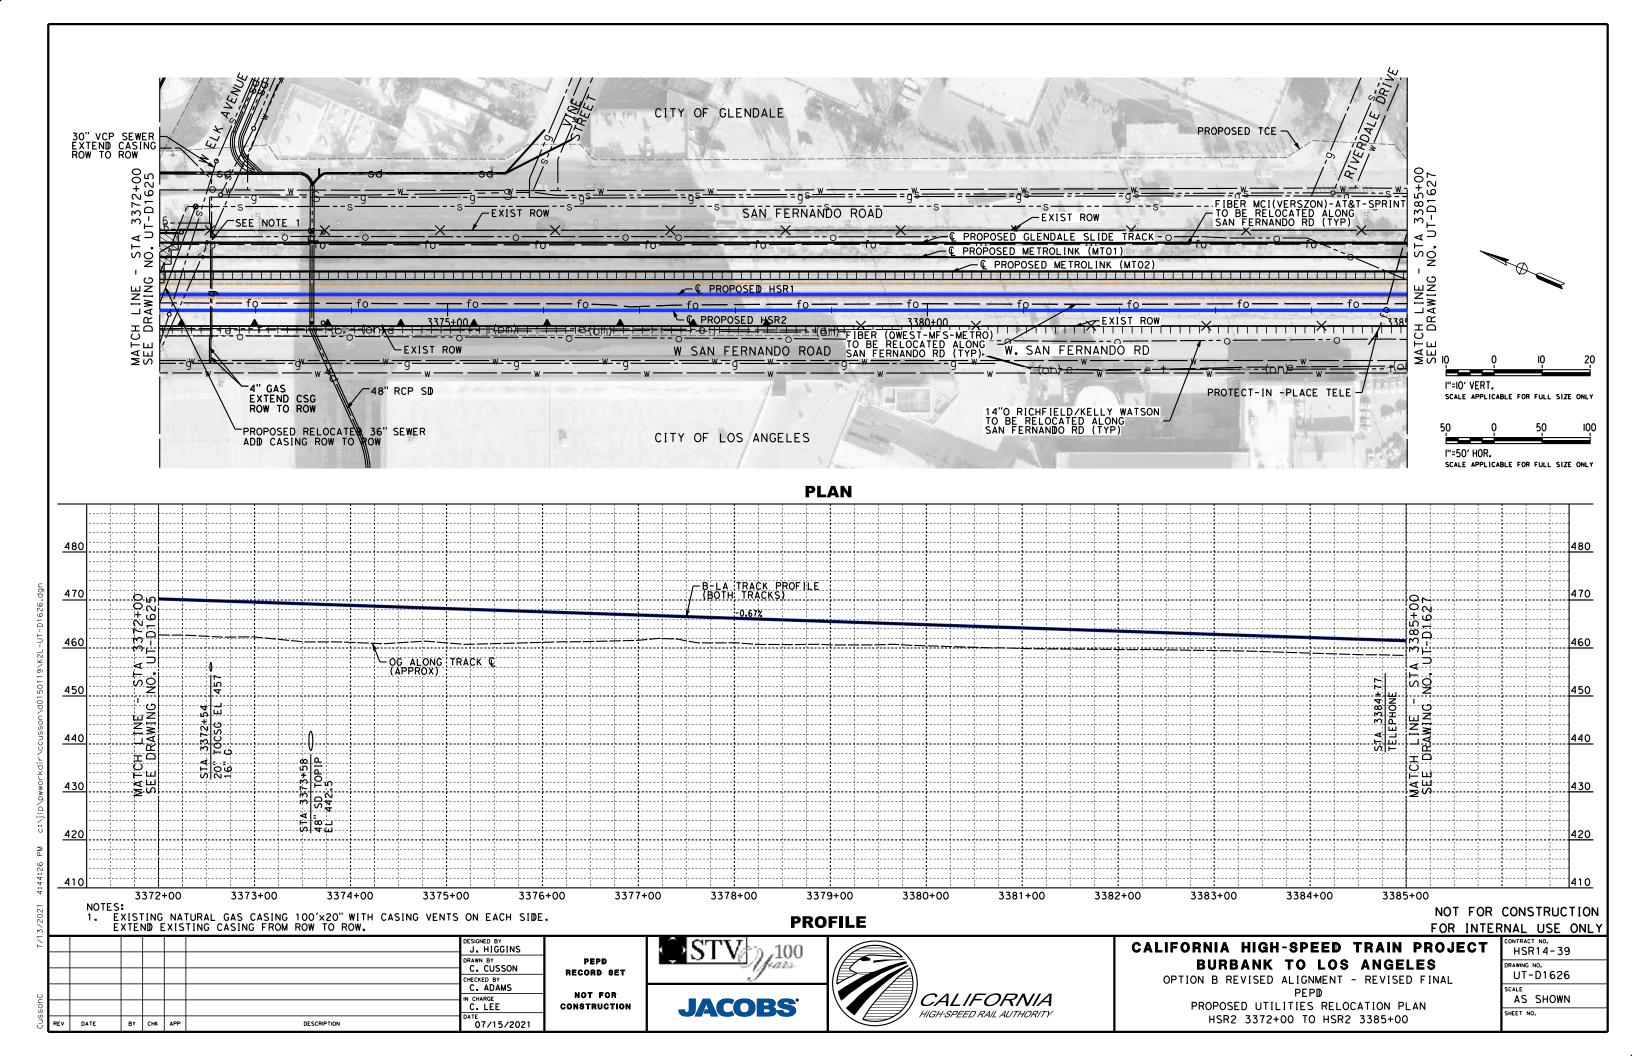


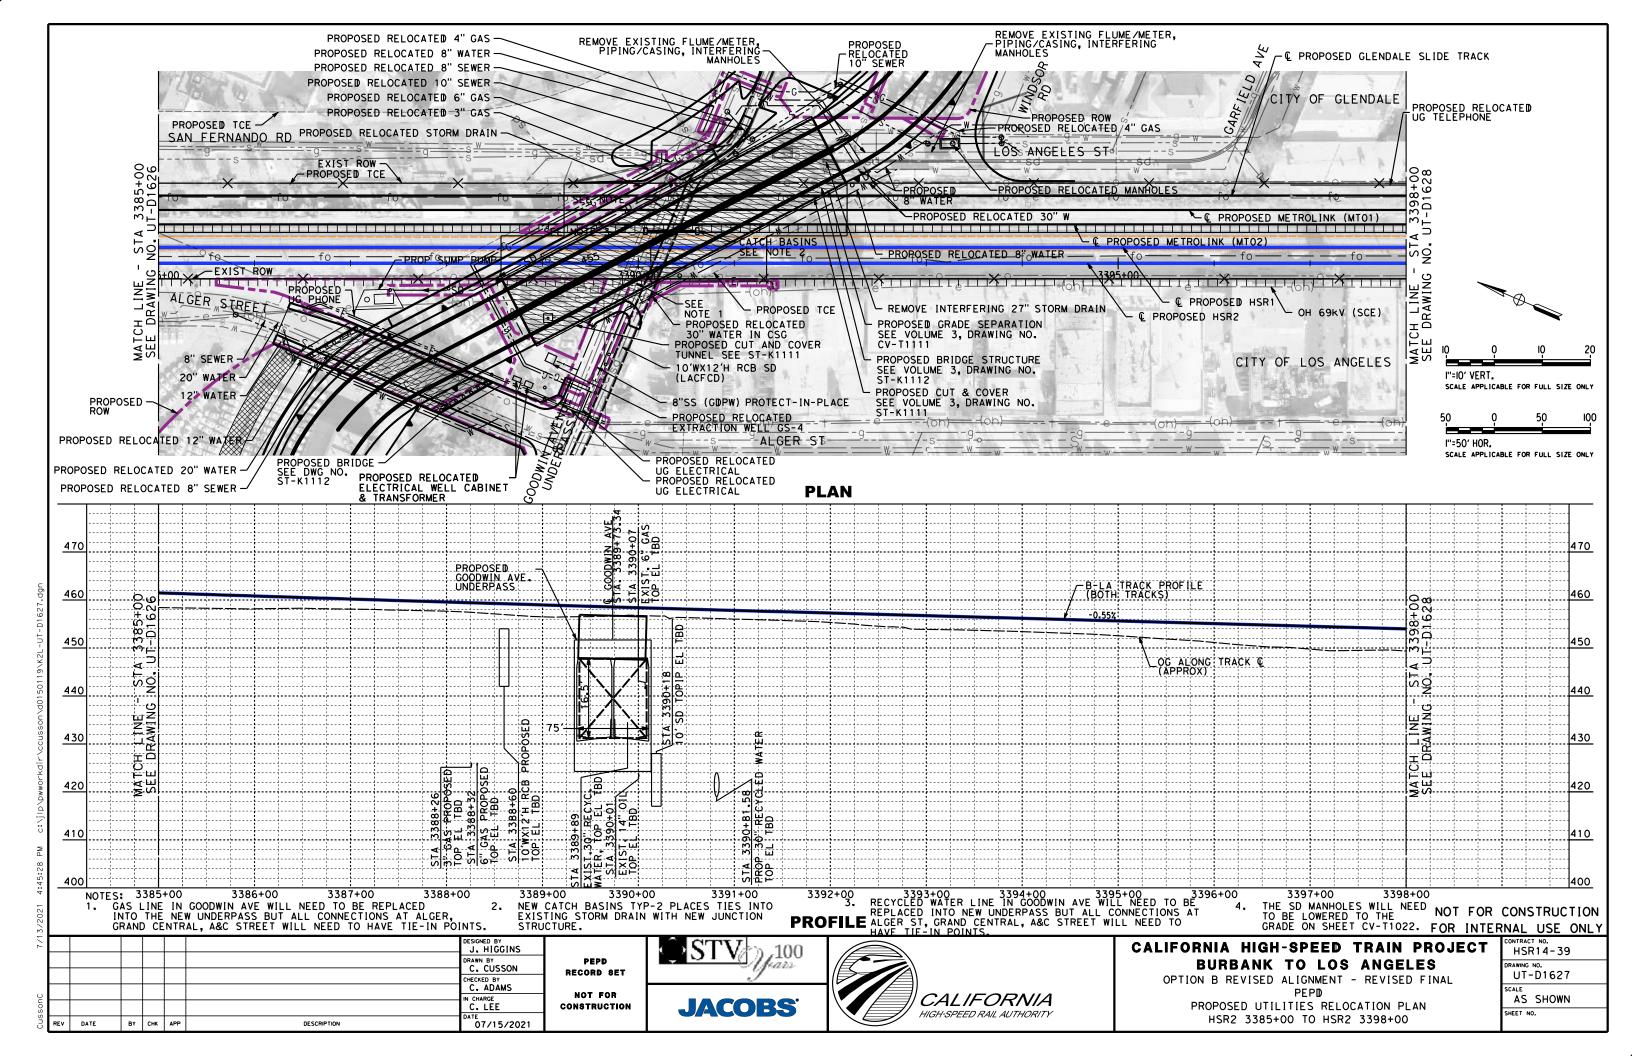


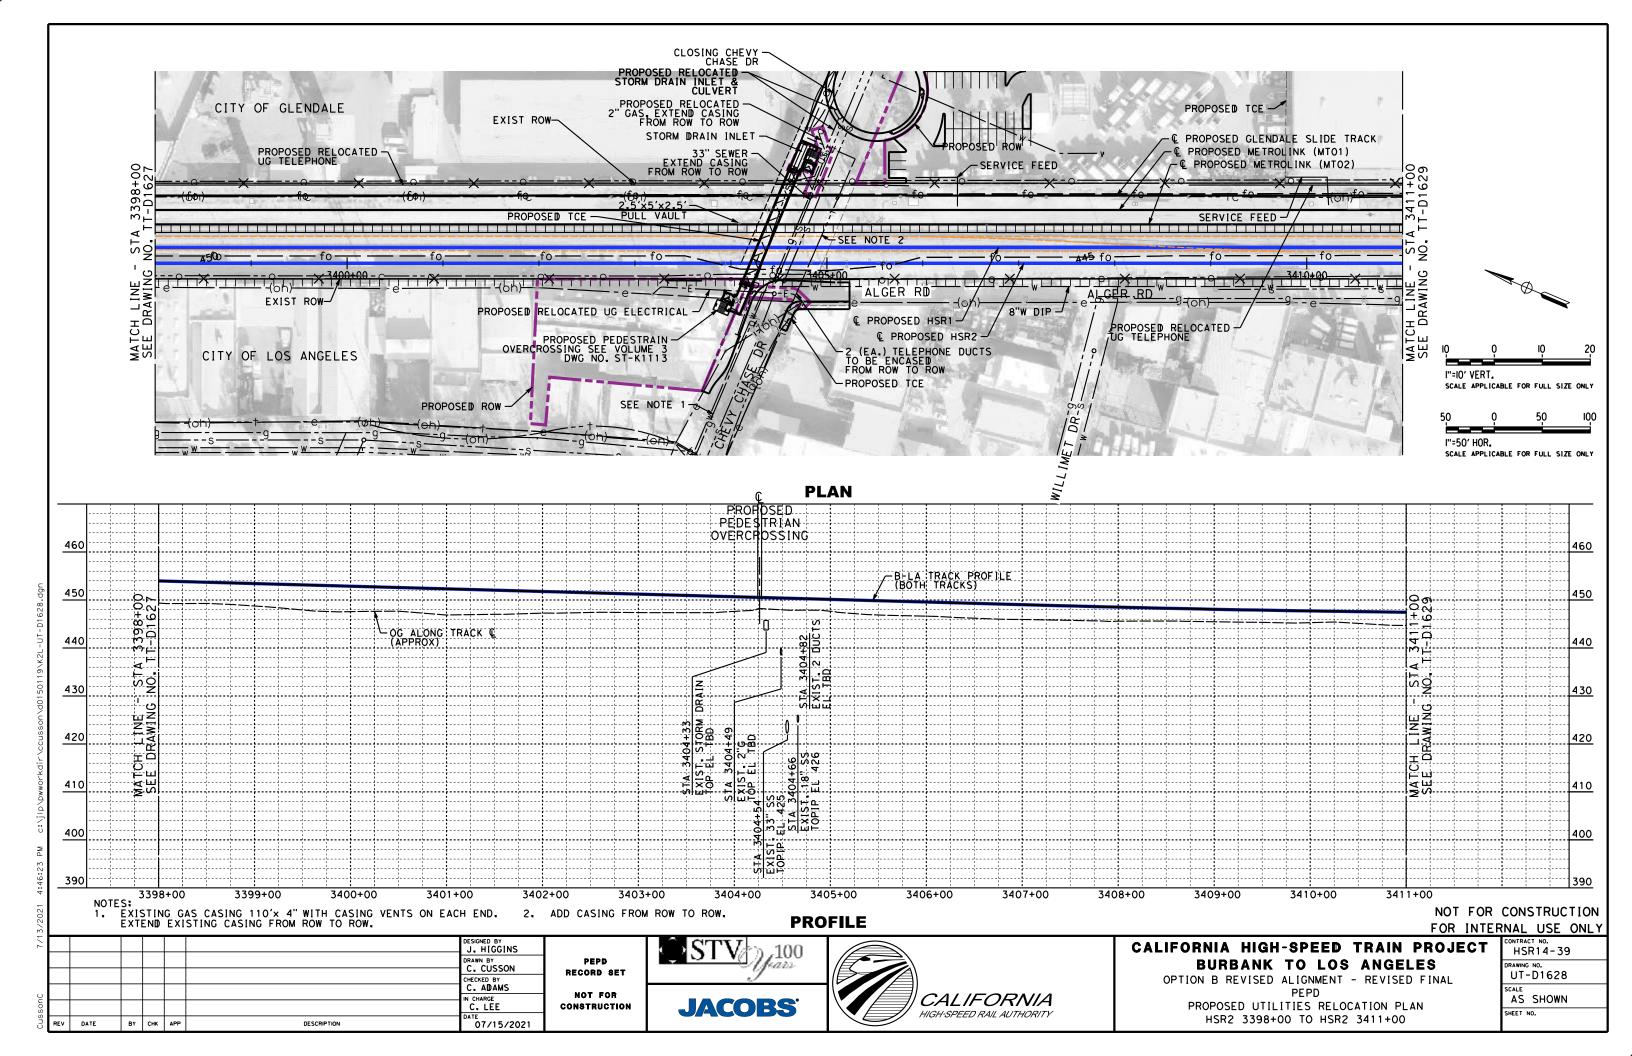


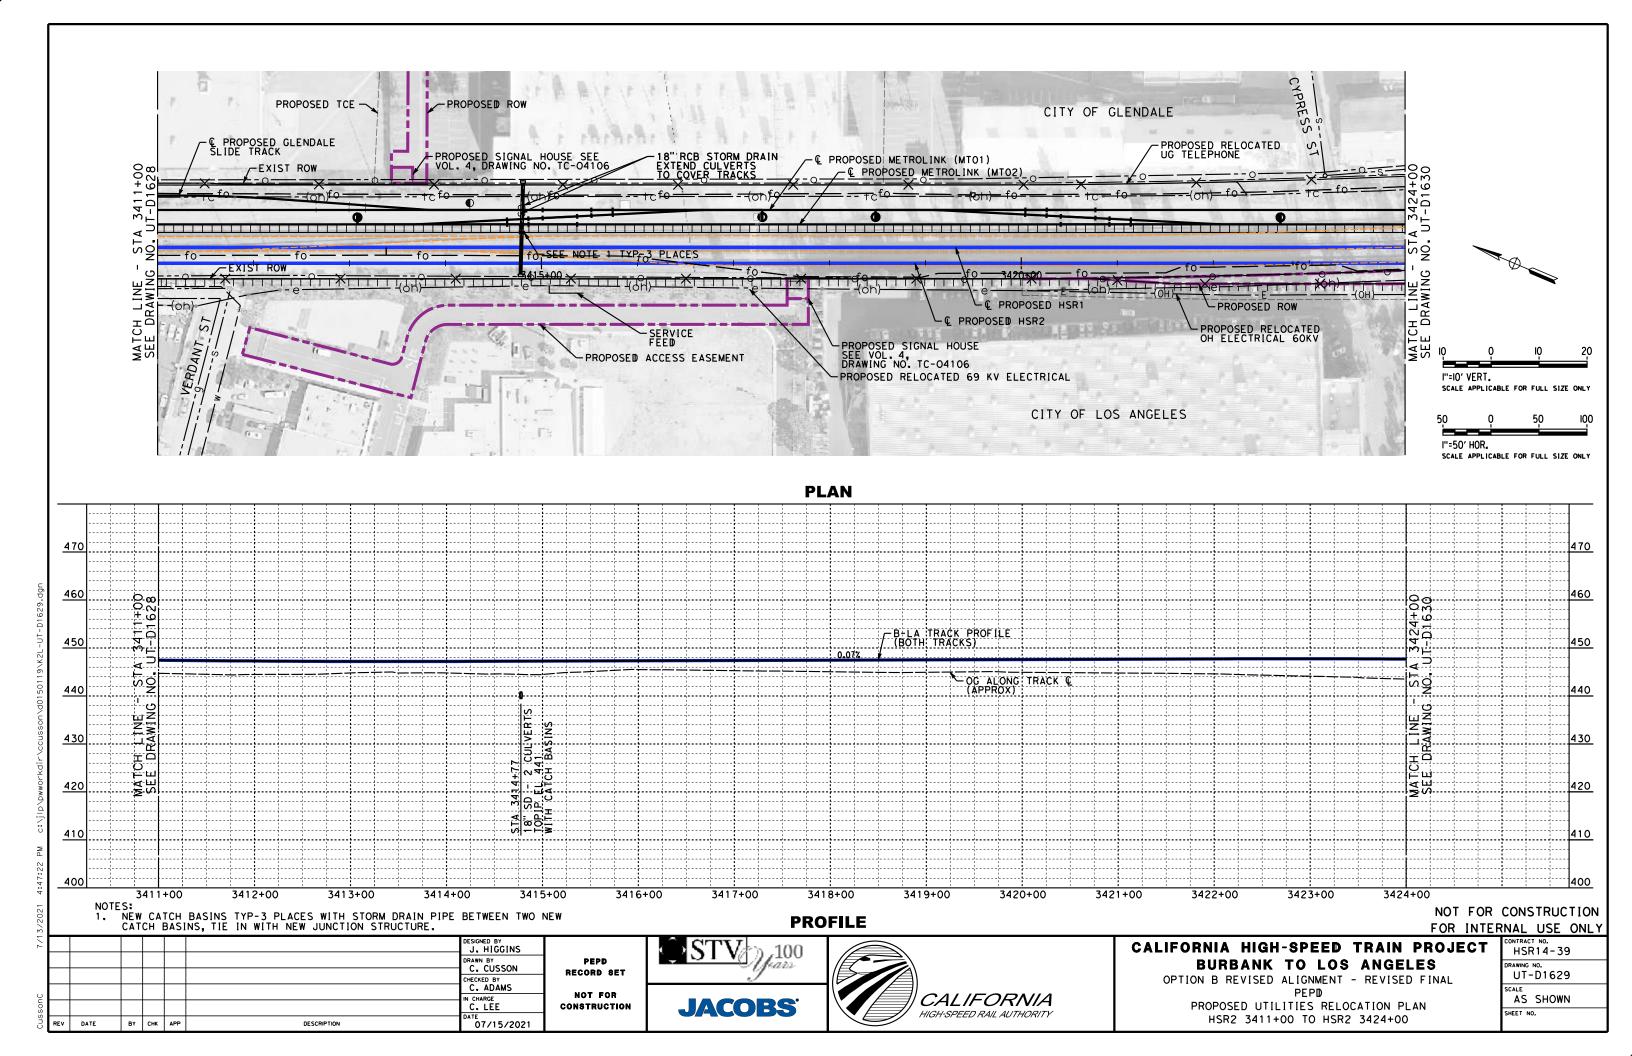


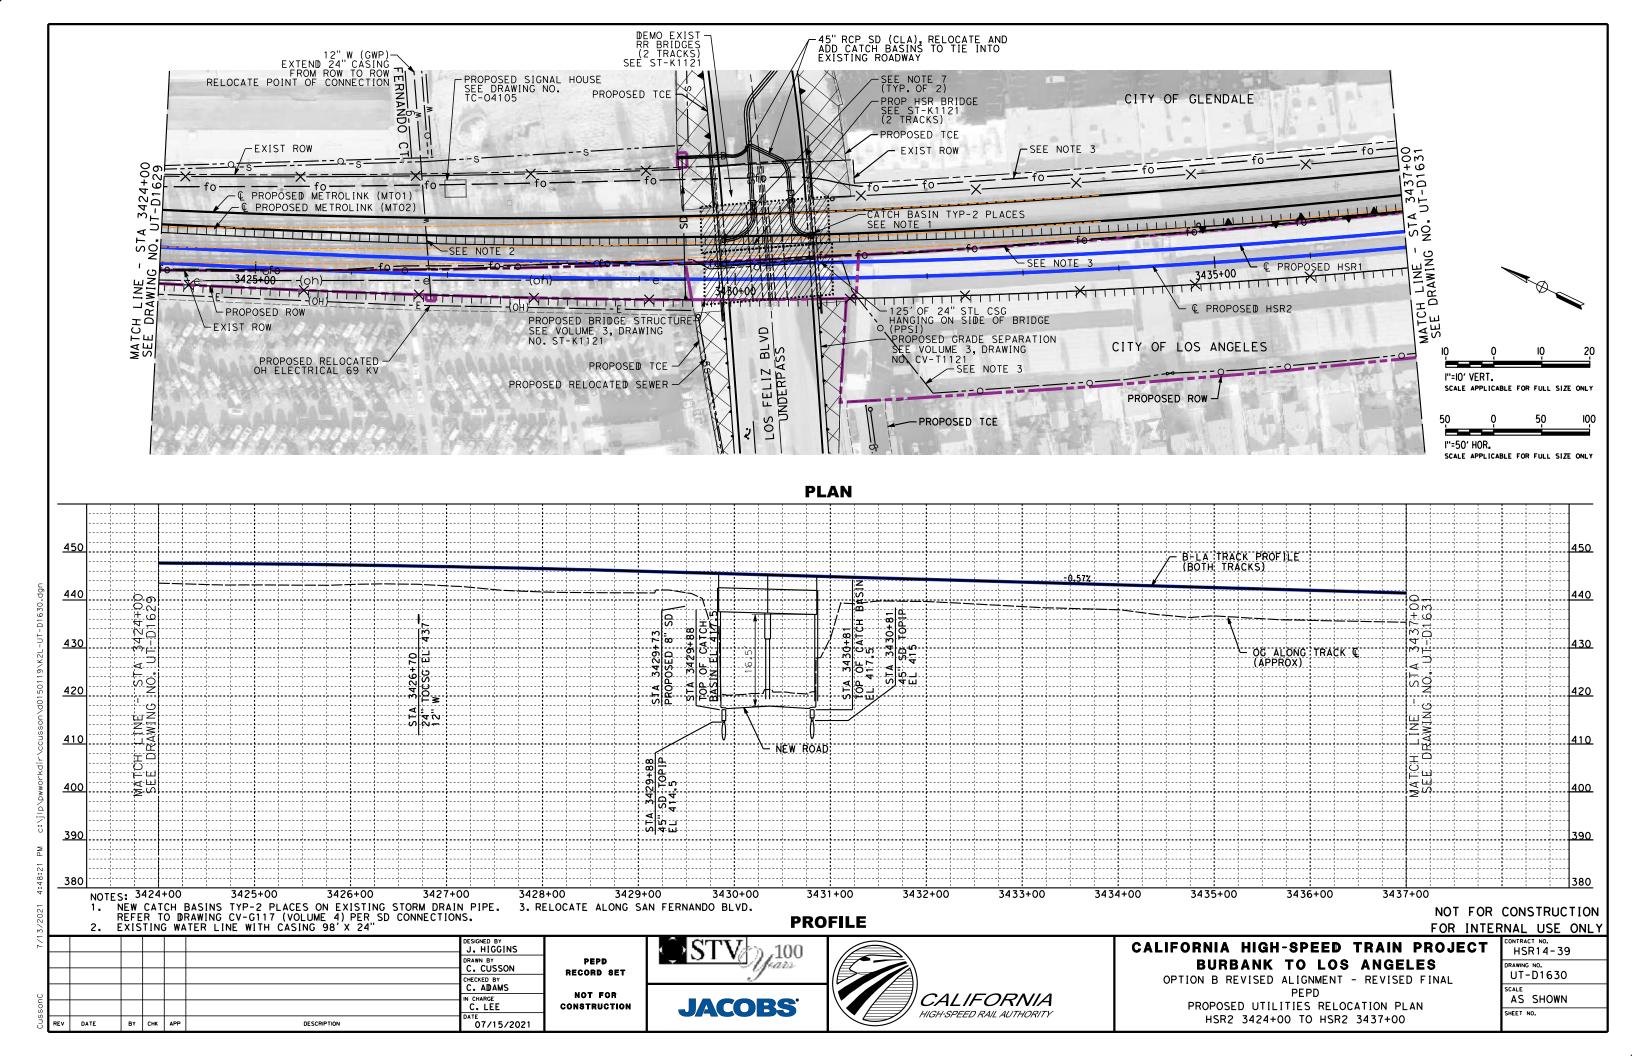


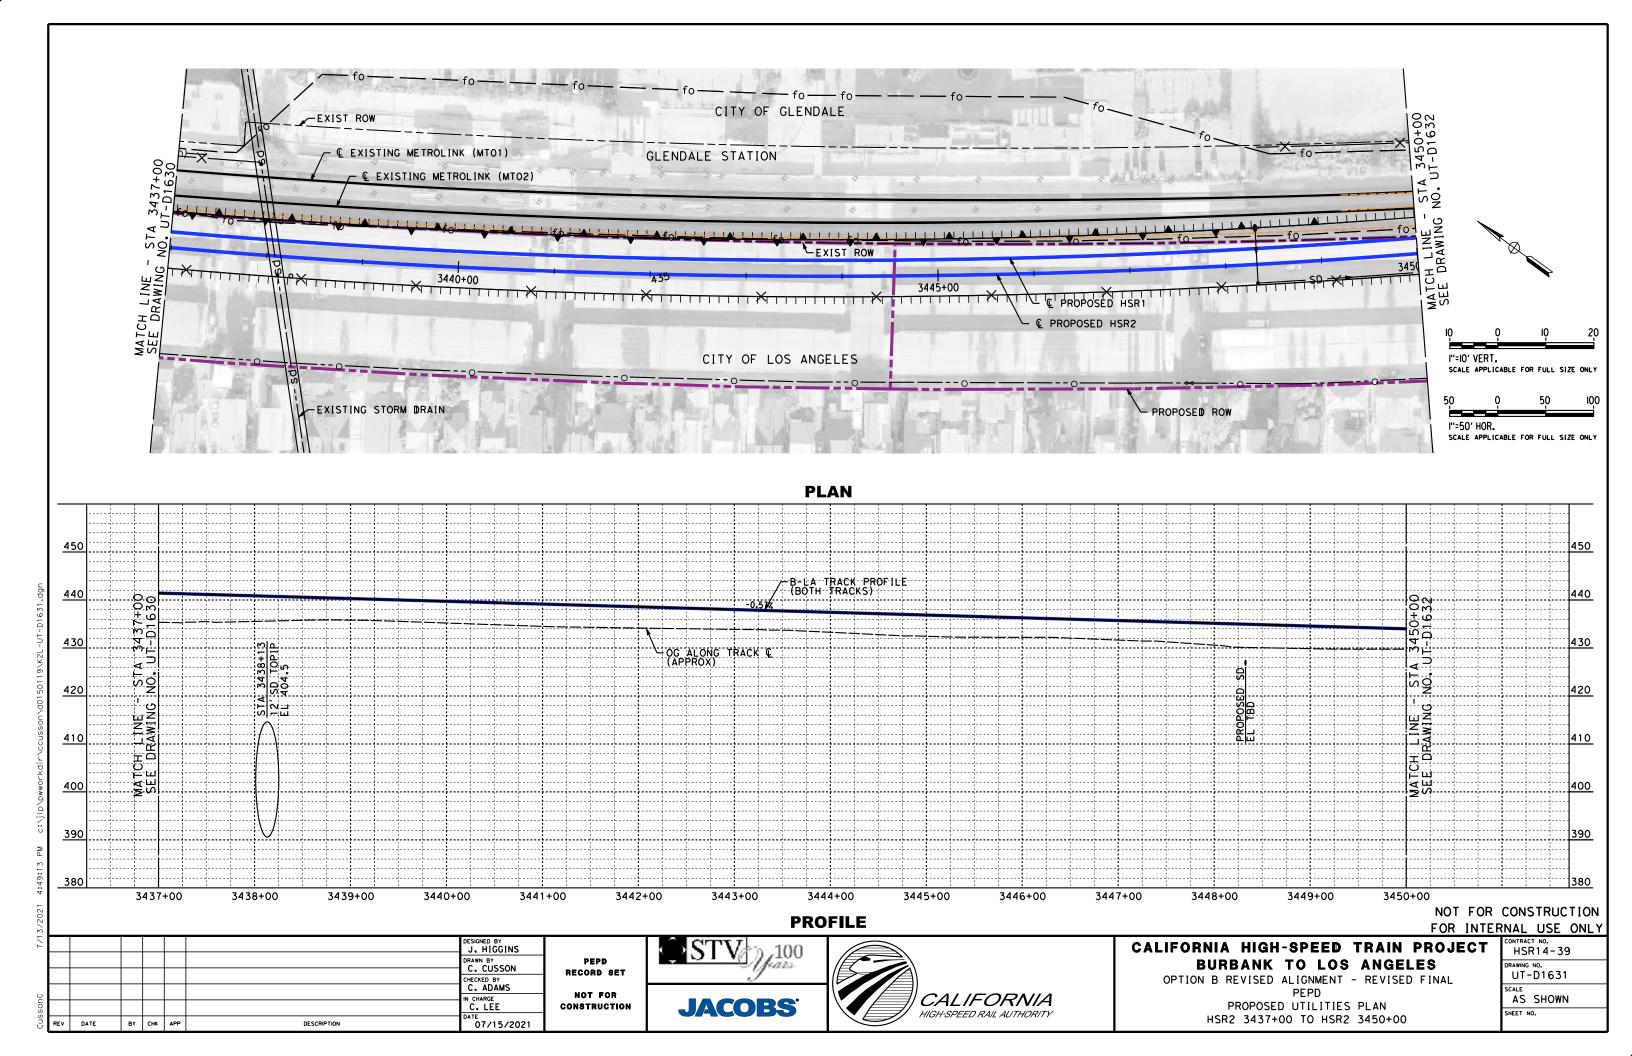


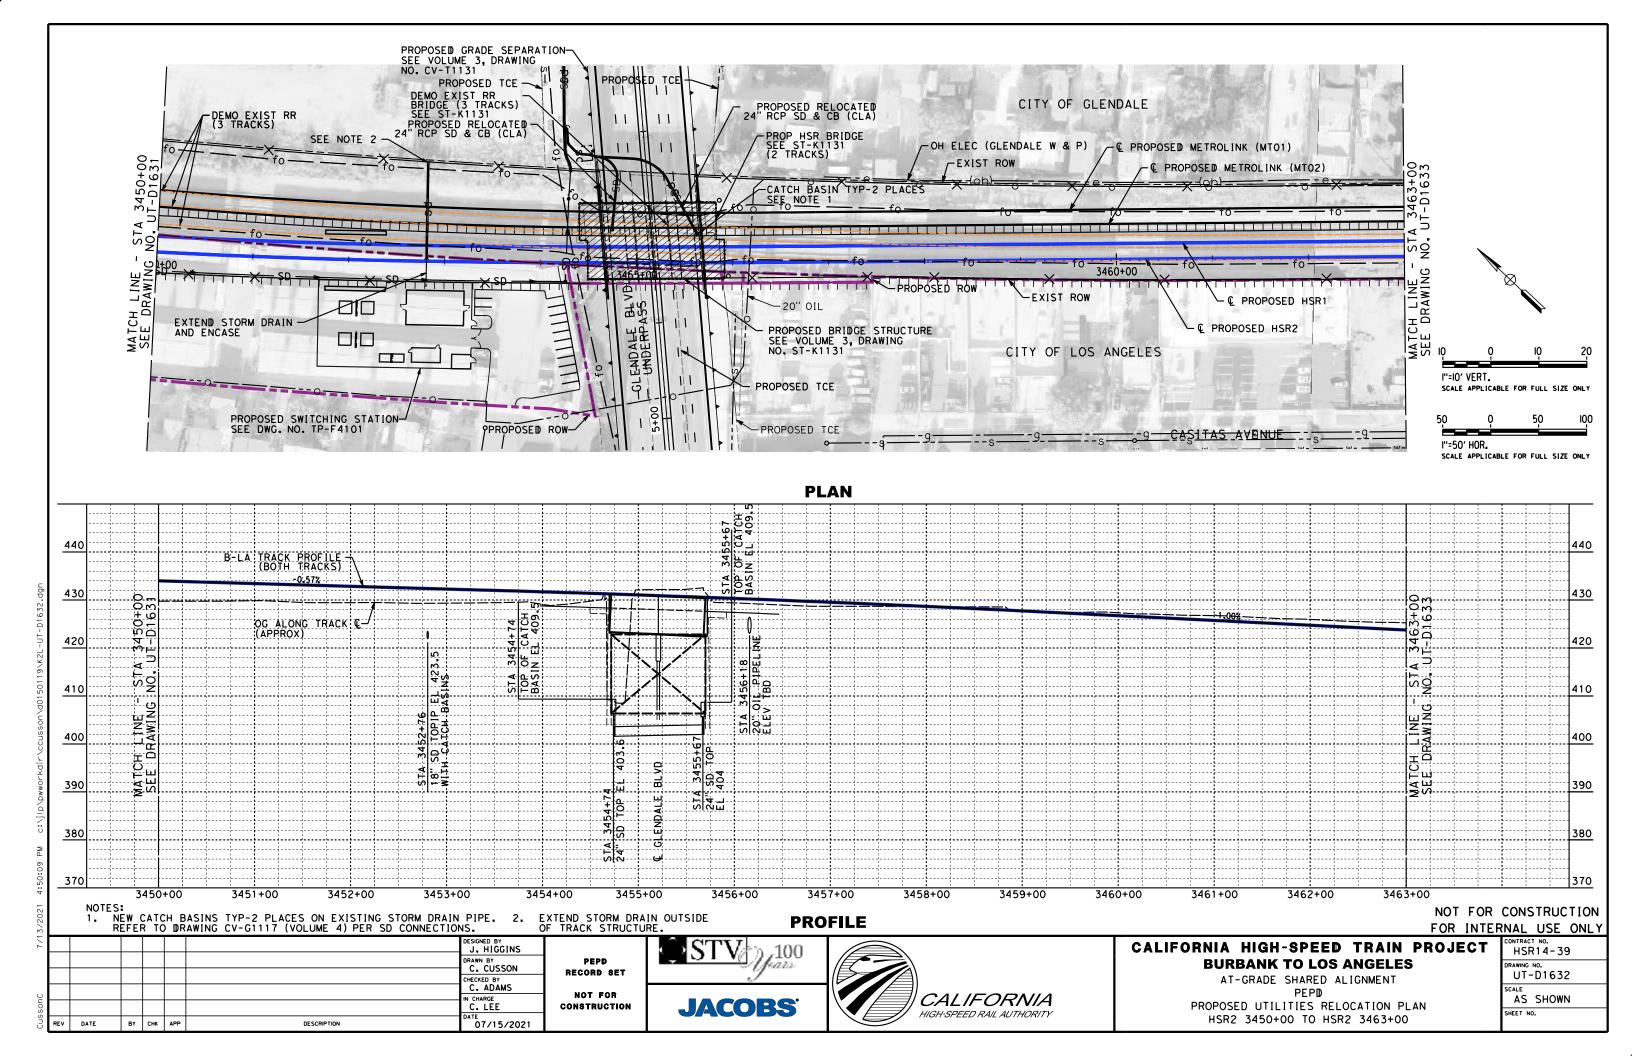


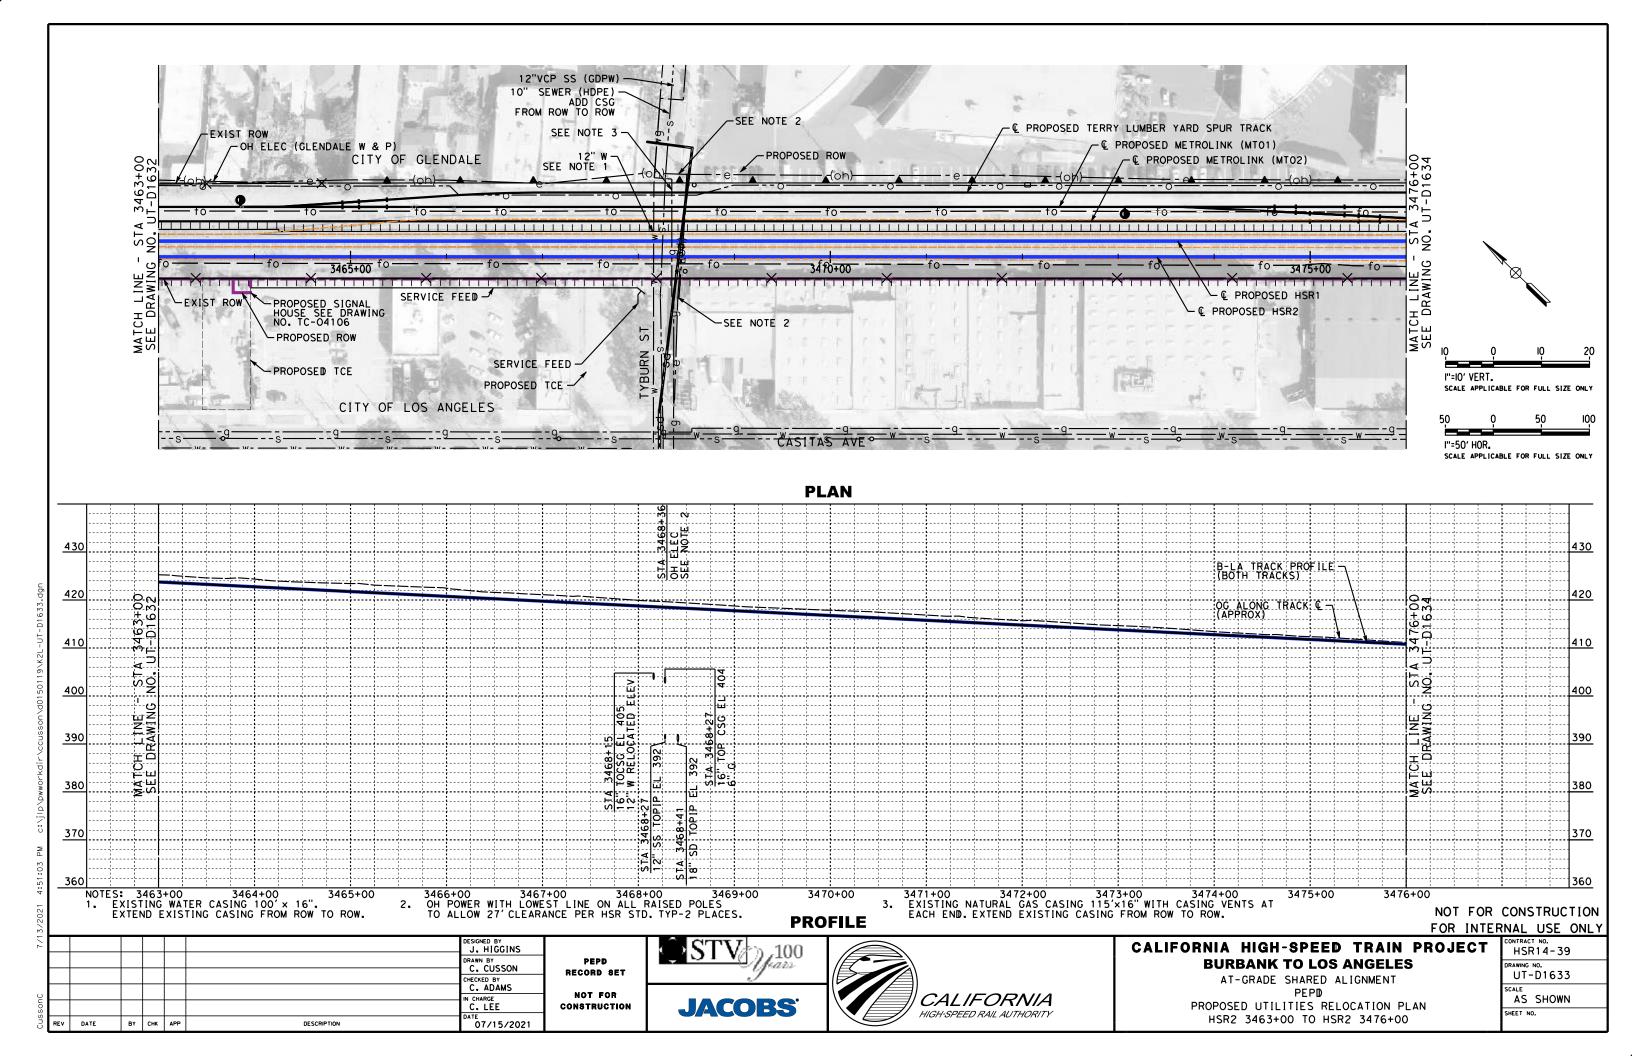


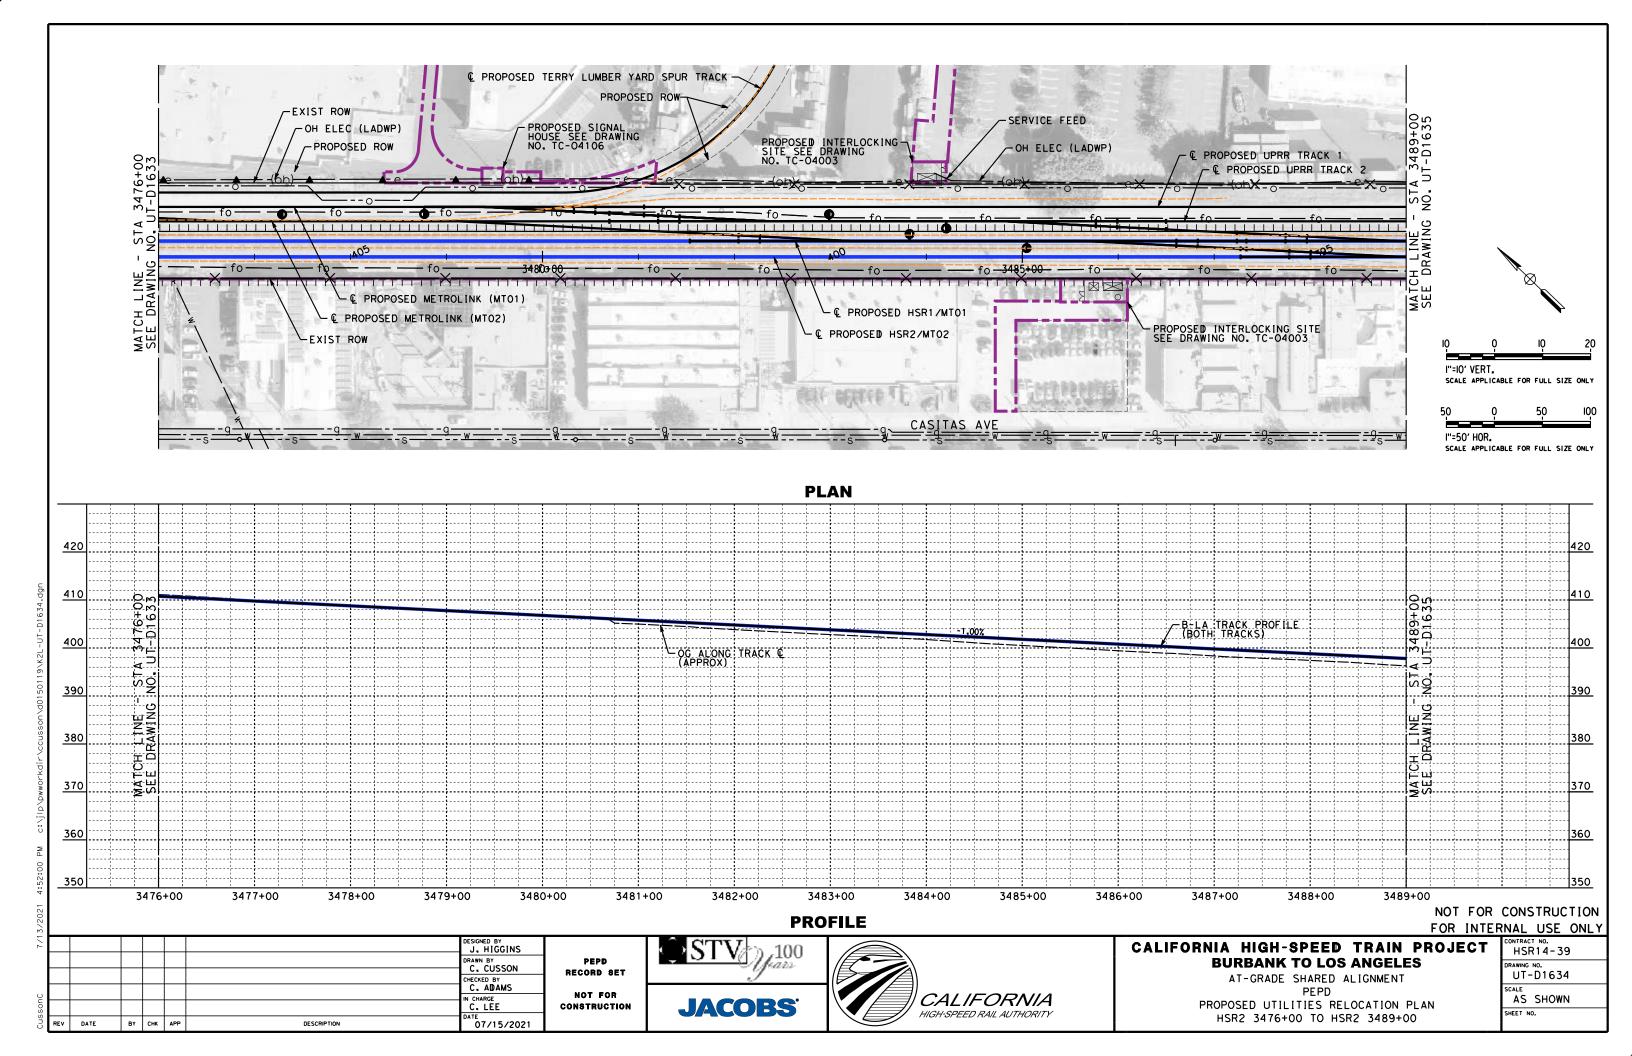


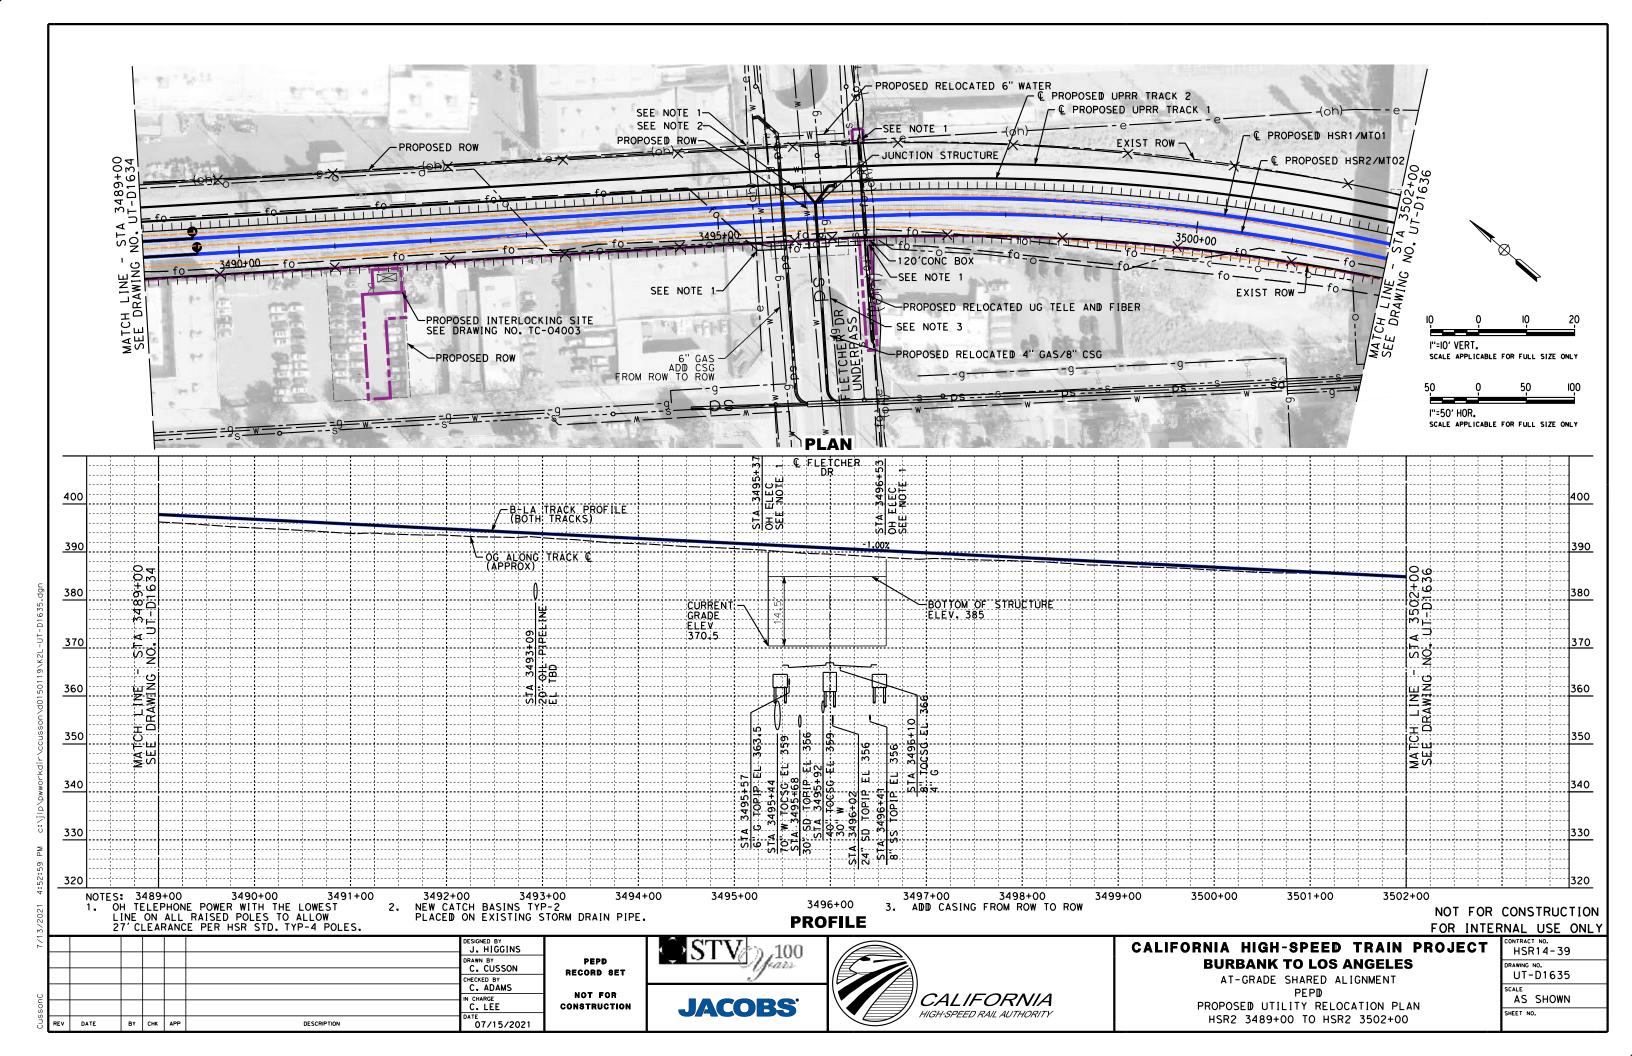


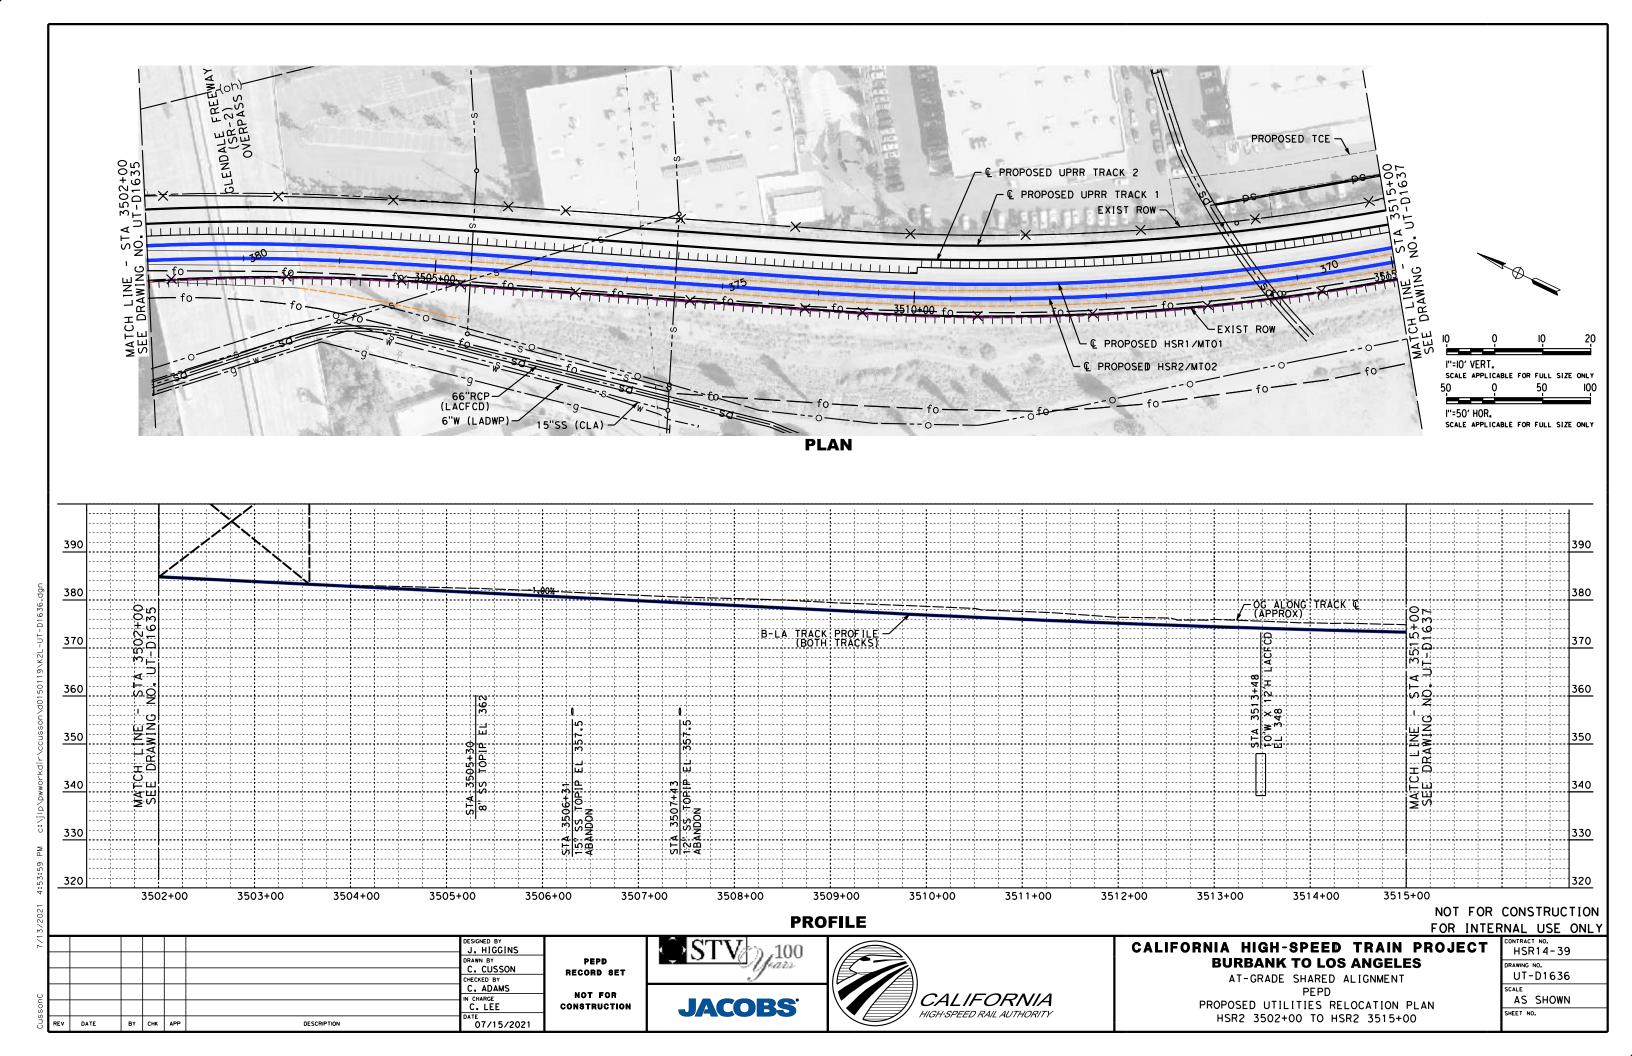


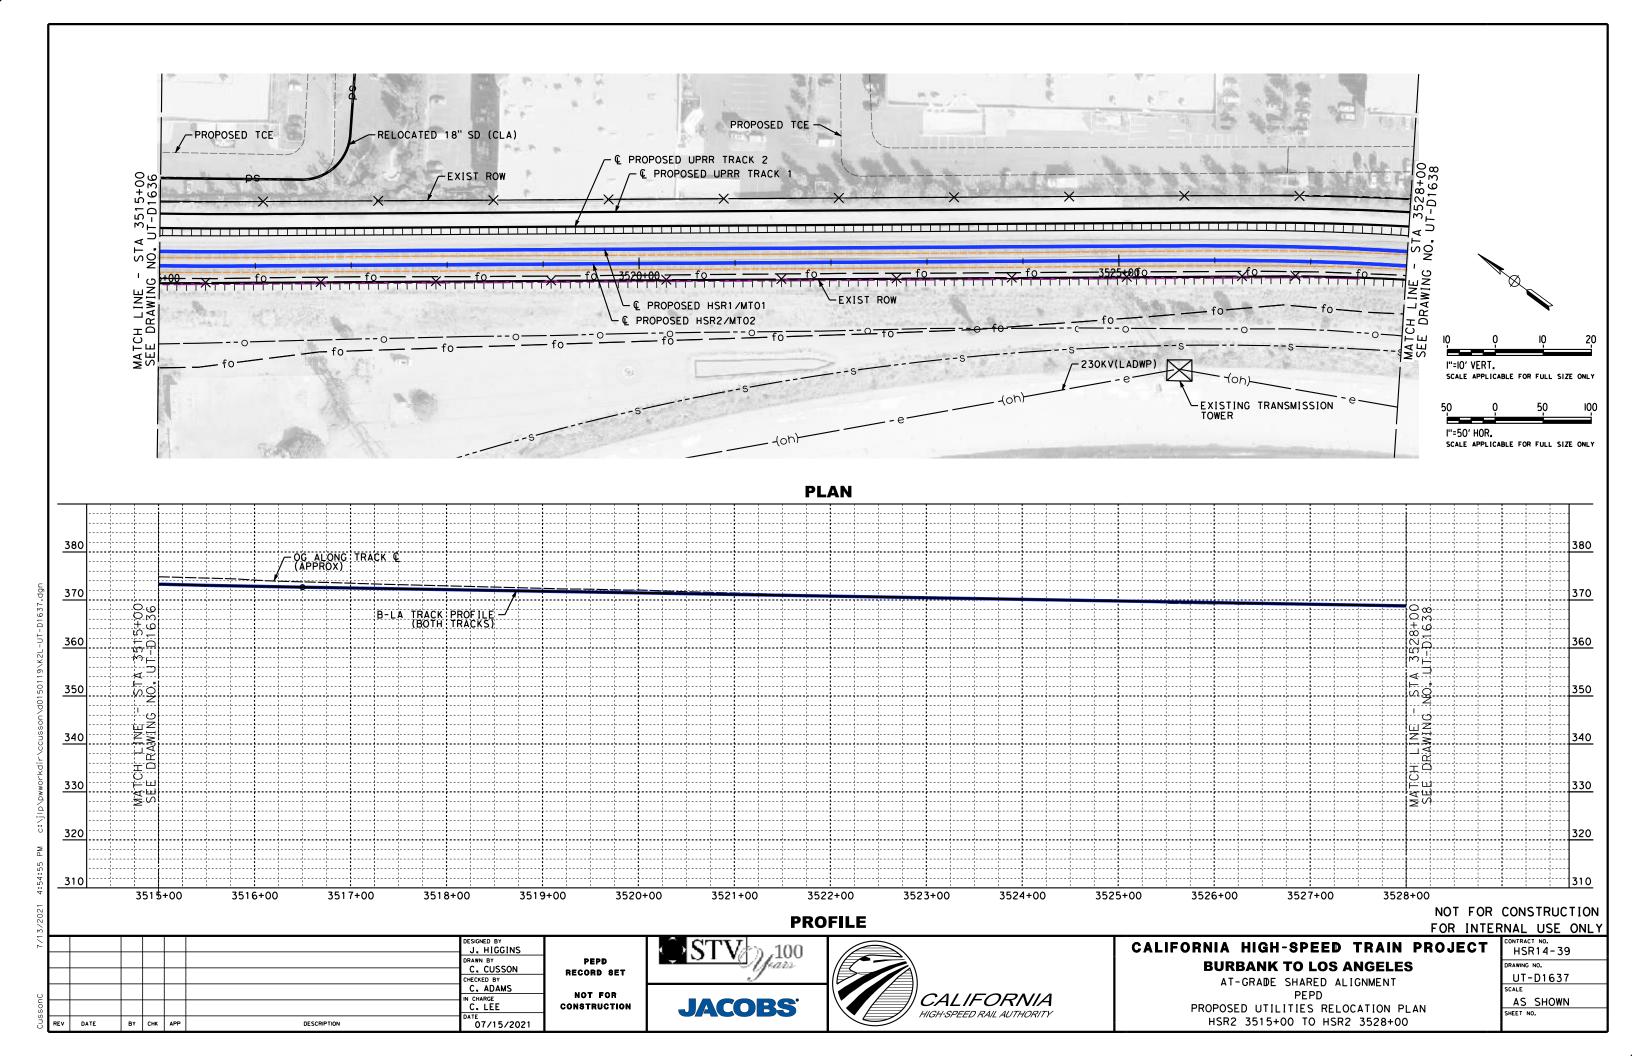


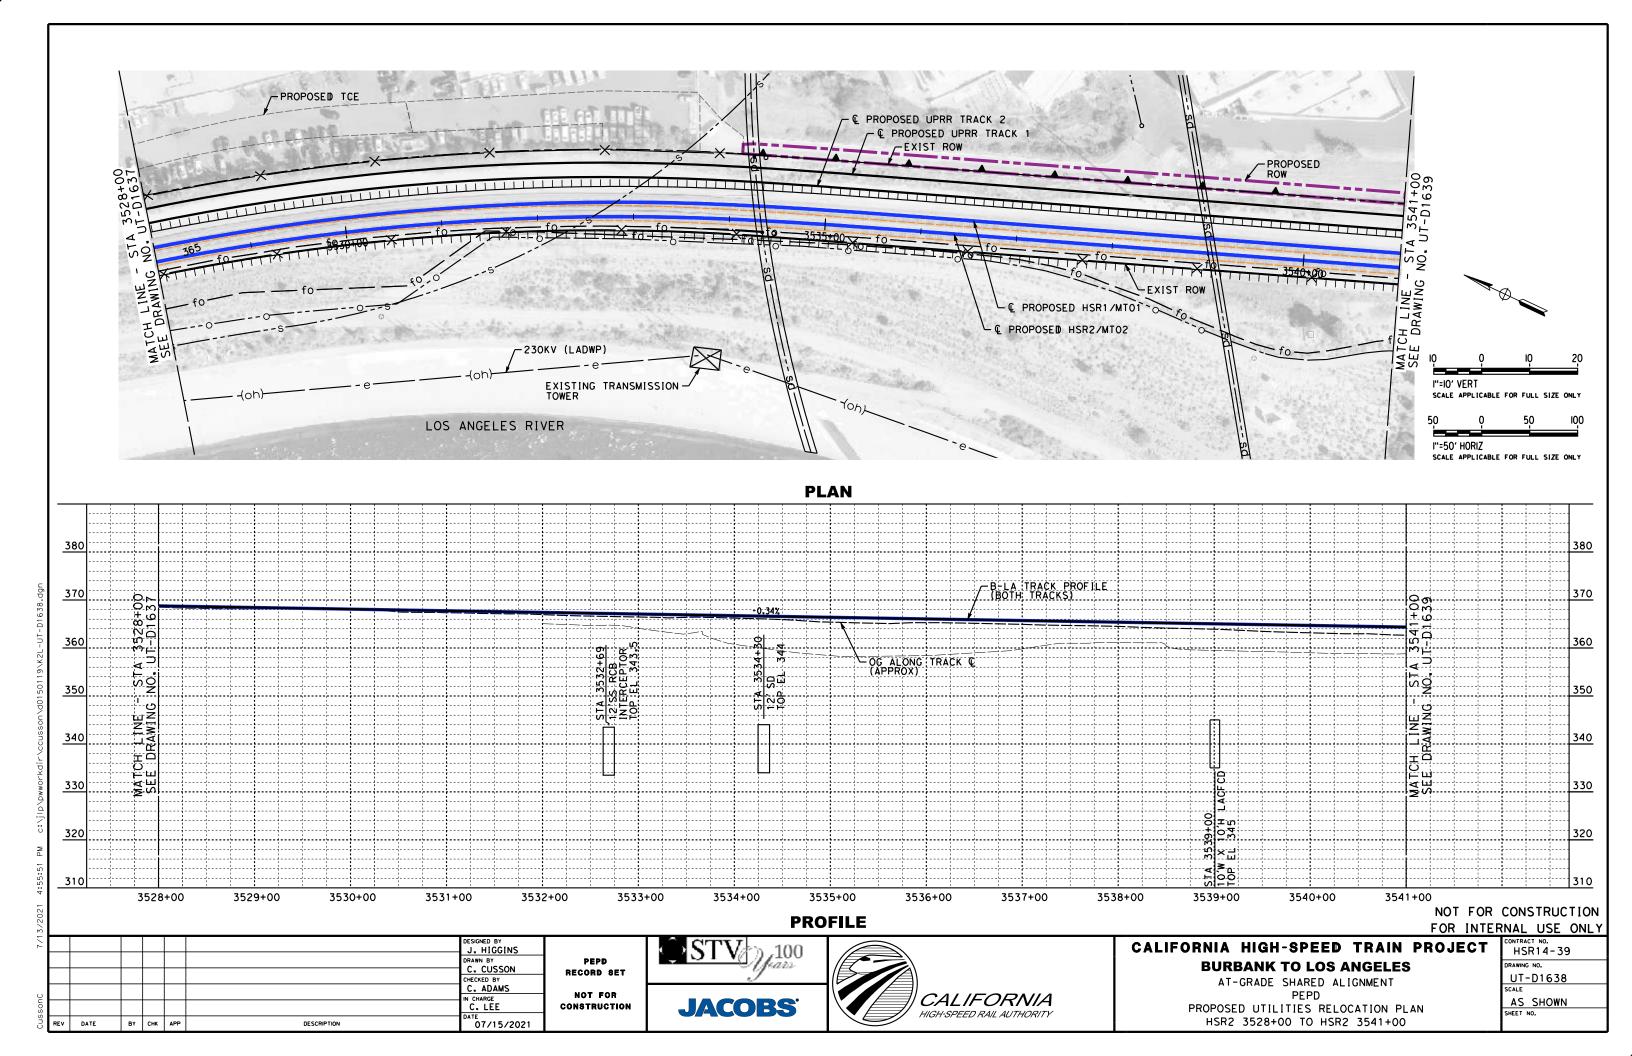


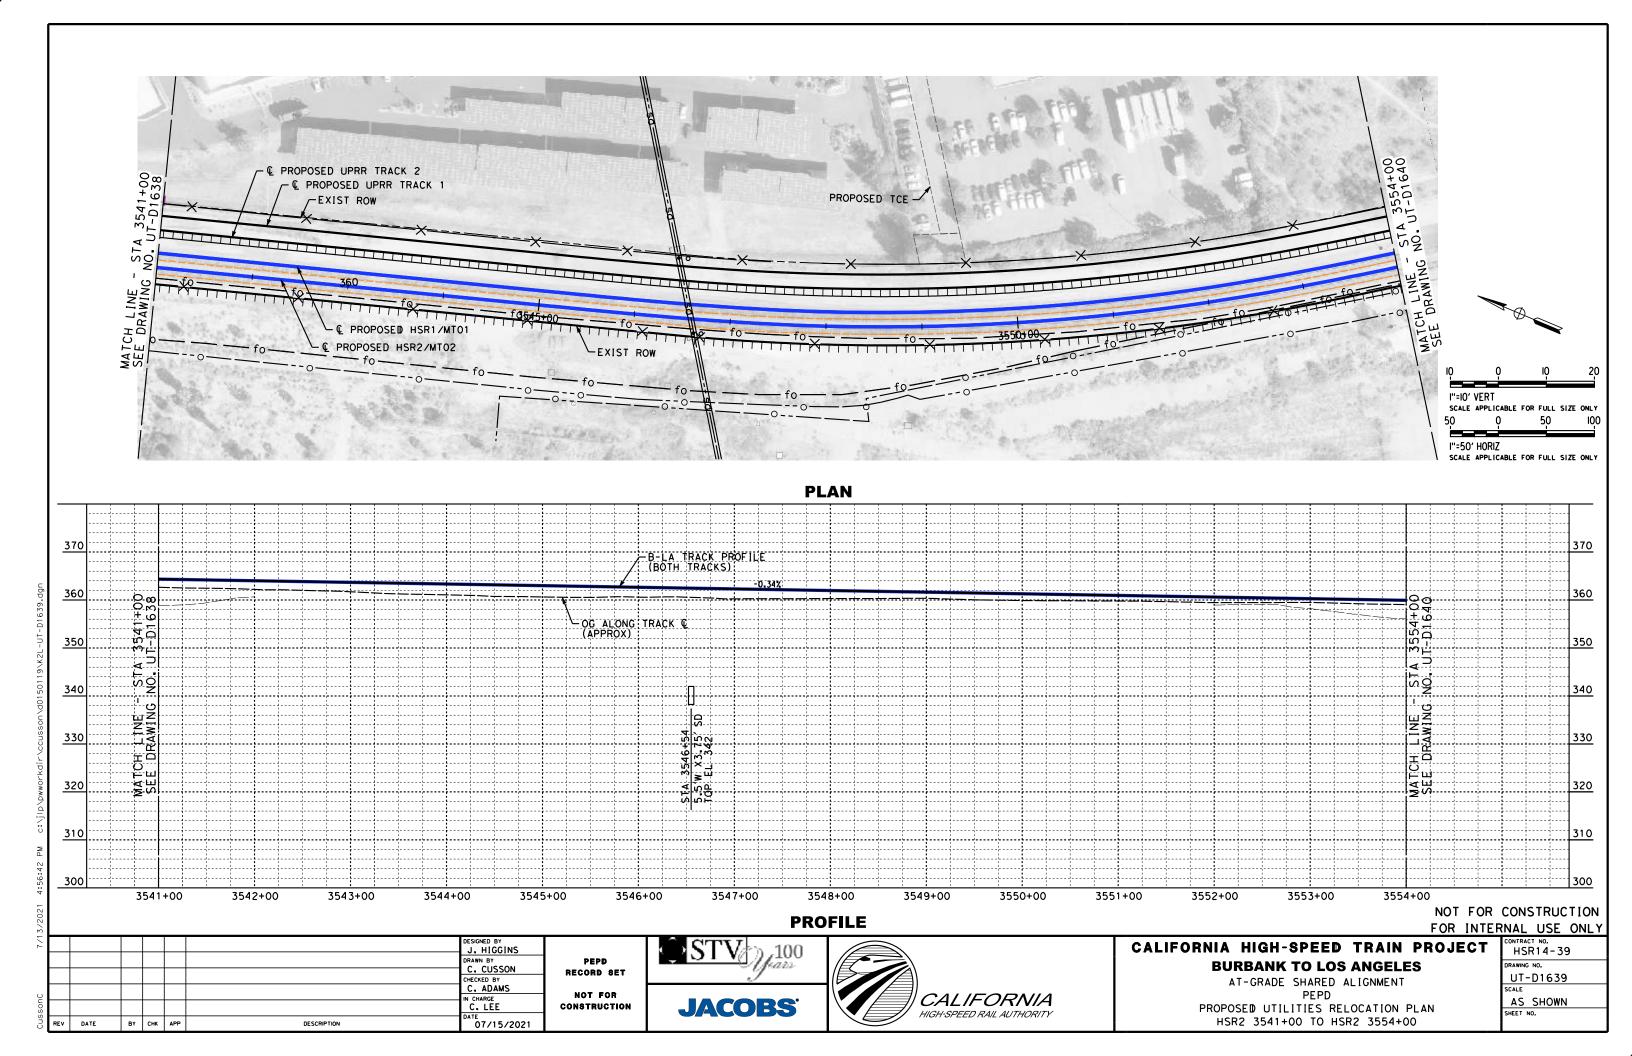


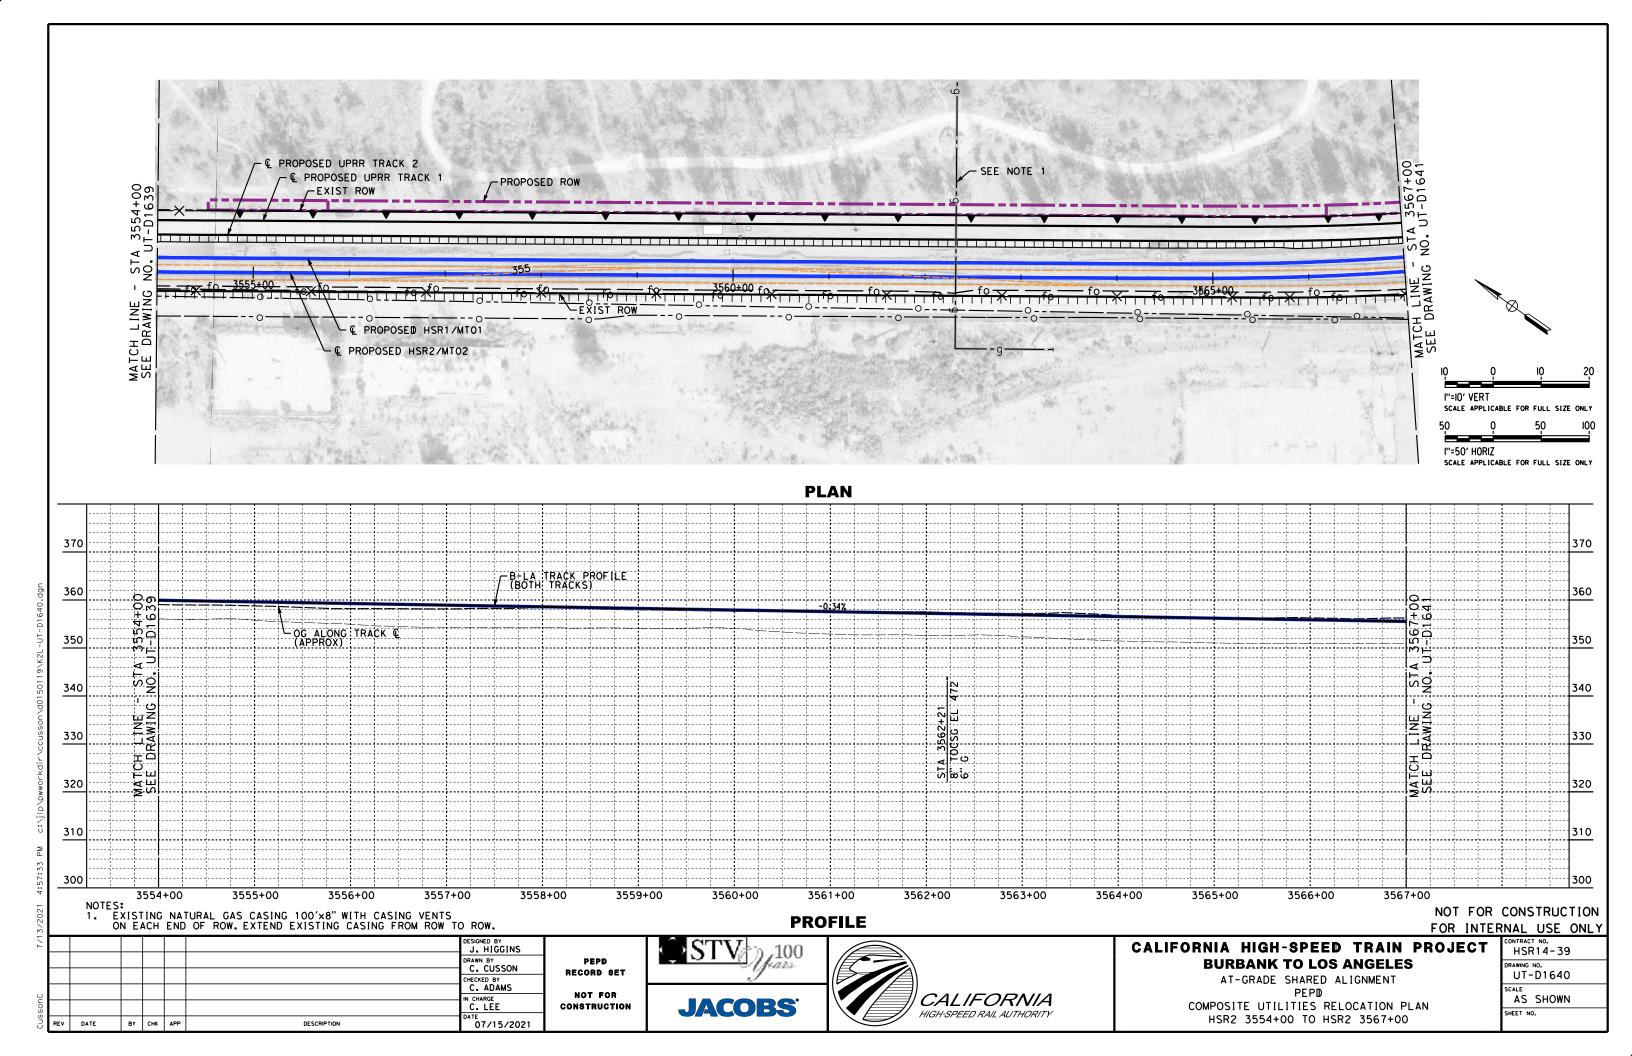


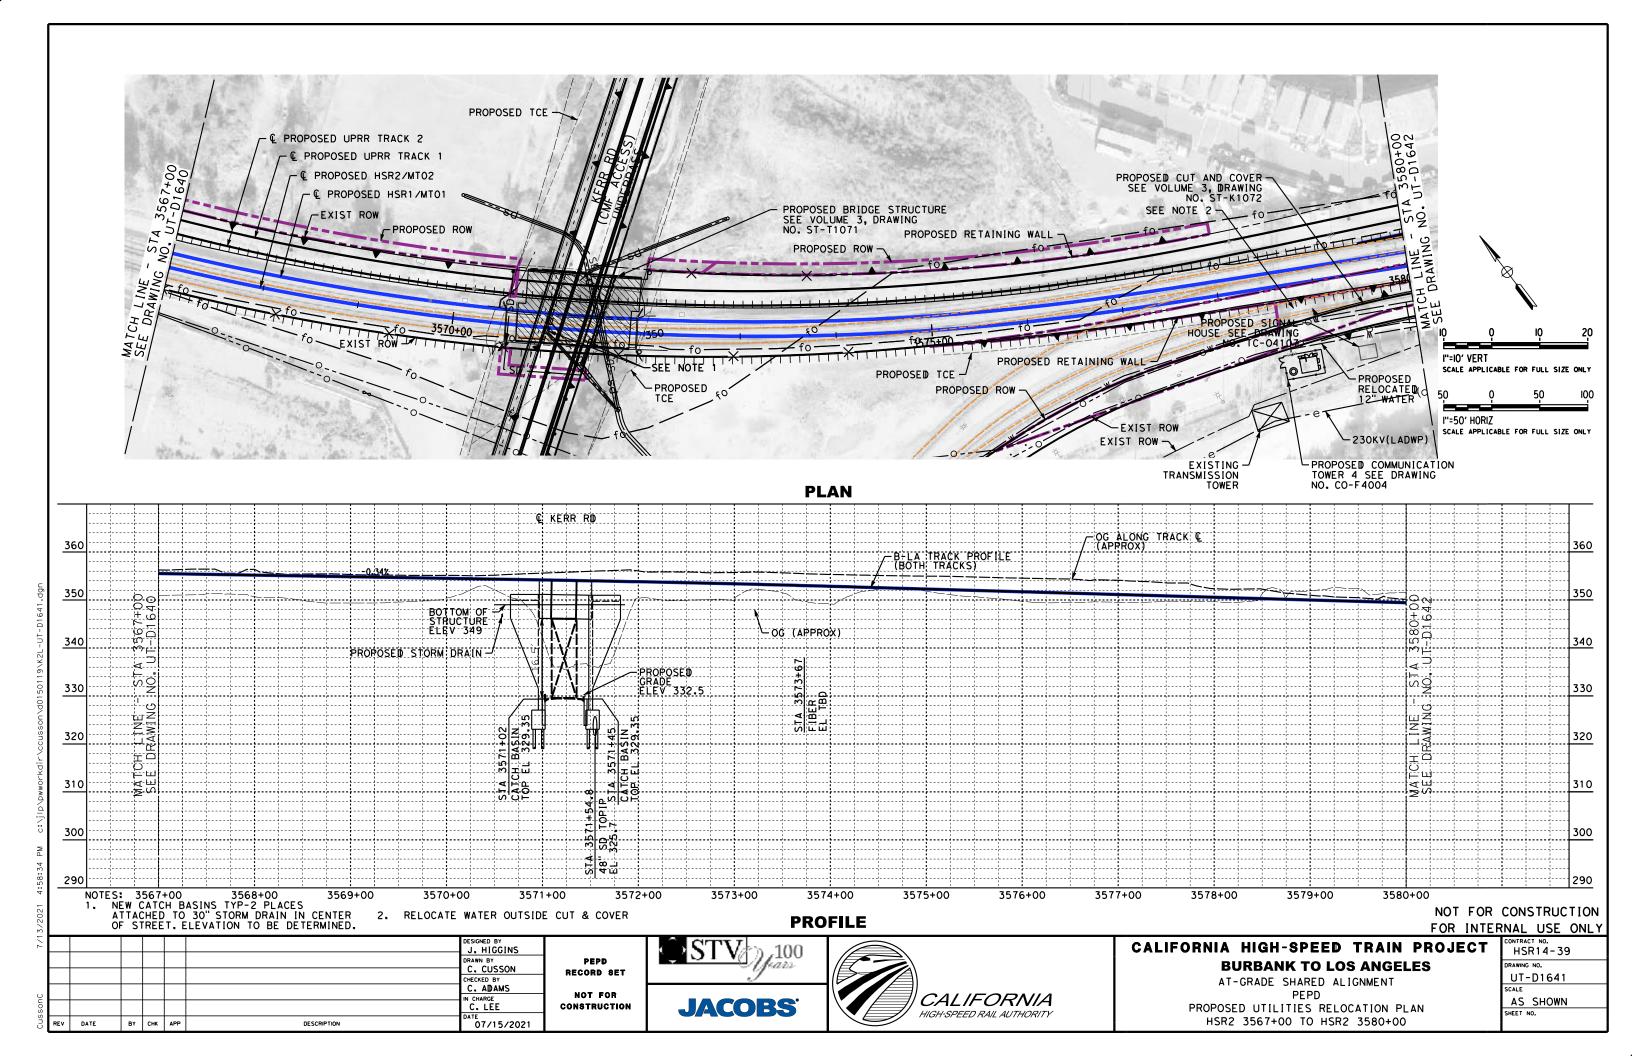


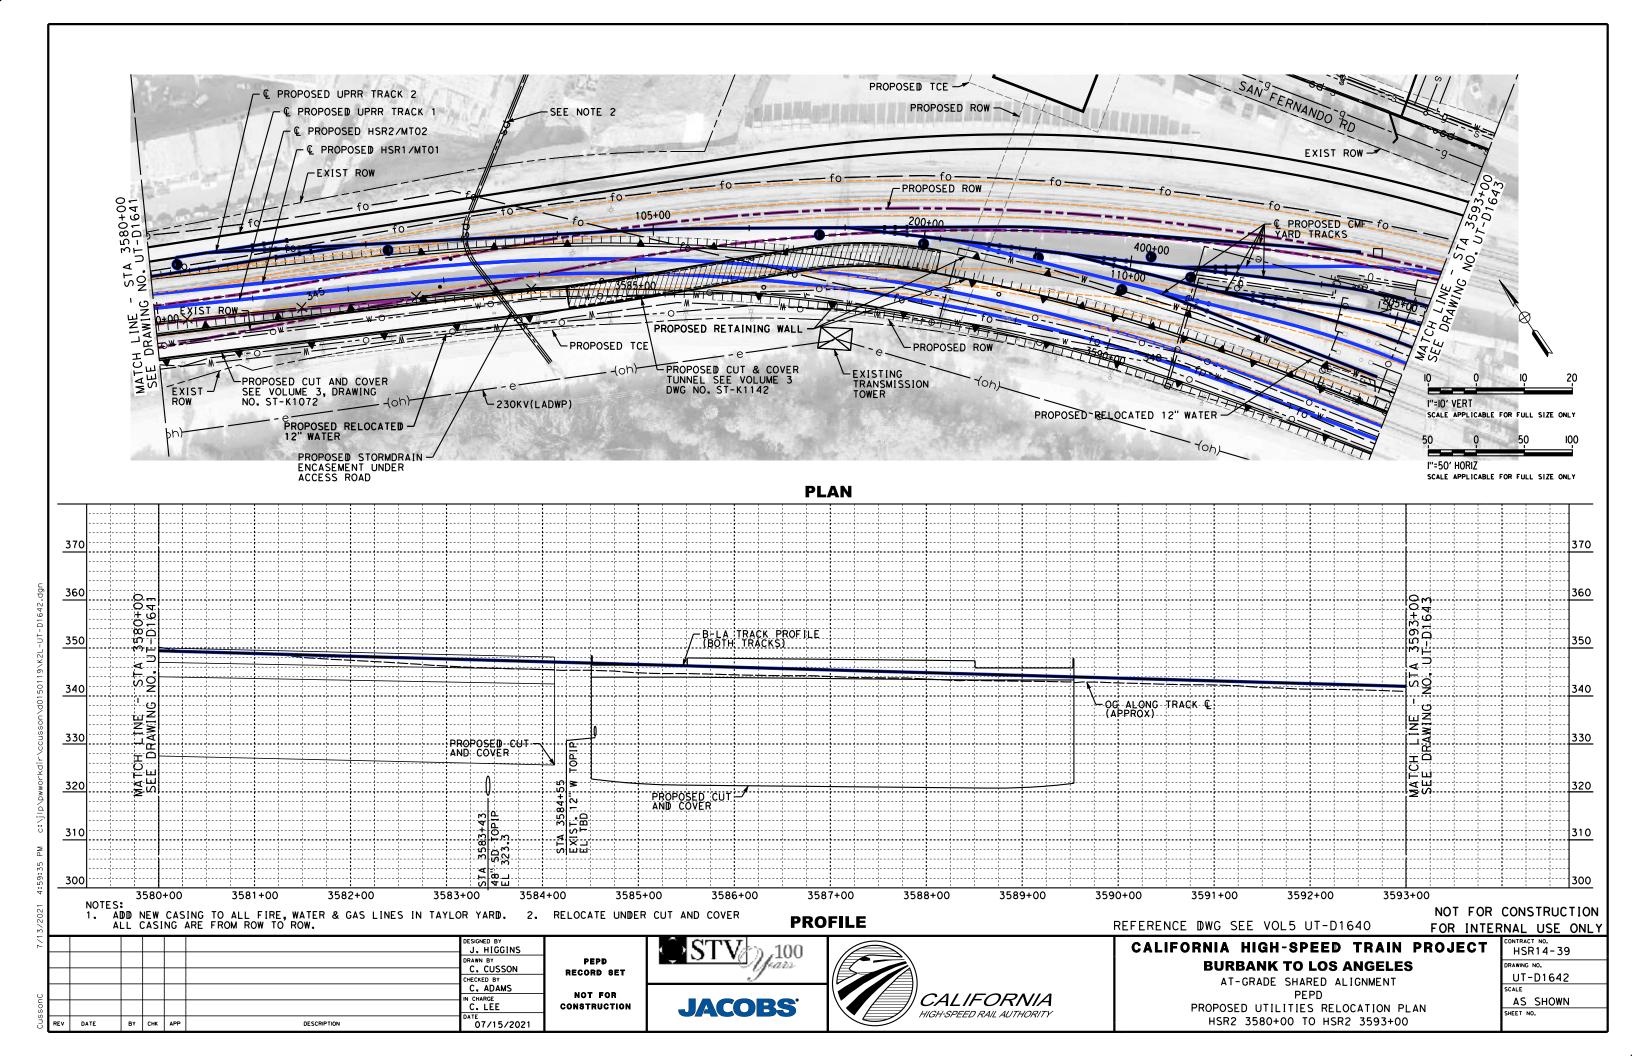


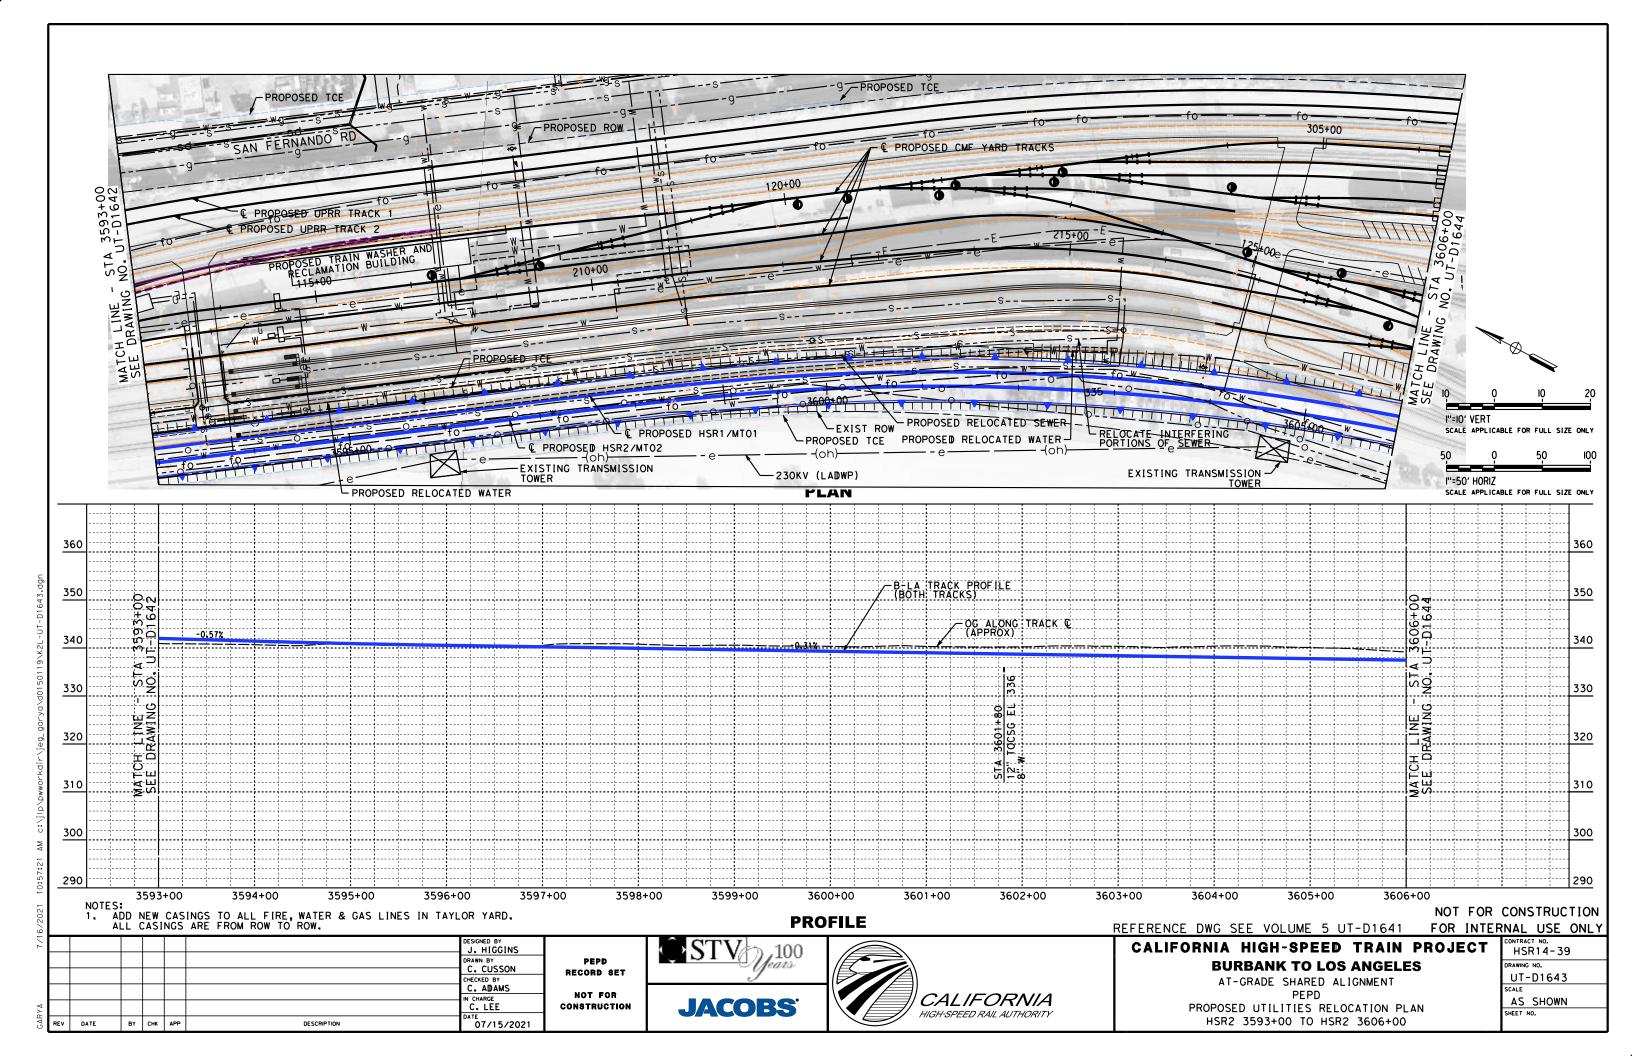


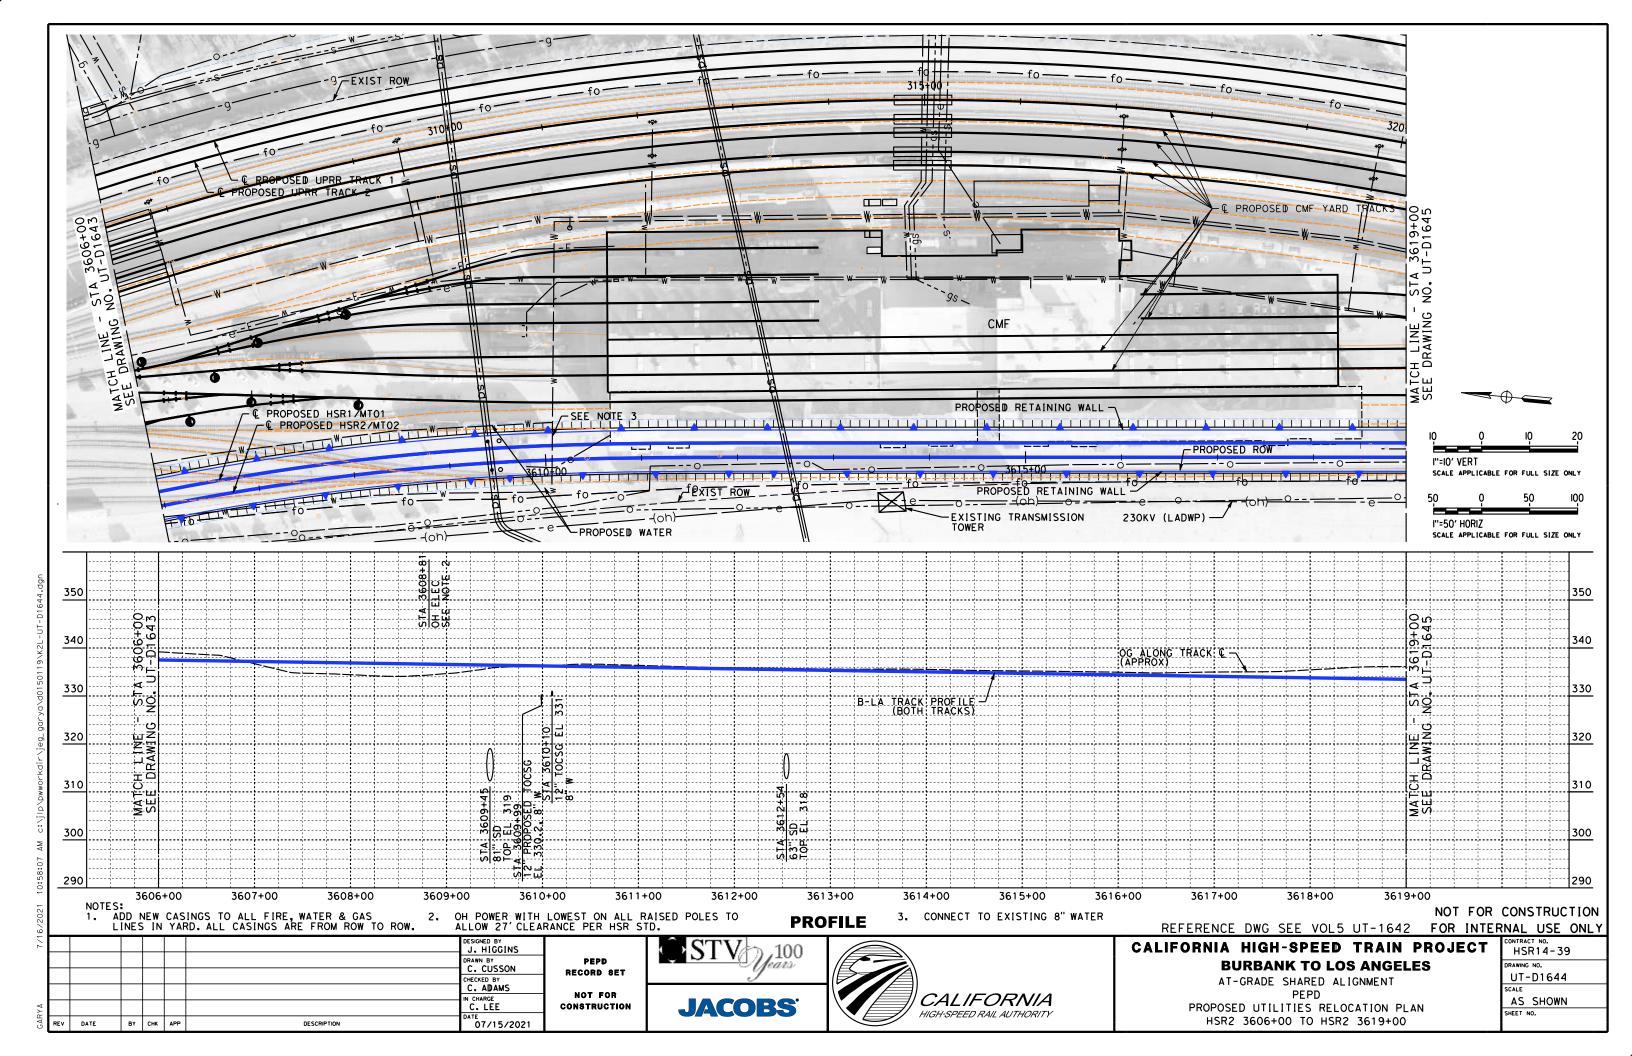


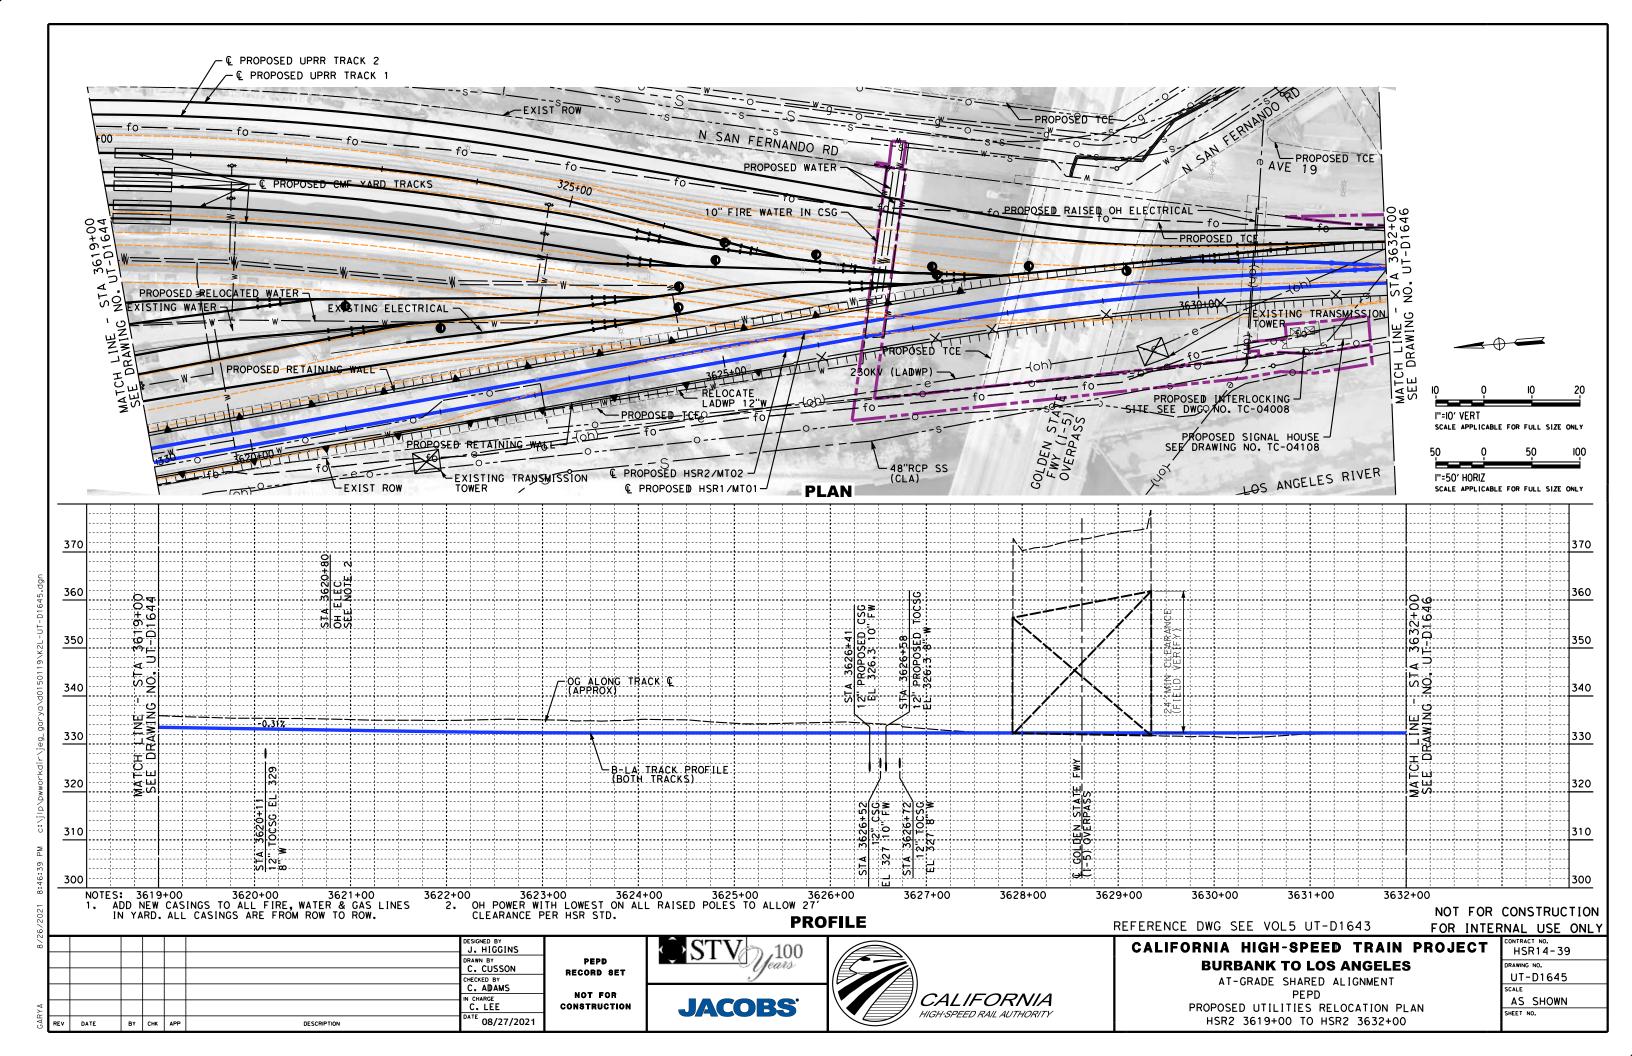


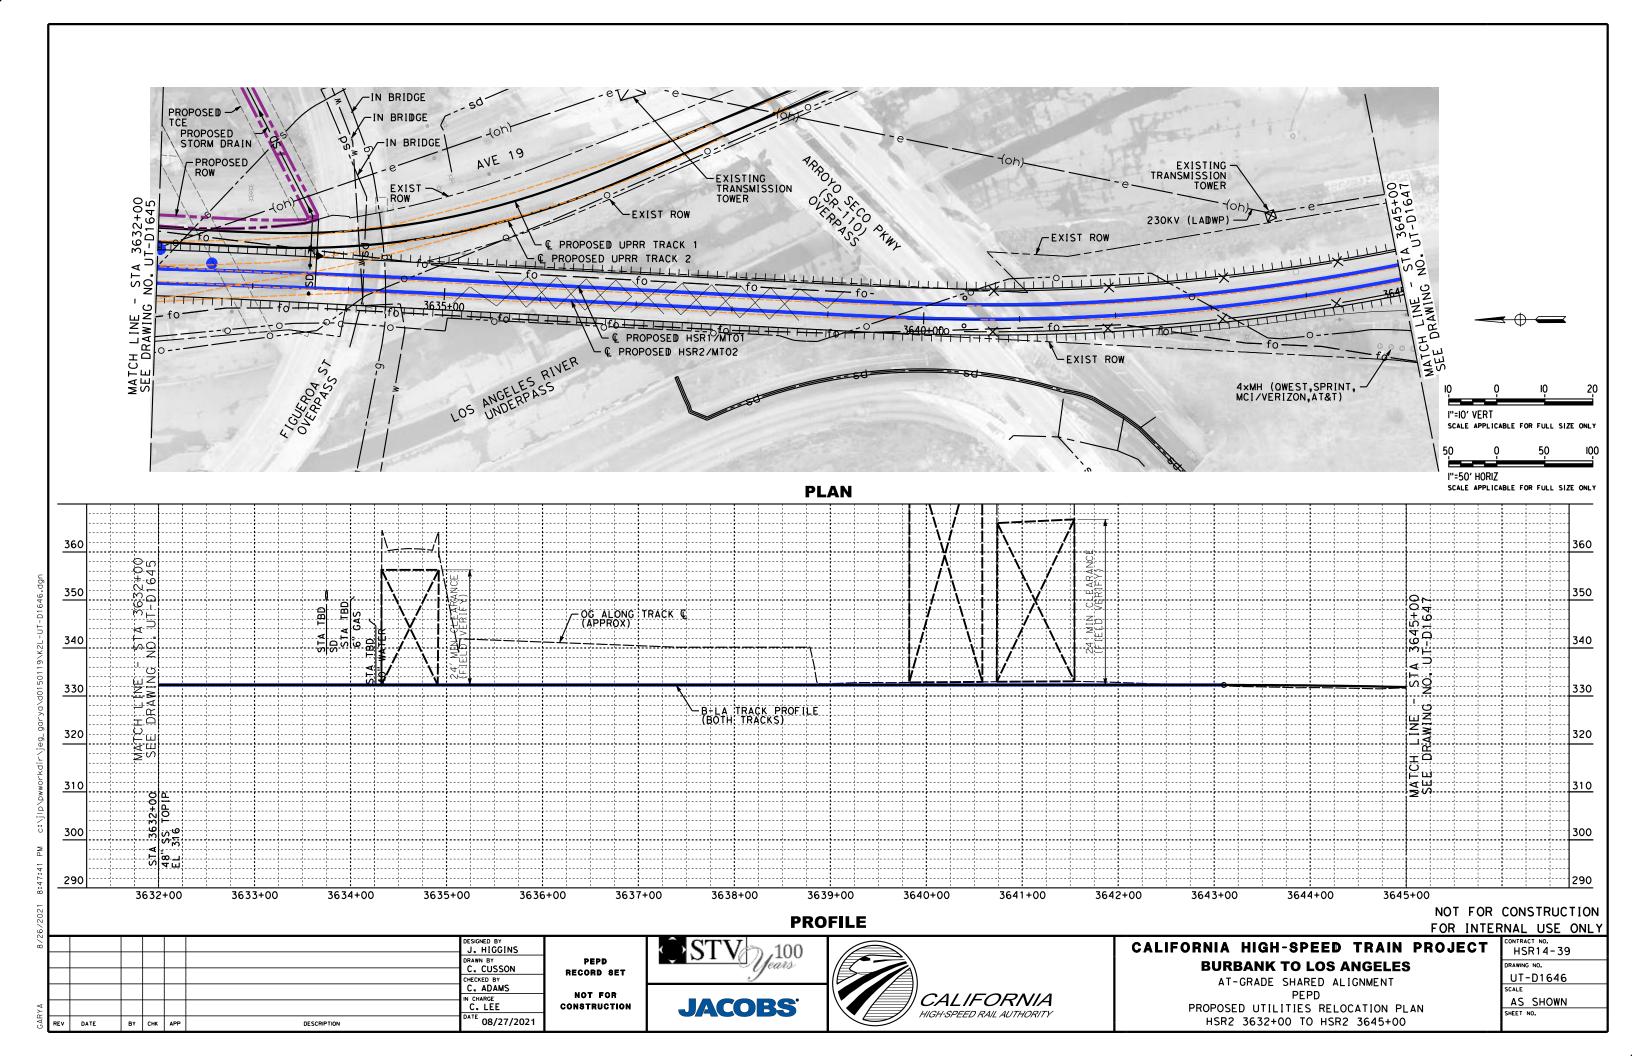


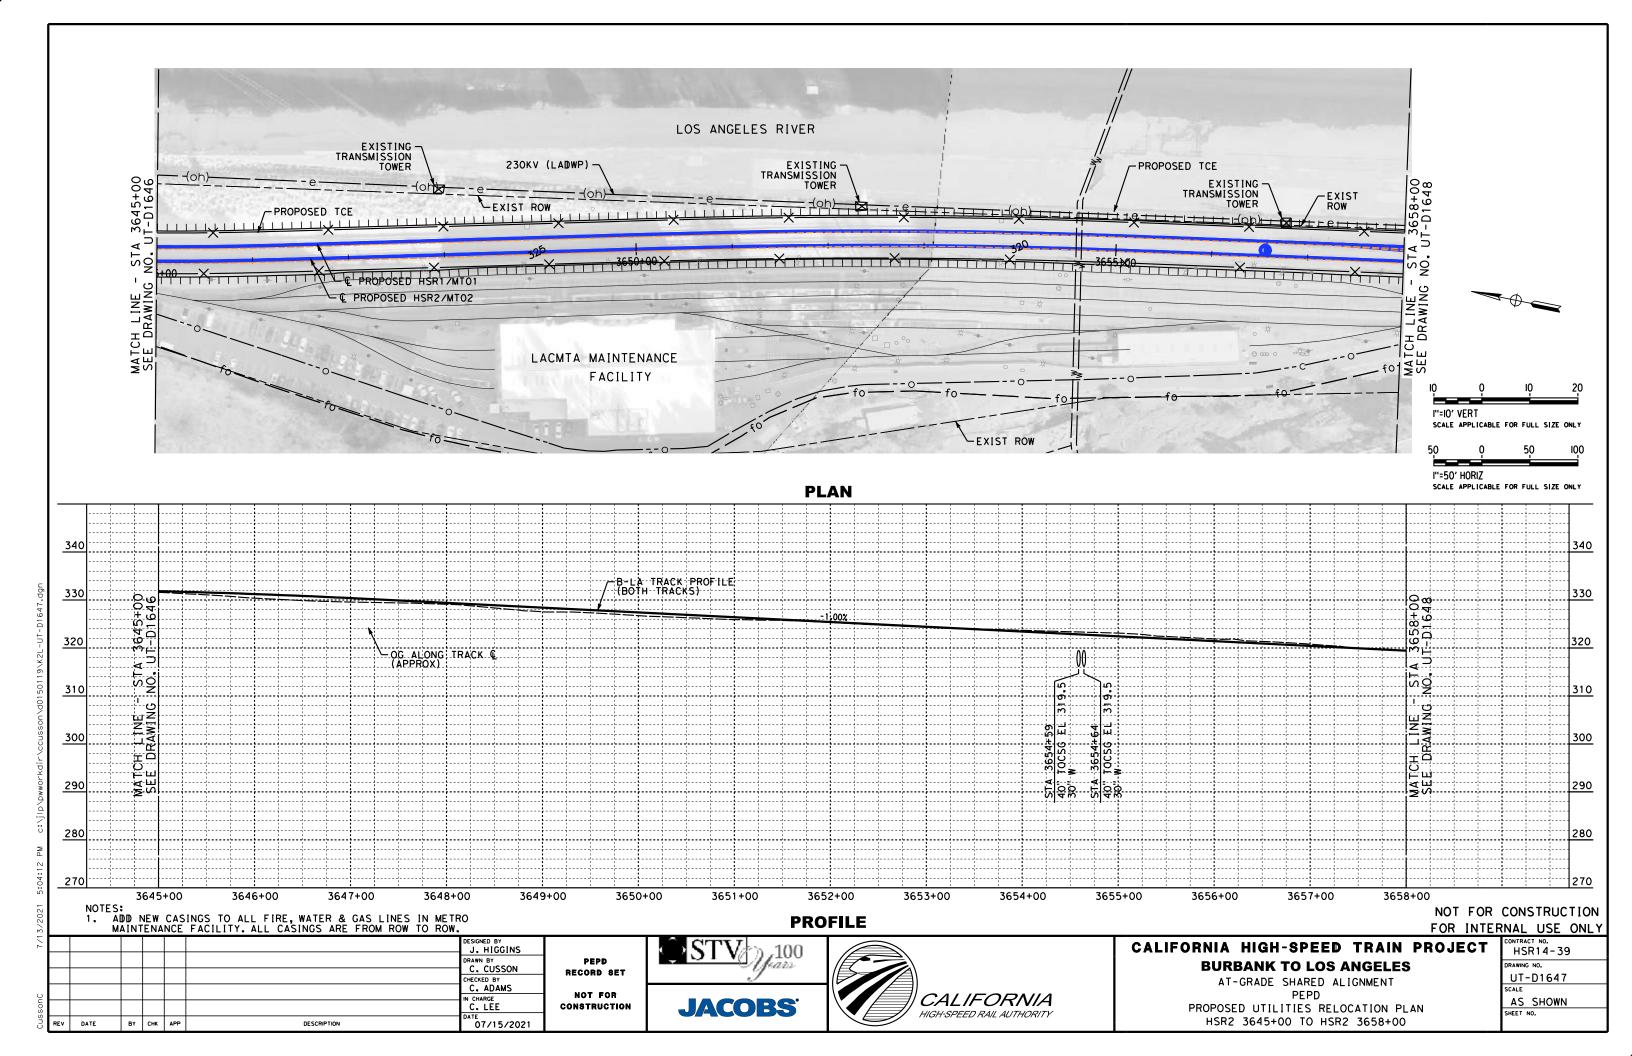


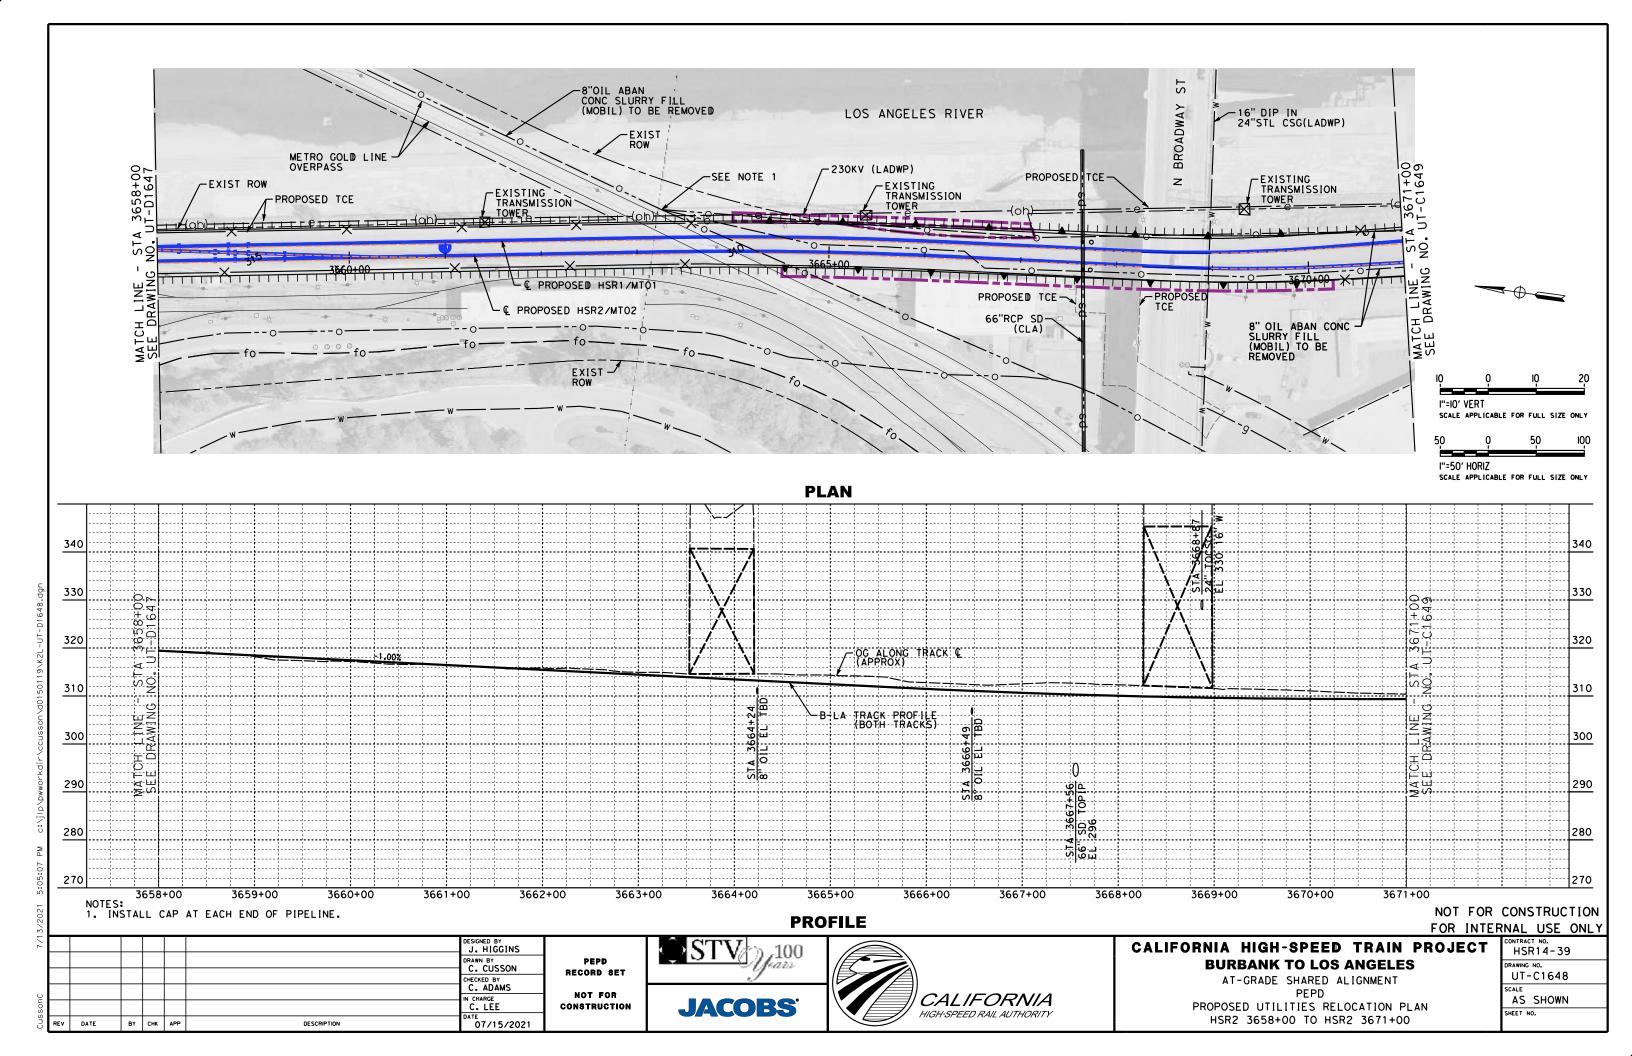


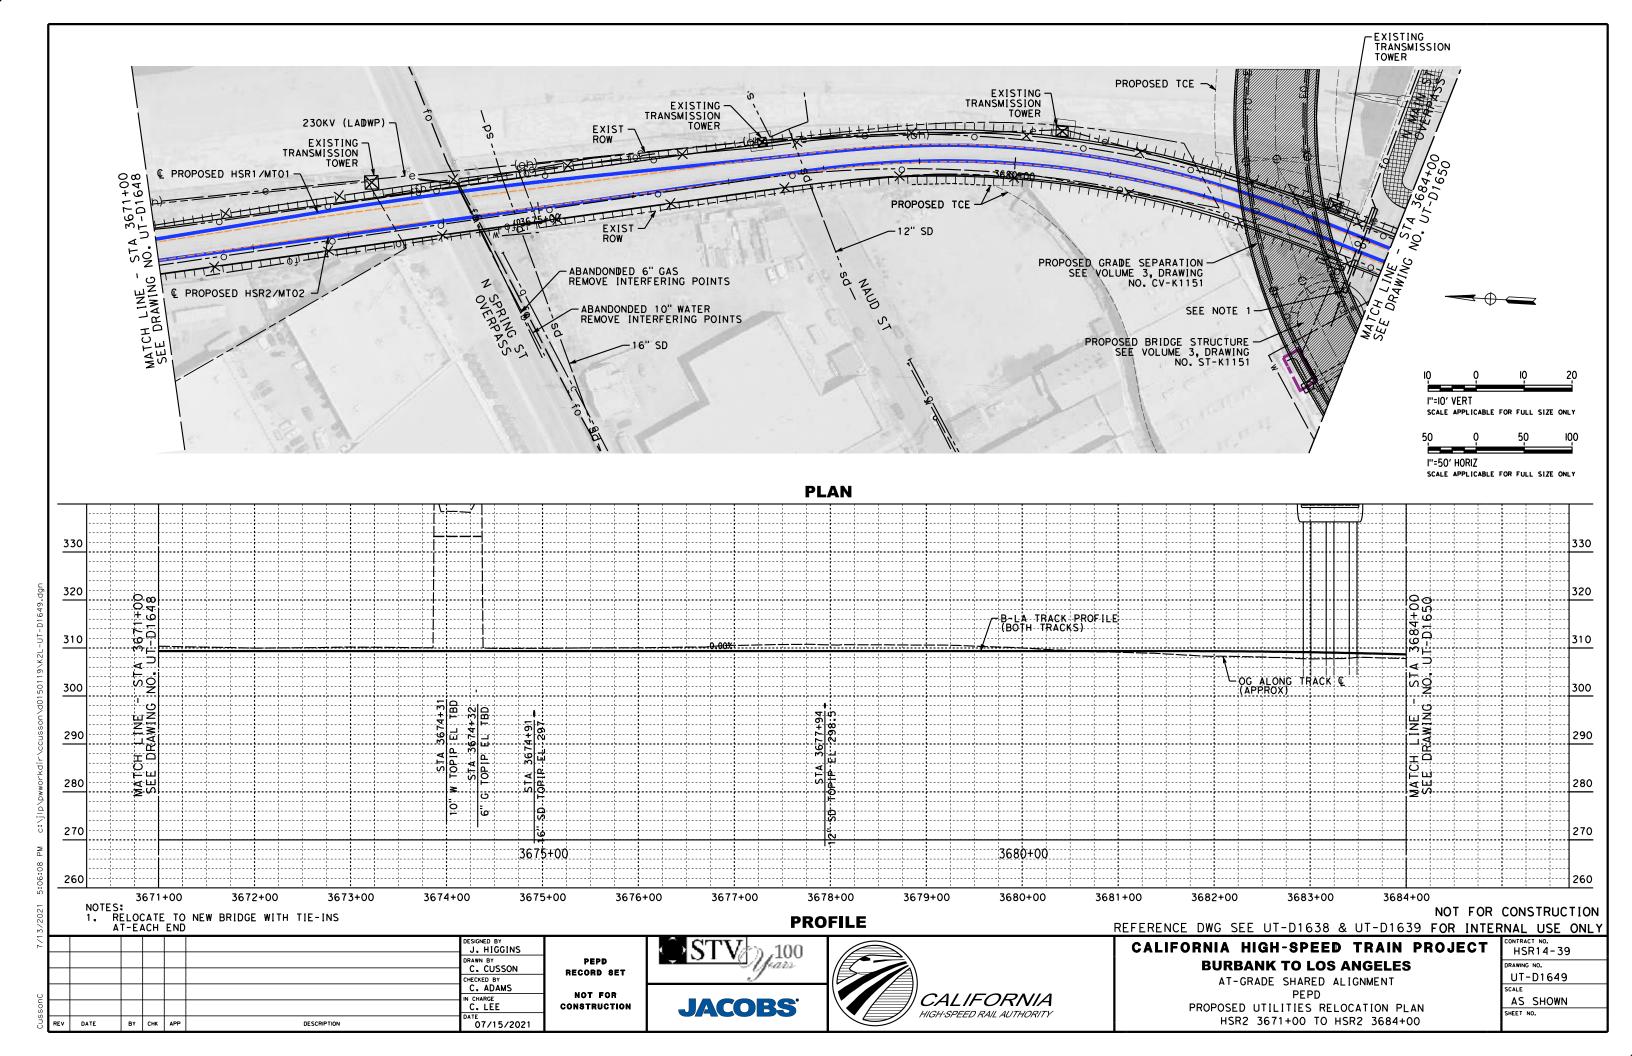


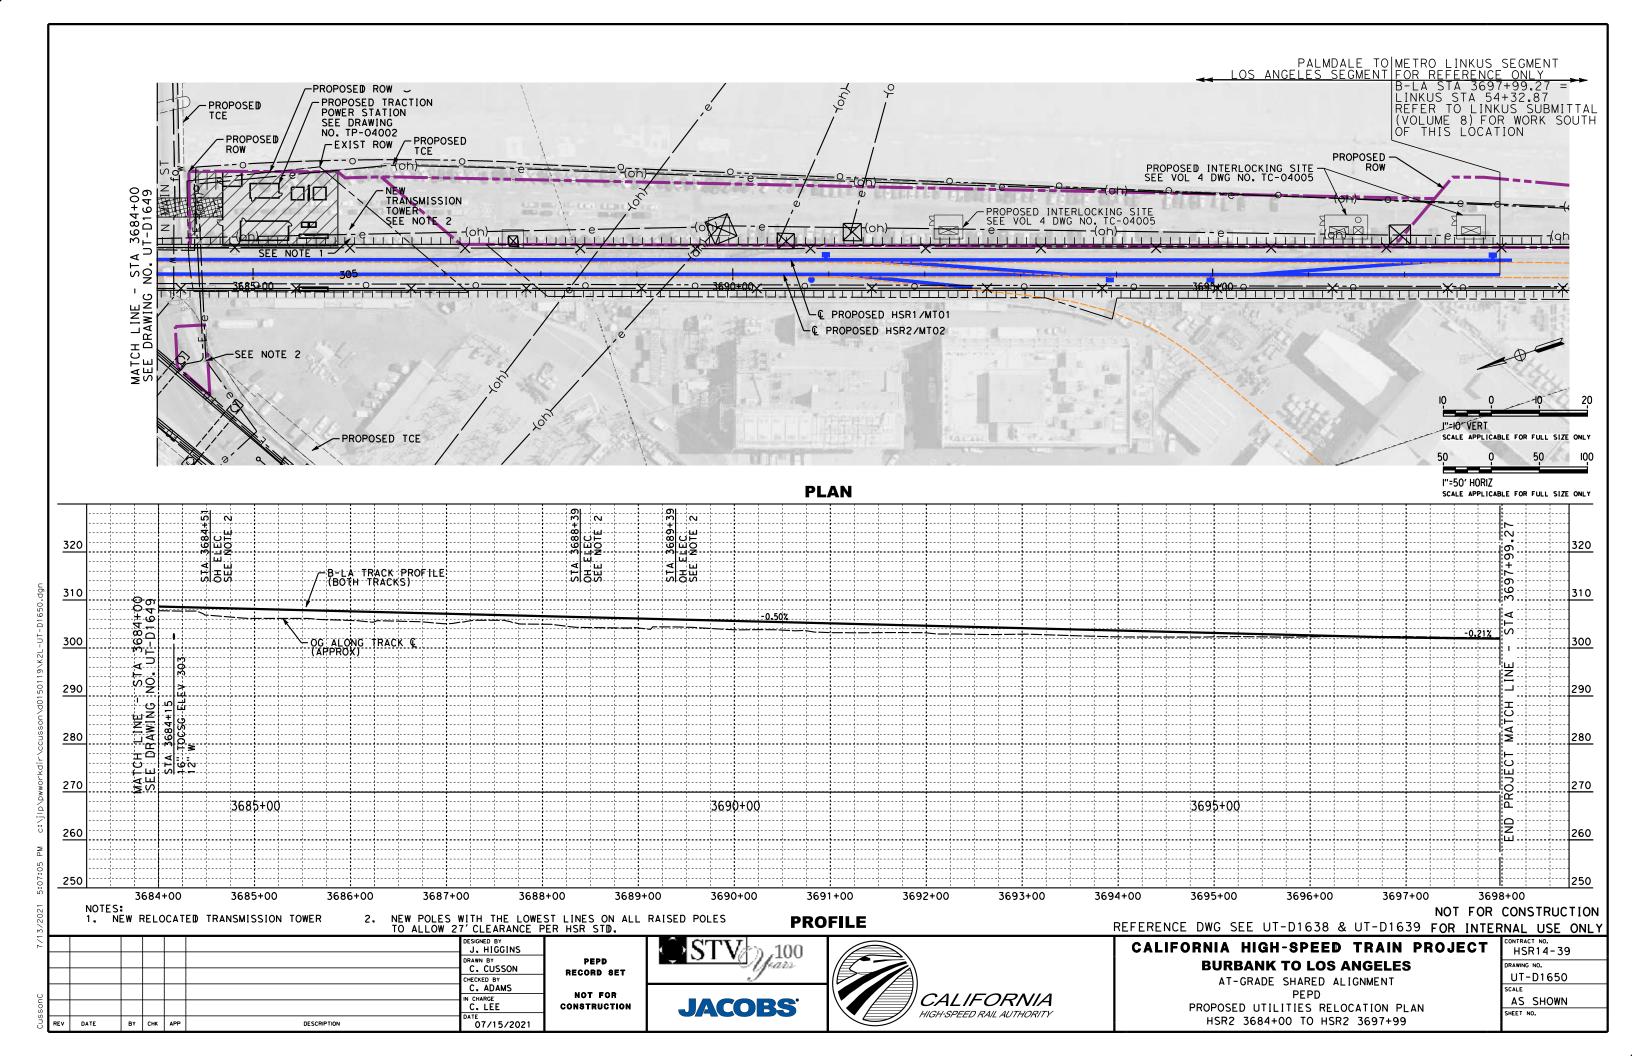


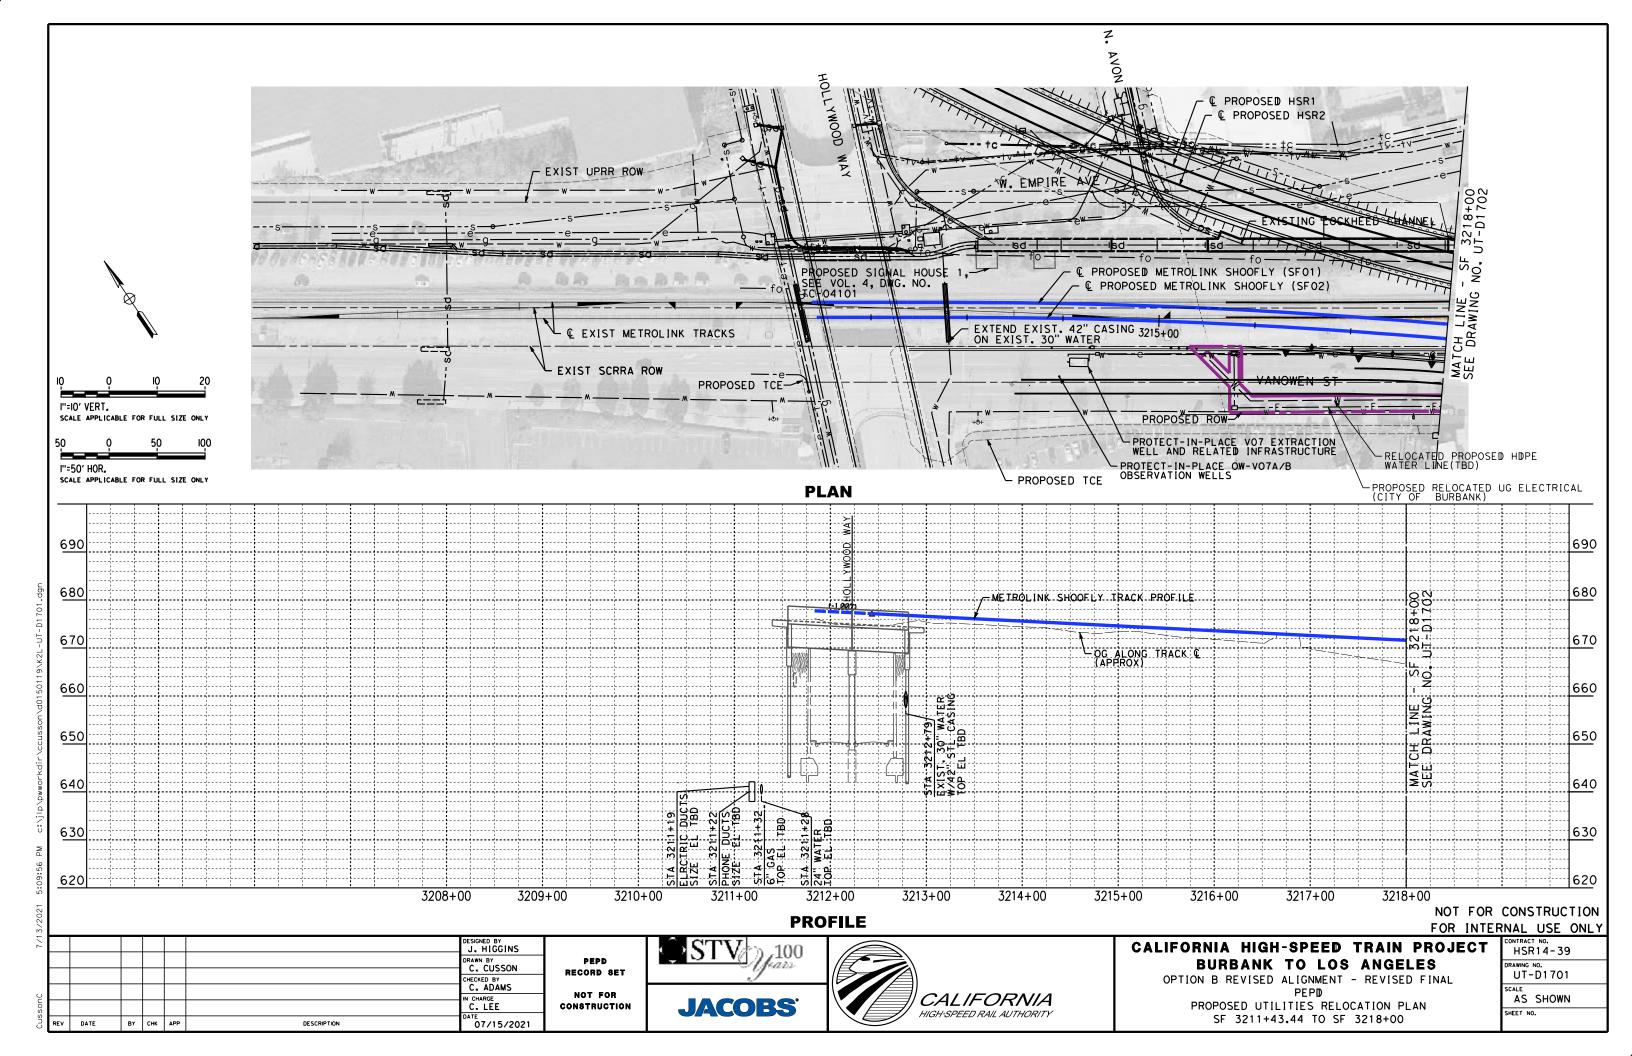


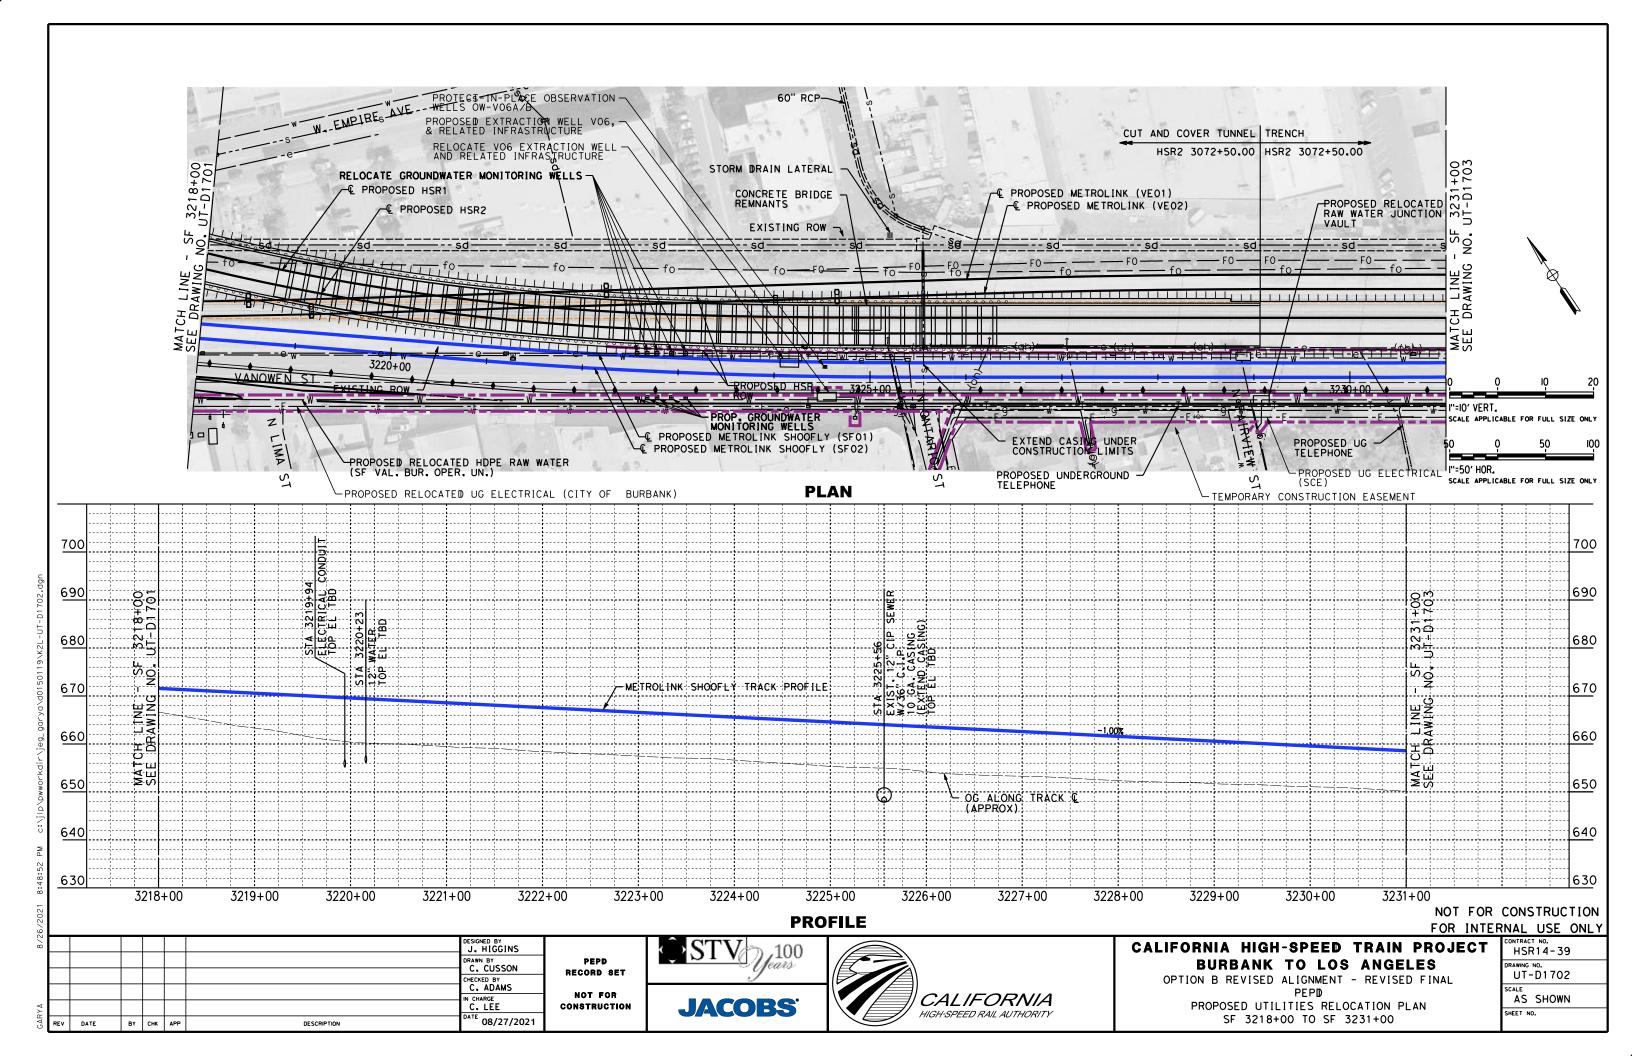


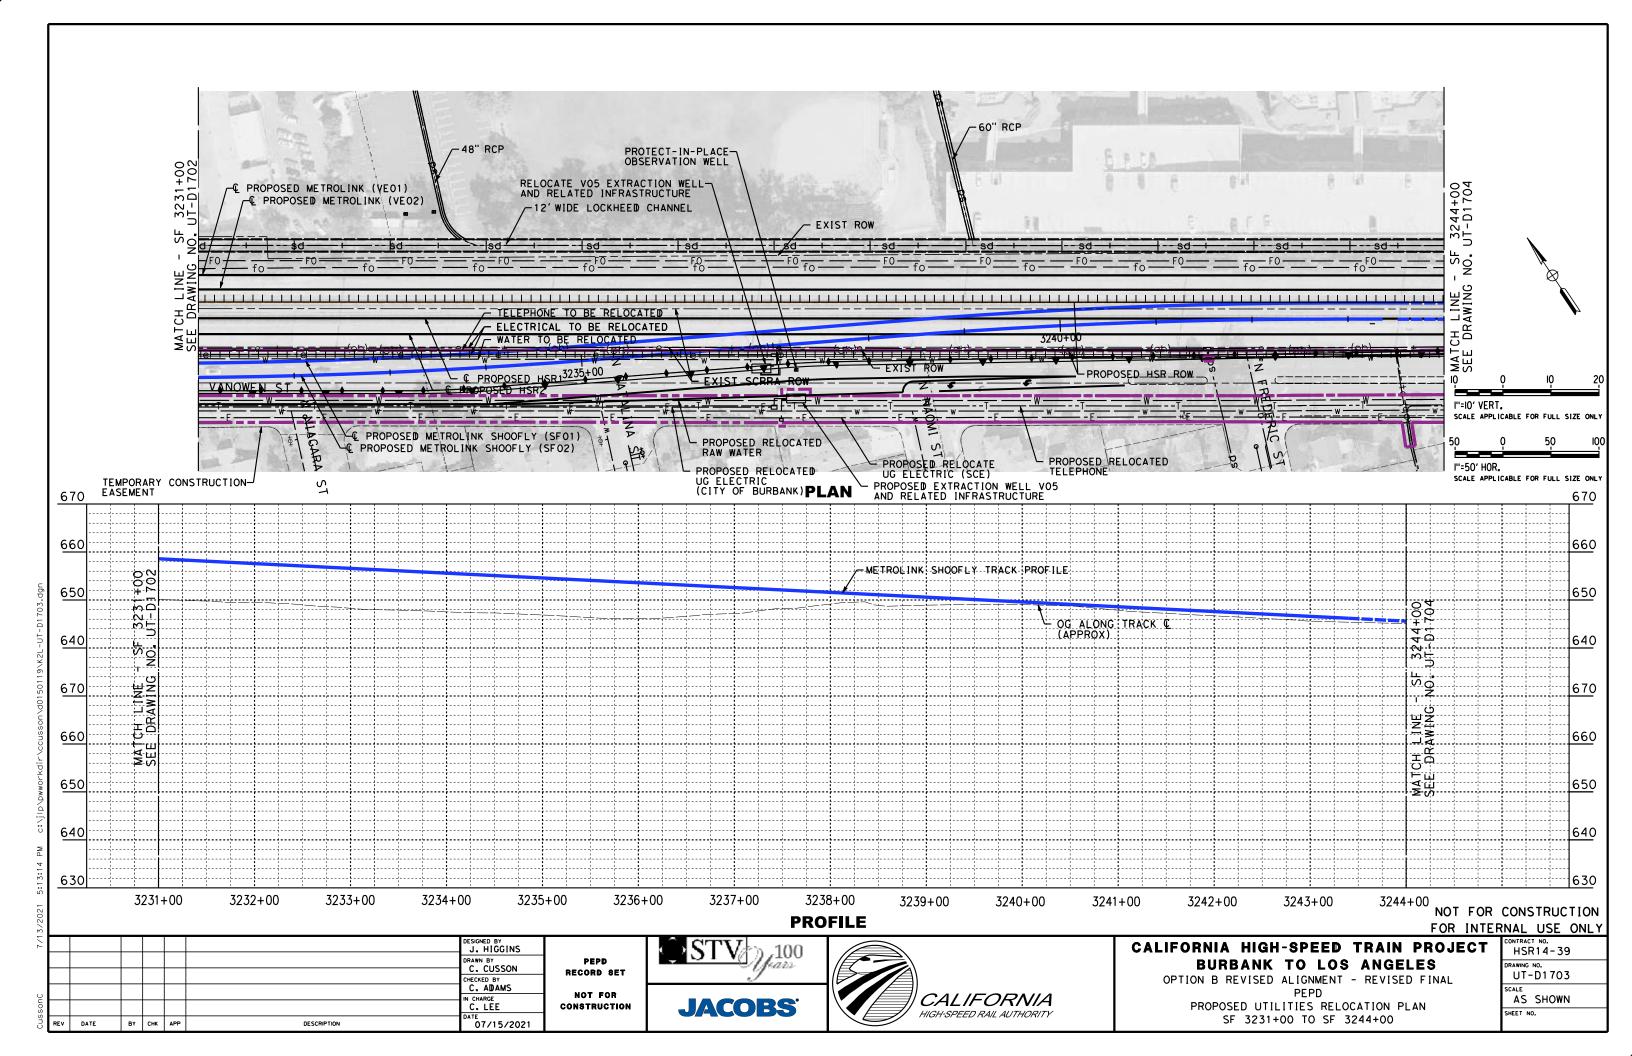


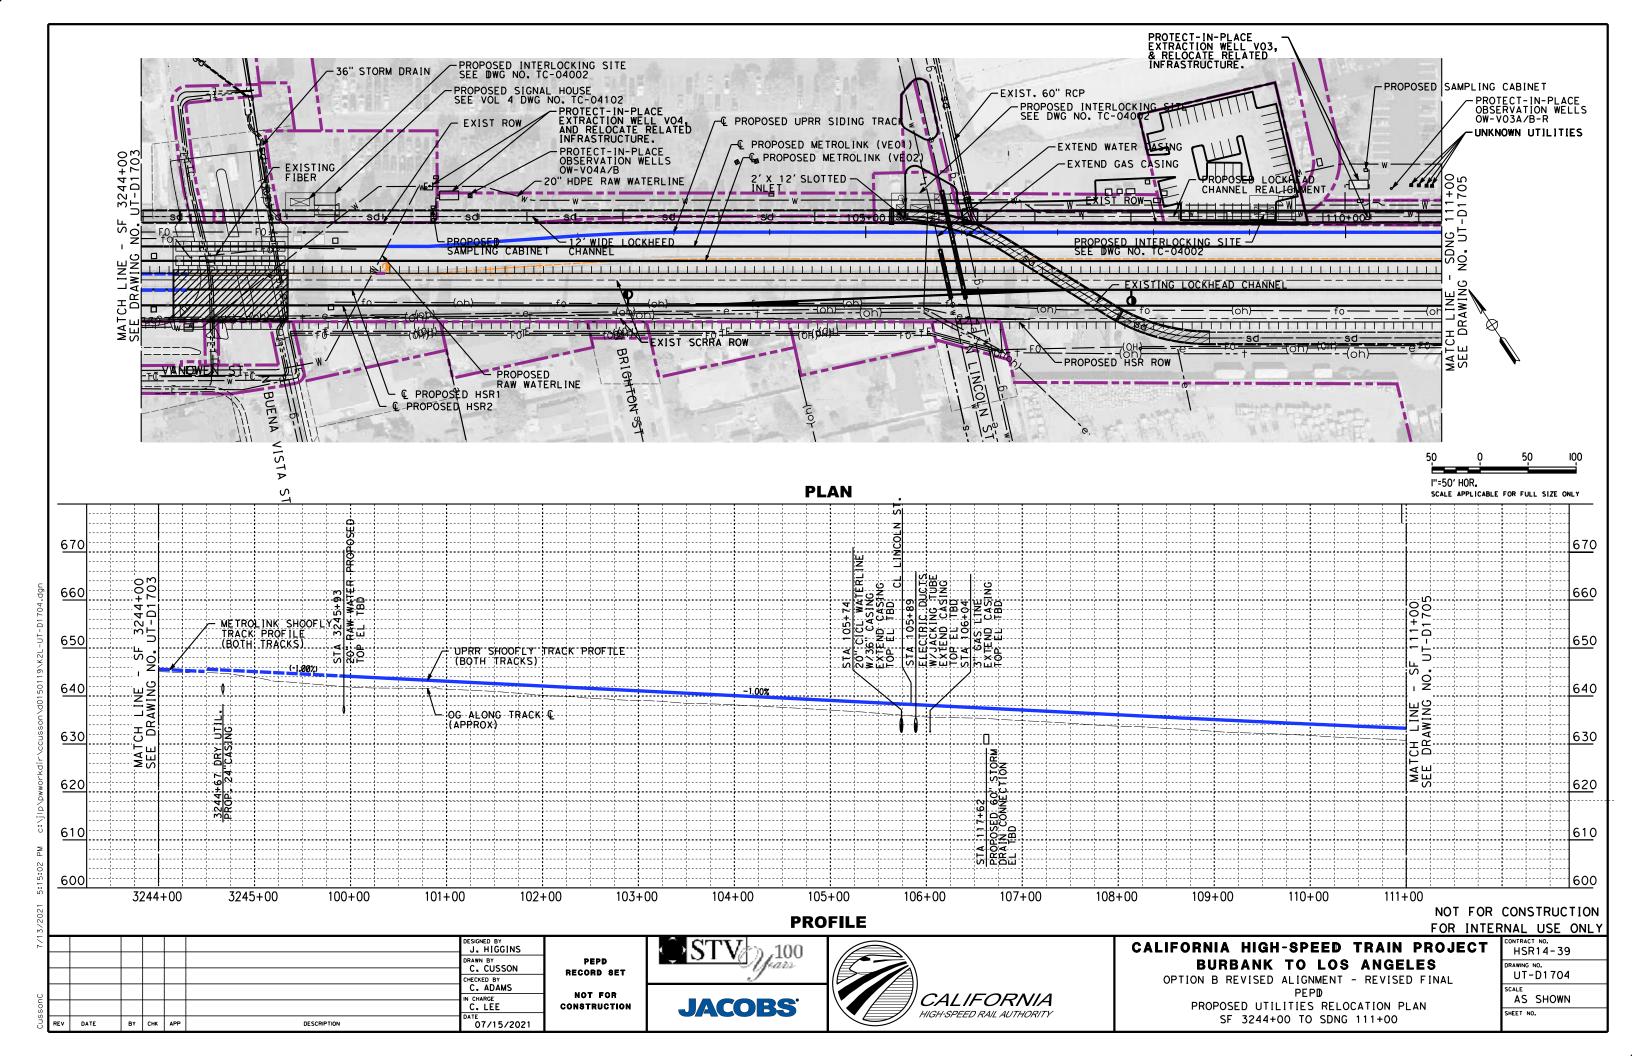


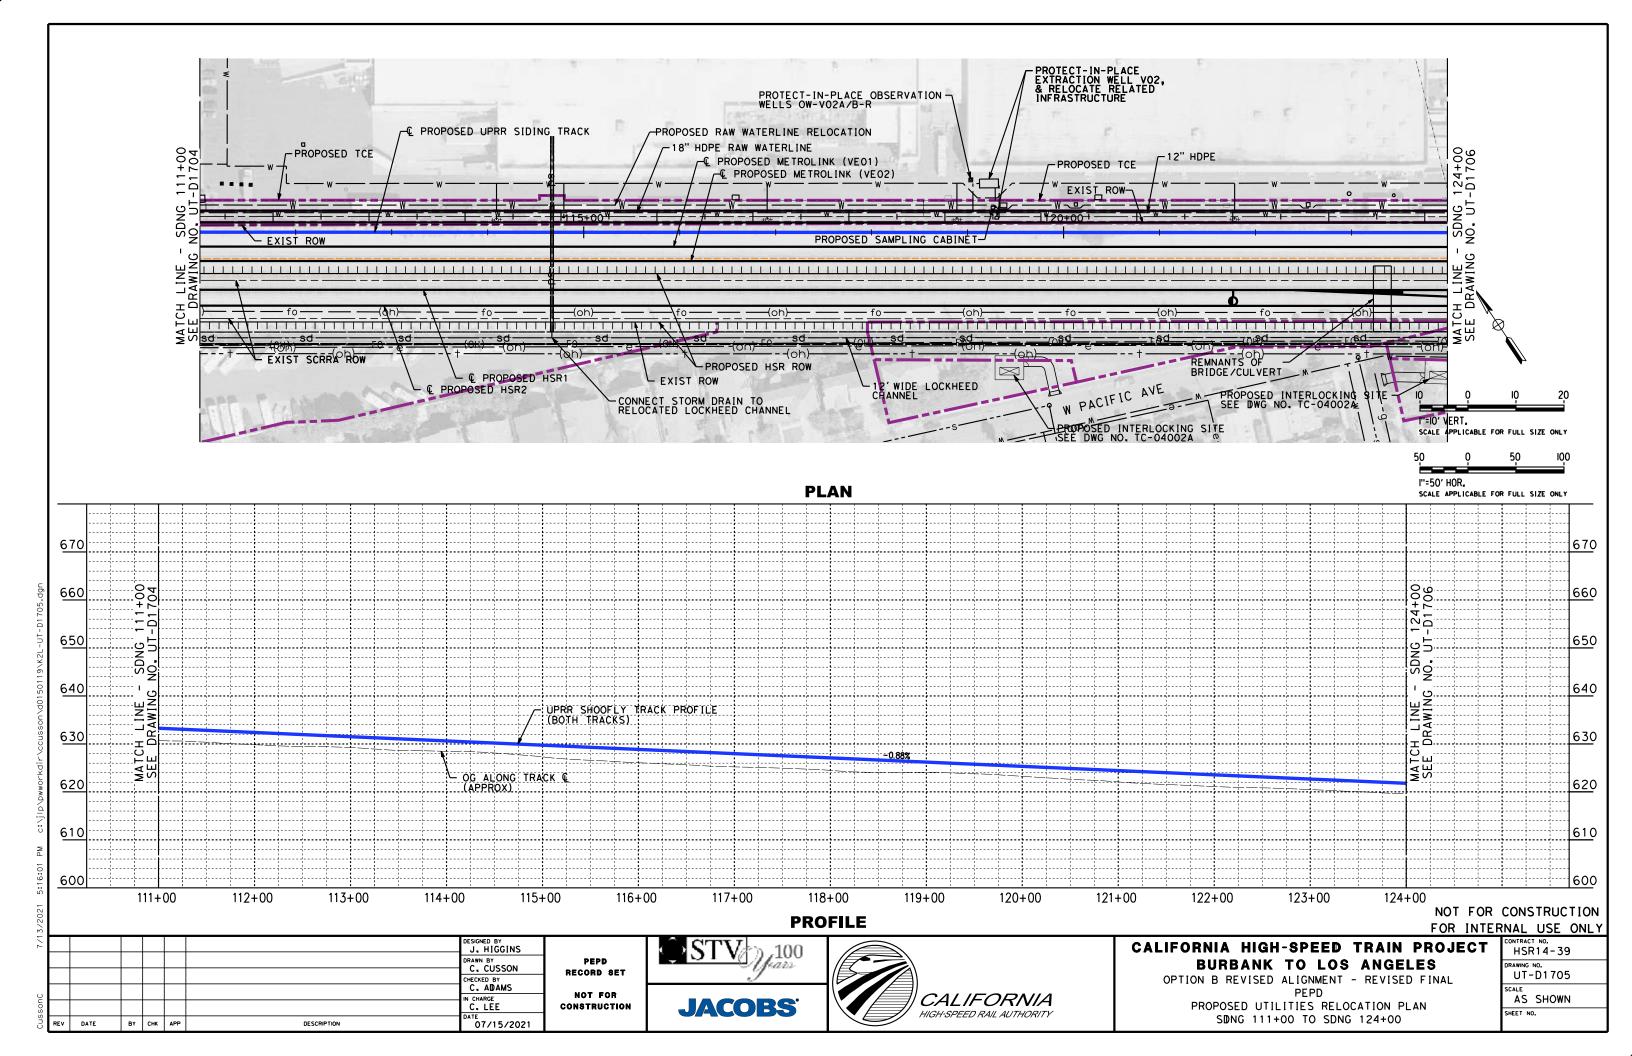


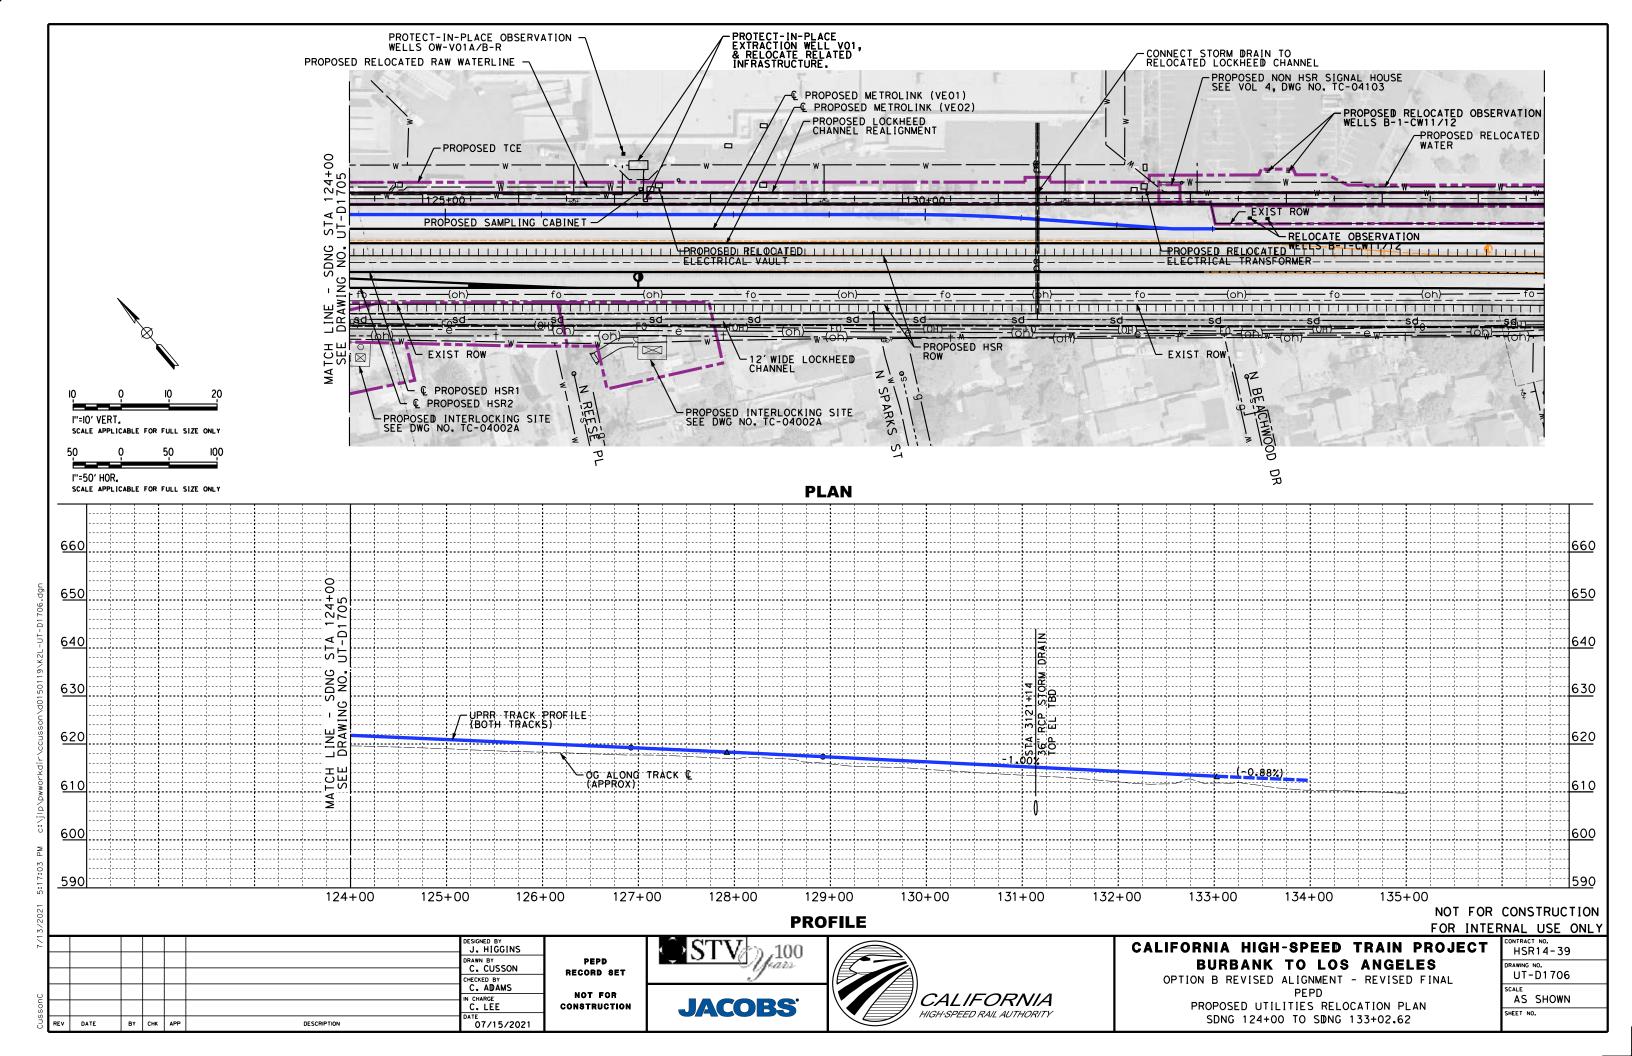


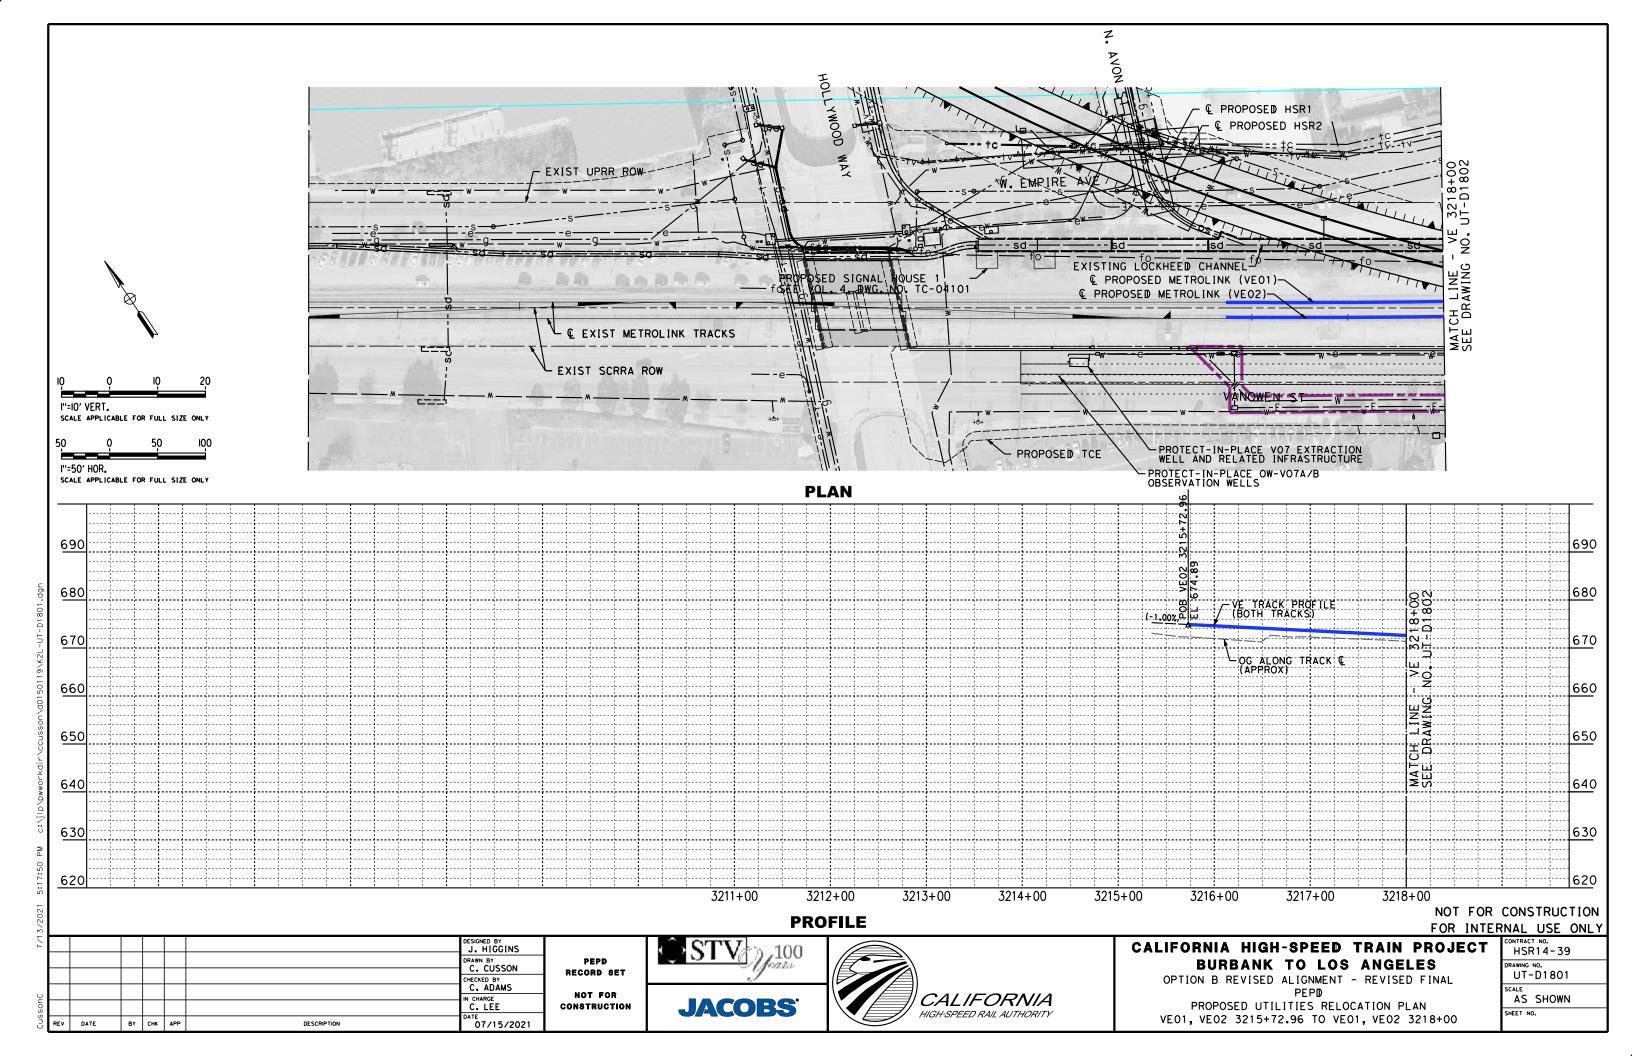


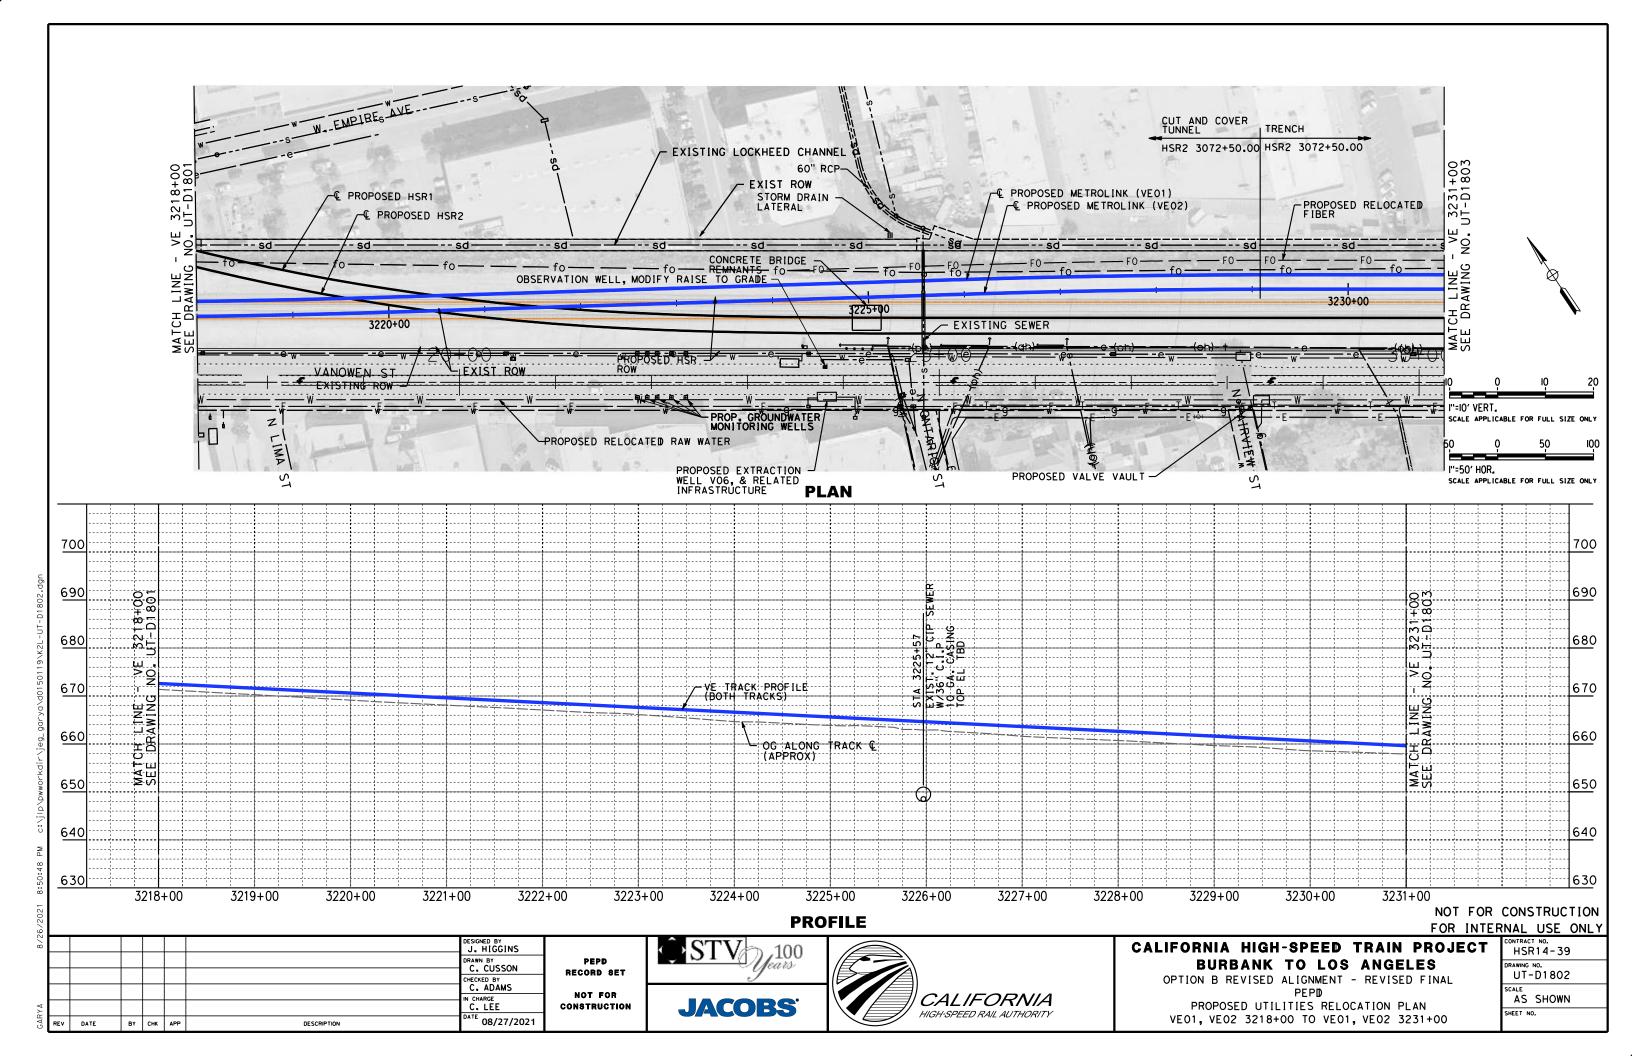


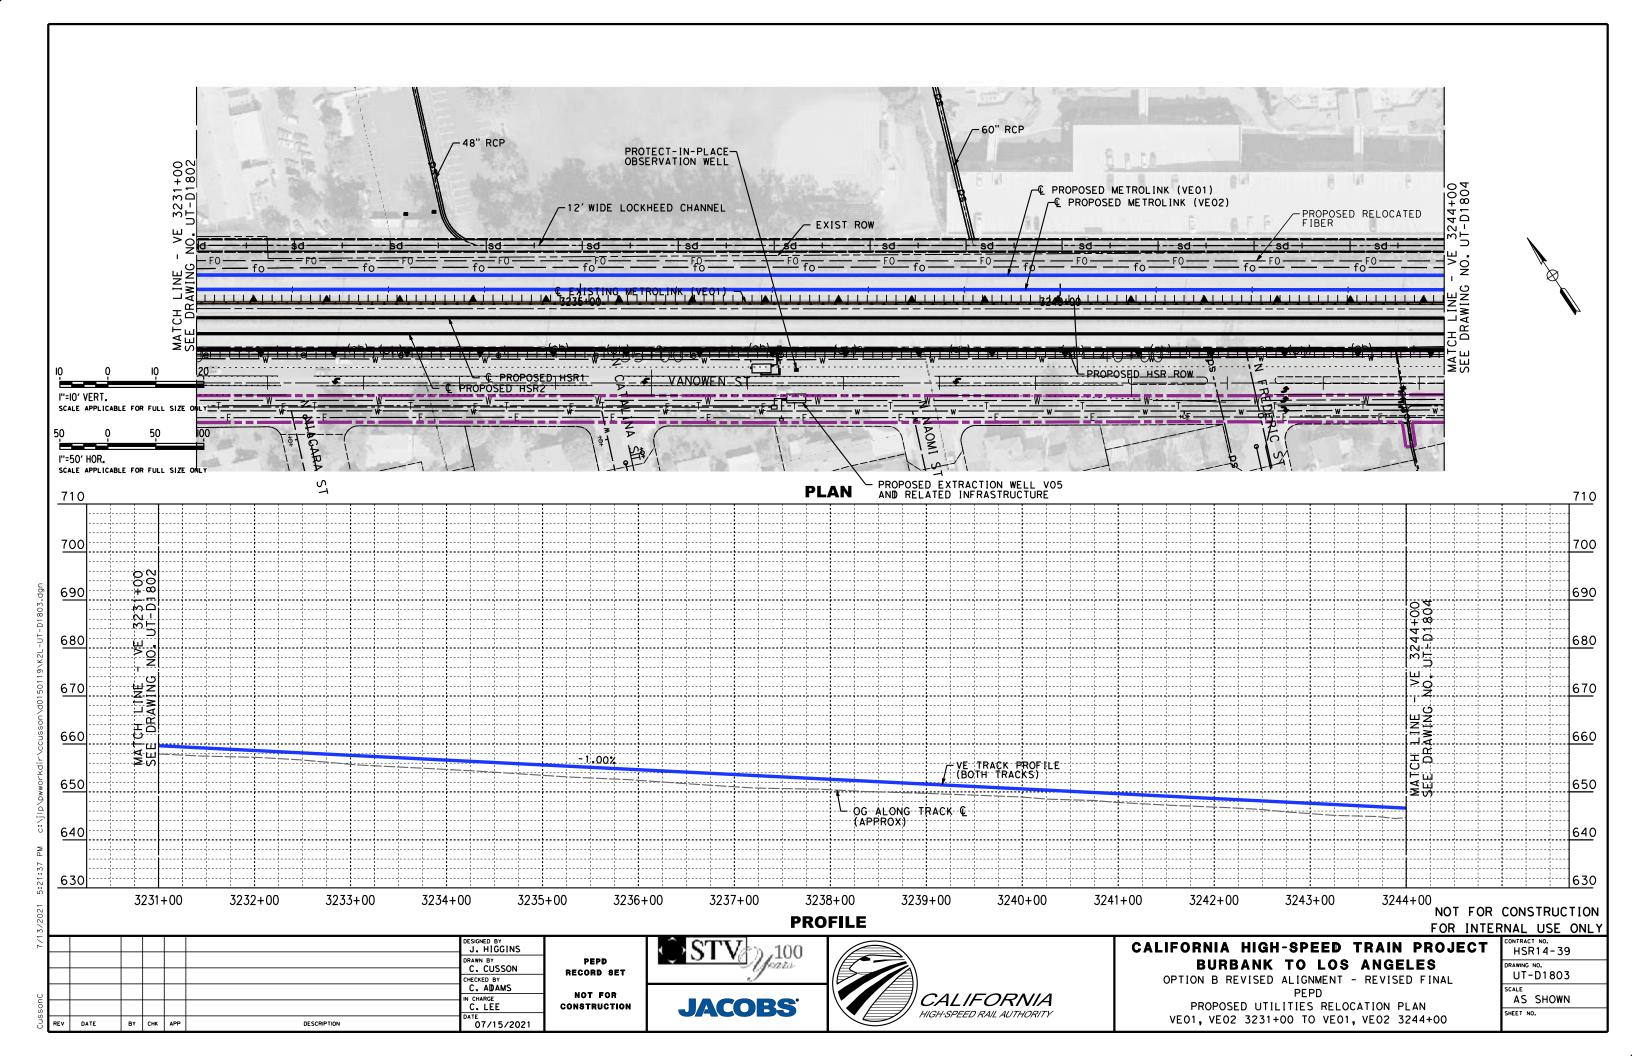

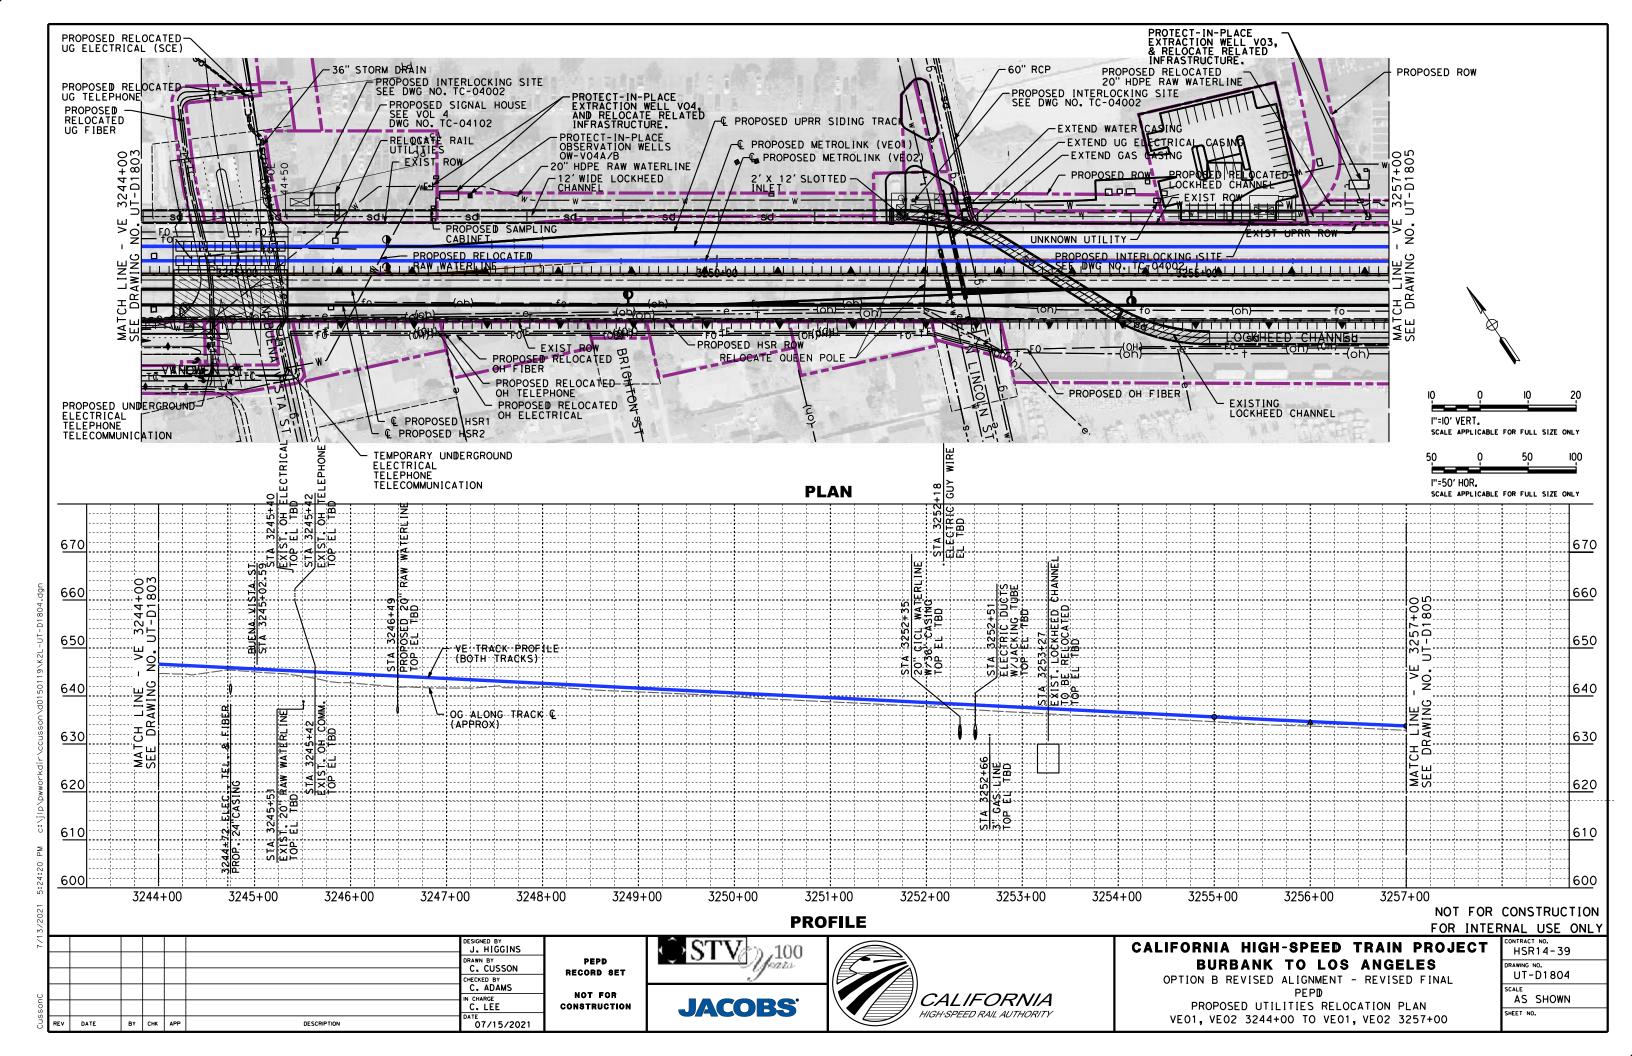

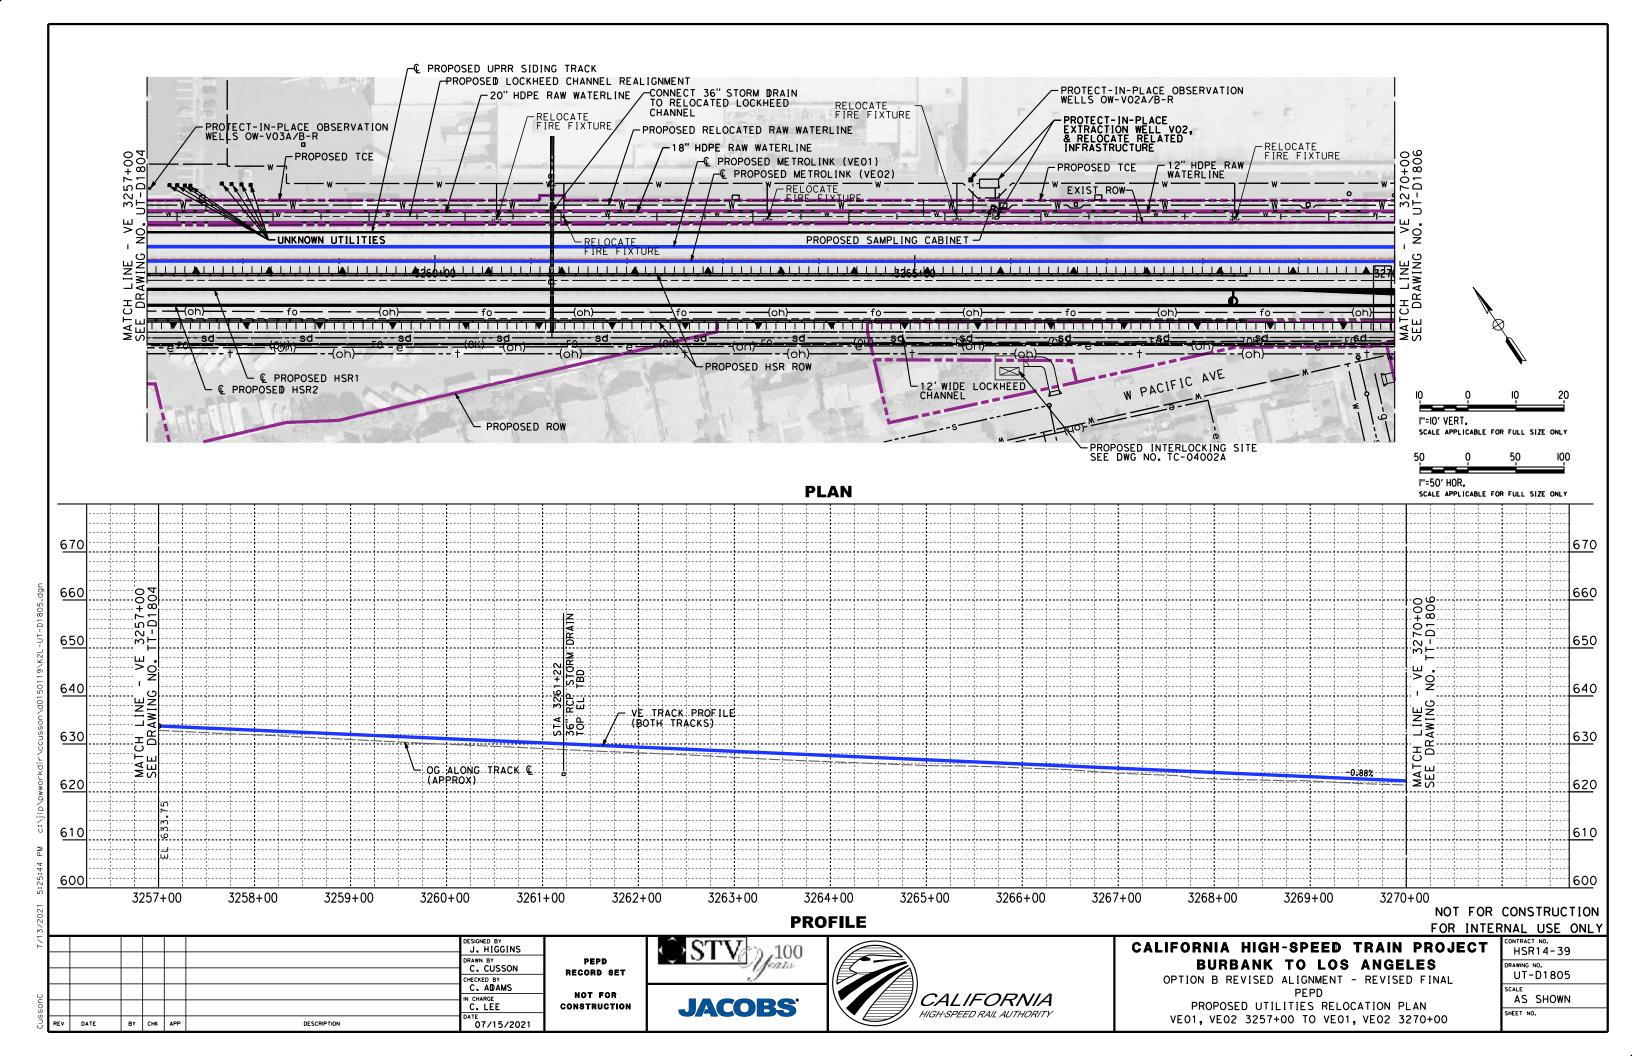

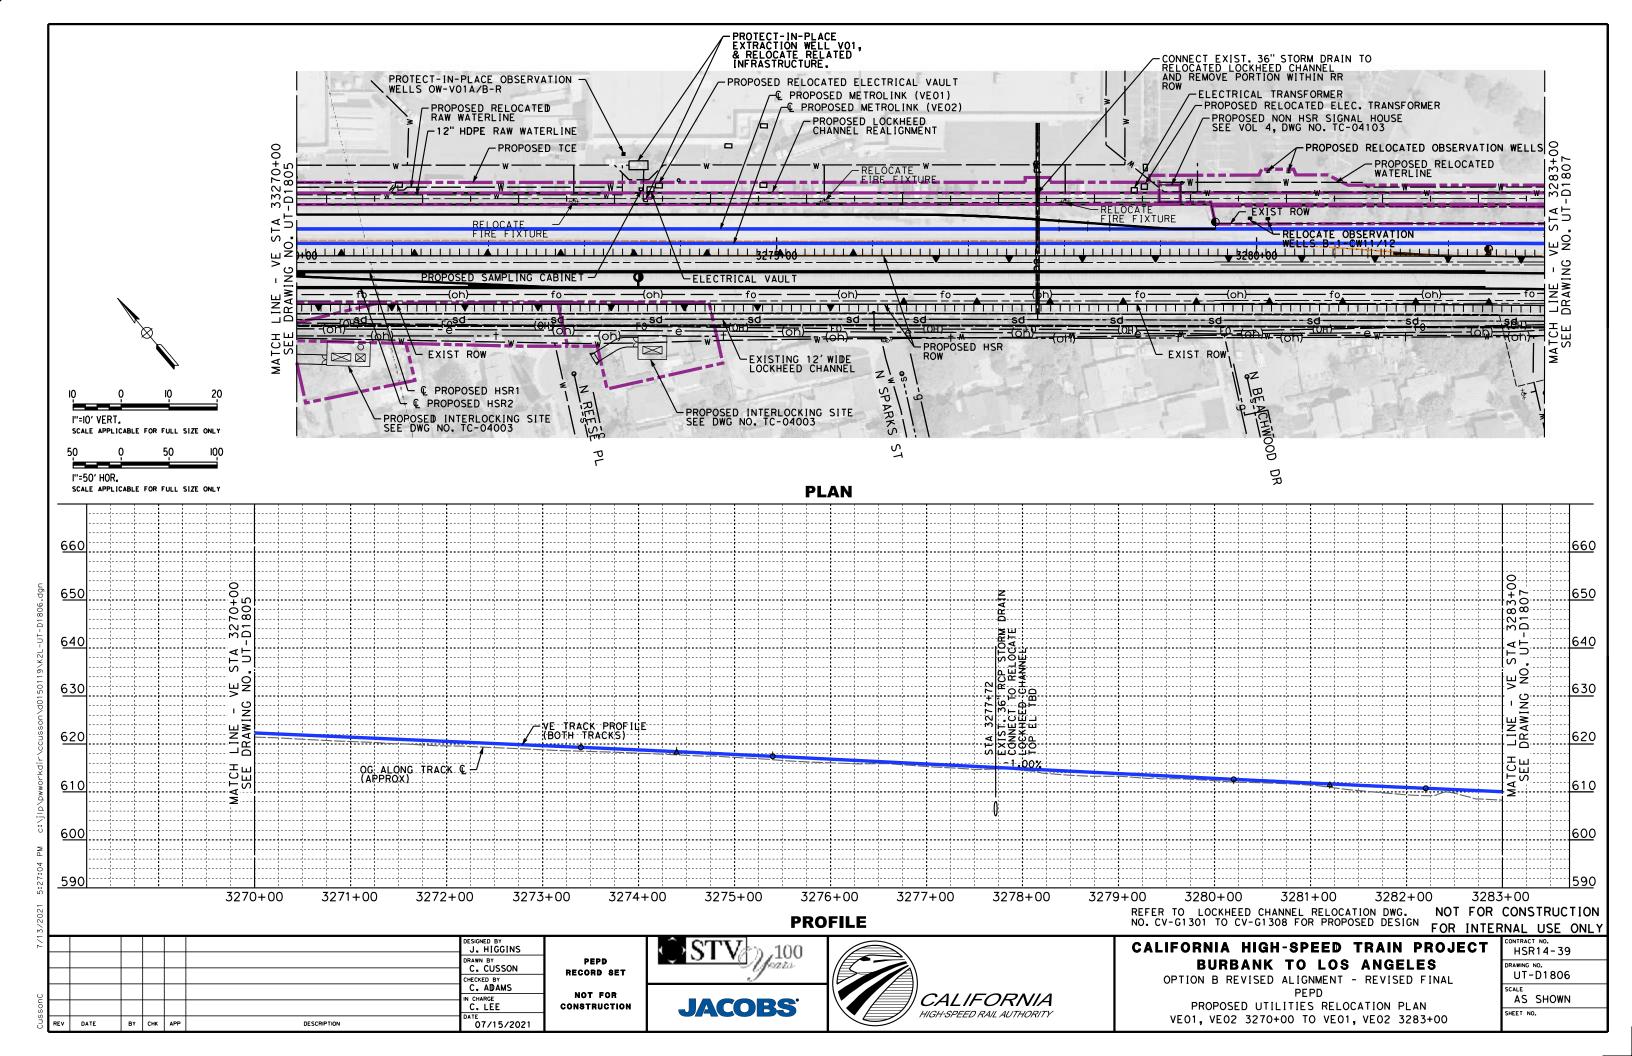

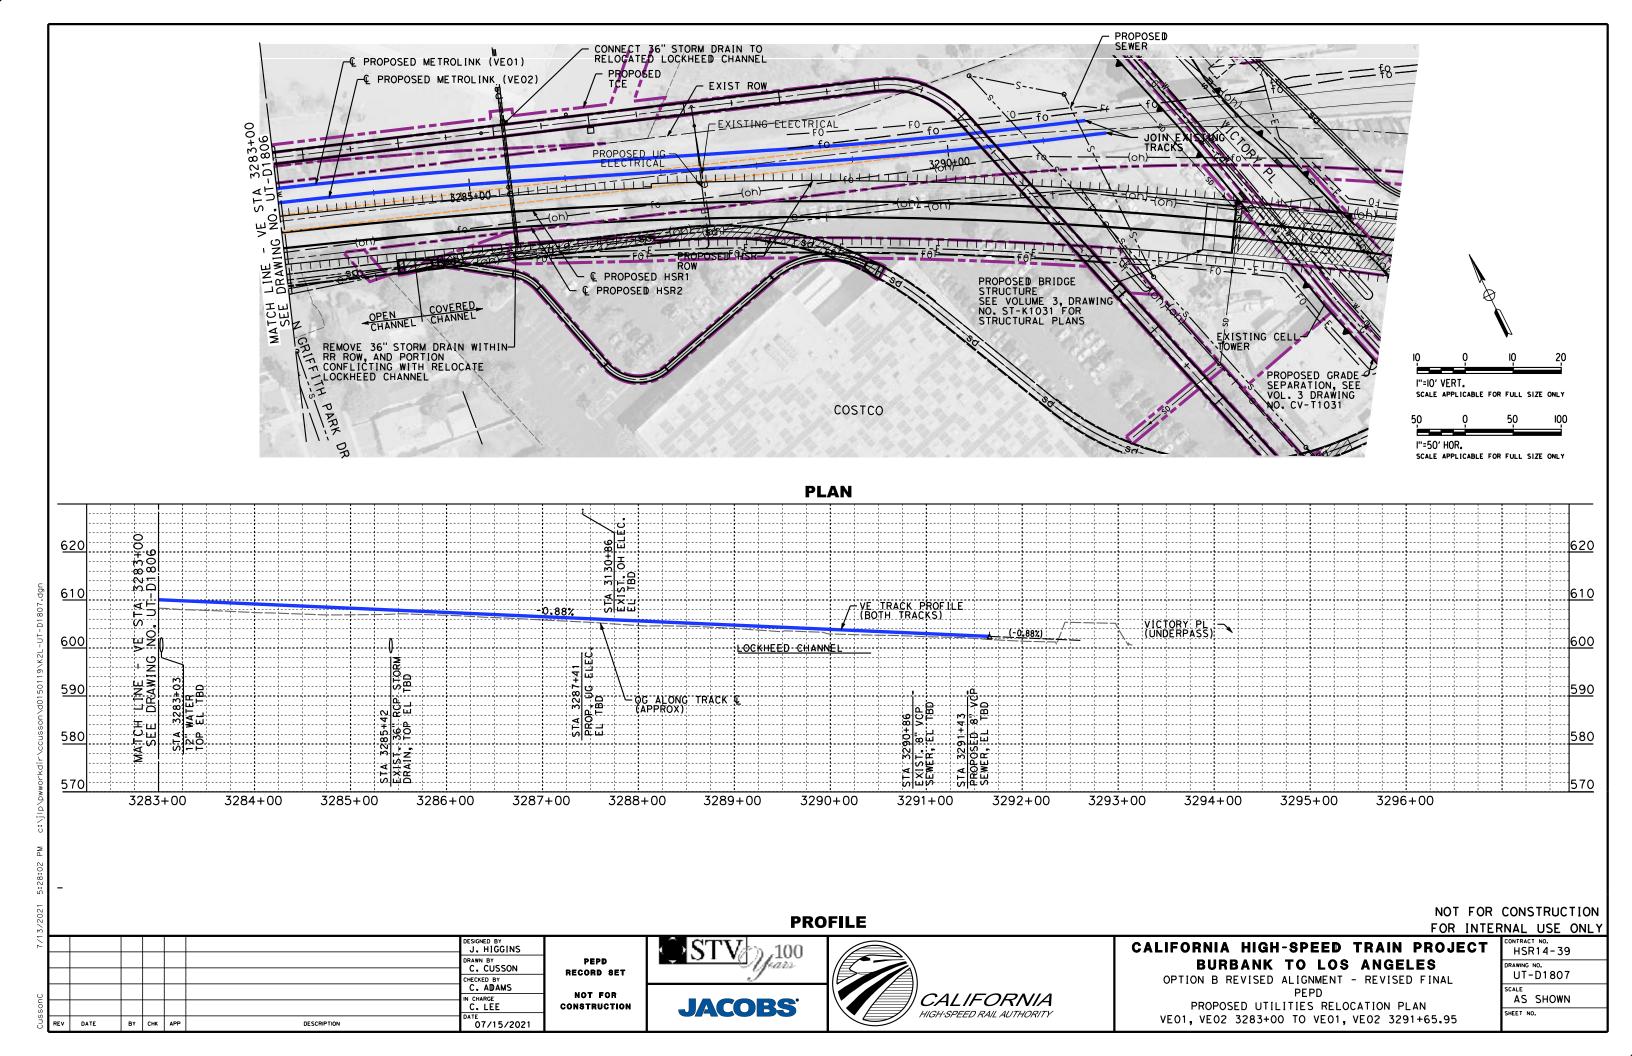

# NOT FOR CONSTRUCTION FOR INTERNAL USE ONLY

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`							DESIGNED BY J. HIGGINS	
							DRAWN BY	
							C. CUSSON CHECKED BY	R
ر							C. ADAMS	
5							C. LEE	CO
20	REV	DATE	ВΥ	СНК	APP	DESCRIPTION	DATE 07/15/2021	

PEPD RECORD SET NOT FOR CONSTRUCTION STV 100

JACOBS



## CALIFORNIA HIGH-SPEED TRAIN PROJECT BURBANK TO LOS ANGELES

CONTRACT NO. HSR14-39
DRAWING NO.
UT-D1901
SCALE
AS SHOWN
SHEET NO.

NOT FOR CONSTRUCTION FOR INTERNAL USE ONLY

DESCRED BY
J. HIGGINS
DRAWN BY
C. CUSSON
CHECKED BY
C. ADAMS
IN CHARGE
C. LEE

REV DATE BY CHK APP DESCRIPTION

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PEPD
RECORD SET

NOT FOR
CONSTRUCTION





#### CALIFORNIA HIGH-SPEED TRAIN PROJECT BURBANK TO LOS ANGELES

ONTRACT NO. HSR14-39	
RAWING NO.	
UT-D1902	
CALE	
AS SHOWN	
HEET NO.	

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DESIGNED BY
J. HIGGINS
DRAWN BY
C. CUSSON
CHECKED BY
C. ADAMS
IN CHARGE
C. LEE

DESCRIPTION

BY CHK APP

PEPD RECORD SET NOT FOR CONSTRUCTION

07/15/2021

STV 100

JACOBS



#### CALIFORNIA HIGH-SPEED TRAIN PROJECT BURBANK TO LOS ANGELES

HSR14-39
DRAWING NO. UT-D1903
AS SHOWN
SHEET NO.

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#### CALIFORNIA HIGH-SPEED TRAIN PROJECT BURBANK TO LOS ANGELES

CONTRACT NO. HSR14-39	
DRAWING NO.	
UT-D1904	
SCALE	
AS SHOWN	
SHEET NO.	

NOT FOR CONSTRUCTION FOR INTERNAL USE ONLY

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PEPD RECORD SET NOT FOR CONSTRUCTION





#### CALIFORNIA HIGH-SPEED TRAIN PROJECT BURBANK TO LOS ANGELES

CONTRACT NO. HSR14-39
DRAWING NO. UT-D1905
SCALE AS SHOWN
SHEET NO.

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DESIGNED BY
J. HIGGINS
JOHN BY
C. CUSSON
CHECKED BY
C. ADAMS
IN CHARGE
C. LEE

DATE
BY CHK APP
DESCRIPTION
DATE
O7/15/2021

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JACOBS



## CALIFORNIA HIGH-SPEED TRAIN PROJECT BURBANK TO LOS ANGELES

CONTRACT NO. HSR14-39	
DRAWING NO.	
UT-D1906	
SCALE	
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PEPD RECORD SET NOT FOR CONSTRUCTION





## CALIFORNIA HIGH-SPEED TRAIN PROJECT BURBANK TO LOS ANGELES

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	CONTRACT NO. HSR14-39
	DRAWING NO. UT-D1907
	AS SHOWN
	SHEET NO.

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Ø	REV	DATE	BY	СНК	ΔРР	DESCRIPTION	DATE 07/15/2021	

PEPD
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CONSTRUCTION





### CALIFORNIA HIGH-SPEED TRAIN PROJECT BURBANK TO LOS ANGELES

CONTRACT NO.
HSR14-39
DRAWING NO.
UT-D1908
SCALE
AS SHOWN
SHEET NO.