
California High-Speed Rail Authority

Palmdale to Burbank Project Section

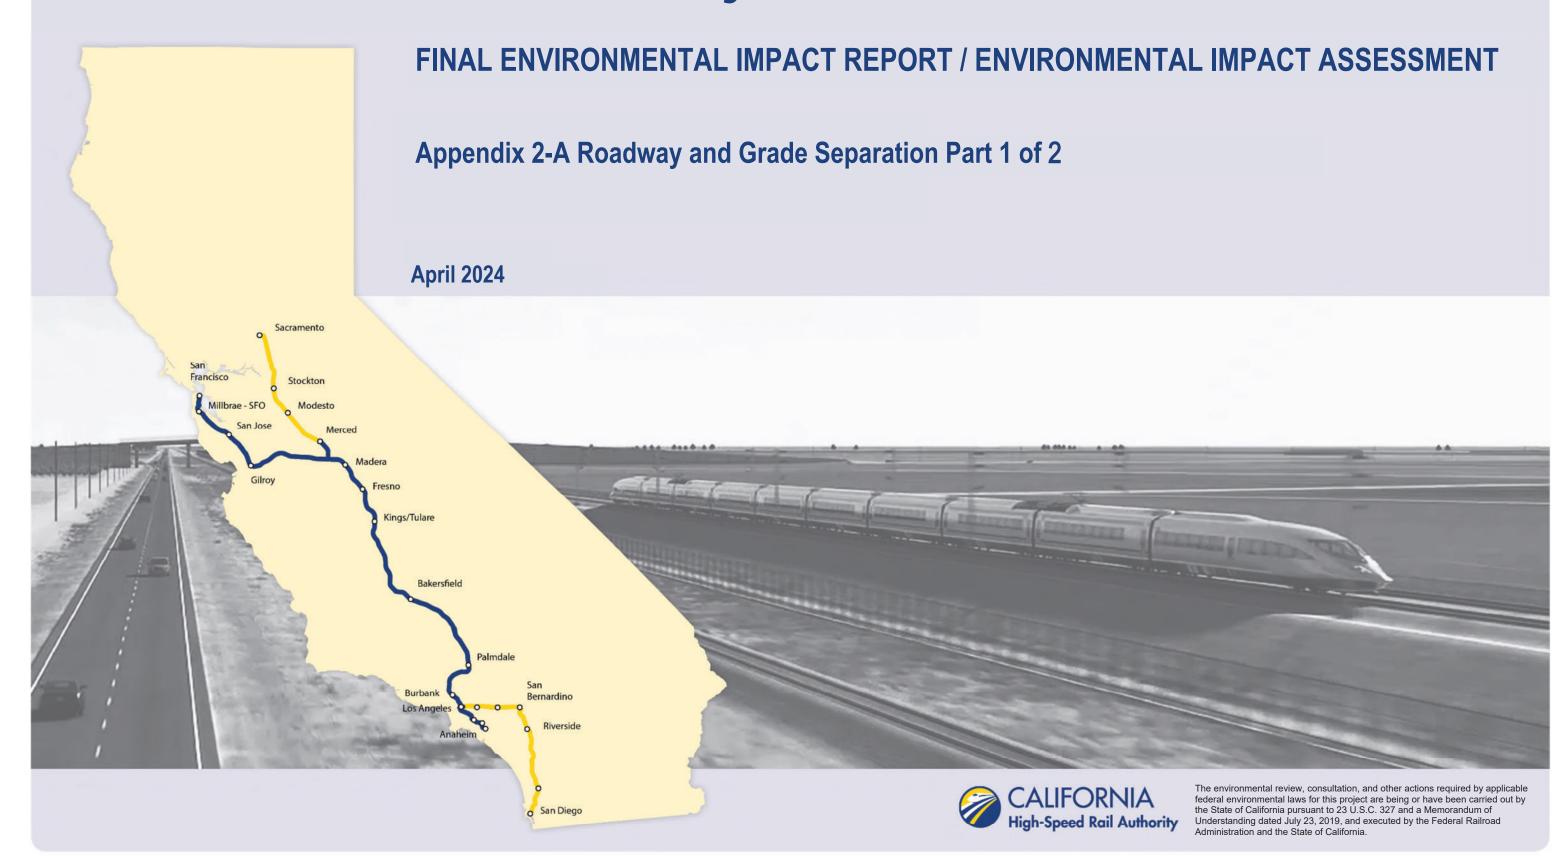





Since publication of the Palmdale to Burbank Project Section Draft Environmental Impact Report/Environmental Impact Statement (EIR/EIS), the following substantive changes have been made to this appendix:

- Appendix 2-A Part 1 of 3, drawings CV-B0002-S14, CV-Y4013-S14, CV-Y4014-S14, CV-Y4015-S14, CV-Y1012-S14, CV-Y1013-S14, CV-Y1014-S14, CV-Y1013-S14, CV-Y
- Appendix 2-A Part 3 of 3, drawings CV-B0002-14A, CV-Y4006-14A, CV-Y4007-14A, CV-Y1007-14A, CV-Y1009-14A, CV-Y1009-14A, CV-Y3001-14A have been updated to show the new Portal 4A Access Road in SR14A Build Alternative which was moved parallel and adjacent to the HSR southbound track alignment in Bee Canyon.
- Appendix 2-A Part 3 of 3, drawings CV-R4001-14A, CV-R4002-14A, CV-R4002-14A, CV-R4004-14A, CV-R4004-14A, CV-R4001-EA, CV-R4001-EA, CV-R4002-EA, CV-R4002-EA, CV-R4002-EA, CV-R4002-EA, CV-R4002-EA, CV-R4002-EA, CV-R4002-EA, CV-R4002-EA, CV-R4004-EA have been updated to include the access road to the water tank located on the North-West corner of Boulders Mobile Home Park.



GENERAL

		
DRAWING NO.	DRAWING DESCRIPTION	
CV-B0001	ROADWAYS AND GRADE SEPARATIONS - INDEX OF DRAWINGS - SHEET 1 OF 3	
CV-B0002	ROADWAYS AND GRADE SEPARATIONS - INDEX OF DRAWINGS - SHEET 2 OF 3	VOLUME
CV-B0003	ROADWAYS AND GRADE SEPARATIONS - INDEX OF DRAWINGS - SHEET 3 OF 3	I OF II
CV-B0004	ROADWAYS AND GRADE SEPARATIONS - ABBREVIATIONS	
CV-B0005	ROADWAYS AND GRADE SEPARATIONS - ABBREVIATIONS AND LEGEND	

REFINED S14 CENTRAL SUBSECTION

	REFINED S14 CENTRAL SUBSECTION	
DRAWING NO.	DRAWING DESCRIPTION	
	KEY MAPS	
CV-B0001-S14	ROADWAY AND GRADE SEPARATION PLAN - KEY MAP - SHEET 1 OF 4	
CV-B0002-S14	ROADWAY AND GRADE SEPARATION PLAN - KEY MAP - SHEET 2 OF 4	
CV-B0003-S14	ROADWAY AND GRADE SEPARATION PLAN - KEY MAP - SHEET 3 OF 4	
CV-B0004-S14	ROADWAY AND GRADE SEPARATION PLAN - KEY MAP - SHEET 4 OF 4	
	ROADWAY PLANS, PROFILES AND TYPICAL SECTIONS	
CV-R4006-S14	ROADWAY PLAN - SIERRA HIGHWAY - SHEET 1 OF 4	
CV-R4007-S14	ROADWAY PLAN - SIERRA HIGHWAY AND WATER TREATMENT PLANT ACCESS RD 2 - SHEET 2 OF 4	
CV-R4008-S14	ROADWAY PLAN - SIERRA HIGHWAY - SHEET 3 OF 4	
CV-R4009-S14	ROADWAY PLAN - SIERRA HIGHWAY - SHEET 4 OF 4	
CV-R4018-S14	ROADWAY PLAN - E BARREL SPRINGS RD, E BARREL SPRINGS ACCESS RD AND EAST SIXTH STREET	
CV-R4019-S14	ROADWAY PLAN - E BARREL SPRINGS RD AND E BARREL SPRINGS ACCESS RD	
CV-R4020-S14	ROADWAY PLAN - SHELDON ST, PRIVATE RD 1, RALSTON AVE, LADWP RD AND ACCESS RD	
CV-R4040-S14	ROADWAY PLAN - TUXFORD ST	
CV-R4041-S14	ROADWAY PLAN - OLINDA ST AND SAN FERNANDO RD	
CV-R1006-S14	ROADWAY PROFILE - SIERRA HIGHWAY - SHEET 1 OF 4	
CV-R1007-S14	ROADWAY PROFILE - SIERRA HIGHWAY - SHEET 2 OF 4	
CV-R1008-S14 CV-R1009-S14	ROADWAY PROFILE - SIERRA HIGHWAY - SHEET 3 OF 4 ROADWAY PROFILE - SIERRA HIGHWAY - SHEET 4 OF 4	
CV-R1009-514	ROADWAY PROFILE - SIERRA HIGHWAY - SHEET 4 OF 4	
CV-R1009A-314	ROADWAY PROFILE - VALLET FORGE AND E AVENUE RTT ROADWAY PROFILE - SIXTH STREET EAST AND WATER TREATMENT PLANT ACCESS RD 2	
CV-R1009B-314	ROADWAY PROFILE - SIXTH STREET EAST AND WATER TREATMENT FLANT ACCESS RD 2	
CV-R1020-S14	ROADWAY PROFILE - E BARREL SPRINGS ROAD - SHEET 1 OF 2	
CV-R1021-S14	ROADWAY PROFILE - E BARREL SPRINGS ROAD - SHEET 2 OF 2	
CV-R1021A-S14	ROADWAY PROFILE - E BARREL SPRINGS ACCESS ROAD	
CV-R1022-S14	ROADWAY PROFILE - SHELDON STREET	
CV-R1023-S14	ROADWAY PROFILE - RALSTON AVENUE, PRIVATE RD 1, LADWP RD AND ACCESS RD	
CV-R1024-S14	ROADWAY PROFILE - SAN FERNANDO ROAD "SFR"	
CV-R1025-S14	ROADWAY PROFILE - SAN FERNANDO ROAD "SFB"	
CV-R1026-S14	ROADWAY PROFILE - SAN FERNANDO ROAD "SFR1"	
CV-R1029-S14	ROADWAY PROFILE - OLINDA STREET	VOLUME
CV-R1030-S14	ROADWAY PROFILE - TUXFORD STREET	VOLUME
CV-R3001-S14	TYPICAL SECTIONS - E BARREL SPRINGS ROAD	I OF II
CV-R3002-S14	TYPICAL SECTIONS - SIXTH STREET EAST	
CV-R3003-S14	TYPICAL SECTIONS - HAROLD THIRD STREET, HAROLD DATE AVE, HAROLD FIFTH STREET AND E BARREL SPRINGS ACCESS RD	
CV-R3004-S14	TYPICAL SECTIONS - BRANFORD STREET, RALSTON AVENUE AND ACCESS ROAD	
CV-R3005-S14	TYPICAL SECTIONS - SHELDON STREET, PRIVATE ROAD 1 AND LADWP ROAD	
CV-R3006-S14	TYPICAL SECTIONS - SIERRA HIGHWAY - SHEET 1 OF 2	
CV-R3007-S14	TYPICAL SECTIONS - SIERRA HIGHWAY - SHEET 2 OF 2	
CV-R3008-S14	TYPICAL SECTIONS - EAST TENTH STREET AND WATER TREATMENT PLANT ACCESS RD 2	
CV-R3009-S14	TYPICAL SECTIONS - SAN FERNANDO ROAD - SHEET 1 OF 2	
CV-R3010-S14	TYPICAL SECTIONS - SAN FERNANDO ROAD - SHEET 2 OF 2	
CV-R3011-S14	TYPICAL SECTIONS - TUXFORD STREET	
CV-R3012-S14	TYPICAL SECTIONS - OLINDA STREET	
CV-R3013-S14	TYPICAL SECTIONS - VALLEY FORGE AND EAST AVENUE R11	
011 74007 644	GRADE SEPARATION PLANS, PROFILES AND TYPICAL SECTIONS	
CV-T4007-S14	GRADE SEPARATION PLAN - EAST AVENUE S - SHEET 1 OF 3	
CV-T4008-S14 CV-T4009-S14	GRADE SEPARATION PLAN - EAST AVENUE S - SHEET 2 OF 3 GRADE SEPARATION PLAN - EAST AVENUE S - SHEET 3 OF 3	
CV-T4009-S14	GRADE SEPARATION PLAN - EAST AVENUE S - SHEET 3 OF 3 GRADE SEPARATION PLAN - BRANFORD STREET AND SANFERNANDO ROAD "SFR1" - SHEET 1 OF 2	
CV-T4019-314	GRADE SEPARATION PLAN - BRANFORD STREET AND SANFERNANDO ROAD SPRI - SHEET I OF 2	
CV-T1007-S14	GRADE SEPARATION PROFILE - EAST AVENUE S - SHEET 1 OF 3	
CV-T1008-S14	GRADE SEPARATION PROFILE - EAST AVENUE S - SHEET 2 OF 3	
CV-T1009-S14	GRADE SEPARATION PROFILE - EAST AVENUE S - SHEET 3 OF 3	
CV-T1015-S14	GRADE SEPARATION PROFILE - BRANFORD STREET	
CV-T3001-S14	TYPICAL SECTIONS - EAST AVENUE S - SHEET 1 OF 2	
CV-T3002-S14	TYPICAL SECTIONS - EAST AVENUE S - SHEET 2 OF 2	
	DESIGNED BY	

REFINED S14 CENTRAL SUBSECTION

DRAWING NO.	DRAWING DESCRIPTION	
	ACCESS ROAD PLANS, PROFILES AND TYPICAL SECTIONS	
CV-Y4001-S14	ACCESS ROAD PLAN - ACCESS ROAD 1	
CV-Y4003-S14	ACCESS ROAD PLAN - ACCESS ROAD 2	
CV-Y4004-S14	ACCESS ROAD PLAN - ACCESS ROAD 3A & 3B	
CV-Y4005-S14	ACCESS ROAD PLAN - ACCESS ROAD 4, 5A & 5 - SHEET 1 OF 4	
CV-Y4006-S14	ACCESS ROAD PLAN - ACCESS ROAD 5 - SHEET 2 OF 4	
CV-Y4007-S14	ACCESS ROAD PLAN - ACCESS ROAD 5 - SHEET 3 OF 4	
CV-Y4008-S14	ACCESS ROAD PLAN - ACCESS ROAD 5 - SHEET 4 OF 4	
CV-Y4009-S14	ACCESS ROAD PLAN - ACCESS ROAD 6A & 6B - SHEET 1 OF 3	
CV-Y4010-S14	ACCESS ROAD PLAN - ACCESS ROAD 6A - SHEET 2 OF 3	
CV-Y4011-S14	ACCESS ROAD PLAN- ACCESS ROAD 6A - SHEET 3 OF 3	
CV-Y4012-S14	ACCESS ROAD PLAN - ACCESS ROAD 7	
CV-Y4013-S14	ACCESS ROAD PLAN - ACCESS ROAD 8 - SHEET 1 OF 3	
CV-Y4014-S14	ACCESS ROAD PLAN - ACCESS ROAD 8 - SHEET 2 OF 3	
CV-Y4015-S14	ACCESS ROAD PLAN - ACCESS ROAD 8 - SHEET 3 OF 3	
CV-Y4016-S14	ACCESS ROAD PLAN - ACCESS ROAD 9	
CV-Y4017-S14	ACCESS ROAD PLAN - WEST AND EAST ADIT ROAD OPTION 1 AND OPTION 2	
CV-Y1001-S14	ACCESS ROAD PROFILE - ACCESS ROAD 1	
CV-Y1002-S14	ACCESS ROAD PROFILE - ACCESS ROAD 2 AND ACCESS ROAD 5A	VOLUME
CV-Y1003-S14	ACCESS ROAD PROFILE - ACCESS ROAD 3A & 3B	I OF II
CV-Y1004-S14	ACCESS ROAD PROFILE - ACCESS ROAD 5 - SHEET 1 OF 4	1 01 11
CV-Y1005-S14	ACCESS ROAD PROFILE - ACCESS ROAD 5 - SHEET 2 OF 4	
CV-Y1006-S14	ACCESS ROAD PROFILE - ACCESS ROAD 5 - SHEET 3 OF 4	
CV-Y1007-S14	ACCESS ROAD PROFILE - ACCESS ROAD 5 - SHEET 4 OF 4	
CV-Y1008-S14	ACCESS ROAD PROFILE - ACCESS ROAD 6A - SHEET 1 OF 3	
CV-Y1009-S14	ACCESS ROAD PROFILE - ACCESS ROAD 6A - SHEET 2 OF 3	
CV-Y1010-S14	ACCESS ROAD PROFILE - ACCESS ROAD 6A - SHEET 3 OF 3	
CV-Y1011-S14	ACCESS ROAD PROFILE - ACCESS ROAD 7	
CV-Y1012-S14	ACCESS ROAD PROFILE - ACCESS ROAD 8 - SHEET 1 OF 3	
CV-Y1013-S14	ACCESS ROAD PROFILE - ACCESS ROAD 8 - SHEET 2 OF 3	
CV-Y1014-S14	ACCESS ROAD PROFILE - ACCESS ROAD 8 - SHEET 3 OF 3	
CV-Y1015-S14	ACCESS ROAD PROFILE - ACCESS ROAD 9	
CV-Y1016-S14	ACCESS ROAD PROFILE - ACCESS ROAD 4 & ACCESS ROAD 6B	
CV-Y1017-S14	ACCESS ROAD PROFILE - WEST AND EAST ADIT ROAD OPTION 1 AND OPTION 2	
CV-Y3001-S14	TYPICAL SECTIONS - ACCESS ROAD 1, 2, 3A AND 3B	
CV-Y3002-S14	TYPICAL SECTIONS - ACCESS ROAD 4, 5, 6A AND 6B	
CV-Y3003-S14	TYPICAL SECTIONS - ACCESS ROAD 8	
CV-Y3004-S14	TYPICAL SECTIONS - EAST ADIT ROAD AND WEST ADIT ROAD, ACCESS ROAD 7 , 9	

ROADWAY/GRADE SEPARATION SHEETS

	L C	1-13	JUZ-	314	TIFICAL SECTIONS - EAST AVENUE 3 - SHE	EI Z OF Z	
						DESIGNED BY J.C. ALAMILLA	
						DRAWN BY D. CORDOBA	P
						CHECKED BY I. LAQUIDAIN	
						IN CHARGE A. RELAÑO	
REV	DATE	ВҮ	СНК	APP	DESCRIPTION	12/30/2023	

PEPD RECORD SET REV 02 NOT FOR

CONSTRUCTION





CALIFORNIA HIGH-SPEED RAIL PROJECT PALMDALE TO BURBANK

ALIGNMENT "REFINED SR14/E1/E2" ROADWAYS AND GRADE SEPARATIONS INDEX OF DRAWINGS SHEET 1 OF 3

HSR14-42 CV-BOOO1 NO SCALE

SHEET NO.

DRAWING DESCRIPTION

DRAWING NO.

DRAWING NO.	DRAWING DESCRIPTION
	KEY MAPS
CV-B0001-E1	ROADWAYS AND GRADE SEPARATION PLAN - KEY MAP - SHEET 1 OF 4
CV-B0002-E1	ROADWAYS AND GRADE SEPARATION PLAN - KEY MAP - SHEET 2 OF 4
CV-B0003-E1	ROADWAYS AND GRADE SEPARATION PLAN - KEY MAP - SHEET 3 OF 4
CV-B0004-E1	ROADWAYS AND GRADE SEPARATION PLAN - KEY MAP - SHEET 4 OF 4
	ROADWAY PLANS, PROFILES AND TYPICAL SECTIONS
CV-R4006-E1	ROADWAY PLAN - SIERRA HIGHWAY "SH-1" - SHEET 1 OF 4
CV-R4007-E1	ROADWAY PLAN - SIERRA HIGHWAY "SH-1" AND WATER TREATMENT PLAN ACCESS RD 2 - SHEET 2 OF 4
CV-R4008-E1	ROADWAY PLAN - SIERRA HIGHWAY "SH-1" - SHEET 3 OF 4
CV-R4009-E1	ROADWAY PLAN - SIERRA HIGHWAY "SH-1" - SHEET 4 OF 4
CV-R4018-E1	ROADWAY PLAN - ANGELES FOREST HIGHWAY, W CARSON MESA ROAD AND MOUNTAIN SPRINGS ROAD
CV-R4019-E1	ROADWAY PLAN - ANGELES FOREST HIGHWAY
CV-R4020-E1	ROADWAY PLAN - ANGELES FOREST HIGHWAY AND ROUTE 14 EB OFF-RAMP
CV-R4022-E1	ROADWAY PLAN - SIERRA HIGHWAY "SH-2" AND ROUTE 14 EB ON-RAMP
CV-R4023-E1	ROADWAY PLAN - SIERRA HIGHWAY "SH-3"
CV-R4030-E1	ROADWAY PLAN - SIERRA HIGHWAY SH-S ROADWAY PLAN - SHELDON ST, PRIVATE RD 1, RALSTON AVE, LADWP RD AND ACCESS RD
CV-R4040-E1	ROADWAY PLAN - TUXFORD STREET
CV-R4041-E1	ROADWAY PLAN - TOXFORD STREET ROADWAY PLAN - OLINDA STREET AND SAN FERNANDO ROAD
CV-R1006-E1	ROADWAY PROFILE - SIERRA HIGHWAY "SH-1" - SHEET 1 OF 4
	ROADWAY PROFILE - SIERRA HIGHWAY "SH-1" - SHEET 2 OF 4
CV-R1007-E1	
	ROADWAY PROFILE - SIERRA HIGHWAY "SH-1" - SHEET 3 OF 4
CV-R1009-E1	ROADWAY PROFILE - SIERRA HIGHWAY "SH-1" AND WATER TREATMENT PLANT ACCESS RD 2 - SHEET 4 OF 4
CV-R1009A-E1	ROADWAY PROFILE - EAST TENTH STREET
CV-R1010-E1	ROADWAY PROFILE - SIERRA HIGHWAY "SH-2" - SHEET 1 OF 2
CV-R1011-E1	ROADWAY PROFILE - SIERRA HIGHWAY "SH-2" - SHEET 2 OF 2
CV-R1012-E1	ROADWAY PROFILE - SIERRA HIGHWAY "SH-3" - SHEET 1 OF 2
CV-R1013-E1	ROADWAY PROFILE - SIERRA HIGHWAY "SH-3" - SHEET 2 OF 2
CV-R1014-E1	ROADWAY PROFILE - MOUNTAIN SPRINGS ROAD
CV-R1018-E1	ROADWAY PROFILE - ANGELES FOREST HIGHWAY AND W CARSON MESA ROAD
CV-R1019-E1	ROADWAY PROFILE - ANGELES FOREST HIGHWAY - SHEET 1 OF 2
CV-R1020-E1	ROADWAY PROFILE - ANGELES FOREST HIGHWAY - SHEET 2 OF 2
CV-R1021-E1	ROADWAY PROFILE - ROUTE 14 EB OFF-RAMP
CV-R1022-E1	ROADWAY PROFILE - ROUTE 14 EB ON-RAMP
CV-R1023-E1	ROADWAY PROFILE - VALLEY FORGE AND E AVENUE R 11
CV-R1024-E1	ROADWAY PROFILE - CARSON MESA ACCESS ROAD
CV-R1025-E1	ROADWAY PROFILE - SAN FERNANDO ROAD "SFR"
CV-R1026-E1	ROADWAY PROFILE - SAN FERNANDO ROAD "SFB"
CV-R1027-E1	ROADWAY PROFILE - SAN FERNANDO ROAD "SFR1"
CV-R1029-E1	ROADWAY PROFILE - SHELDON STREET
CV-R1030-E1	ROADWAY PROFILE - OLINDA STREET
CV-R1031-E1	ROADWAY PROFILE - TUXFORD STREET
CV-R3001-E1	TYPICAL SECTIONS - SIERRA HIGHWAY - SHEET 1 OF 2
CV-R3002-E1	TYPICAL SECTIONS - SIERRA HIGHWAY - SHEET 2 OF 2
CV-R3003-E1	TYPICAL SECTIONS - ROUTE 14 EB ON-RAMP AND ROUTE 14 EB OFF-RAMP
CV-R3004-E1	TYPICAL SECTIONS - SIERRA HIGHWAY AND ANGELES FOREST HIGHWAY
CV-R3005-E1	TYPICAL SECTIONS - EAST TENTH STREET AND WATER TREATMENT PLANT ACCESS RD 2
CV-R3006-E1	TYPICAL SECTIONS - W CARSON MESA ROAD AND MOUNTAIN SPRINGS RD
CV-R3009-E1	TYPICAL SECTIONS - SAN FERNANDO ROAD - SHEET 1 OF 2
CV-R3010-E1	TYPICAL SECTIONS - SAN FERNANDO ROAD - SHEET 2 OF 2
CV-R3011-E1	TYPICAL SECTIONS - TUXFORD STREET
CV-R3012-E1	TYPICAL SECTIONS - OLINDA STREET
CV-R3013-E1	TYPICAL SECTIONS - BRANFORD ST, RALSTON AVE AND ACCESS RD
CV-R3014-E1	TYPICAL SECTIONS - SHELDON ST, PRIVATE ROAD 1 AND LADWP RD

E1 CENTRAL SUBSECTION

DRAWING NO.	DRAWING DESCRIPTION	
	GRADE SEPARATION PLANS, PROFILES AND TYPICAL SECTIONS	1
CV-T4007-E1	GRADE SEPARATION PLAN - EAST AVENUE S - SHEET 1 OF 3	1
CV-T4008-E1	GRADE SEPARATION PLAN - EAST AVENUE S - SHEET 2 OF 3	1
CV-T4009-E1	GRADE SEPARATION PLAN - EAST AVENUE S - SHEET 3 OF 3	
CV-T4010-E1	GRADE SEPARATION PLAN - BRANDFORD ST AND SAN FERNANDO RD "SFR1" - SHEET 1 OF 2	
CV-T4011-E1	GRADE SEPARATION PLAN - BRANDFORD ST - SHEET 2 OF 2	
CV-T4015-E1	GRADE SEPARATION PLAN - FORESTON DRIVE AND FORESTON ACCESS ROAD	
CV-T4016-E1	GRADE SEPARATION PLAN - FORESTON DRIVE	
CV-T4017-E1	GRADE SEPARATION PLAN - ALISO CANYON ROAD AND ACCESS ROAD 3	
CV-T4018-E1	GRADE SEPARATION PLAN - ALISO CANYON ROAD	
CV-T1007-E1	GRADE SEPARATION PROFILE - EAST AVENUE S - SHEET 1 OF 3	
CV-T1008-E1	GRADE SEPARATION PROFILE - EAST AVENUE S - SHEET 2 OF 3	VOLUME
CV-T1009-E1	GRADE SEPARATION PROFILE - EAST AVENUE S - SHEET 3 OF 3	II OF II
CV-T1010-E1	GRADE SEPARATION PROFILE - BRANFORD STREET] '' 0' ''
CV-T1016-E1	GRADE SEPARATION PROFILE - FORESTON DRIVE - SHEET 1 OF 2	
CV-T1017-E1	GRADE SEPARATION PROFILE - FORESTON DRIVE - SHEET 2 OF 2	
CV-T1018-E1	GRADE SEPARATION PROFILE - ALISO CANYON ROAD - SHEET 1 OF 2	_
CV-T1019-E1	GRADE SEPARATION PROFILE - ALISO CANYON ROAD - SHEET 2 OF 2	_
CV-T3001-E1	TYPICAL SECTIONS - FORESTON DRIVE	_
CV-T3002-E1	TYPICAL SECTIONS - ALISO CANYON ROAD	_
CV-T3003-E1	TYPICAL SECTIONS - EAST AVENUE S - SHEET 1 OF 2	_
CV-T3004-E1	TYPICAL SECTIONS - EAST AVENUE S - SHEET 2 OF 2	_
	ACCESS ROAD PLANS, PROFILES AND TYPICAL SECTIONS	_
CV-Y4001-E1	ACCESS ROAD PLAN - EAST ADIT ACCESS ROAD	_
CV-Y1001-E1	ACCESS ROAD PROFILE - FORESTON ACCESS ROAD AND ACCESS ROAD 3 - PORTAL 3	_
CV-Y1002-E1	ACCESS ROAD PROFILE - EAST ADIT ACCESS ROAD	_
CV-Y3001-E1	TYPICAL SECTIONS - VALLEY FORGE AND EAST AVE R11	_
CV-Y3002-E1	TYPICAL SECTIONS - CARSON MESA ACCESS ROAD AND ACCESS ROAD 3	_
CV-Y3003-E1	TYPICAL SECTIONS - EAST ADIT ACCESS ROAD	

VOLUME II OF II

						DESIGNED BY	
						DRAWN BY	1
						CHECKED BY W. GUO	
						IN CHARGE A. RELANO	
REV	DATE	BY	СНК	APP	DESCRIPTION	DATE 04/30/2021	

PEPD RECORD SET REV 02 NOT FOR CONSTRUCTION





CALIFORNIA HIGH-SPEED RAIL PROJECT PALMDALE TO BURBANK

ALIGNMENT "REFINED SR14/E1/E2" ROADWAYS AND GRADE SEPARATIONS INDEX OF DRAWINGS SHEET 2 OF 3

	CONTRACT NO. HSR14-42					
	DRAWING NO. CV-BOOO2					
	NO SCALE					
	SHEET NO.					

KEY MAP

ROADWAY PLAN - SIERRA HIGHWAY "SH-1" - SHEET 1 OF 4

ROADWAY PLAN - SIERRA HIGHWAY "SH-1" - SHEET 3 OF 4 ROADWAY PLAN - SIERRA HIGHWAY "SH-1" - SHEET 4 OF 4

ROADWAY PLAN - WENTWORTH STREET - SHEET 1 OF 3

ROADWAY PROFILE - SIERRA HIGHWAY "SH-1" - SHEET 1 OF 4
ROADWAY PROFILE - SIERRA HIGHWAY "SH-1" - SHEET 2 OF 4

ROADWAY PROFILE - SIERRA HIGHWAY "SH-1" - SHEET 3 OF 4

ROADWAY PROFILE - SIERRA HIGHWAY "SH-2" - SHEET 1 OF 2

ROADWAY PROFILE - SIERRA HIGHWAY "SH-2" - SHEET 2 OF 2 ROADWAY PROFILE - SIERRA HIGHWAY "SH-3" - SHEET 1 OF 2

ROADWAY PROFILE - SIERRA HIGHWAY "SH-3" - SHEET 2 OF 2

ROADWAY PROFILE - ANGELES FOREST HIGHWAY - SHEET 1 OF 2

ROADWAY PROFILE - ANGELES FOREST HIGHWAY - SHEET 2 OF 2

ROADWAY PROFILE - VALLEY FORGE AND E AVENUE R 11

ROADWAY PROFILE - WENTWORTH STREET - SHEET 1 OF 3 ROADWAY PROFILE - WENTWORTH STREET - SHEET 2 OF 3

ROADWAY PROFILE - WENTWORTH STREET - SHEET 3 OF 3 TYPICAL SECTIONS - SIERRA HIGHWAY - SHEET 1 OF 2

TYPICAL SECTIONS - SIERRA HIGHWAY - SHEET 2 OF 2

TYPICAL SECTIONS - WENTWORTH STREET - SHEET 1 OF 2
TYPICAL SECTIONS - WENTWORTH STREET - SHEET 2 OF 2
GRADE SEPARATION PLANS, PROFILES AND TYPICAL SECTIONS

GRADE SEPARATION PLAN - EAST AVENUE S - SHEET 1 OF 3

GRADE SEPARATION PLAN - EAST AVENUE S - SHEET 2 OF 3 GRADE SEPARATION PLAN - EAST AVENUE S - SHEET 3 OF 3

ROADWAY PROFILE - ANGELES FOREST HIGHWAY AND W CARSON MESA ROAD

TYPICAL SECTIONS - ROUTE 14 EB ON-RAMP AND ROUTE 14 EB OFF-RAMP

TYPICAL SECTIONS - MOUNTAIN SPRINGS ROAD AND W CARSON MESA ROAD

GRADE SEPARATION PLAN - FORESTON DRIVE AND FORESTON ACCESS ROAD

GRADE SEPARATION PLAN - ALISO CANYON ROAD AND ACCESS ROAD 3

GRADE SEPARATION PROFILE - EAST AVENUE S - SHEET 1 OF 3

GRADE SEPARATION PROFILE - EAST AVENUE S - SHEET 2 OF 3

GRADE SEPARATION PROFILE - EAST AVENUE S - SHEET 3 OF 3
GRADE SEPARATION PROFILE - FORESTON DRIVE - SHEET 1 OF 2

GRADE SEPARATION PROFILE - FORESTON DRIVE - SHEET 2 OF 2

TYPICAL SECTIONS - EAST AVENUE S - SHEET 1 OF 2
TYPICAL SECTIONS - EAST AVENUE S - SHEET 2 OF 2

GRADE SEPARATION PROFILE - ALISO CANYON ROAD - SHEET 1 OF 2

GRADE SEPARATION PROFILE - ALISO CANYON ROAD - SHEET 2 OF 2

TYPICAL SECTIONS - EAST TENTH STREET AND WATER TREATMENT PLANT ACC RD 2

TYPICAL SECTIONS - SIERRA HIGHWAY AND ANGELES FOREST HIGHWAY

ROADWAY PLAN - WENTWORTH STREET - SHEET 2 OF 3 ROADWAY PLAN - WENTWORTH STREET - SHEET 3 OF 3

ROADWAY PLANS, PROFILES AND TYPICAL SECTIONS

ROADWAY PLAN - ANGELES FOREST HIGHWAY

ROADWAY PLAN - SIERRA HIGHWAY "SH-3"

ROADWAY PROFILE - EAST TENTH STREET

ROADWAY PROFILE - MOUNTAIN SPRINGS ROAD

ROADWAY PROFILE - ROUTE 14 EB OFF-RAMP

ROADWAY PROFILE - CARSON MESA ACCESS ROAD

ROADWAY PROFILE - ROUTE 14 EB ON-RAMP

GRADE SEPARATION PLAN - FORESTON DRIVE

GRADE SEPARATION PLAN - ALISO CANYON ROAD

ROADWAY AND GRADE SEPARATION PLAN - KEY MAP - SHEET 1 OF 3

ROADWAY AND GRADE SEPARATION PLAN - KEY MAP - SHEET 2 OF 3

ROADWAY AND GRADE SEPARATION PLAN - KEY MAP - SHEET 3 OF 3

DRAWING DESCRIPTION

ROADWAY PLAN - SIERRA HIGHWAY "SH-1" AND WATER TREATMENT PLANT ACCESS RD 2 - SHEET 2 OF 4

ROADWAY PROFILE - SIERRA HIGHWAY "SH-1" AND WATER TREATMENT PLANT ACCESS RD 2 - SHEET 4 OF 4

ROADWAY PLAN - ANGELES FOREST HWY, W CARSON MESA ROAD AND MOUNTAIN SPRINGS RD

ROADWAY PLAN - SIERRA HIGHWAY "SH-2", ANGELES FOREST HIGHWAY AND ROUTE 14 EB OFF-RAMP ROADWAY PLAN - SIERRA HIGHWAY "SH-3" AND ROUTE 14 EB ON-RAMP

DRAWING NO.

CV-B0001-E2

CV-B0002-E2

CV-B0003-E2

CV-R4006-E2

CV-R4007-E2

CV-R4008-E2 CV-R4009-E2

CV-T1009-E2

CV-T1016-E2

CV-T1017-E2

CV-T1018-E2 CV-T1019-E2

CV-T3001-E2

CV-T3002-E2

CV-T3003-E2

TYPICAL SECTIONS - FORESTON DRIVE

TYPICAL SECTIONS - ALISO CANYON ROAD

PEPD RECORD SET
REV 02

NOT FOR
CONSTRUCTION





E2 CENTRAL SUBSECTION

DRAWING NO.	DRAWING DESCRIPTION	
	ACCESS ROAD PLANS, PROFILES AND TYPICAL SECTIONS	
CV-Y4001-E2	ACCESS ROAD PLAN - ACCESS ROAD 4	
CV-Y4002-E2	ACCESS ROAD PLAN - ACCESS ROAD 5	
CV-Y4003-E2	ACCESS ROAD PLAN - WEST ADIT ACCESS ROAD	VOLUME
CV-Y1001-E2	ACCESS ROAD PROFILE - FORESTON ACCESS ROAD AND ACCESS ROAD 3 - PORTAL 3	II OF II
CV-Y1002-E2	ACCESS ROAD PROFILE - ACCESS ROAD 4	
CV-Y1003-E2	ACCESS ROAD PROFILE - ACCESS ROAD 5 AND WEST ADIT ACCESS ROAD	
CV-Y3001-E2	TYPICAL SECTIONS - VALLEY FORGE AND EAST AVE R11	
CV-Y3002-E2	TYPICAL SECTIONS - ACCESS ROAD 4, ACCESS ROAD 5 AND WEST ADIT ACCESS ROAD	
CV-Y3003-E2	TYPICAL SECTIONS - CARSON MESA ACCESS ROAD AND ACCESS ROAD 3	

VOLUME II OF II


CALIFORNIA HIGH-SPEED RAIL PROJECT PALMDALE TO BURBANK

ALIGNMENT "REFINED SR14/E1/E2" ROADWAYS AND GRADE SEPARATIONS INDEX OF DRAWINGS SHEET 3 OF 3

HSR14-42
CV-B0003
SCALE
NO SCALE

SHEET NO.

	A DESCRIPTION OF THE PAGE		C CONTINUED		F CONTINUED		(M CONTINUED)	B	(P CONTINUED)
	GREGATE BASE	CR	CREEK	FTG	FOOTING	MP	METAL PLATE	PVMT	PAVEMENT
	ANDON	CRCP	CONTINUOUS REINFORCED	FWBT	FACING WESTBOUND TRAFFIC	MPGR	METAL PLATE GUARD RAILING	PVP	MAINTENANCE VEHICLE PU
	JTMENT	0000	CONCRETE PAVEMENT	FWY	FREEWAY	MPH	MILES PER HOUR	PVMT	PAVEMENT
· · · -	PHALT CONCRETE	CRSP	CONCRETED ROCK SLOPE PROTECTION		G	MSE	MECHANICALLY STABILIZED EARTH	PVP	MAINTENANCE VEHICLE PU
	PHALT CONCRETE BASE		CURVE TO SPIRAL	0.0		MTL	MATERIAL		(Q
	JUST		CEMENT TREATED BASE	GP	GRADING PLANE	MΤ	MAIN TRACK		<u> </u>
AHD AHE			CEMENT TREATED PERMEABLE BASE	GR	GUARD RAILING		(N)	QTY	QUANTITY
	TERNATE		CEMENT TREATED PERMEABLE MATERIAL	GSP	GALVANIZED STEEL PIPE				
	ME FROM MIDNIGHT TO NOON	CTRS	CENTERS	GTR	GUTTER	N	NORTH, NORTHING		\bigcirc R
APPROX APP		Œ.	CENTERLINE		Н	NB	NORTHBOUND		
	CESS RESTRICTION		\bigcirc D			NO.	NUMBER (MUST HAVE PERIOD)	R	RADIUS
	GREGATE SUBBASE	_		H	HEIGHT	NOS.	NUMBERS (MUST HAVE PERIOD)	RD	ROAD
	PHALT TREATED PERMEABLE BASE	_	DEPTH	HDC	HIGH DESERT CORRIDOR	NS	NEAR SIDE	REINF	REINFORCED, REINFORCEME
	PHALT TREATED PERMEABLE MATERIAL		DOUBLE	HR	HOUR	NTS	NOT TO SCALE		REINFORCING
	ENUE		DEGREE	HMA	HOT MIXED ASPHALT	N/A	NOT APPLICABLE	REL	RELOCATE
			DELINEATOR	HORIZ	HORIZONTAL		0	REPL	REPLACEMENT
AT			DETAIL, DETOUR	HP	HINGE POINT, HORSEPOWER			RET	RETAINING
	B		DRAINAGE INLET, DROP INLET	HŞT	HIGH SPEED TRAIN	OBLR	OBLITERATE	REV	REVISED
	B)	DIA	DIAMETER	HSR	HIGH SPEED RAIL	OC	OVERCROSSING	RDWY	ROADWAY
			DIAPHRAGM	HWY	HIGHWAY	OD	OUTSIDE DIAMETER	RM	ROAD-MIXED
	GINNING OF BRIDGE	DIST	DISTANCE, DISTRICT			OF	OUTSIDE FACE	RP	RADIUS POINT, REFERENCE
	GIN HORIZONTAL CURVE	DMBB	DOUBLE METAL BEAM BARRIER			OG	ORIGINAL GROUND	RR	RAILROAD
	GIN CURB RETURN	DR	DRIVE	IB	IMPORTED BORROW	OGAC	OPEN GRADED ASPHALT CONCRETE	RSP	ROCK SLOPE PROTECTION
BEG BEG	GIN	DTBB	DOUBLE THRIE BEAM BARRIER	ID	INSIDE DIAMETER	ОН	OVERHEAD	RT	RIGHT
BIT CTD BIT	TUMINOUS COATED	DWY	DRIVEWAY	IF	INSIDE FACE			RTE	ROUTE
BK BAC	СК			IN	INCH, INCHES		(P)	RW	REDWOOD, RETAINING WALL
BKF BAC	CKFILL		(E)	INT	INTERIOR	Р	PAGE	R/W	RIGHT OF WAY
	ILDING	E	EAST, EASTING	INV	INVERT	PB	PULL BOX	RWY	RAILWAY
	JLEVARD		ACTUAL SUPERELEVATION	IRR	IRRIGATION	P-B	PALMDALE TO BURBANK	144	Marchai
	NCH MARK		UNBALANCED SUPERELEVATION	11	IMIGATION	PC	POINT OF CURVATURE, PRECAST		(S
	TTOM		EASEMENT		J	PCC	POINT OF COMPOUND CURVE,		
	KERSFIELD TO PALMDALE		END OF BRIDGE	JCT	JUNCTION		PORTLAND CEMENT CONCRETE	S	SOUTH, SUPPLEMENT
BR BRII			END HORIZONTAL CURVE	JPCP	JOINTED PLAIN CONCRETE PAVEMENT	PCP	PERFORATED CONCRETE PIPE,	SAE	STRUCTURE APPROACH EMB
			END CURB RETURN			r Gr	PRESTRESSED CONCRETE PIPE	SALV	SALVAGE
			ELEVATION	JT	JOINT	PCVC	POINT OF COMPOUND VERTICAL CURVE		
					K			SB	SOUTHBOUND
DW DAR	RBED WIRE		EXTRALEGAL LEAD NETWORK		Diazonas Ta constitut da abobe anches	PED OC	PEDESTRIAN OVERCEOGGING	SC	SPIRAL TO CURVE
	C		EMBANKMENT	К	DISTANCE TO ACHIEVE 1% GRADE CHANGE		PEDESTRIAN OVERCROSSING	SCRRA	SOUTHERN CALIFORNIA REC
211	DIE ANGUER ACCEMBLY		ENGINEER			PED UC	PEDESTRIAN UNDERCROSSING		RAIL AUTHORITY
	BLE ANCHOR ASSEMBLY		EDGE OF DECK	_		PG	PROFILE GRADE	SD	STORM DRAIN
	NSTRUCTION AREA SIGN	EP	EDGE OF PAVEMENT	L _	LENGTH	PI	POINT OF INTERSECTION	SEC	SECOND
	NCRETE BARRIER		EQUATION, EQUAL	LAT	LATITUDE	PJP	PARTIAL JOINT PENETRATION	SECT	SECTION
	NCRETE BLOCK WALL		EDGE OF SHOULDER	LCB	LEAN CONCRETE BASE	P,PL	PLATE	SEP	SEPARATION
	NTER TO CENTER		EDGE OF TRAVELED WAY	LMF	LIGHT MAINTENANCE FACILITY	P/L	PROPERTY LINE	66	SUBGRADE
	IFORNIA HIGH SPEED RAIL		END VERTICAL CURVE	LN	LANE	PM	POST MILE, TIME FROM NOON TO MIDNIGH	1 (SHOULDER
-	THORITY		ENDWALL	LOC	LOCATION	PN	PAVING NOTCH	SHLD SHT	SHEET
	_IFORNIA HIGH SPEED TRAIN	EXC	EXCAVATION	LOL	LAYOUT LINE	POB	POINT OF BEGINNING		
CHSR CAL	_IFORNIA HIGH SPEED RAIL	EXIST, EX	• EXISTING	LONG	LONGITUDE	POC	POINT OF HORIZONTAL CURVE	SIM	SIMILAR
CG CEN	NTER OF GRAVITY	EXP	EXPANSION	LONGIT	LONGITUDINAL	POE	POINT OF ENDING	S	STATION LINE
CHNL CHA	ANNEL	EXP JT	EXPANSION JOINT	LT	LEFT	POT	POINT OF TANGENT	SM	SELECTED MATERIAL
CI CAS	ST IRON	EXWY	EXPRESSWAY			POVC	POINT OF VERTICAL CURVE	SPEC	SPECIAL, SPECIFICATIONS
CIDH CAS	ST-IN-DRILLED-HOLE	EXT	EXTERIOR		<u> </u>	PP	PIPE PILE, PLASTIC PIPE, POWER POLE	SS	SLOPE STAKE, SPIRAL TO
	NTERLINE, CLASS			MAINT	MAINTENANCE	PPEF	PROPOSED PERMANENT	SR	STATE ROUTE
	ASS 2		<u> </u>	MAX	MAXIMUM		ENVIRONMENTAL FOOTPRINT	ST	STREET, SPIRAL TO TANGE
		FEBT	FACING EASTBOUND TRAFFIC	MB	METAL BEAM	PRC	POINT OF REVERSE CURVE	STA	STATION
	EAR, CLEARANCE		FINISHED GRADE	MBB	METAL BEAM BARRIER	PROP	PROPOSED	STBB	SINGLE THRIE BEAM BARRI
	JNTY		FLOW LINE	MBGR	METAL BEAM GUARD RAILING	PRF	POINT OF VERTICAL CURVE	STD	STANDARD
	_UMN		FACING NORTHBOUND TRAFFIC	MED	MEDIAN	PRVC	PAVEMENT REINFORCING FABRIC	STR	STRUCTURE
	NCRETE		FACE OF CONCRETE		MINIMUM	PS&E	POINT OF REVERSE VERTICAL CURVE	SRS	STAND ALONE RADIO SITE
	NECTOR		FRONTAGE ROAD	MIN		PS,P/S	PLANS, SPECIFICATIONS AND ESTIMATES	SURF	SURFACING
	NNECTOR NSTRUCT, CONSTRUCTION		FAR SIDE, FINISHED SURFACE	MISC	MISCELLANEOUS	PS,P75 PSP	PRESTRESSED, PARALLEL STATION	SW	SIDEWALK, SOUND WALL
	·		·	M/L	MAIN LINE (RAILWAY)	-		SWR	SEWER .
			FACING SOUTHBOUND TRAFFIC	MOD	MODIFIED, MODIFY	PT	POINT OF VERTICAL INTERSECTION	SWS	SWITCHING STATION
COORD COO	DRDINATE	FT	FOOT, FEET	MON	MONUMENT	PVI	POINT OF VERTICAL INTERSECTION		
			J.C. ALAMILLA				CALIFORNIA HIGH-S	SPEED RA	AIL PROJECT CONTRAC
			DRAWN BY				PALMDALE		''
			A. SANZ CHECKED BY PEPD RECORD SET REV 02	(1)			l l		1 6
+++			W. GUO	SEN			ALIGNMENT "REF		DATIONS SCALE
			IN CHARGE NOT FOR	S	CALIFO	ORNIA	ROADWAYS AND G		RATIONS
			A.RELANO CONSTRUCTION		HIGH-SPEED RAI		ABBRE	VIATIONS	SHEET NO
BY CHK AP	APP DESCRIPTION		04/30/2021		1		1		l

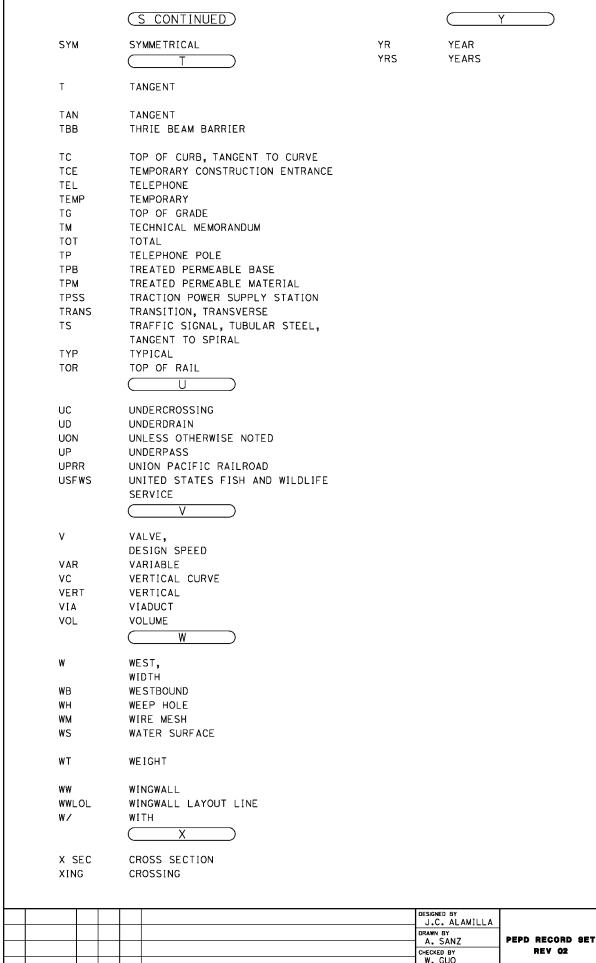

DESCRIPTION


DATE

BY CHK APP

GENERAL NOTES

- 1. THE FOLLOWING ARE ROADWAY DESIGN STANDARD AND GUIDELINES:
 - A. CALTRANS HIGHWAY DESIGN MANUAL (2016)
 - B. AASHTO ROADSIDE DESIGN GUIDE (2011)
 - C. APPLICABLE LOCAL DESIGN STANDARD AND GUIDELINES (I.E., CITY OF PALMDALE)
- 2. STA 296+82.67 (SPRUCE CT) IS THE NORTHERN LIMIT OF THE PALMDALE-BURBANK ENVIRONMENTAL DOCUMENT. NORTH OF THIS POINT REFERS TO BAKERSFIELD-PALMDALE ENVIRONMENTAL DOCUMENT. DESIGN FEATURES BETWEEN STA 265+00.00 AND STA 296+82.67 (SPRUCE CT) SHOWN FOR REFERENCE ONLY.

LEGEND

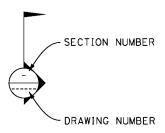

PROPOSED RIGHT OF WAY EXISTING RIGHT OF WAY RETAINING WALL FILL

CUT NOISE BARRIER (POTENTIAL)

OG / ORIGINAL GROUND

REMOVE BASE & SURFACING


POINT OF MINIMUM VERTICAL CLEARANCE

WATER SURFACE


ESTIMATED 100-YEAR FLOOD ELEVATION



EXISTING HIGH VOLTAGE TOWER

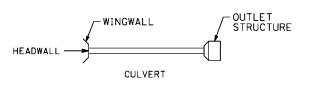

255+00 260+00 265+00 CONTROL LINE EXAMPLE "A" LINE

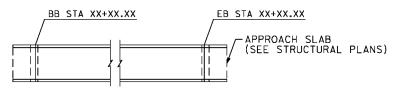

BRIDGE STRUCTURE

CALIFORNIA HIGH-SPEED RAIL PROJECT PALMDALE TO BURBANK

ALIGNMENT "REFINED SR14/E1/E2" ROADWAYS AND GRADE SEPARATIONS ABBREVIATIONS AND LEGEND


CONTRACT NO.
HSR14-42
DRAWING NO.
CV-B0005
SCALE
NO SCALE
SHEET NO.

NOT FOR CONSTRUCTION 04/30/2021

N CHARGE A.RELANO






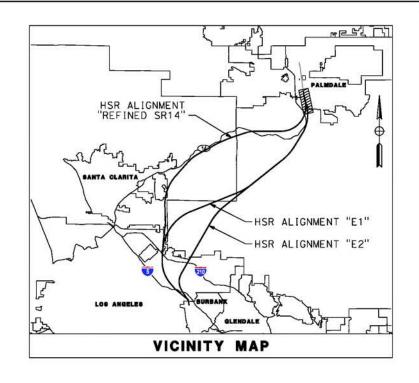

LEGEND:

ROADWAY PLAN AND ACCESS ROAD PLAN

GRADE SEPARATION PLAN

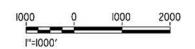

							J.C. ALAMILLA	
-	\dashv						DRAWN BY A. SANZ	P
-	-		_				W. GUO	
8	\exists					<u>. </u>	IN CHARGE A. RELANO	
O RE	Eν	DATE	BY	СНК	APP	DESCRIPTION	DATE 04/30/2021	

PEPD RECORD SET REV 02 NOT FOR CONSTRUCTION








CALIFORNIA HIGH-SPEED RAIL PROJECT PALMDALE TO BURBANK


ALIGNMENT "REFINED SR14"
ROADWAY AND GRADE SEPARATION PLAN
KEY MAP
SHEET 1 OF 4

SCALE	4-					
SCALE	ORAWING NO. CV-B0001-S14					
AS SHOWN	HAVOO					

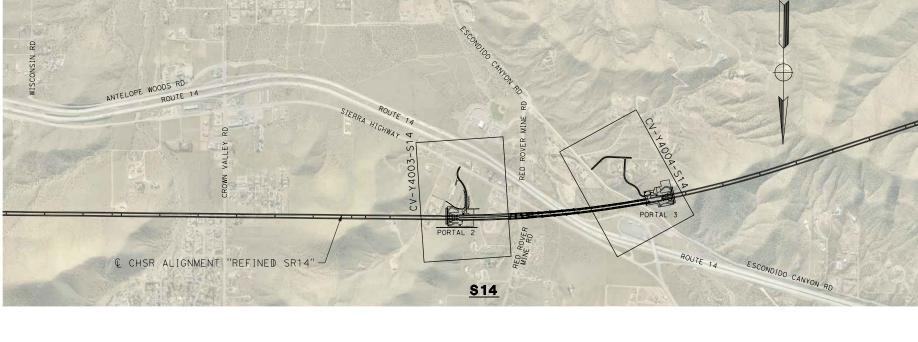

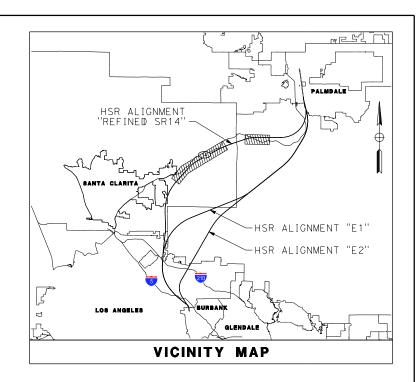

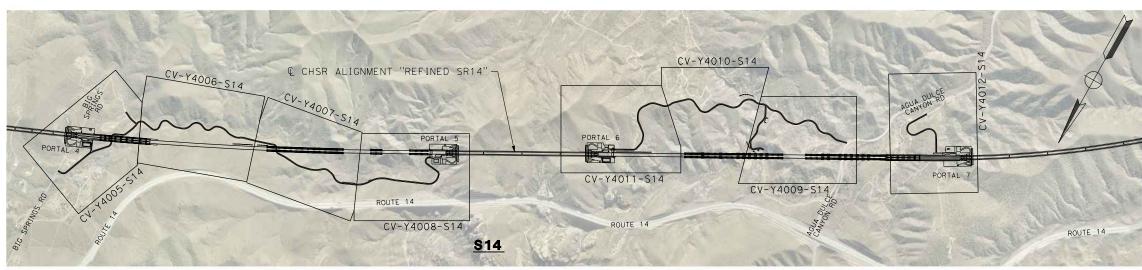

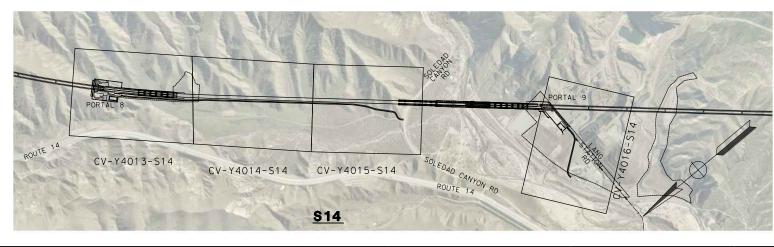

ROADWAY PLAN AND ACCESS ROAD PLAN

						DESIGNED BY J.C. ALAMILLA
						DRAWN BY D. CORDOBA
						CHECKED BY
						I. LAQUIDAIN
						IN CHARGE A. RELAÑO
REV	DATE	BY	СНК	APP	DESCRIPTION	DATE 12/30/2023

PEPD RECORD SET REV 02 NOT FOR

CONSTRUCTION


୬⊕ sener 🖟




CALIFORNIA HIGH-SPEED RAIL PROJECT PALMDALE TO BURBANK

ALIGNMENT "REFINED SR14"
ROADWAY AND GRADE SEPARATION PLAN
KEY MAP
SHEET 2 OF 4

CONTRACT NO. HSR14-42
DRAWING NO.
CV-B0002-S14
SCALE
AS SHOWN
CUEET NO

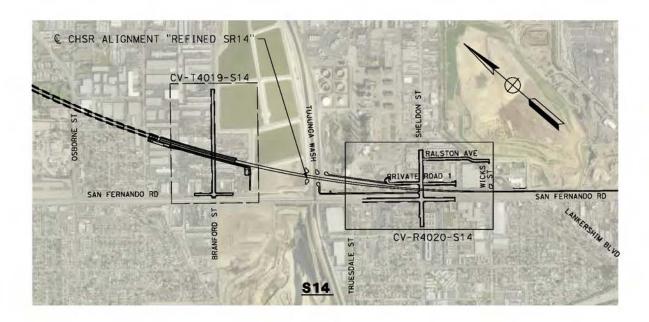


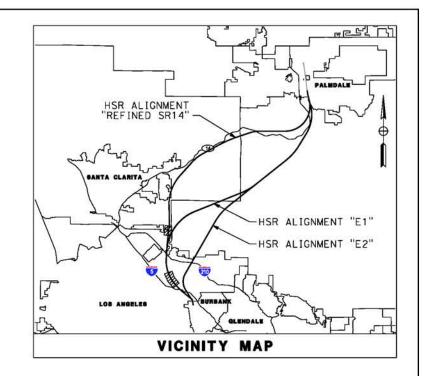



ROADWAY PLAN AND ACCESS ROAD PLAN

GRADE SEPARATION PLAN

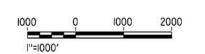

						J.C. ALAMILLA	
						DRAWN BY A. SANZ	P
-		+				W. GUO	j.
						IN CHARGE A. RELANO	
REV	DATE	ВΥ	СНК	APP	DESCRIPTION	DATE 04/30/2021	

PEPD RECORD SET REV 02 NOT FOR

CONSTRUCTION






CALIFORNIA HIGH-SPEED RAIL PROJECT PALMDALE TO BURBANK

ALIGNMENT "REFINED SR14"
ROADWAY AND GRADE SEPARATION PLAN
KEY MAP SHEET 3 OF 4

CONTRACT NO. HSR14-42					
DRAWING CV-	NO. В0003-S14				
SCALE	SHOWN				

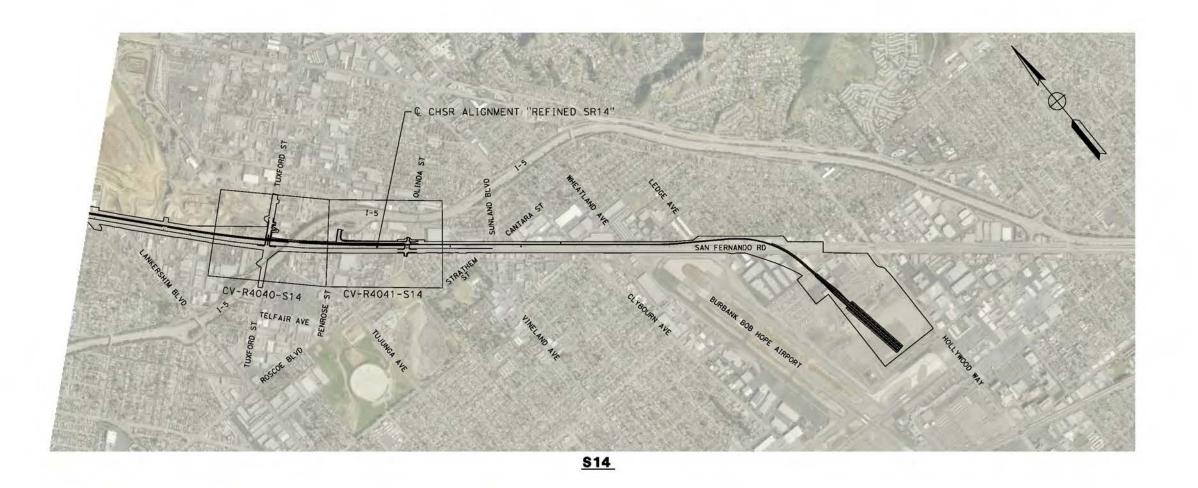

LEGEND:

1"=1000"

ROADWAY PLAN

o 1000 2000

1							
						J.C. ALAMILLA	
\square		\perp				DRAWN BY A. SANZ	P
-		-				CHECKED BY W. GUO	
H		-				IN CHARGE A. RELANO	
REV	DATE	BY	СНК	APP	DESCRIPTION	DATE 04/30/2021	

PEPD RECORD SET REV 02

NOT FOR CONSTRUCTION








CALIFORNIA HIGH-SPEED RAIL PROJECT PALMDALE TO BURBANK


ALIGNMENT "REFINED SR14"
ROADWAY AND GRADE SEPARATION PLAN
KEY MAP
SHEET 4 OF 4

CON	FRACT NO. HSR14-42
DRAN	WING NO. V-B0004-S14
SCAL	.ε
	AS SHOWN

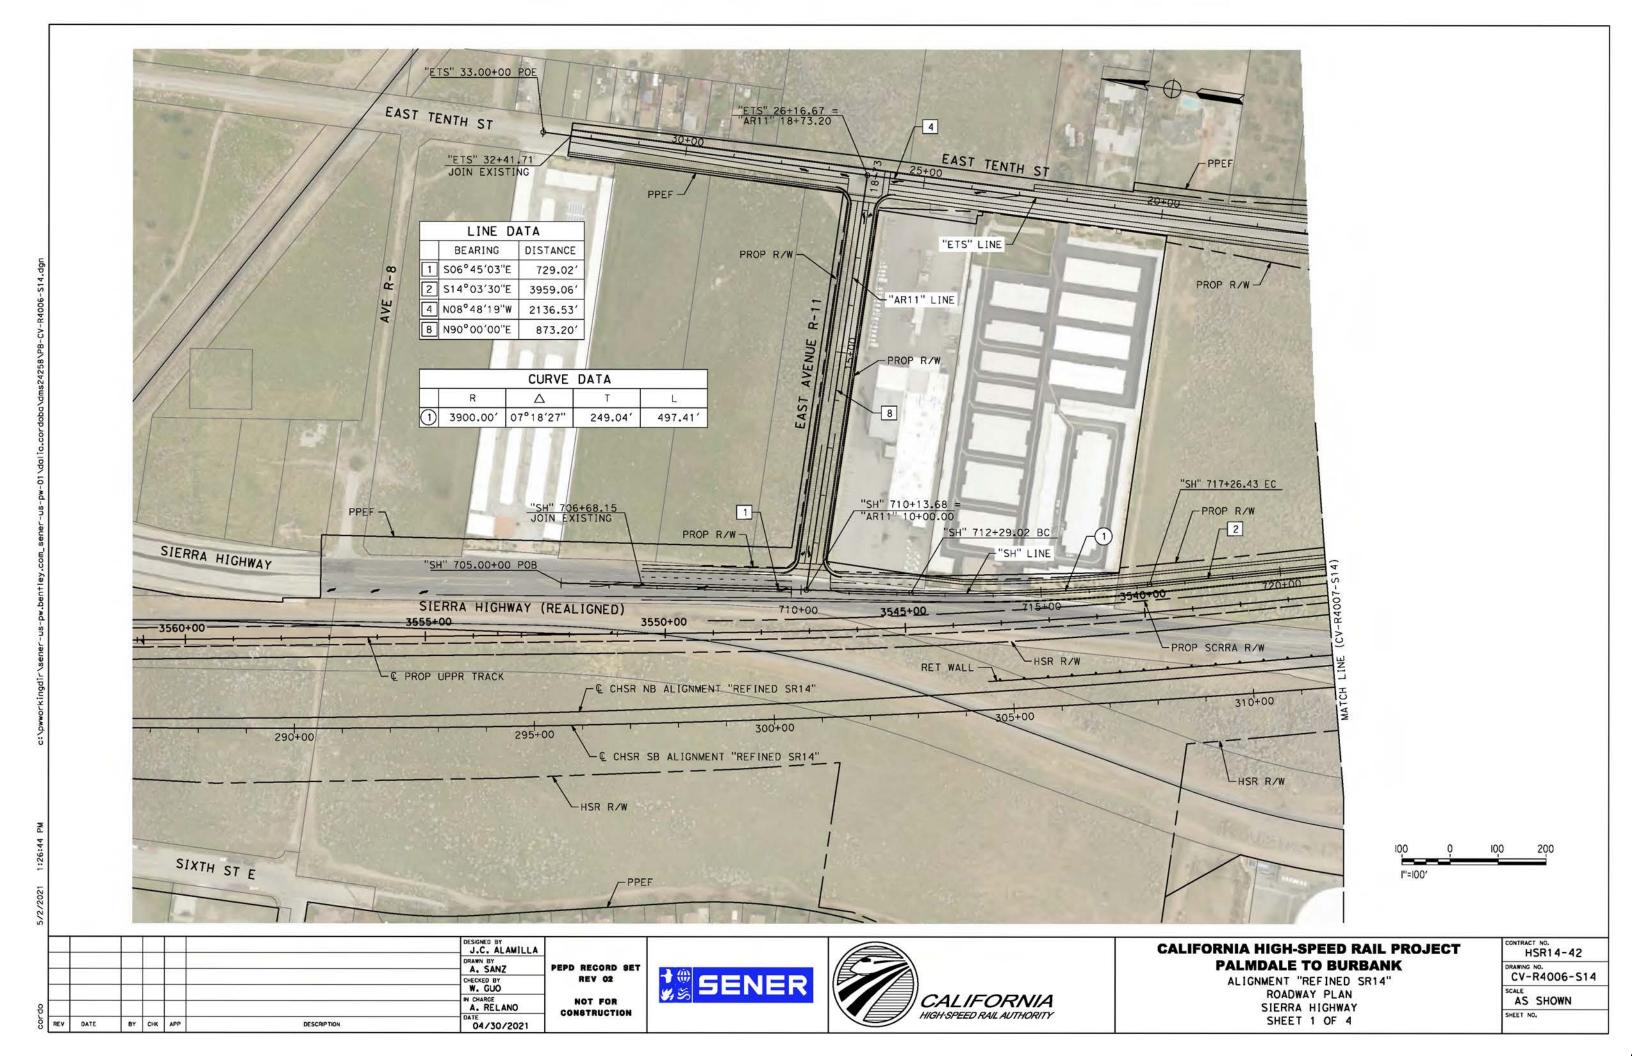

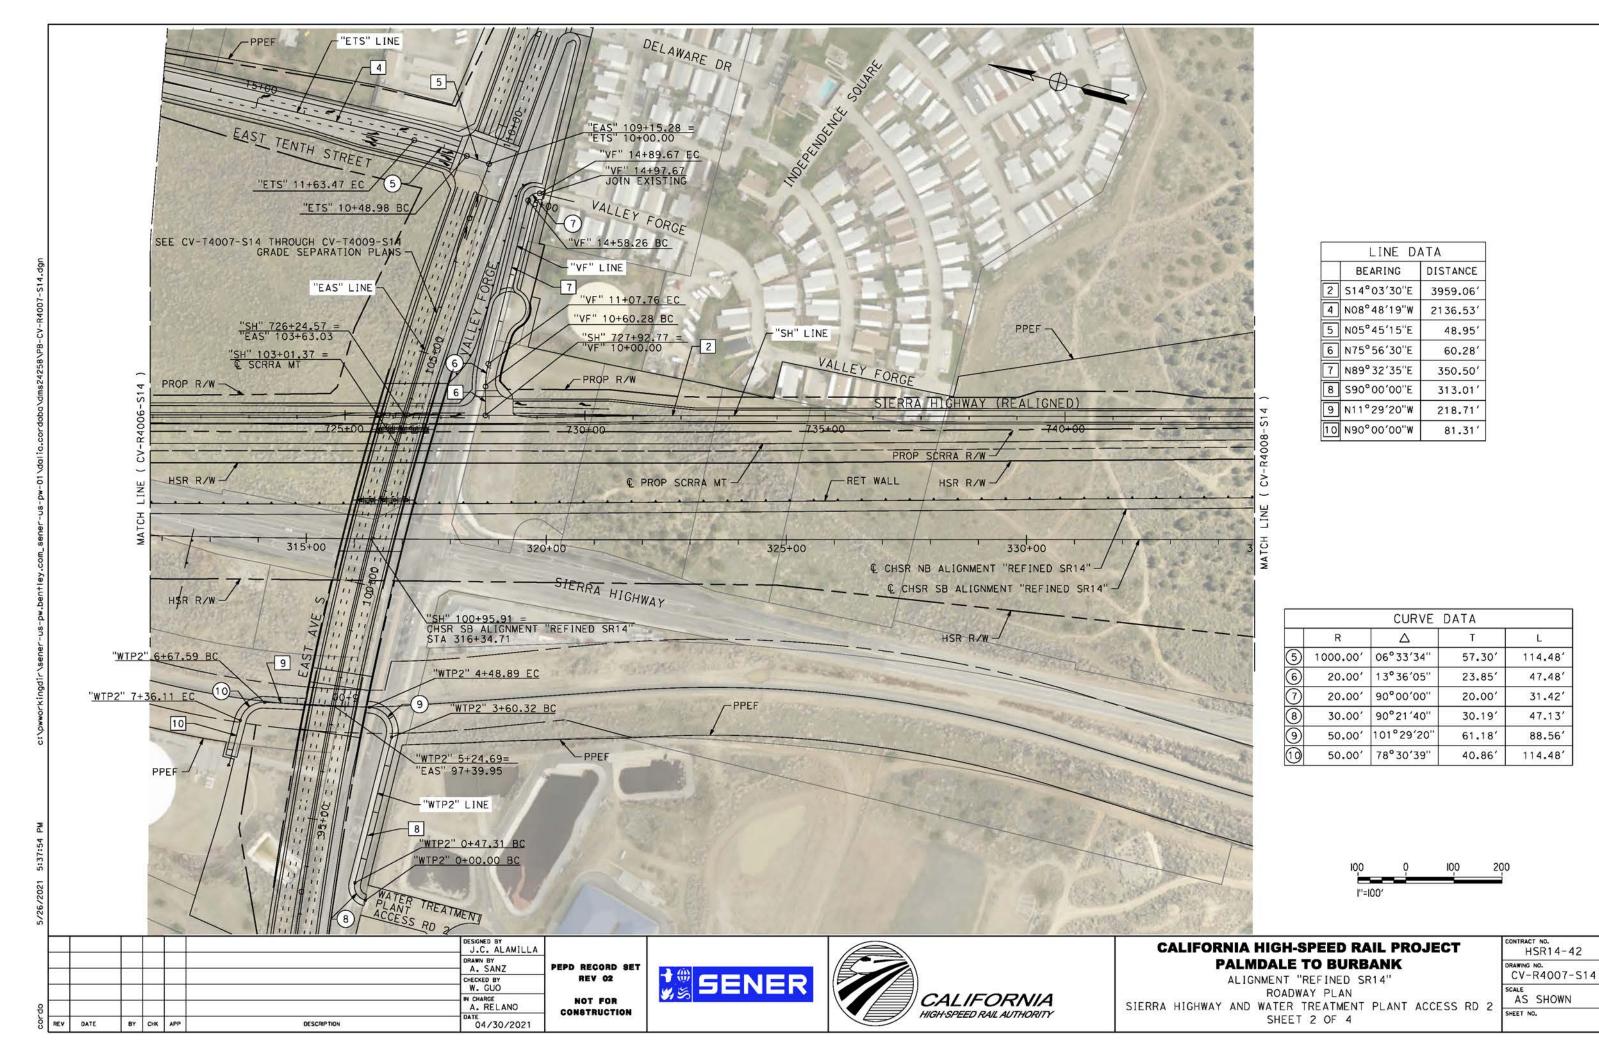

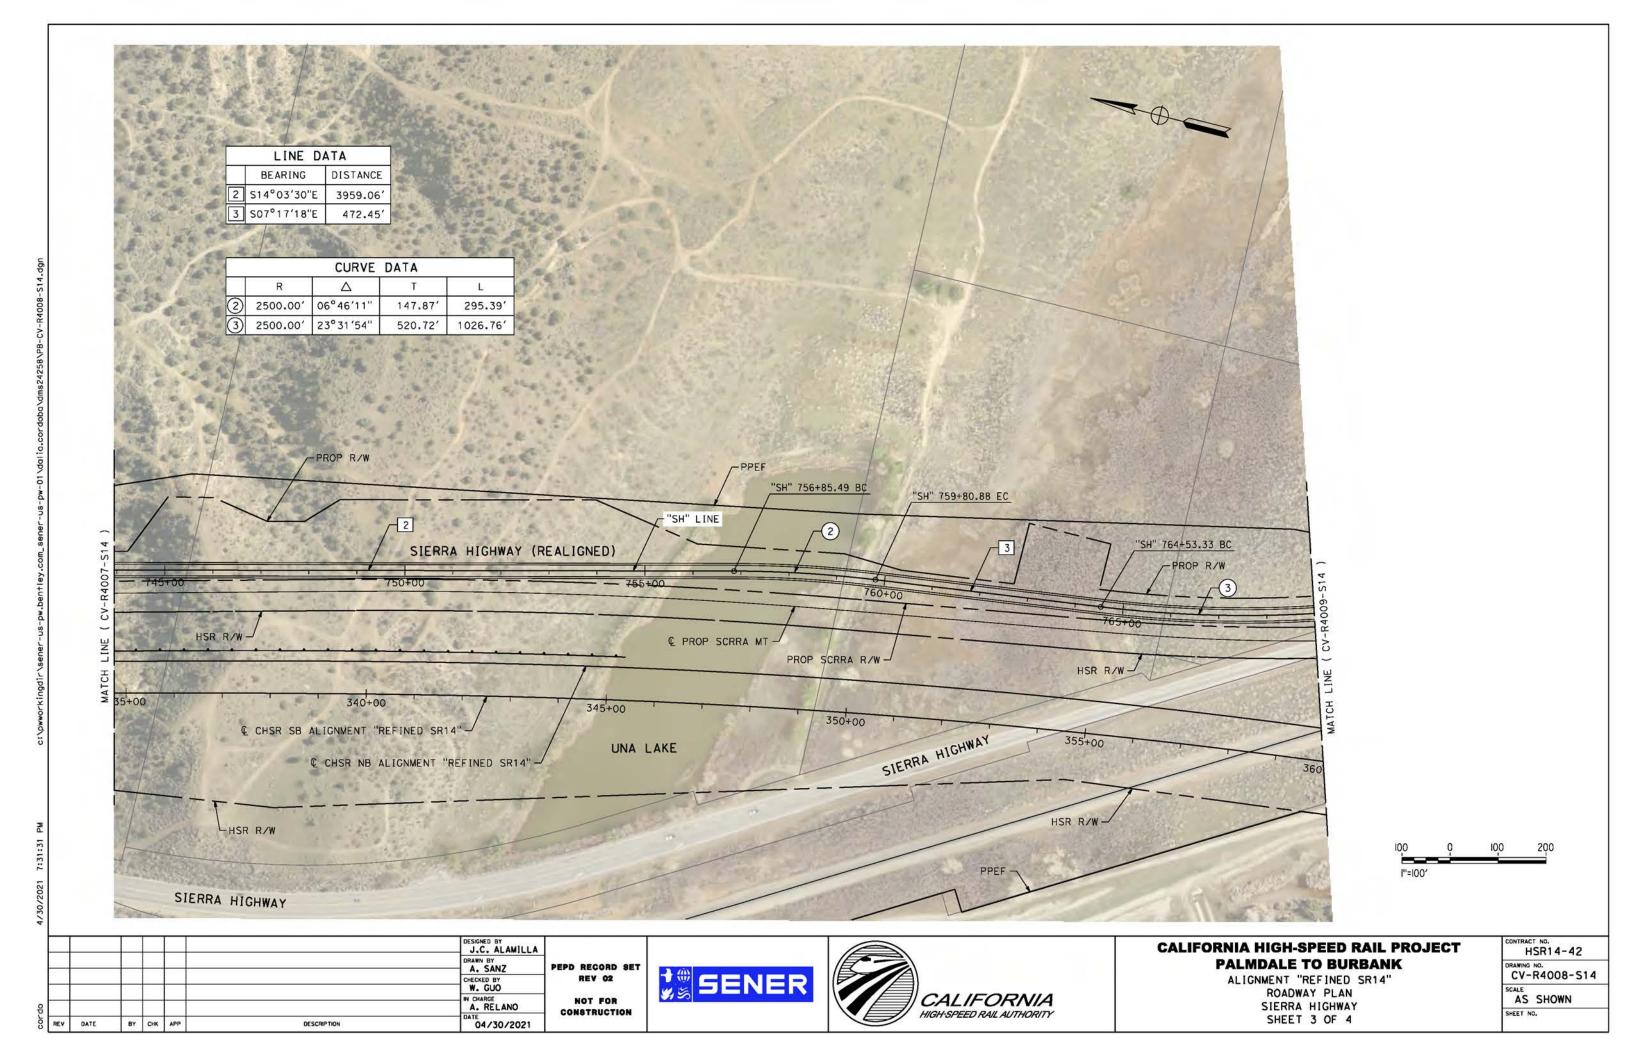

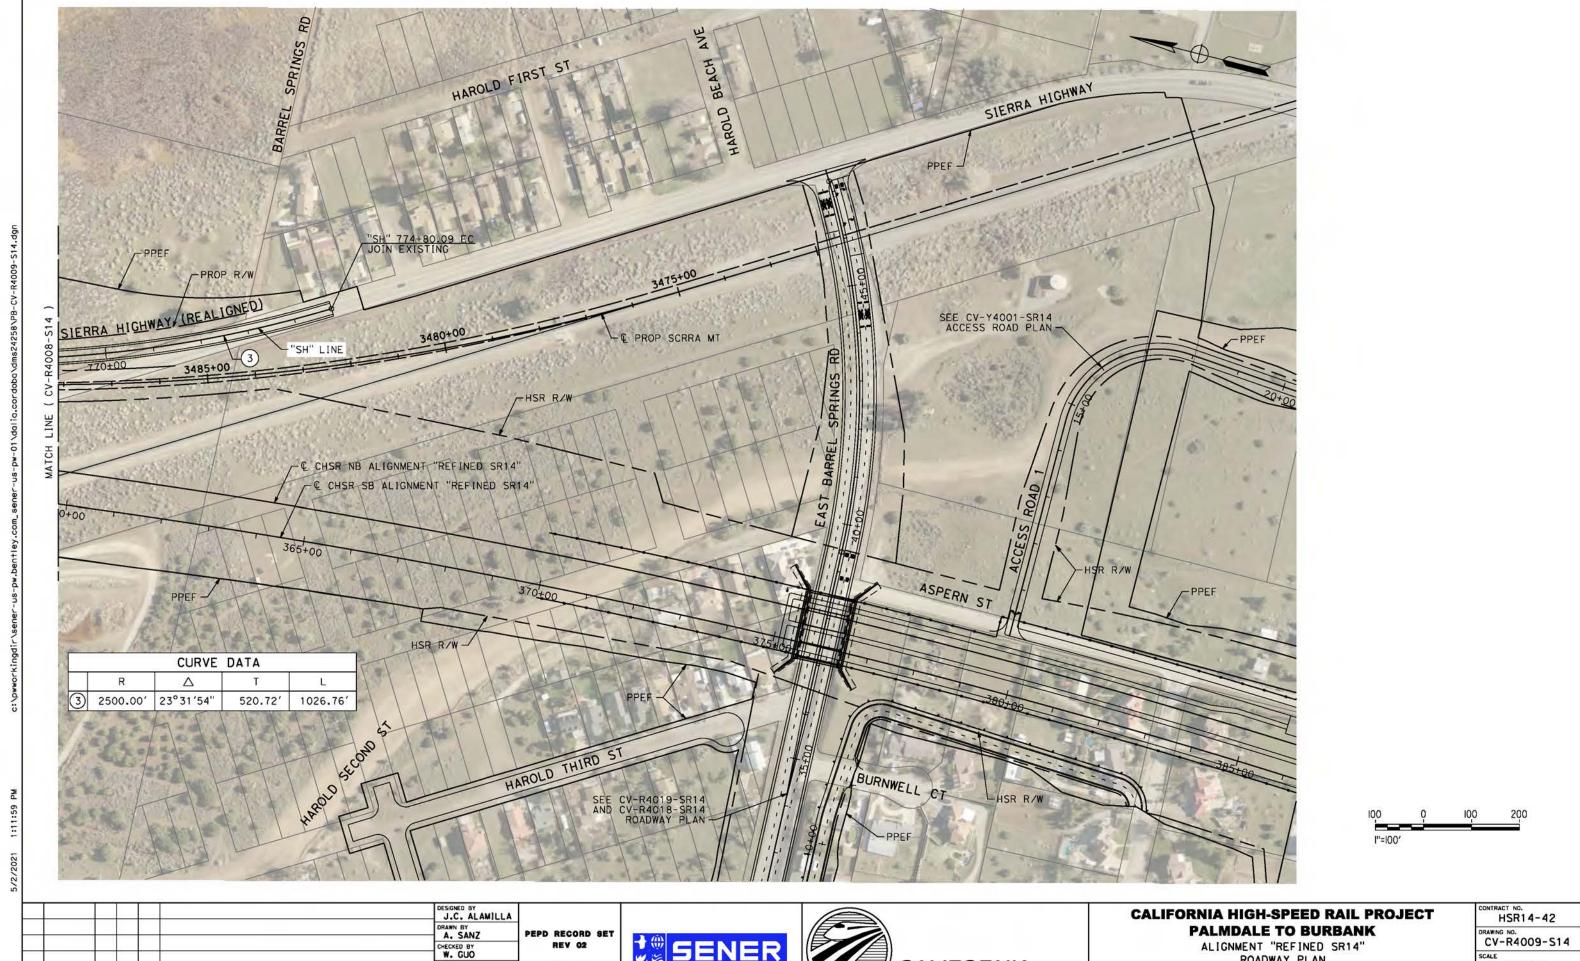

DATE

BY CHK APP

DESCRIPTION

A. RELANO NOT FOR CONSTRUCTION


04/30/2021


SENER





ALIGNMENT "REFINED SR14"
ROADWAY PLAN SIERRA HIGHWAY SHEET 4 OF 4

HSR14-42					
DRAWING CV-	[№] . R4009-S14				
SCALE	SHOWN				
SHEET N	0.				

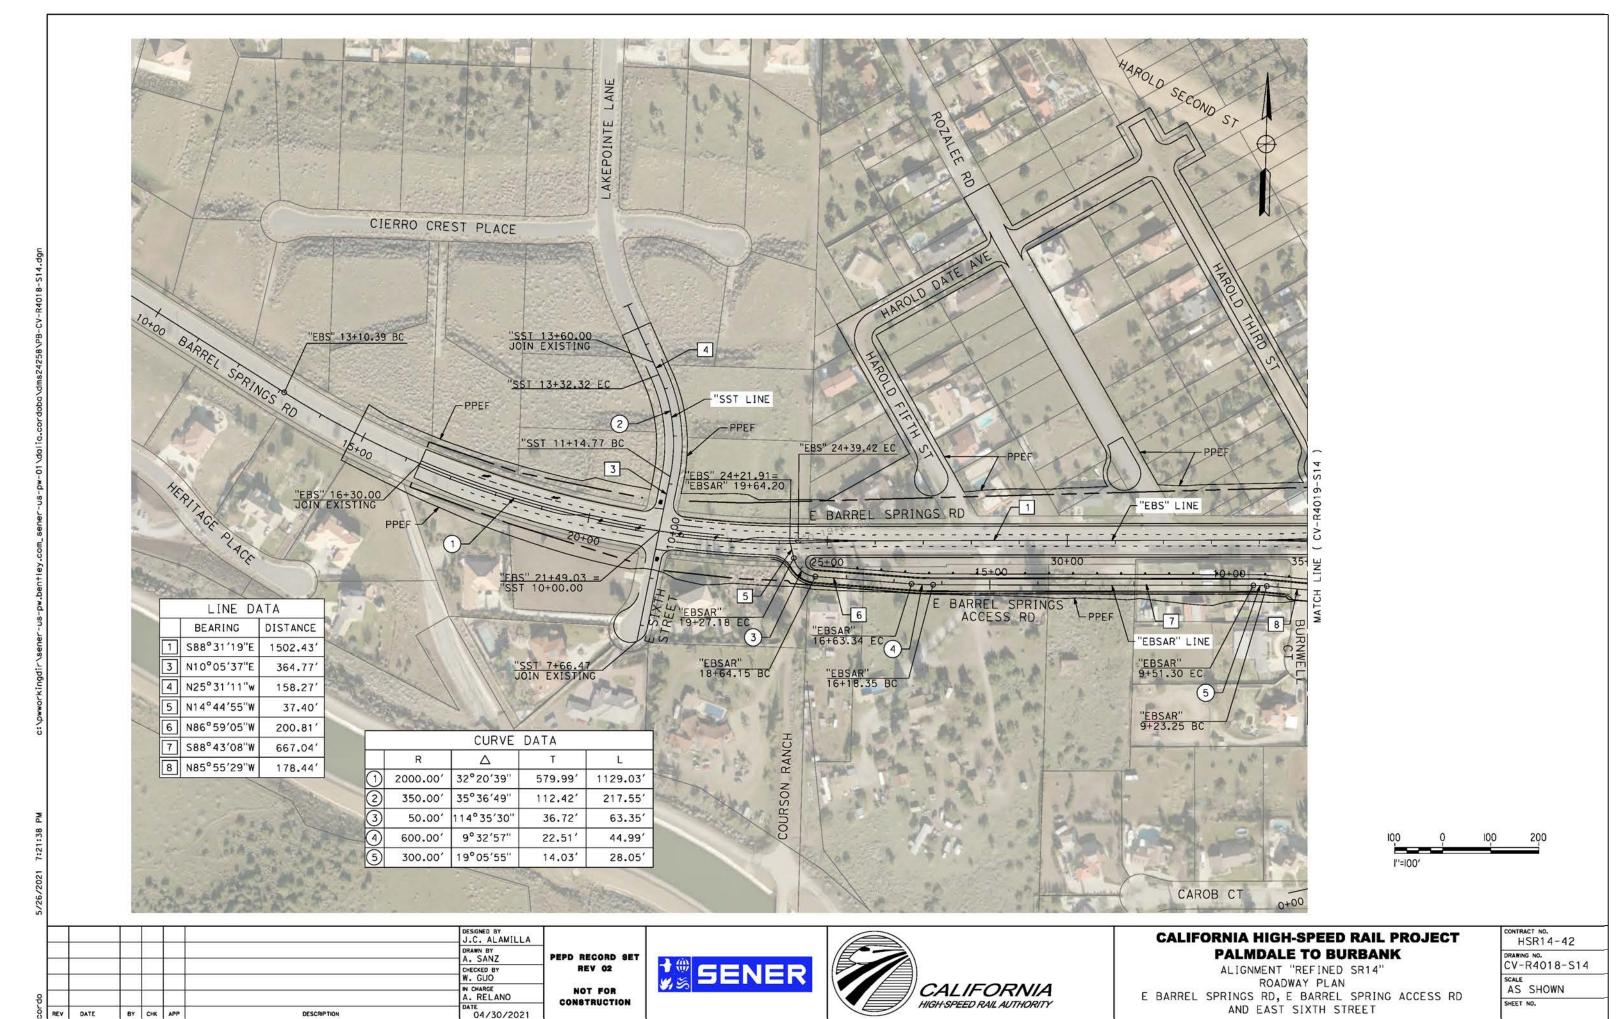

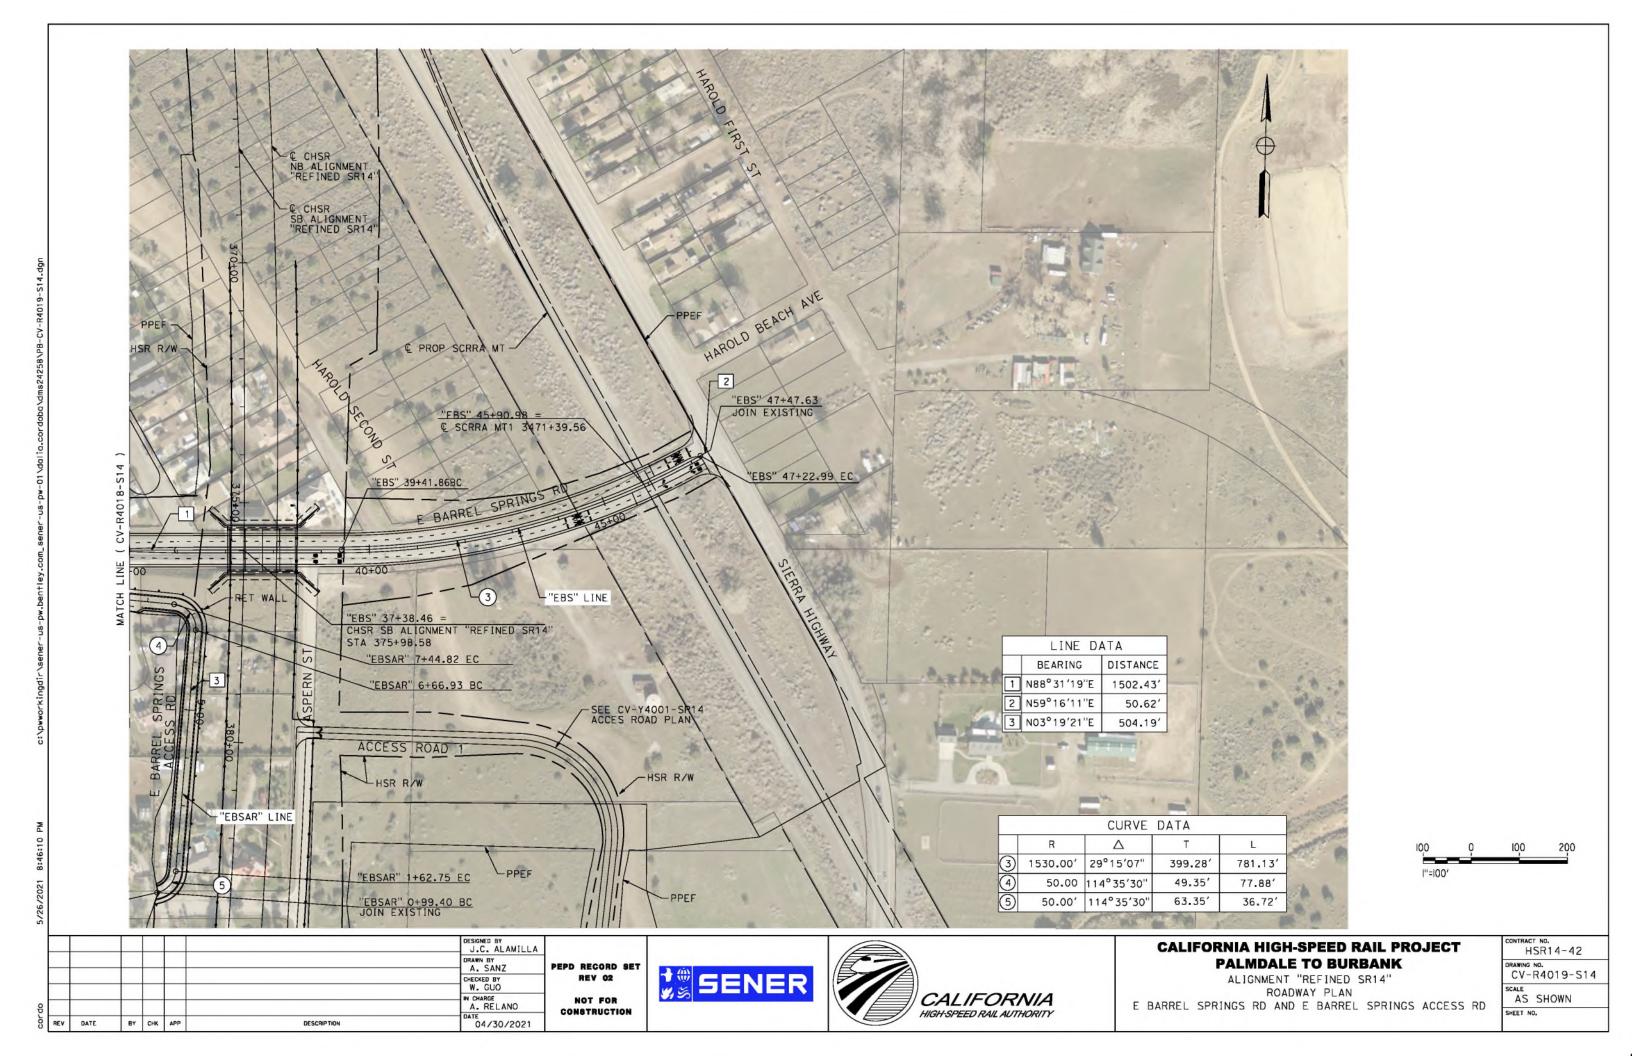

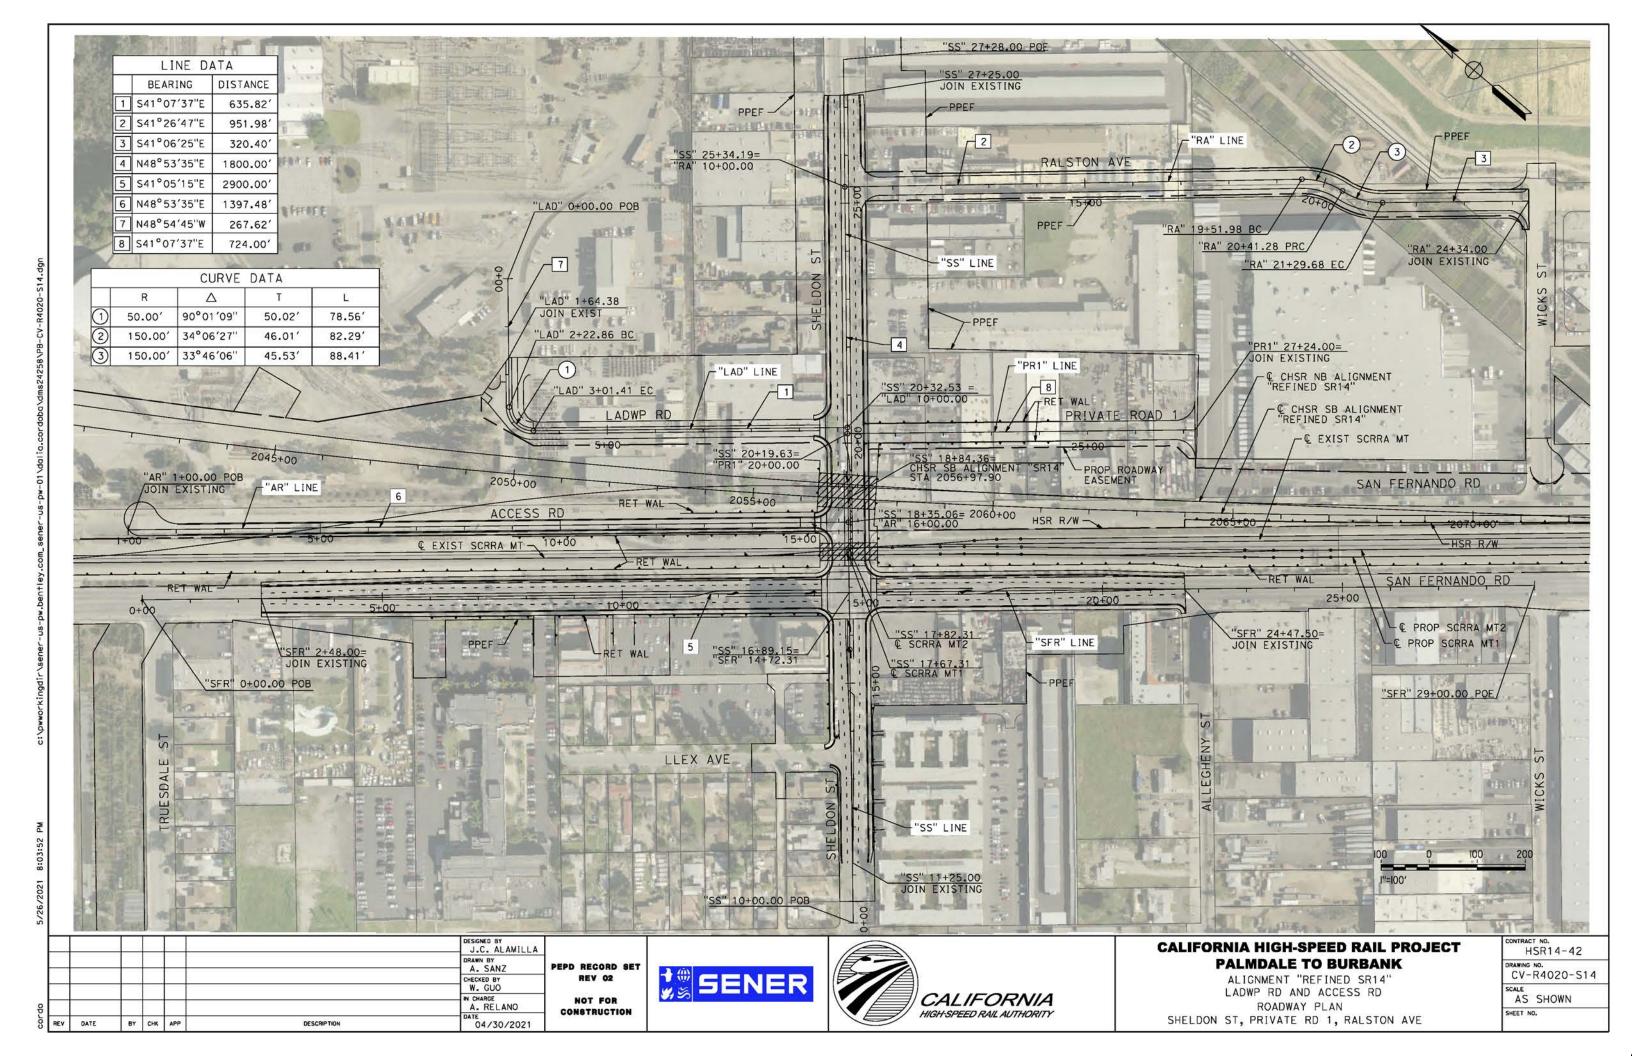

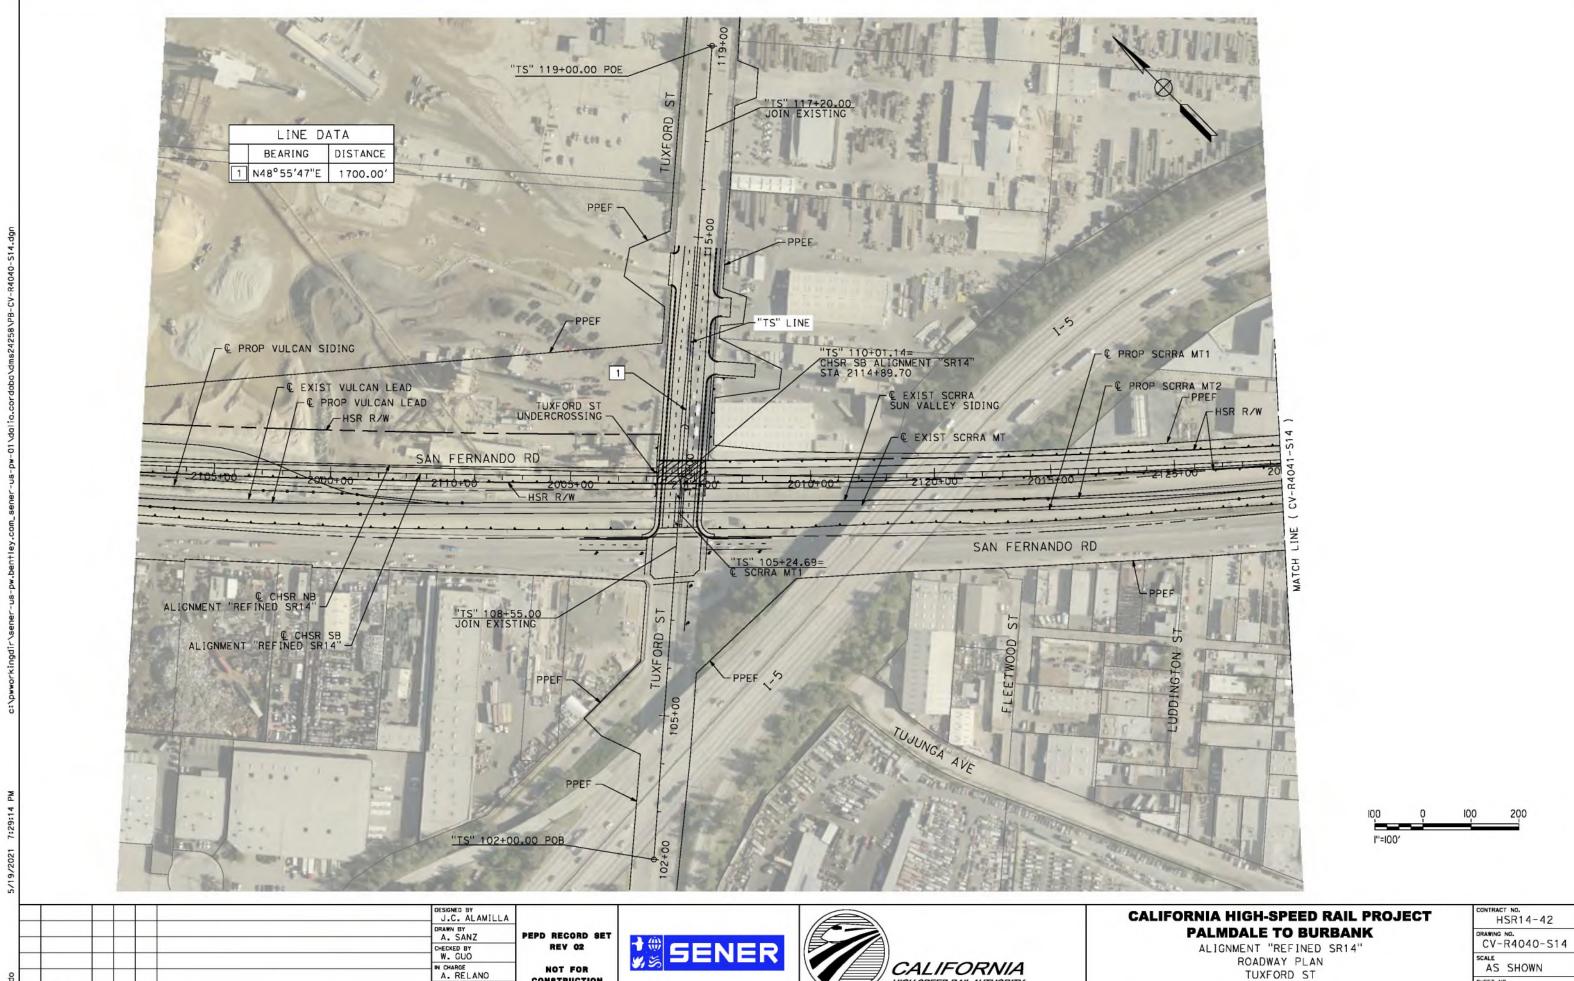

HIGH-SPEED RAIL AUTHORITY

CONSTRUCTION


04/30/2021


DATE


BY CHK APP


DESCRIPTION


AS SHOWN SHEET NO.

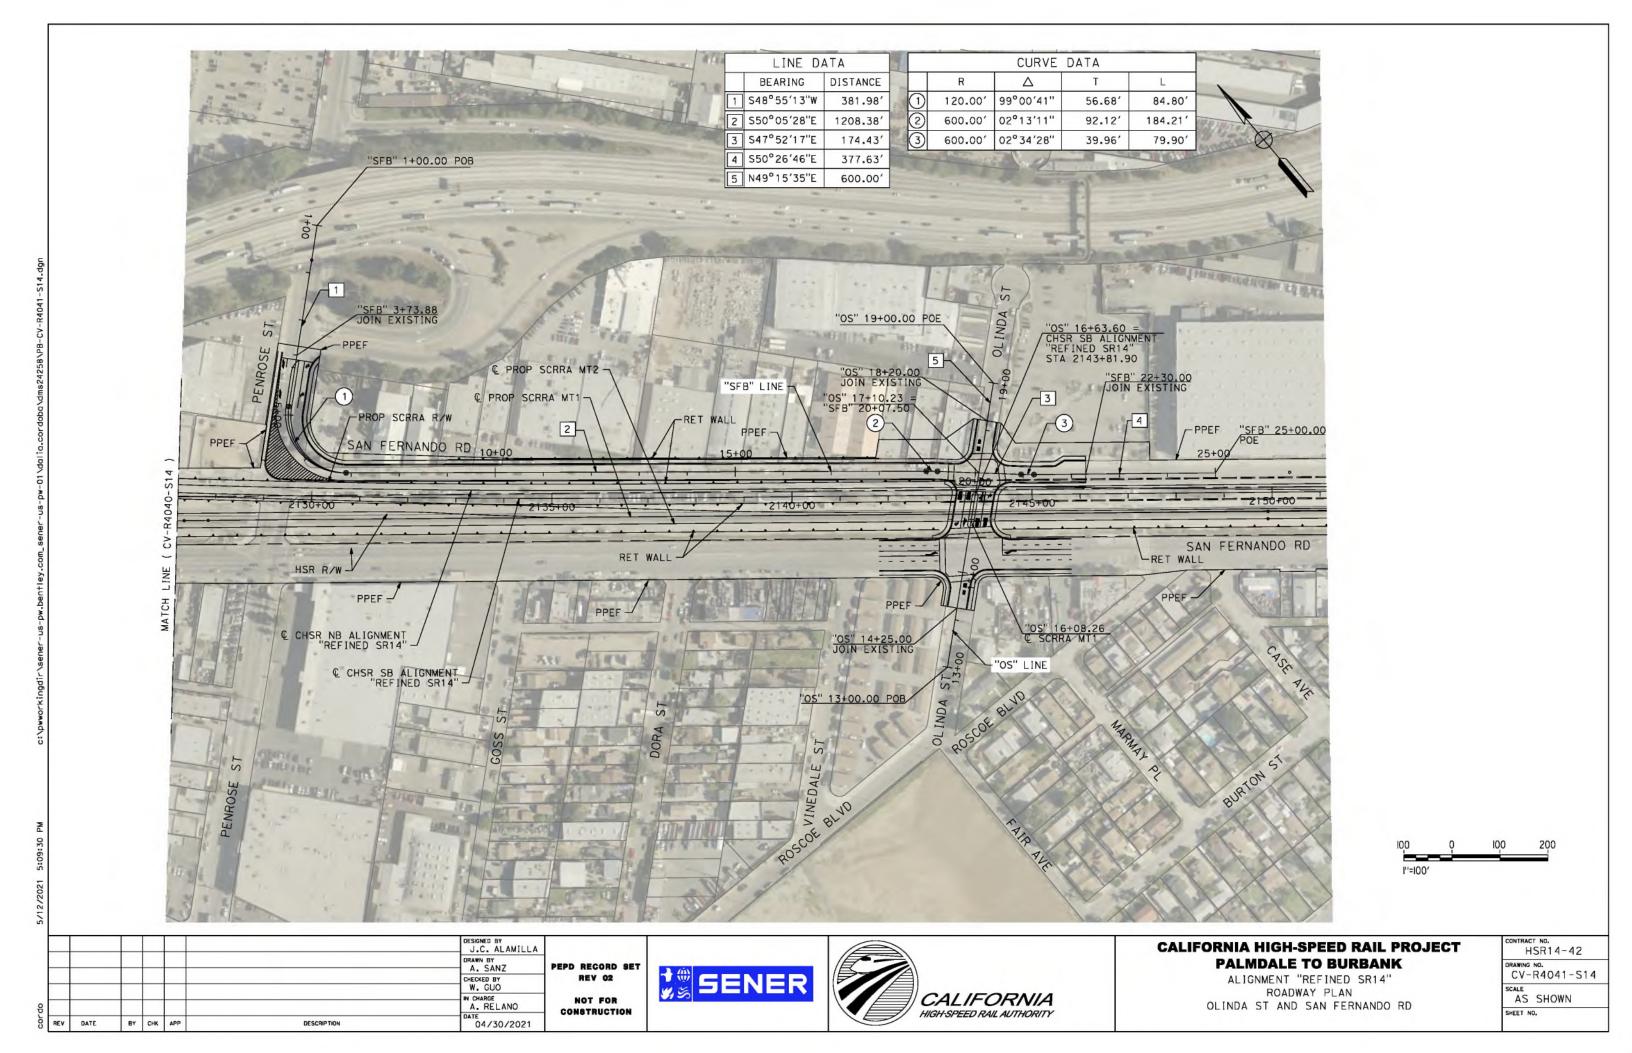


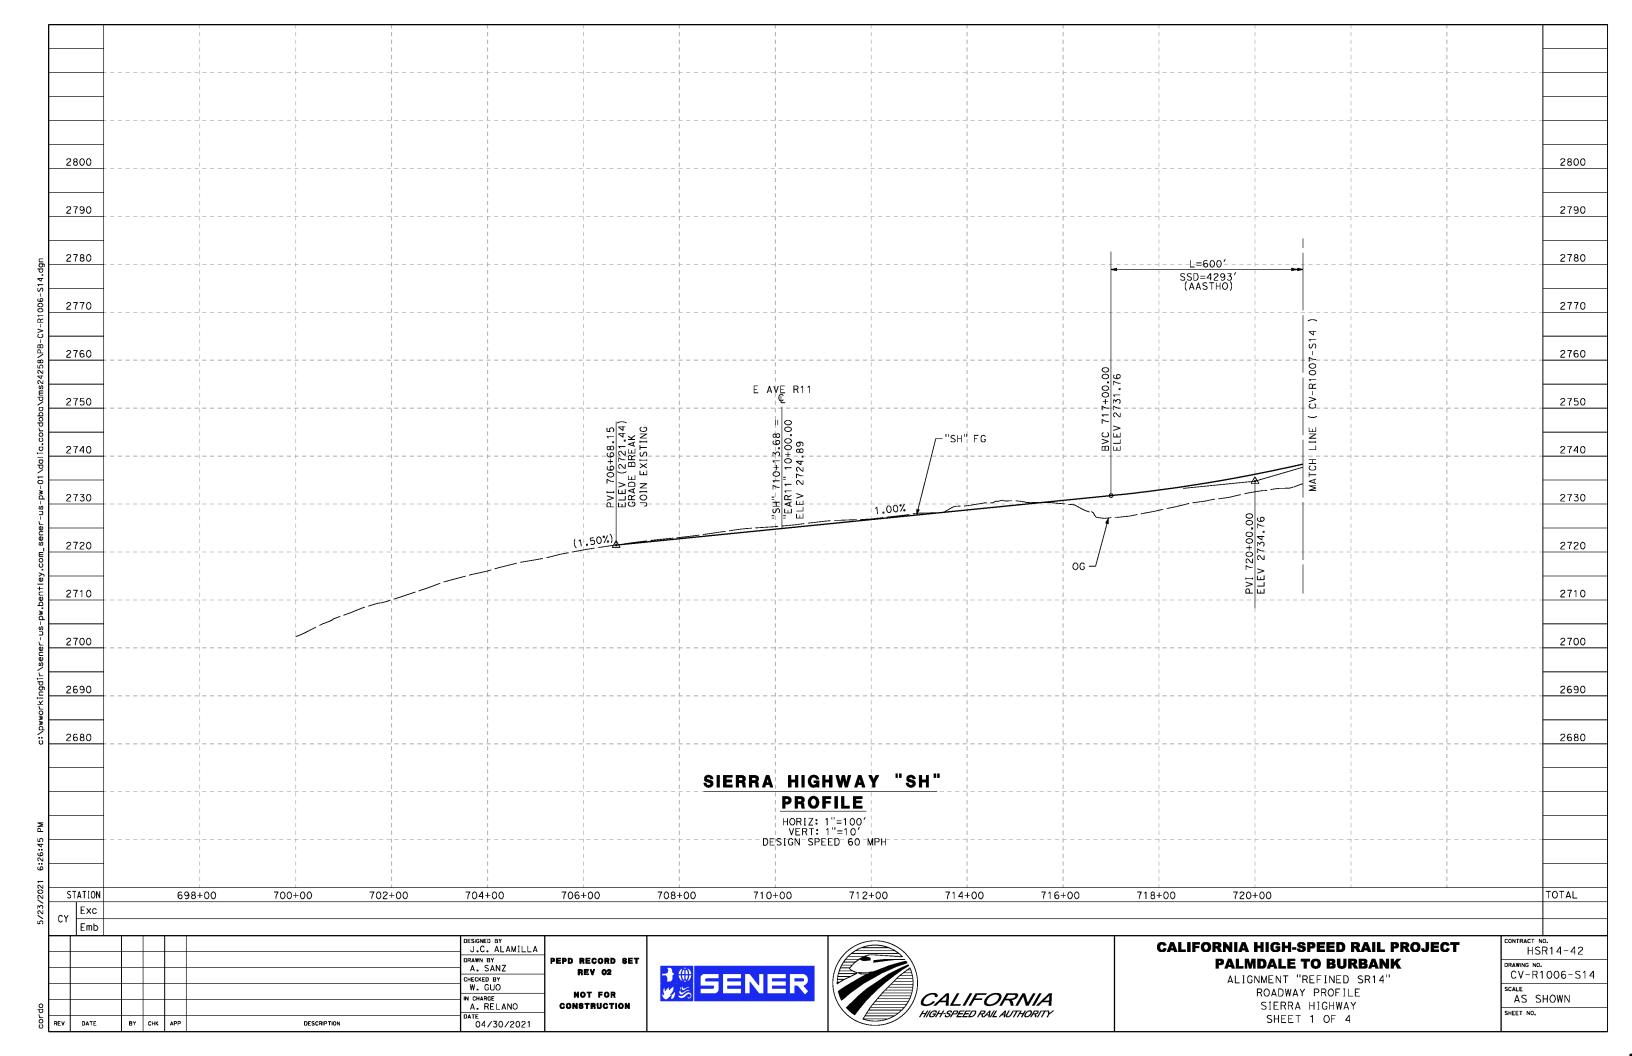


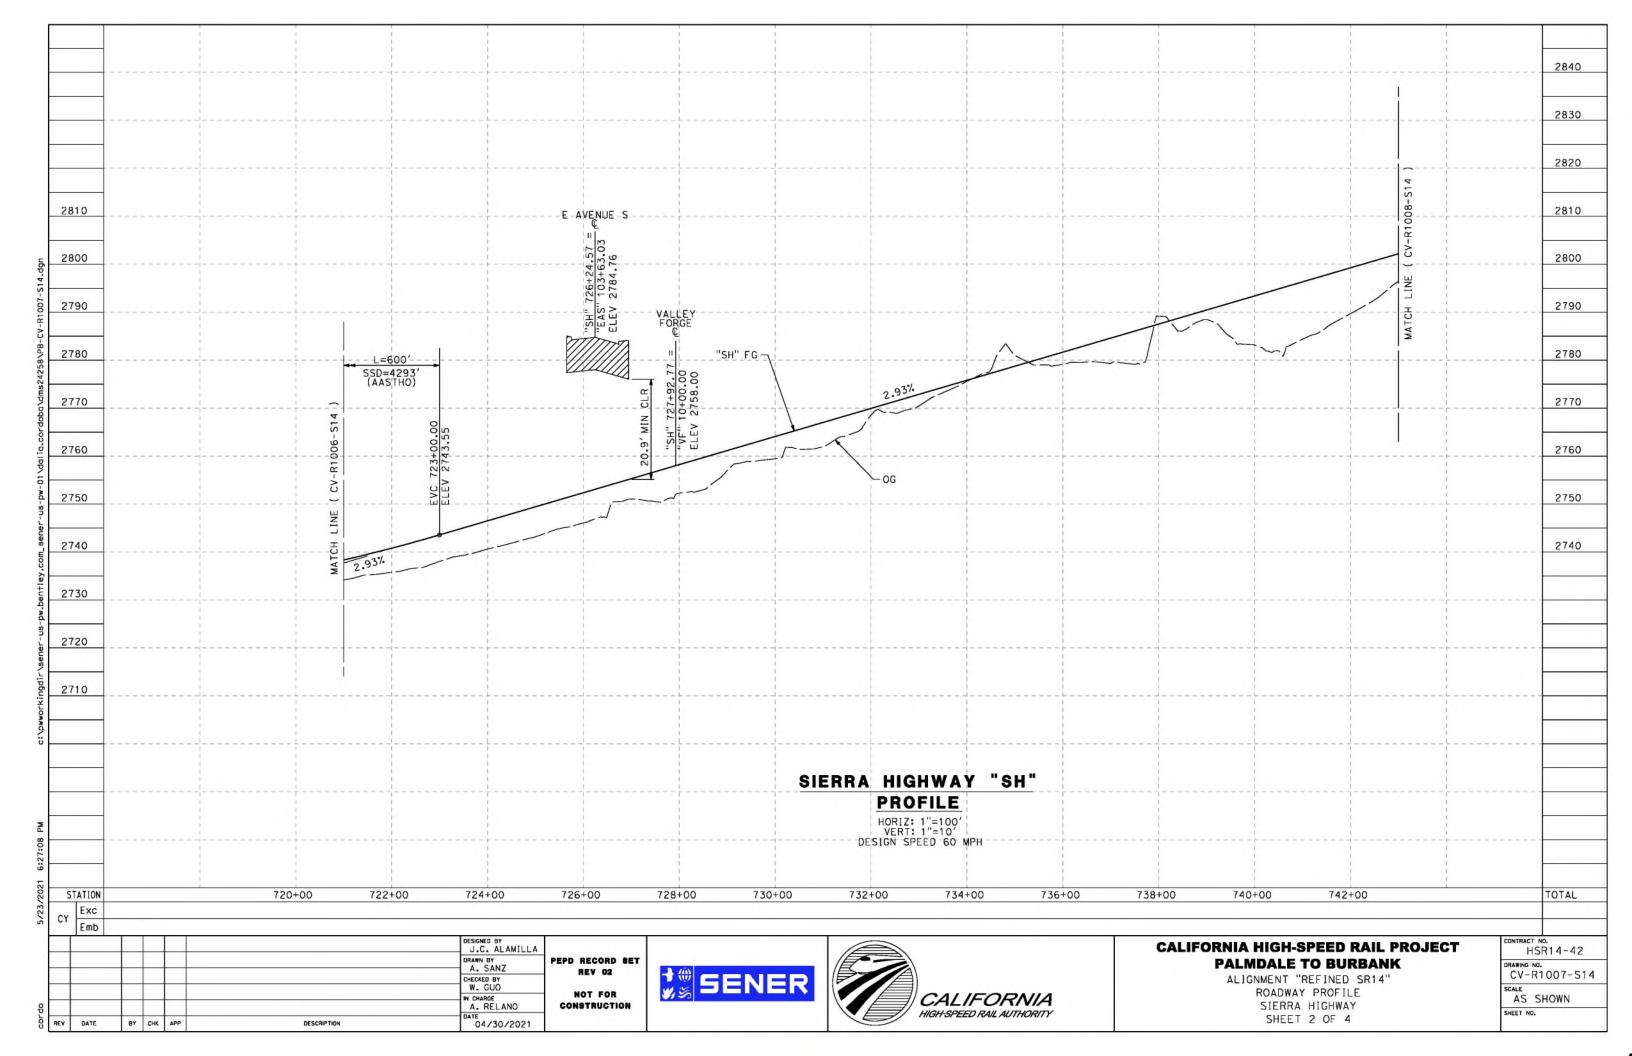


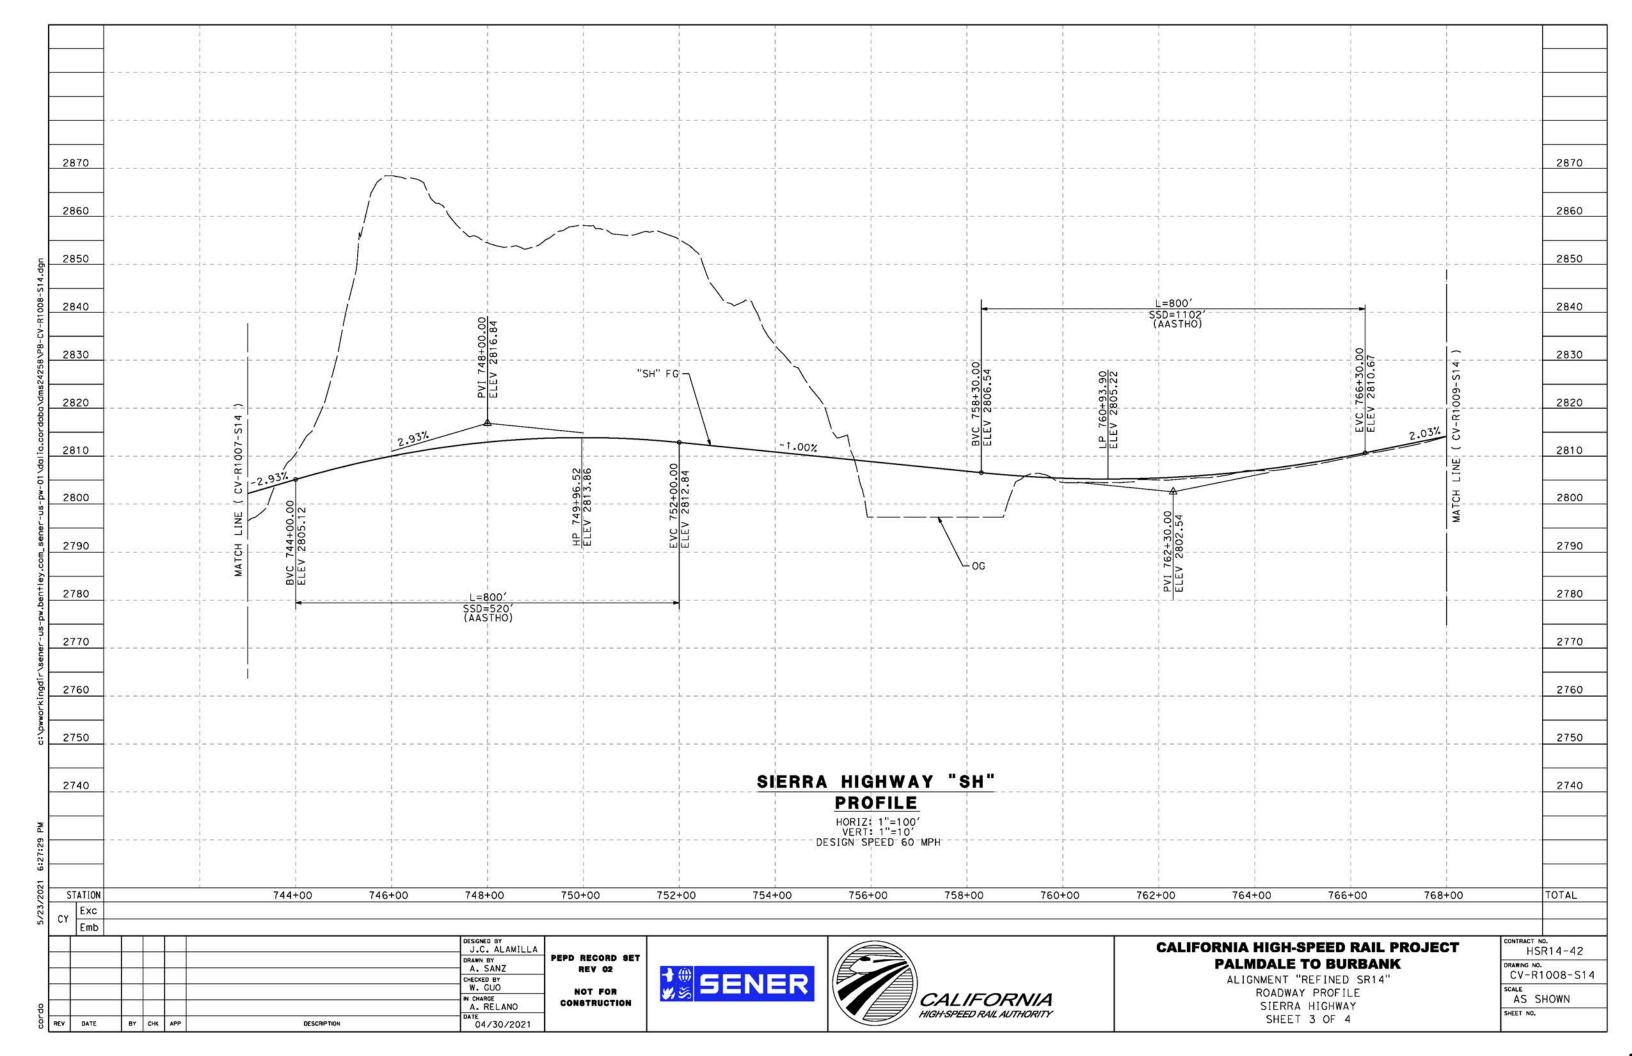


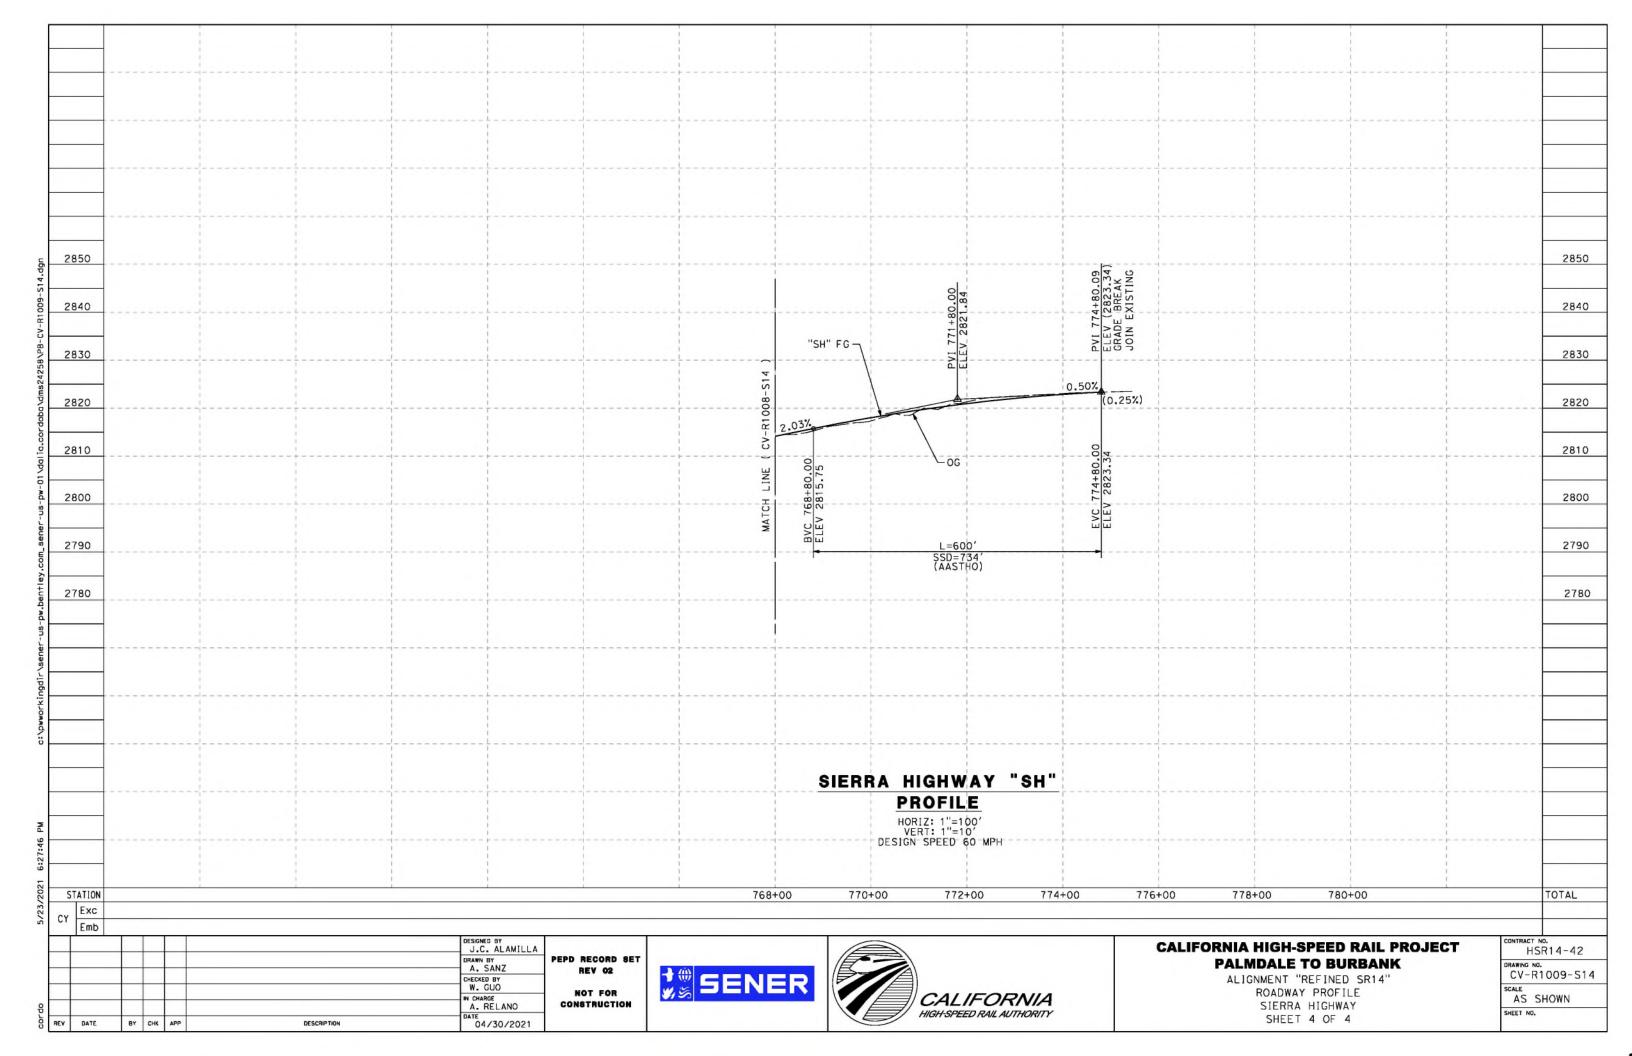


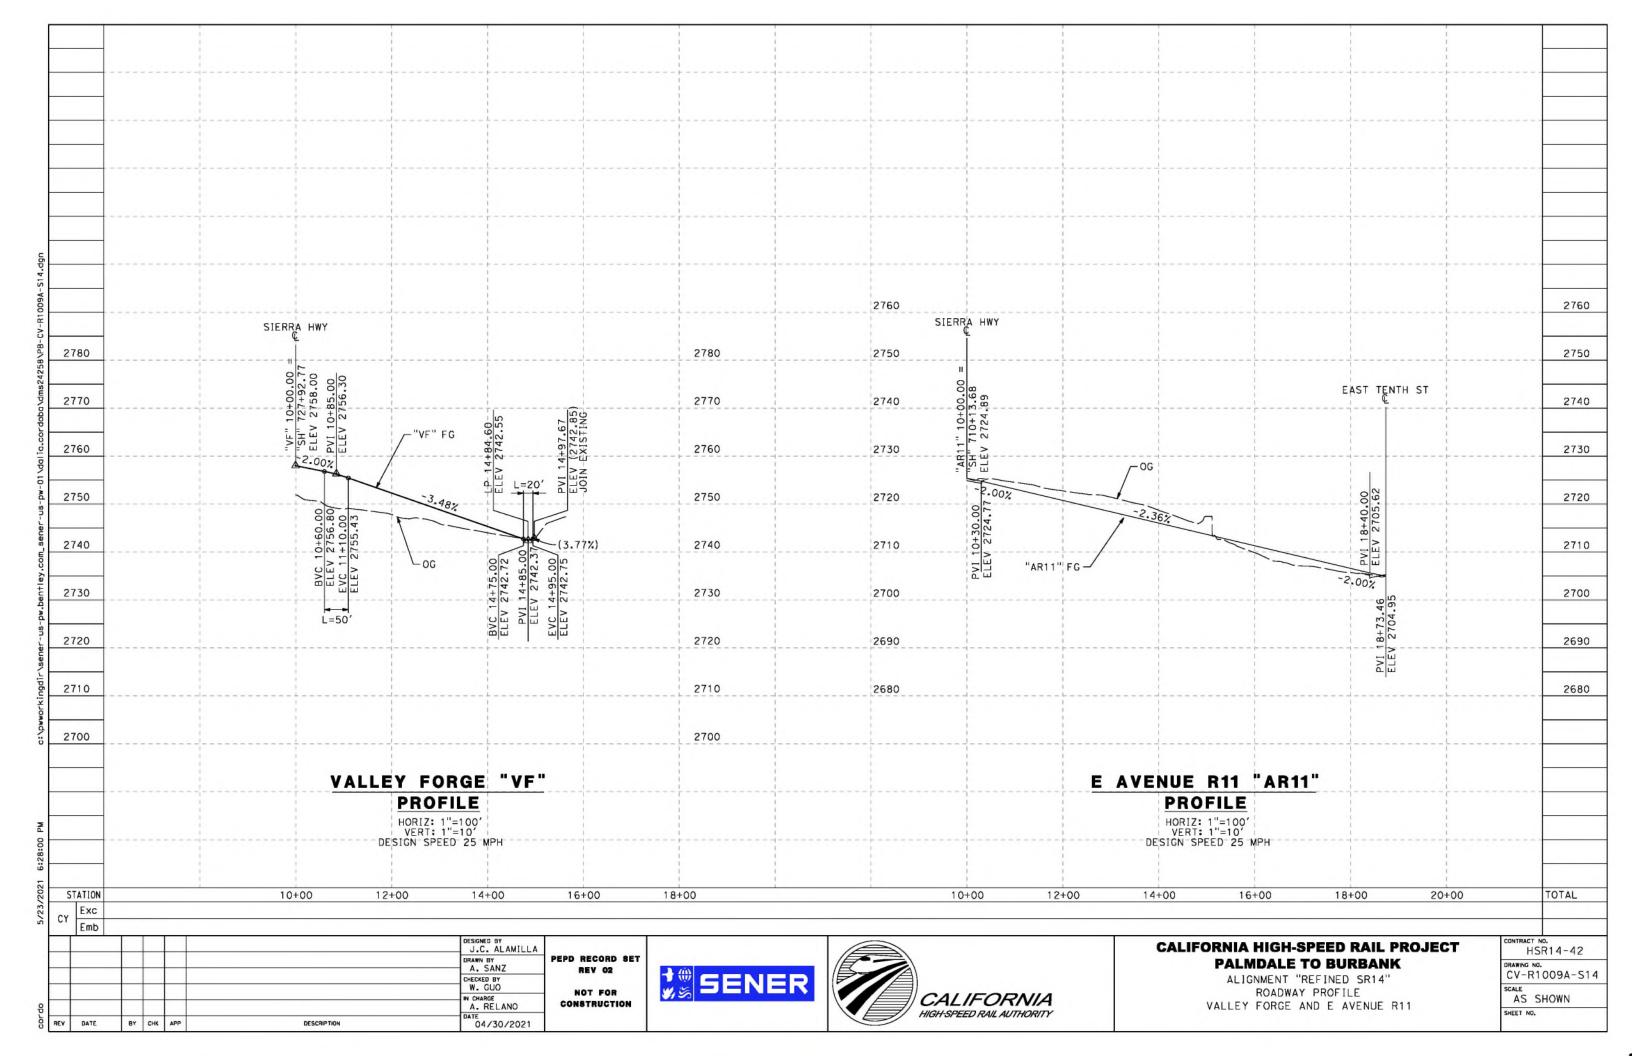


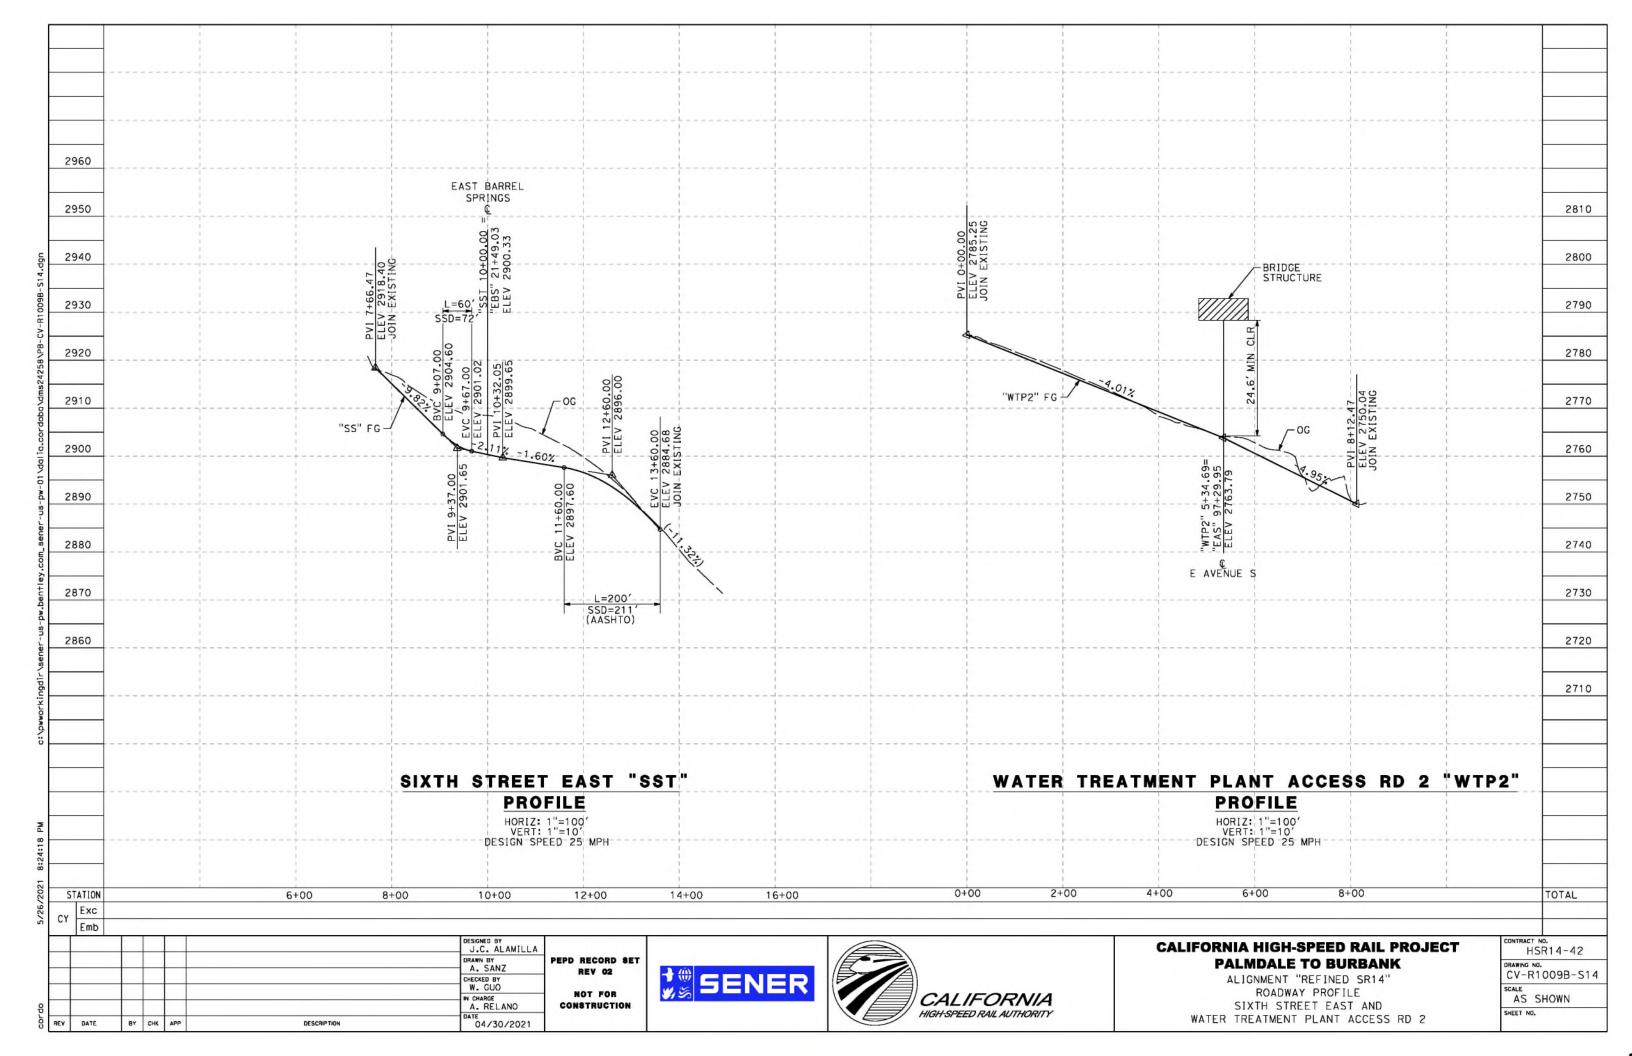


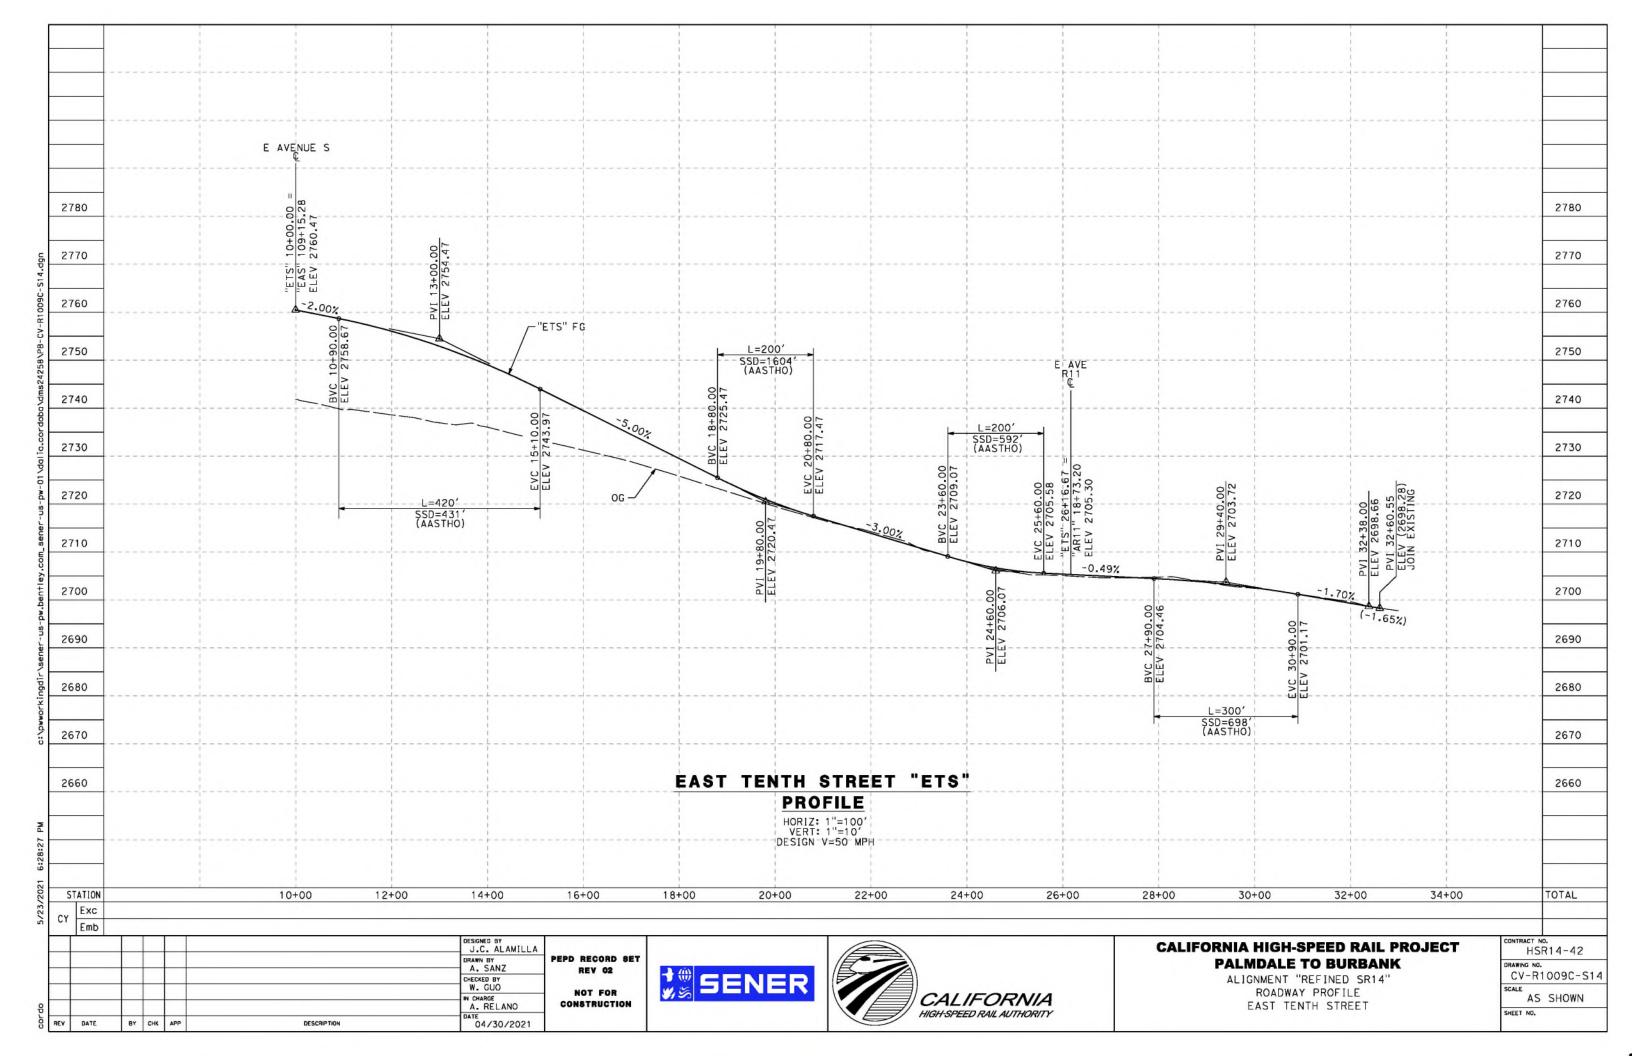


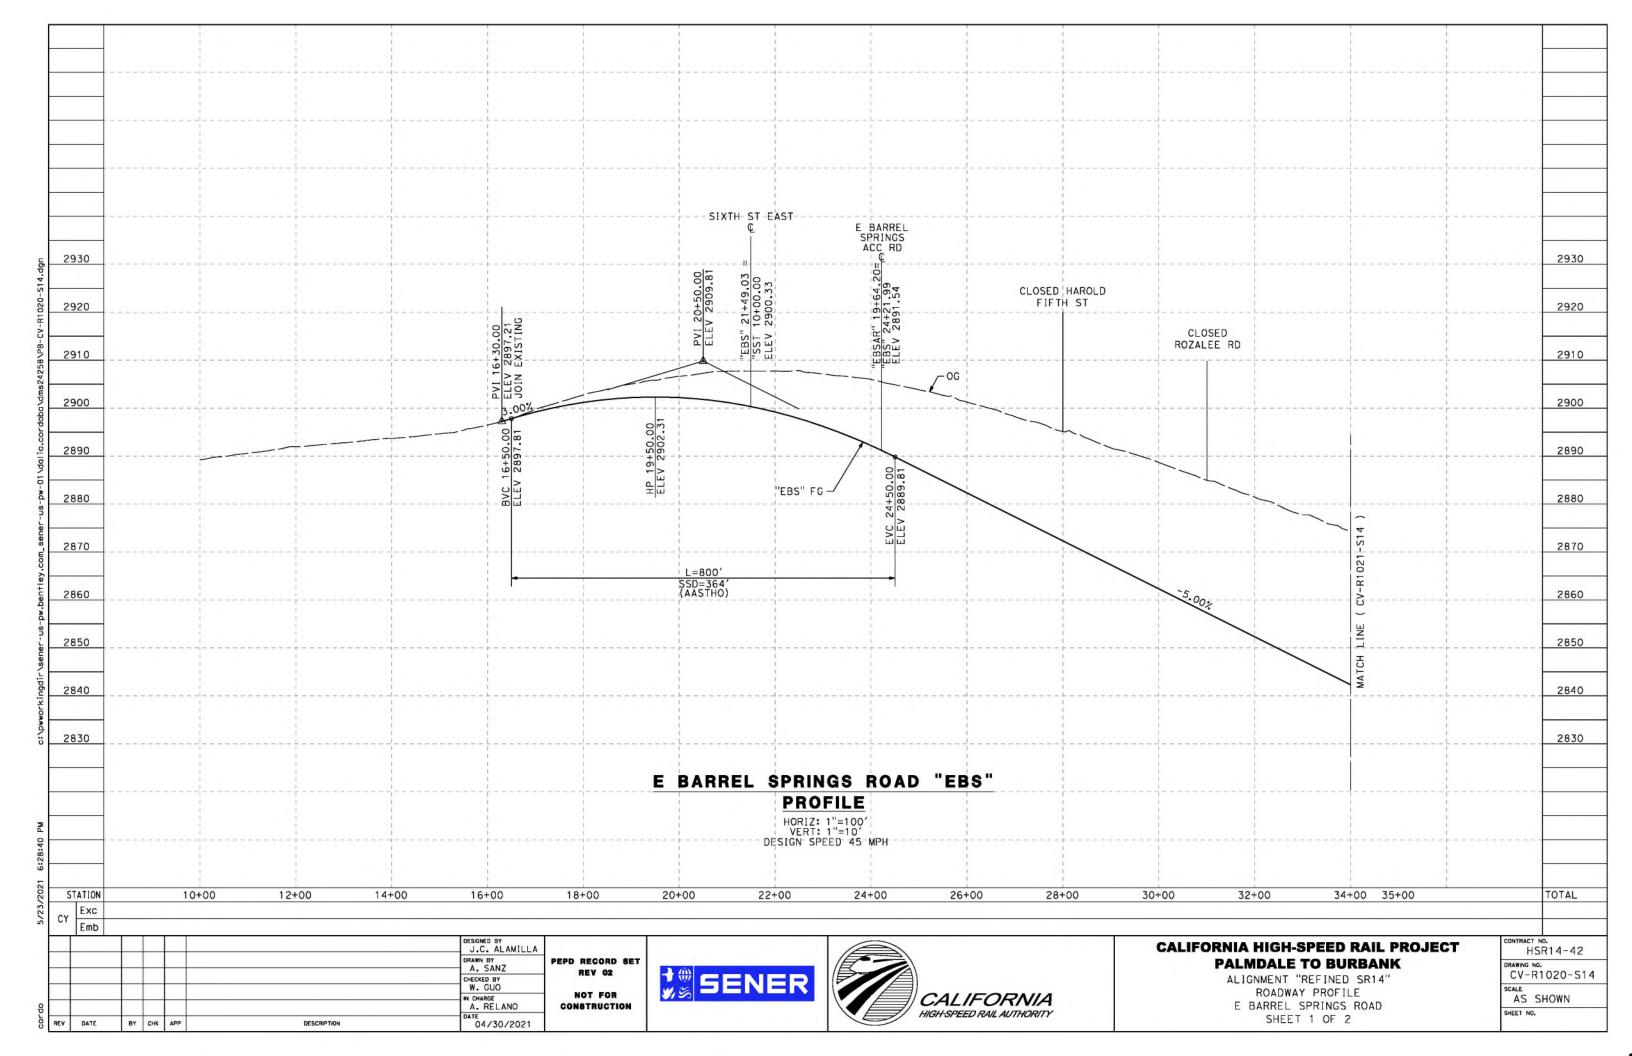


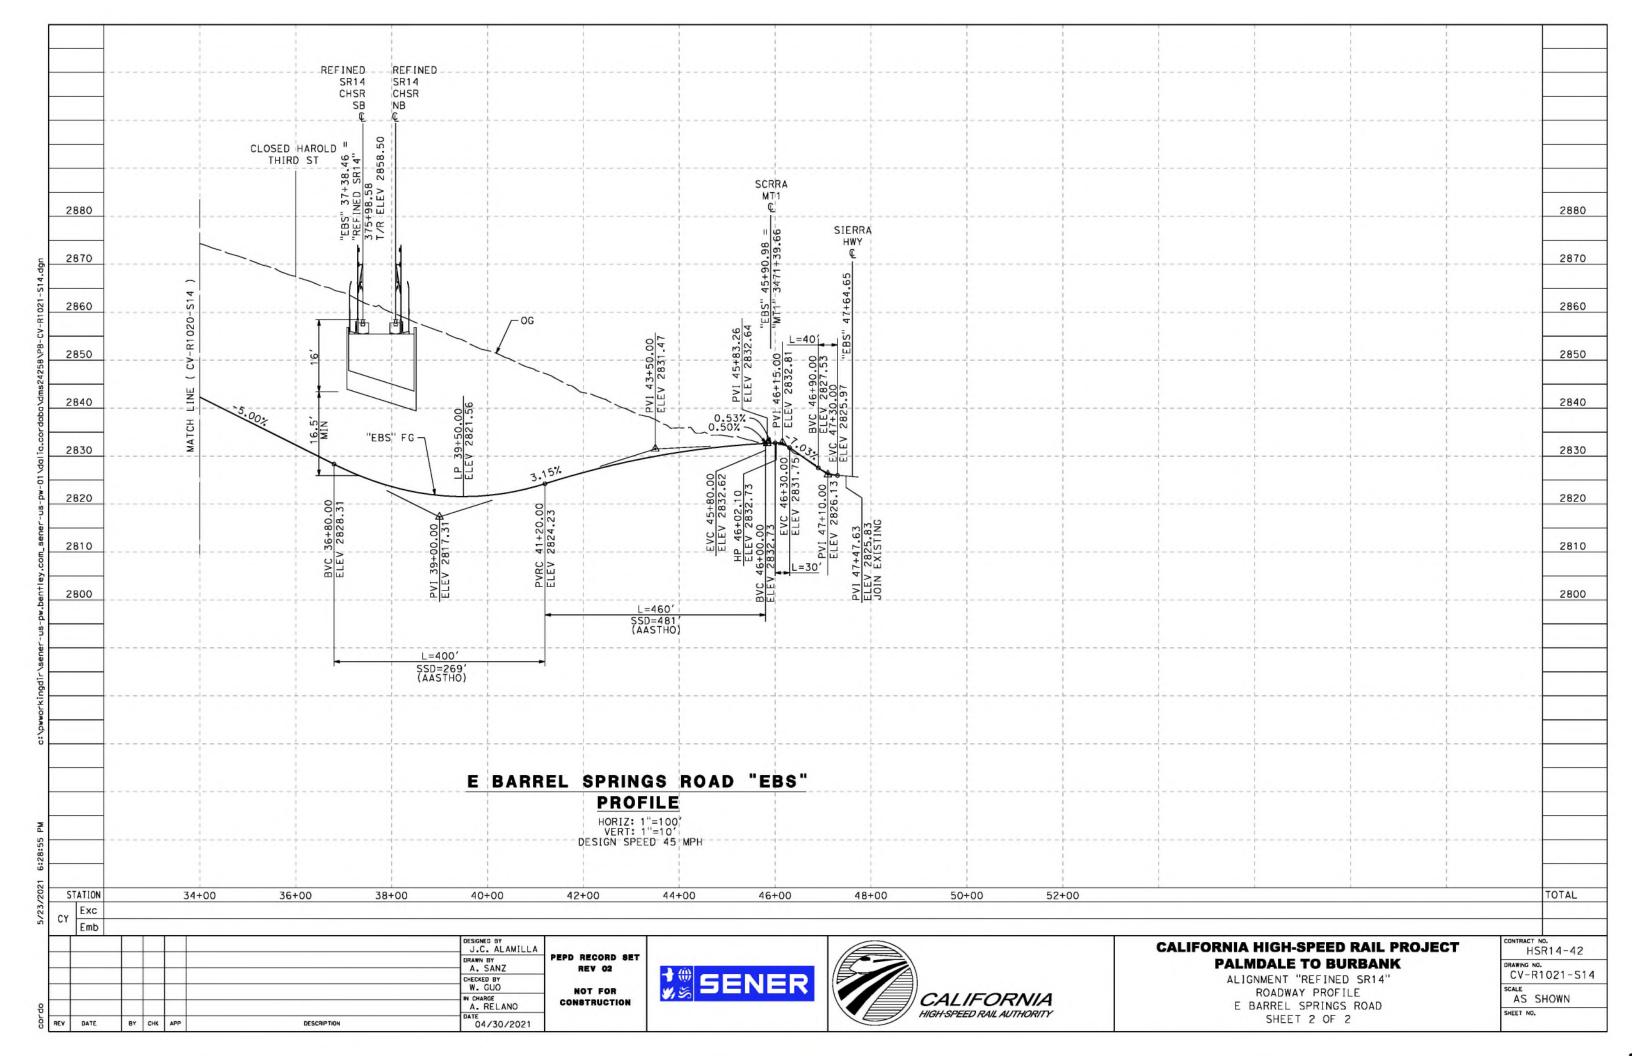


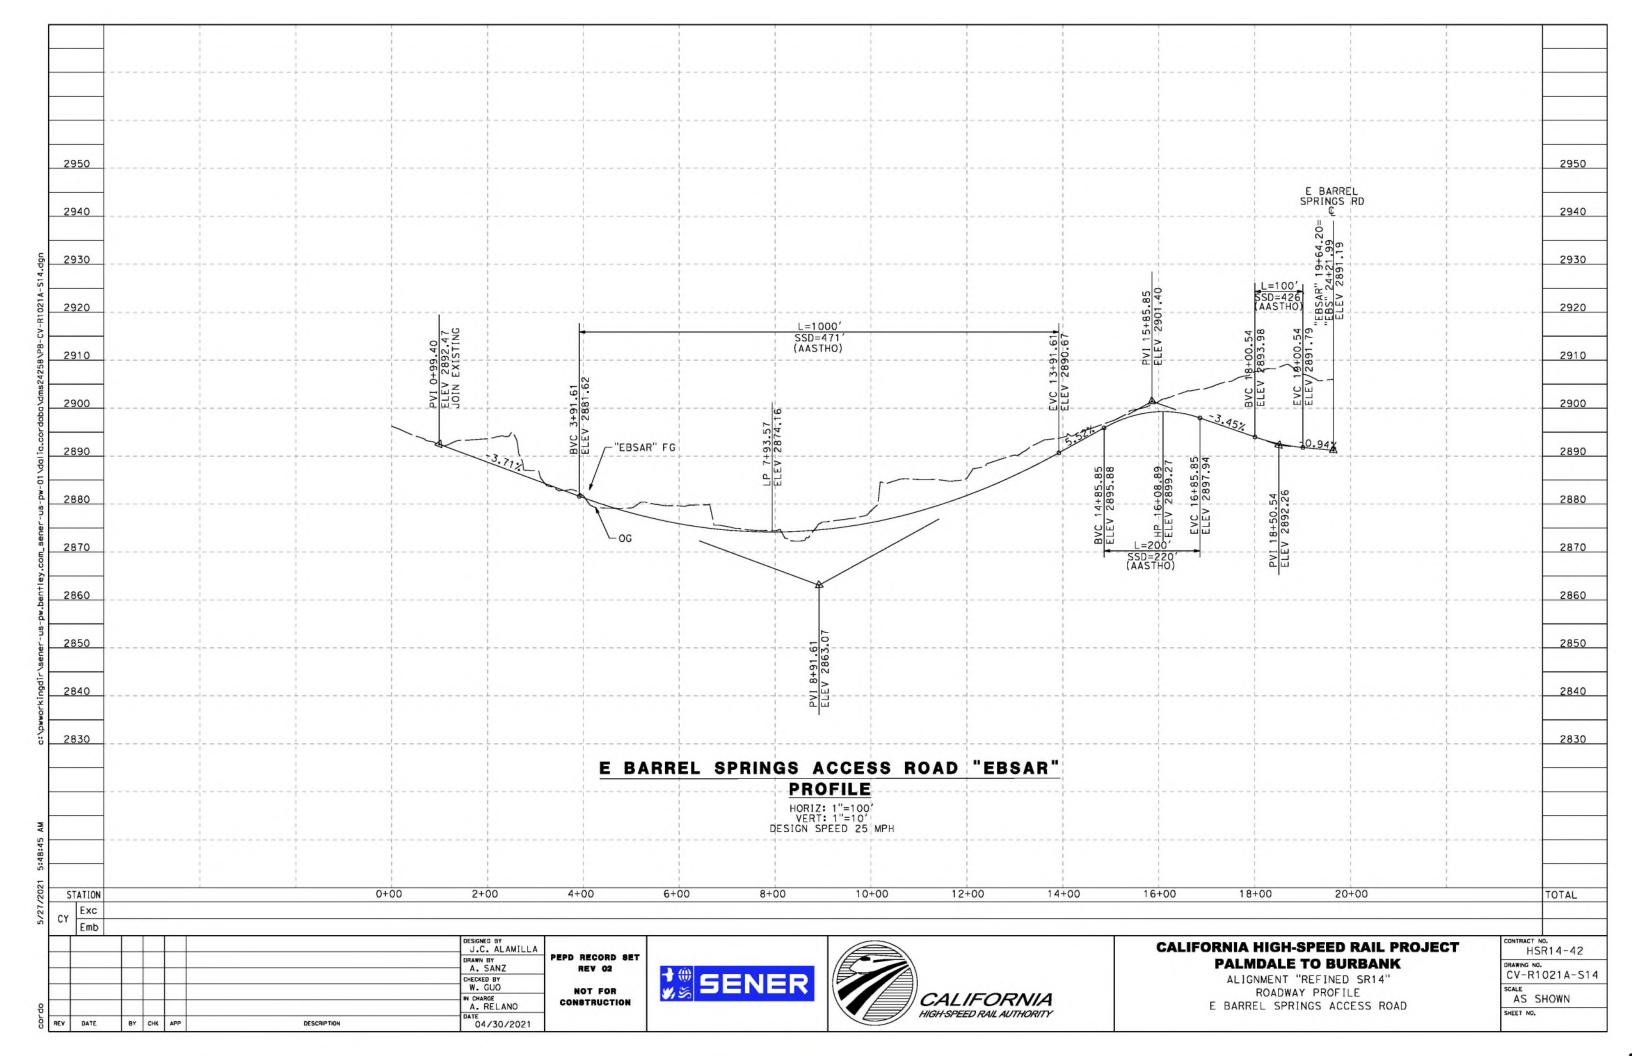


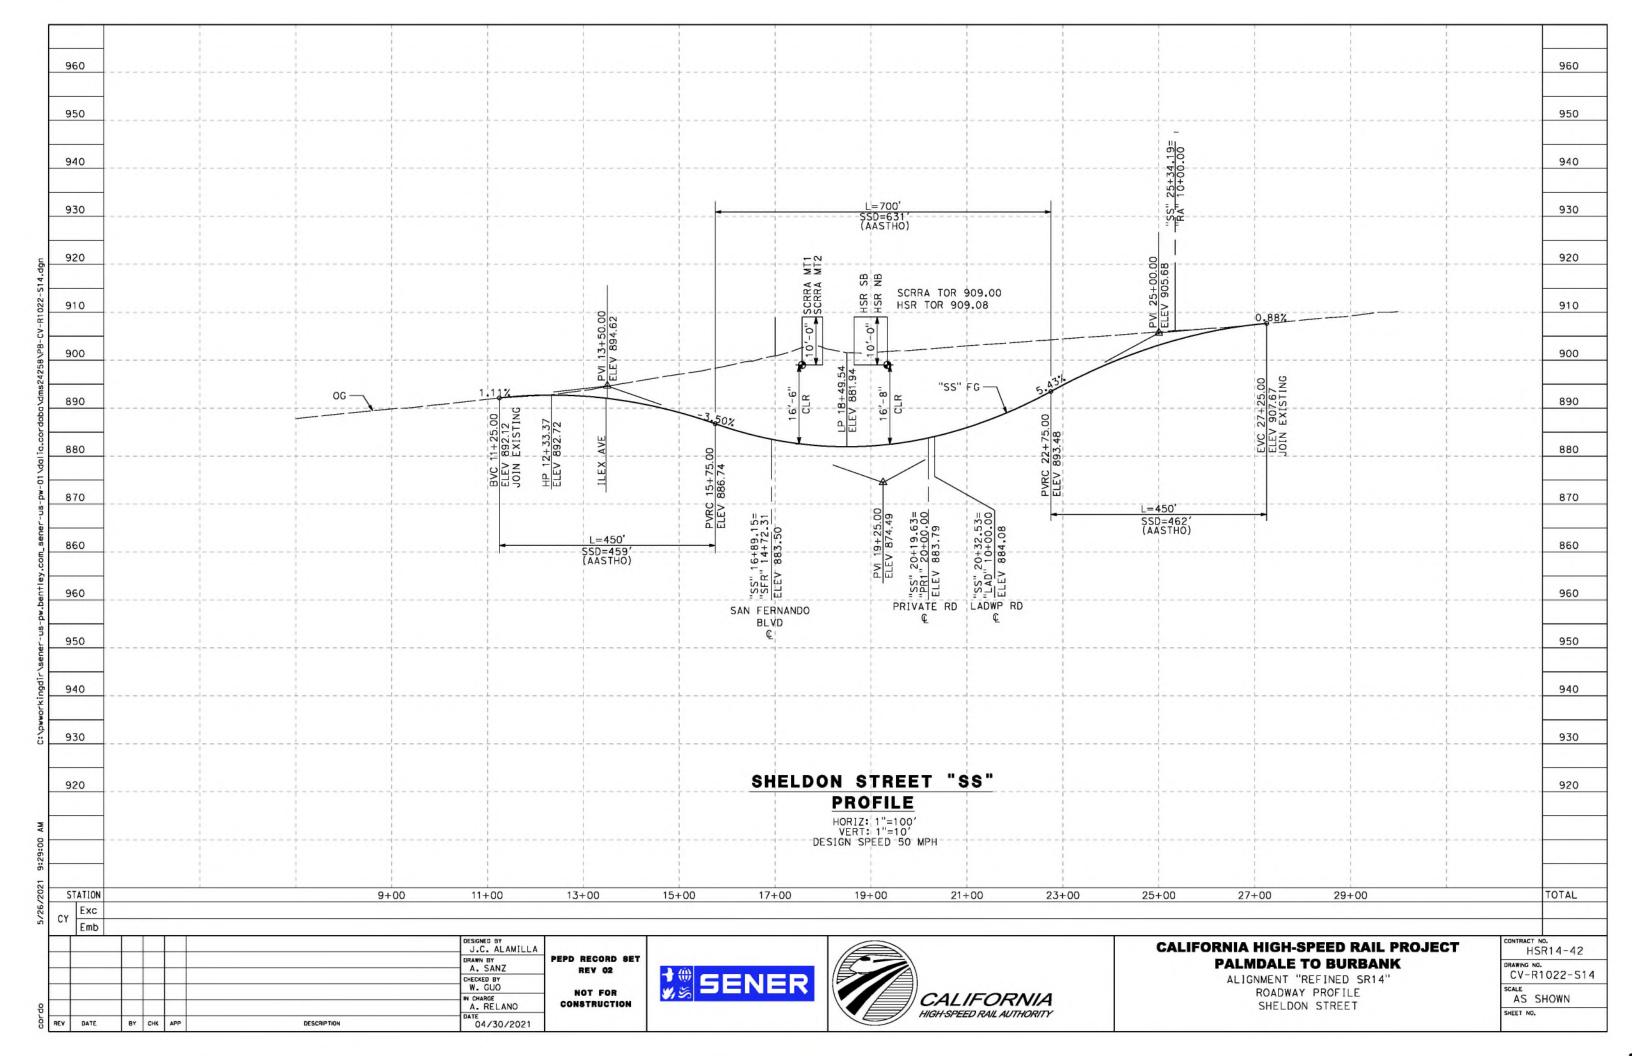


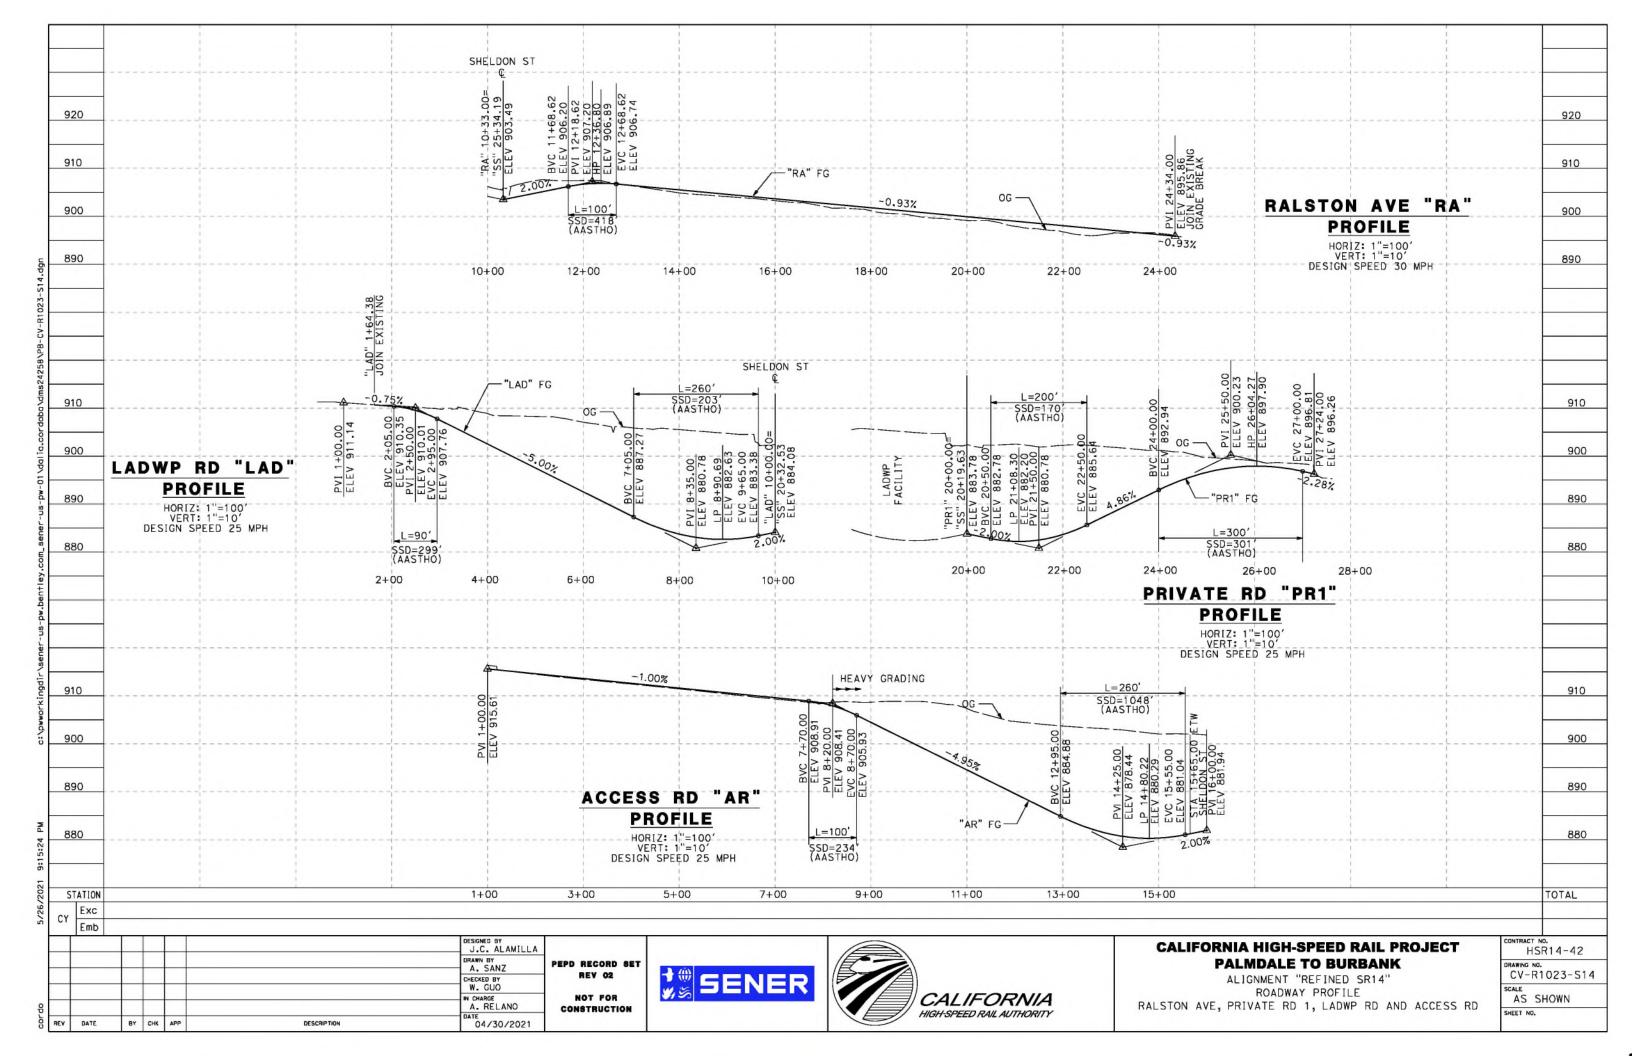


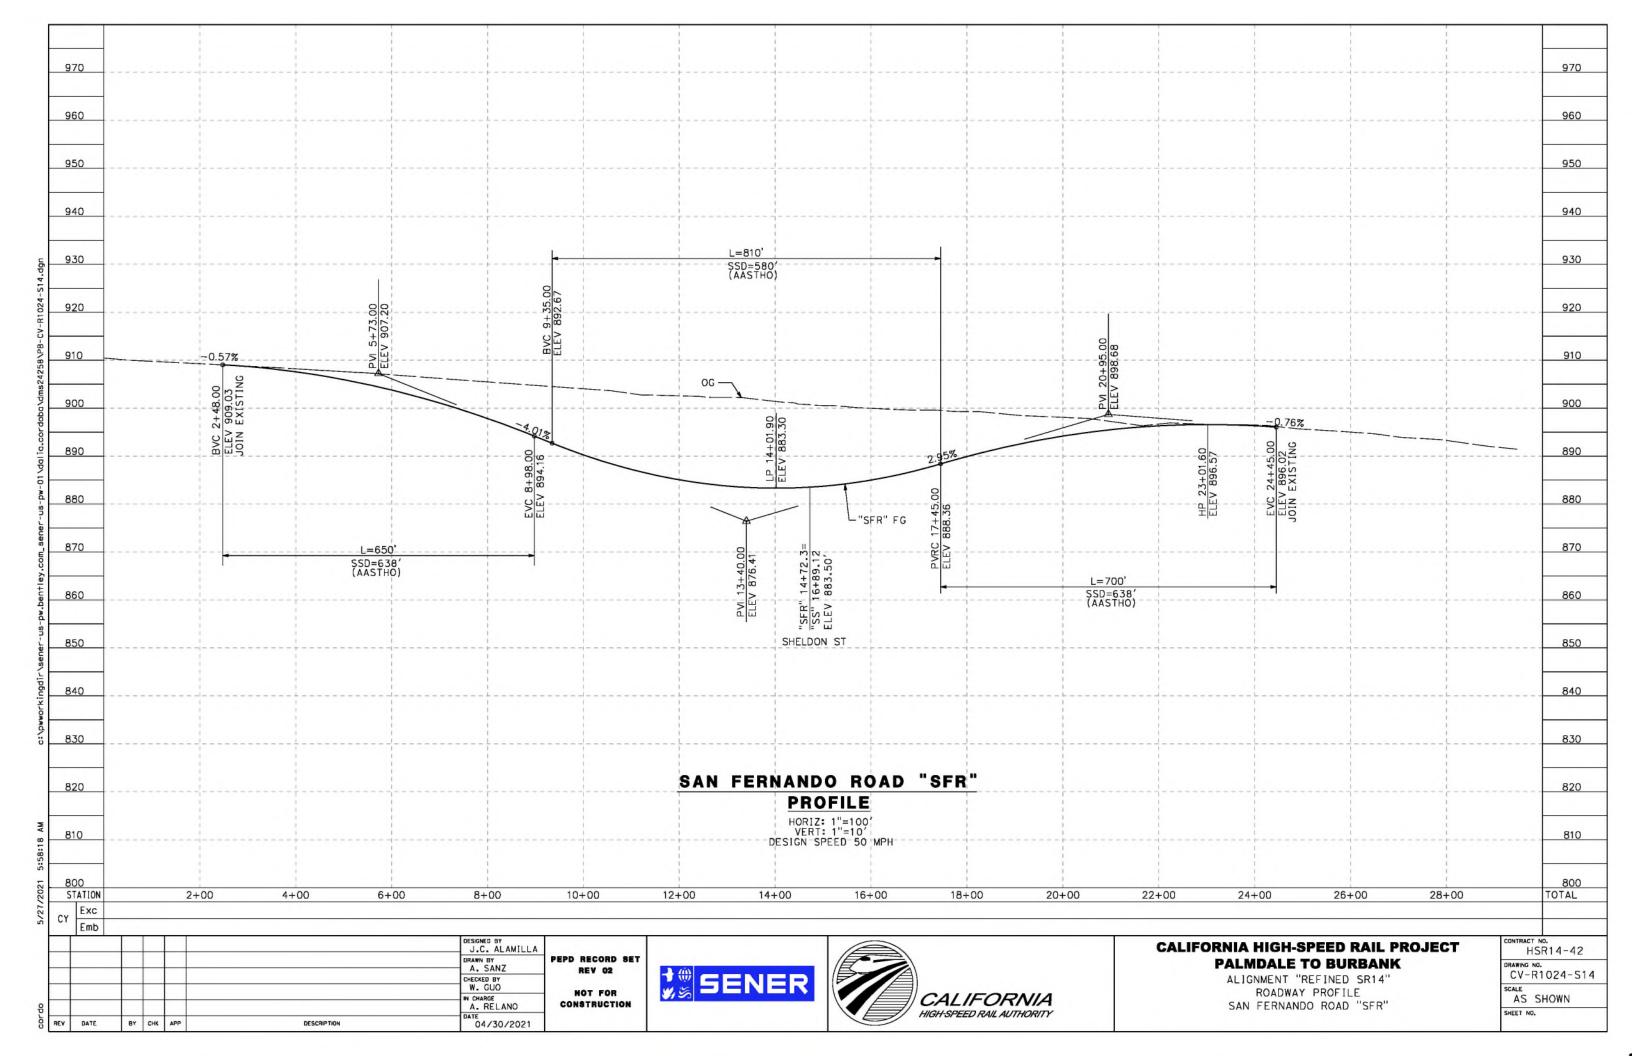

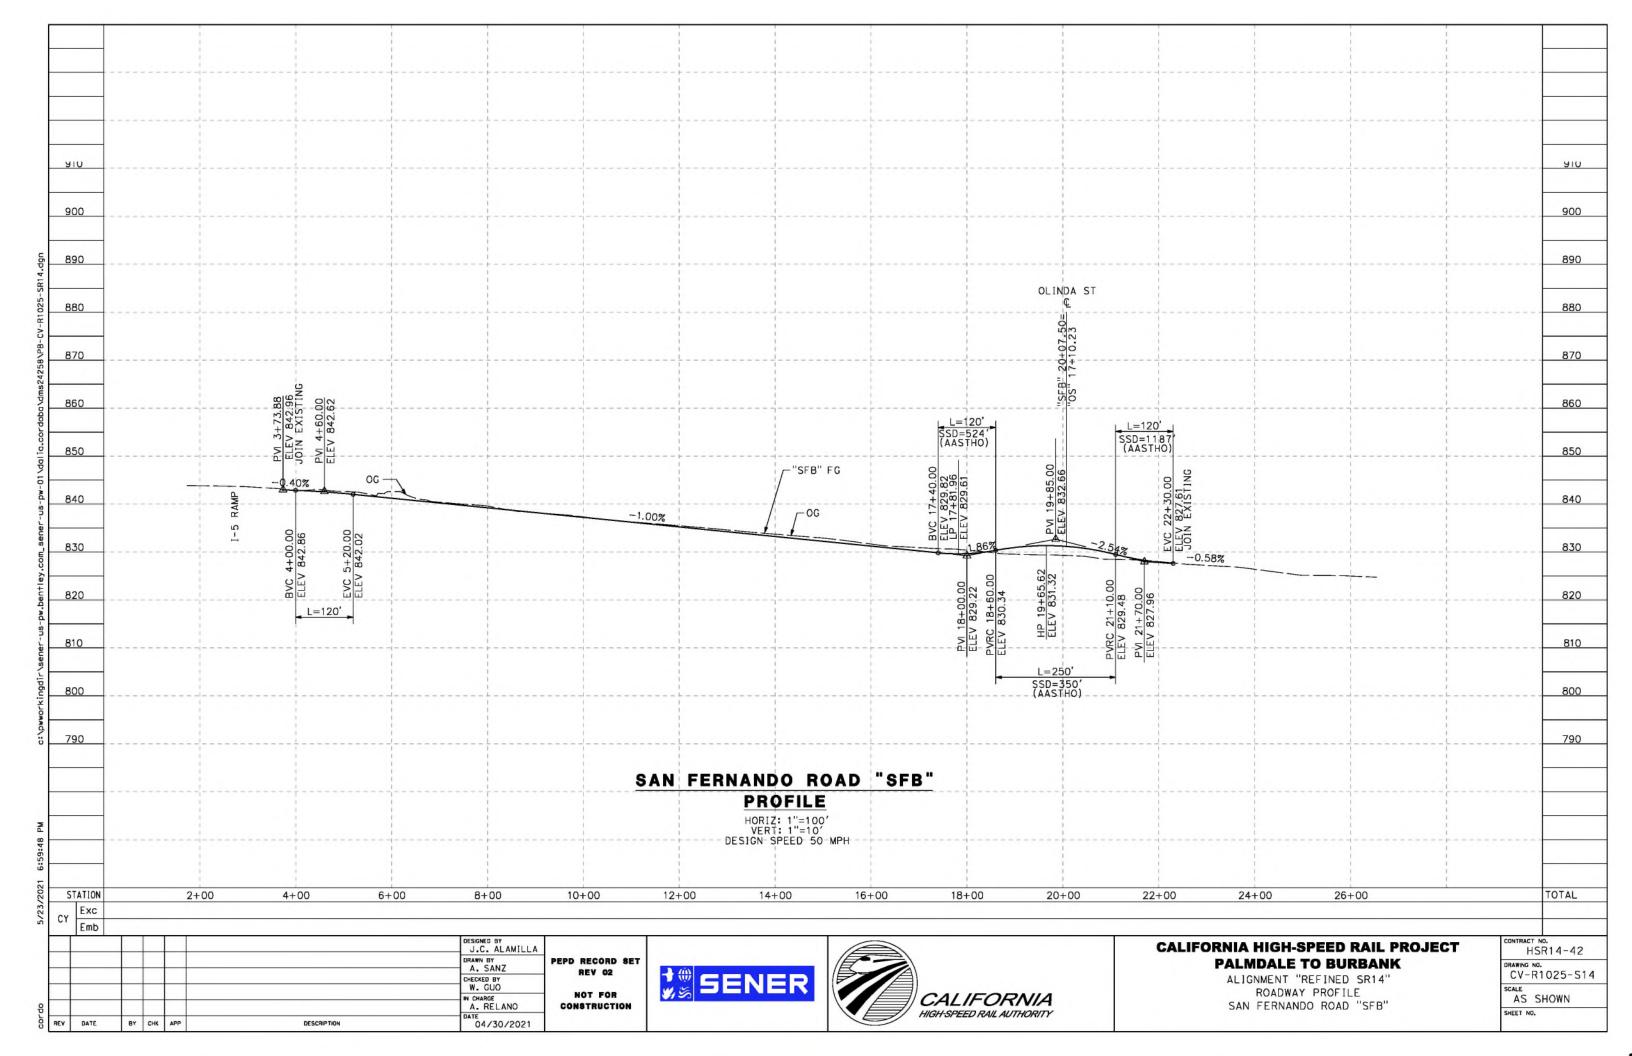

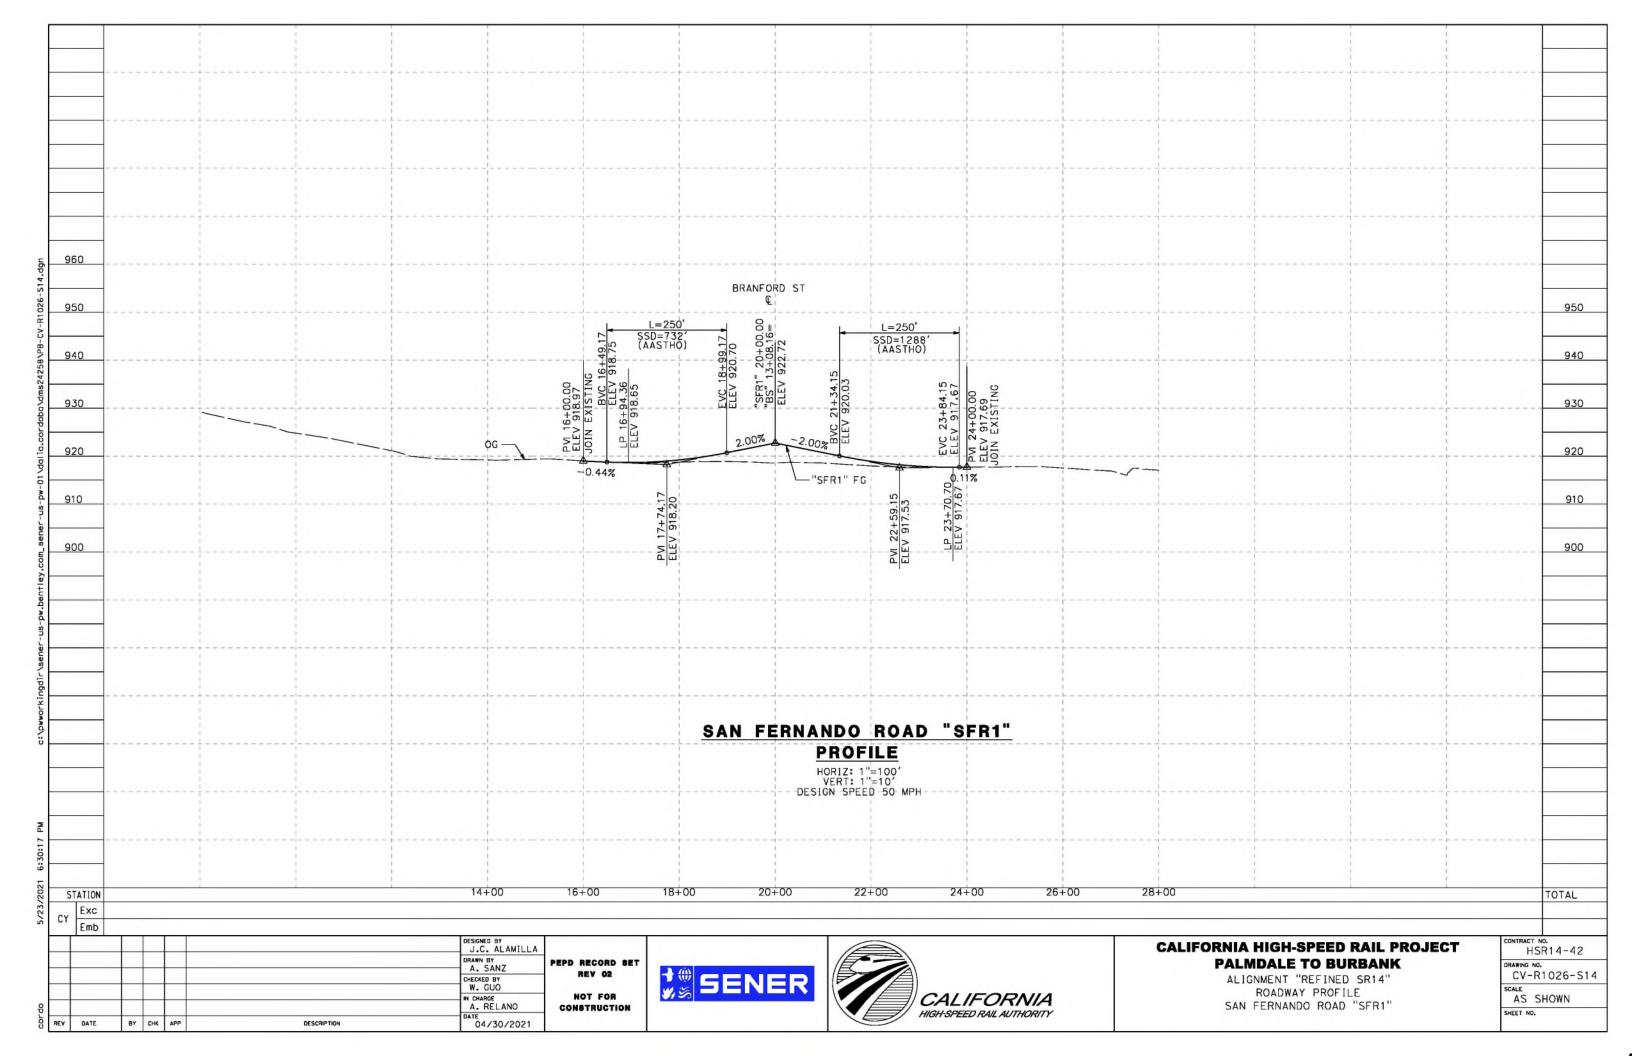


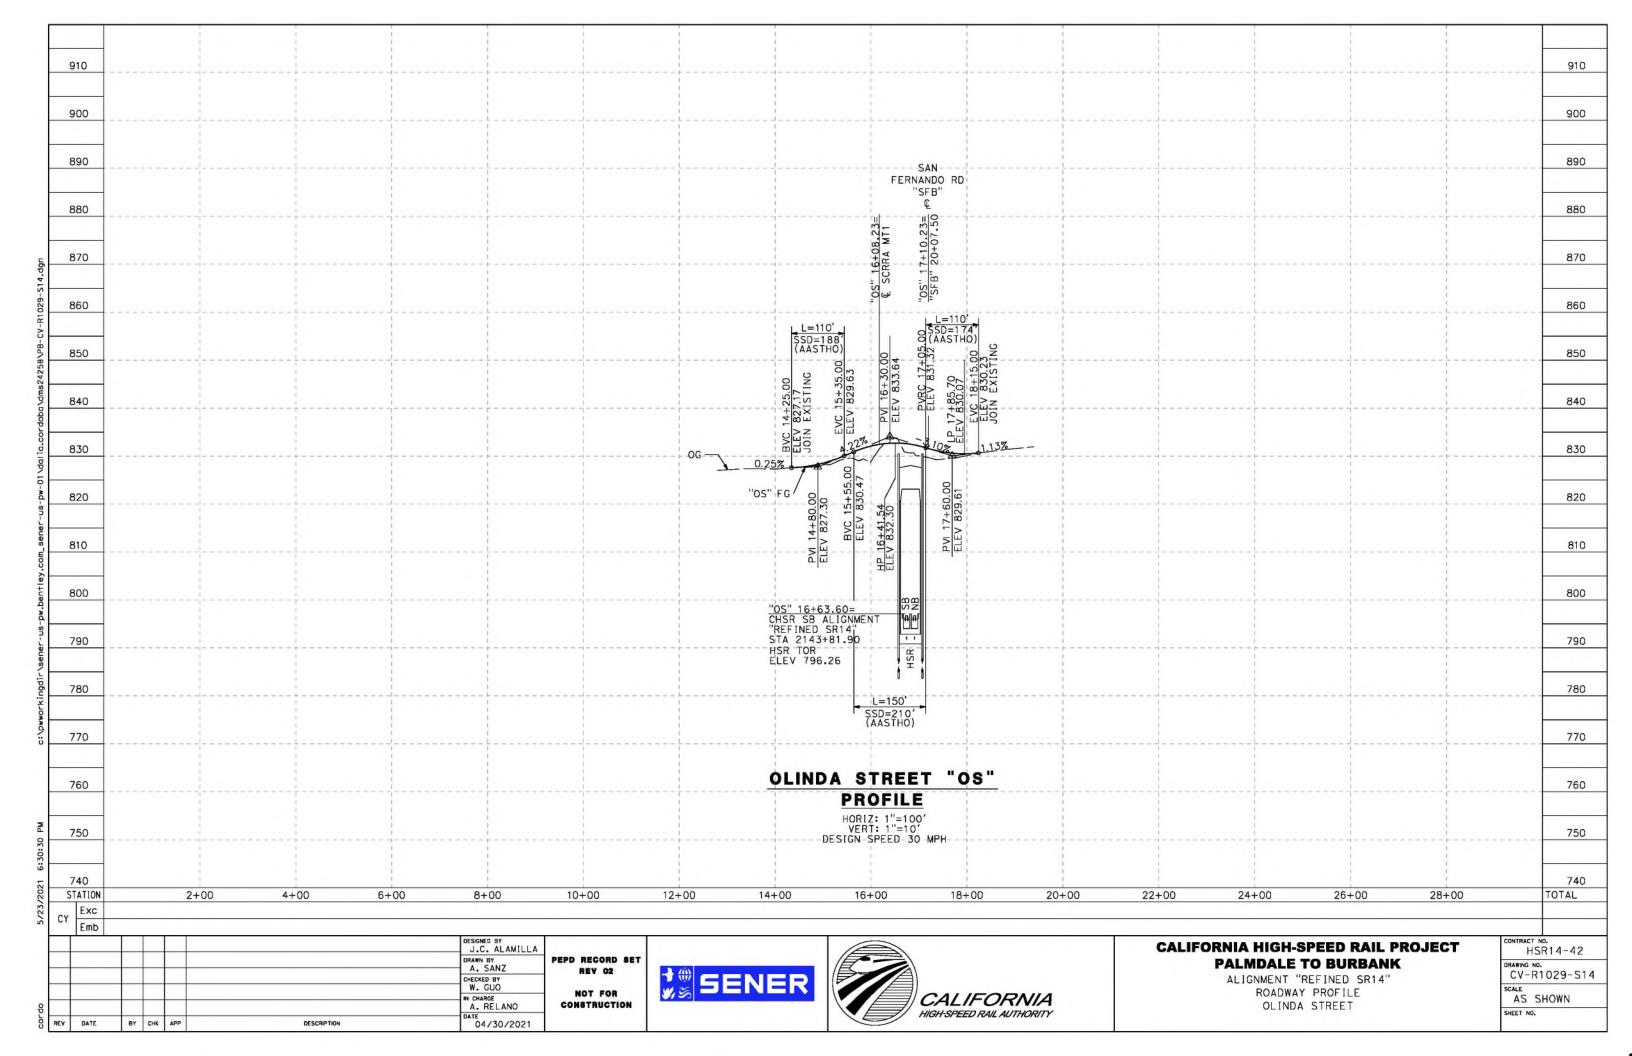

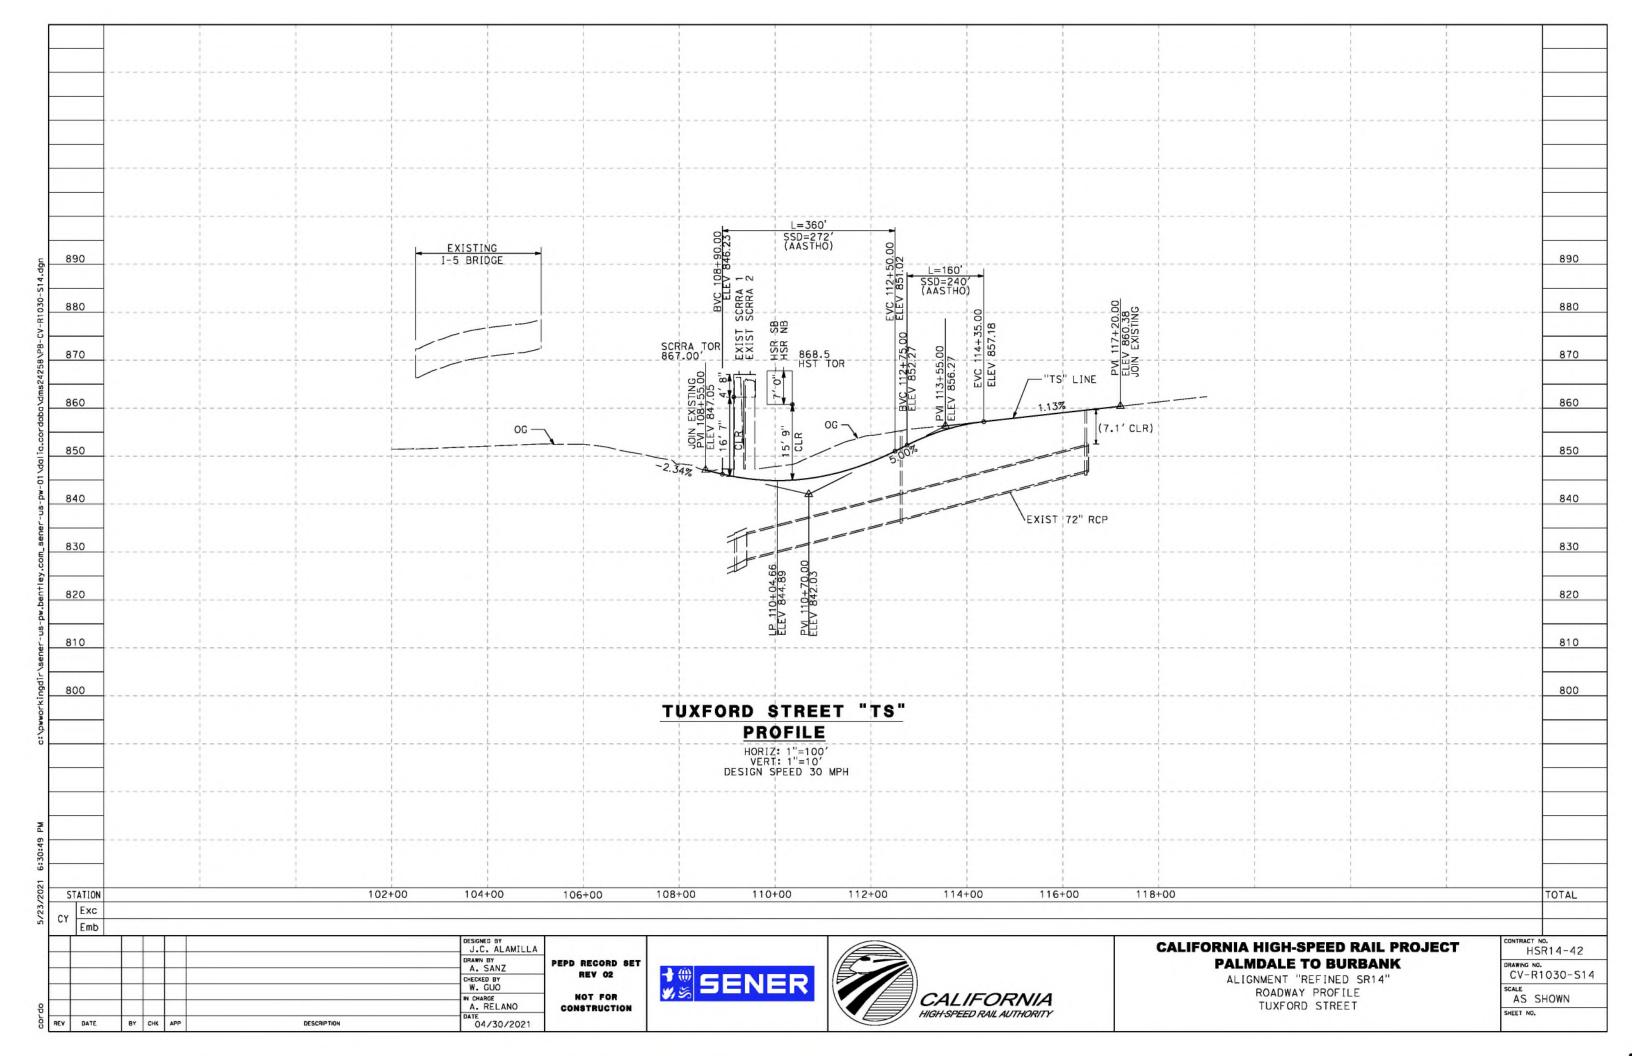

OG -



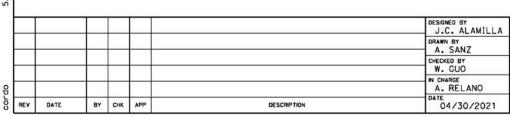

VAR 85' TO 107'

WB LANE

PEPD RECORD SET
REV 02

NOT FOR
CONSTRUCTION




R/W

- OG

VAR 92' TO 126'


EB LANE



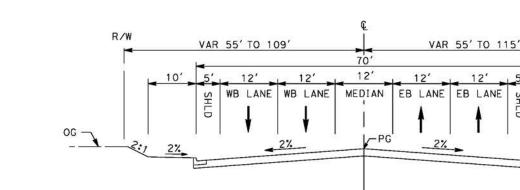

E BARREL SPRINGS ROAD

STA 39+48 TO STA 47+23
SECONDARY HIGHWAY
PER LOS ANGELES COUNTY MASTER PLAN OF HIGHWAYS

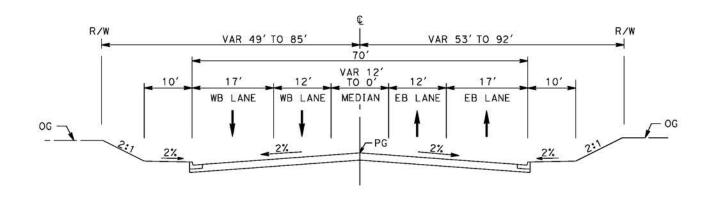


WB LANE EB LANE

E BARREL SPRINGS ROAD

STA 25+75 TO STA 34+00 SECONDARY HIGHWAY PER LOS ANGELES COUNTY MASTER PLAN OF HIGHWAYS

E BARREL SPRINGS ROAD

STA 16+30 TO STA 25+75
SECONDARY HIGHWAY
PER LOS ANGELES COUNTY MASTER PLAN OF HIGHWAYS

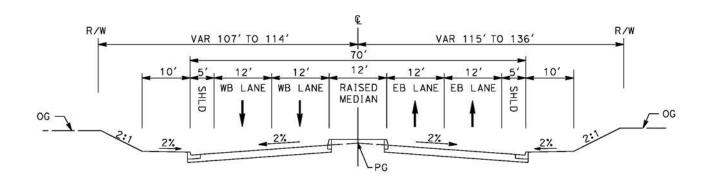

E BARREL SPRINGS ROAD

STA 34+00 TO STA 39+48
SECONDARY HIGHWAY
PER LOS ANGELES COUNTY MASTER PLAN OF HIGHWAYS

CALIFORNIA HIGH-SPEED RAIL PROJECT PALMDALE TO BURBANK

ALIGNMENT "REFINED SR14" TYPICAL SECTIONS E BARREL SPRINGS ROAD

Н	SR14-42
DRAWING CV-	_{NO} . R3001-S14
SCALE NO	SCALE
CHECK NO	,

R/W

PEPD RECORD SET REV 02 NOT FOR

CONSTRUCTION





CALIFORNIA HIGH-SPEED RAIL PROJECT PALMDALE TO BURBANK

ALIGNMENT "REFINED SR14" TYPICAL SECTIONS SIXTH STREET EAST

CONTRACT NO. HSR14-42
DRAWING NO. CV-R3002-S14
NO SCALE

SHEET NO.

VAR VAR 34.5-36' VAR 27.8'-29' VAR R/W

VAR 10' 18' 18' 10'


SB LANE NB LANE

OG

2': 2'' 2'' 2'' 2'' 2'' 2'' 2''


SIXTH STREET EAST

STA 10+00 TO STA 13+60
INTERIOR LOCAL STREET
PER LOS ANGELES COUNTY CODE OF ORDINANCES
CHAPTER 21 PARTS 2 AND 3

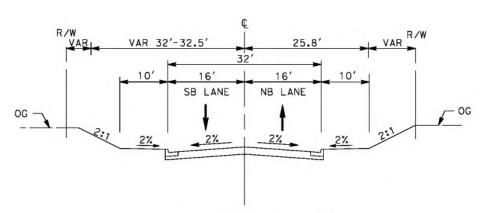


SIXTH STREET EAST

STA 7+50 TO STA 9+65
CUL-DE-SAC STREET
PER LOS ANGELES COUNTY CODE OF ORDINANCES
CHAPTER 21 PARTS 2 AND 3

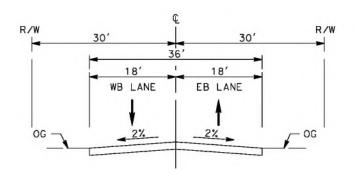


HAROLD THIRD STREET

PER LOS ANGELES COUNTY CODE OF ORDINANCES CHAPTER 21 PARTS 2 AND 3

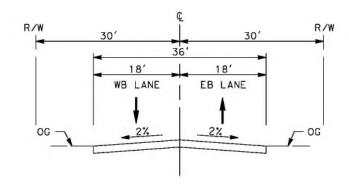


HAROLD DATE AVE

INTERIOR LOCAL STREET
PER LOS ANGELES COUNTY CODE OF ORDINANCES
CHAPTER 21 PARTS 2 AND 3

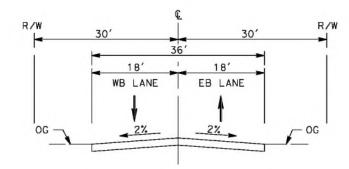

HAROLD FIFTH STREET

INTERIOR LOCAL STREET
PER LOS ANGELES COUNTY CODE OF ORDINANCES
CHAPTER 21 PARTS 2 AND 3

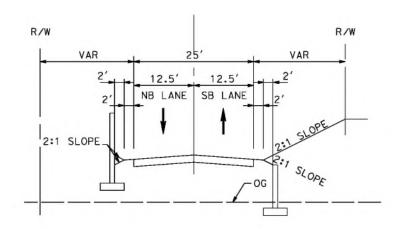

E BARREL SPRINGS ACCESS ROAD

STA 0+00 TO STA 20+00
INTERIOR LOCAL STREET
PER LOS ANGELES COUNTY CODE OF ORDINANCES
CHAPTER 21 PARTS 2 AND 3

\Box						J.C. ALAMILLA	
\dashv		-				DRAWN BY A. SANZ	PI
\dashv						W. GUO	
\dashv						IN CHARGE A. RELANO	
REV	DATE	BY	СНК	APP	DESCRIPTION	DATE 04/30/2021	

PEPD RECORD SET REV 02

NOT FOR CONSTRUCTION





CALIFORNIA HIGH-SPEED RAIL PROJECT PALMDALE TO BURBANK

ALIGNMENT "REFINED SR14"


TYPICAL SECTIONS

HAROLD THIRD STREET, HAROLD DATE AVE,

HAROLD FIFTH STREET AND E BARREL SPRINGS ACCESS RD


CONTRACT NO. HSR14-42	
CV-R3003-S14	
NO SCALE	



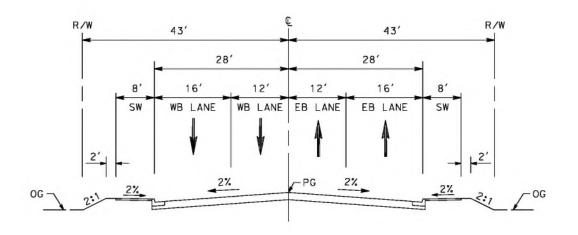


BRANFORD STREET

STA 14+51 TO STA 25+80 AVENUE II (SECONDARY HIGHWAY) PER CITY OF LOS ANGELES GENERAL PLAN 2035

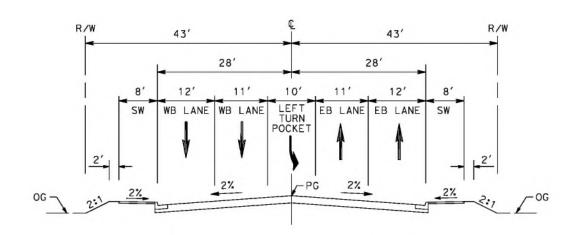


BRANFORD STREET

STA 13+34 TO STA 15+00 AVENUE II (SECONDARY HIGHWAY)
PER CITY OF LOS ANGELES GENERAL PLAN 2035

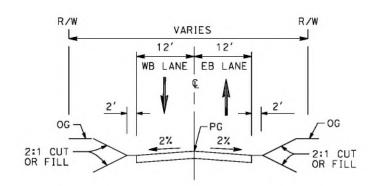

ACCESS ROAD

STA 1+00 TO STA 16+00 LOCAL STREET PER CITY OF LOS ANGELES GENERAL PLAN 2035

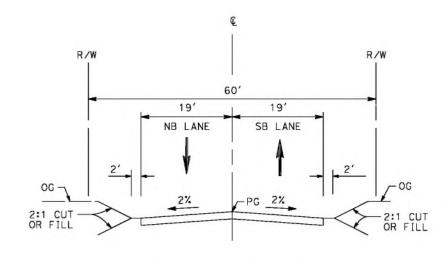

RALSTON AVENUE

STA 10+31 TO STA 24+34 LOCAL STREET PER CITY OF LOS ANGELES GENERAL PLAN 2035

						J.C. ALAMILLA	
		-				A. SANZ	PEPD RECORD SET
		+	-			W. GUO	REV 02
						IN CHARGE A. RELANO	NOT FOR CONSTRUCTION
REV	DATE	ВЧ	СНК	APP	DESCRIPTION	04/30/2021	CONSTRUCTION






CALIFORNIA HIGH-SPEED RAIL PROJECT PALMDALE TO BURBANK


ALIGNMENT "REFINED SR14" TYPICAL SECTIONS BRANFORD ST, RALSTON AVE AND ACCESS RD

CONTRACT NO. HSR14-42
CV-R3004-S14
NO SCALE

SHEET NO.

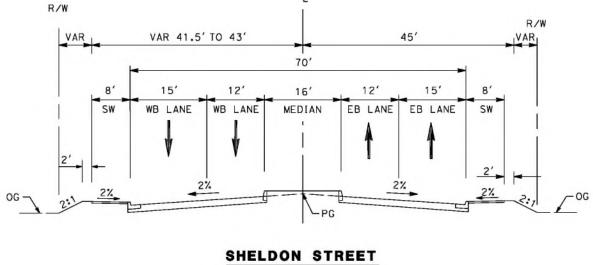


STA 10+25 TO STA 12+70 AVENUE II (SECONDARY HIGHWAY) PER CITY OF LOS ANGELES GENERAL PLAN 2035

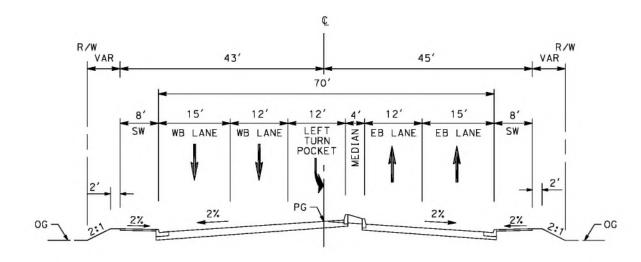


SHELDON STREET

STA 8+88 TO STA 10+25 AVENUE II (SECONDARY HIGHWAY) PER CITY OF LOS ANGELES GENERAL PLAN 2035

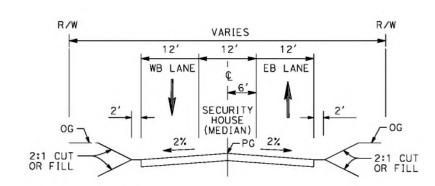

LADWP ROAD STA 1+00 TO STA 10+00

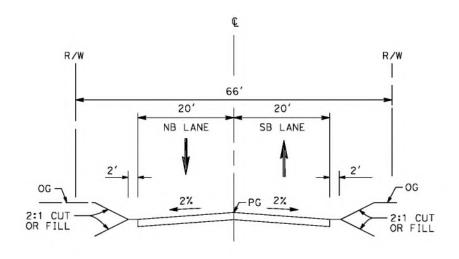

PRIVATE ROAD 1 STA 12+64 TO STA 27+24

						J.C. ALAMILLA	
		\perp				A. SANZ	PEPD RECORD SET
-		-				W. GUO	REV 02
						IN CHARGE A. RELANO	NOT FOR CONSTRUCTION
REV	DATE	BY	СНК	APP	DESCRIPTION	04/30/2021	CONSTRUCTION





CALIFORNIA HIGH-SPEED RAIL PROJECT PALMDALE TO BURBANK

ALIGNMENT "REFINED SR14" TYPICAL SECTIONS SHELDON ST, PRIVATE RD 1 AND LADWP RD

CONTRACT NO. HSR14-42	
CV-R3005-S14	
NO SCALE	



PEPD RECORD SET
REV 02

NOT FOR
CONSTRUCTION


SENER



CALIFORNIA HIGH-SPEED RAIL PROJECT PALMDALE TO BURBANK


ALIGNMENT "REFINED SR14"
TYPICAL SECTIONS
SIERRA HIGHWAY
SHEET 1 OF 2

CONTRAC	T NO.
Н	ISR14-42
DRAWING	NO.
CV-	R3006-S14
SCALE	2123003.0
	SCALE

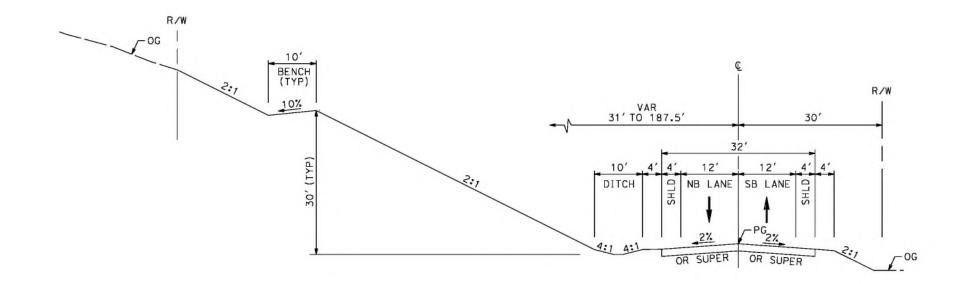

SIERRA HIGHWAY

STA 728+48 TO 774+80 MAJOR ARTERIAL (B1) PER CITY OF PALMDALE GENERAL PLAN

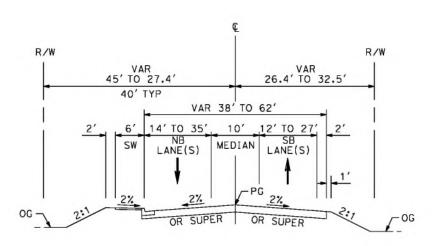

SIERRA HIGHWAY

STA 706+68 TO STA 728+48 MAJOR ARTERIAL (B1) PER CITY OF PALMDALE GENERAL PLAN

PEPD RECORD SET
REV 02

NOT FOR
CONSTRUCTION








ALIGNMENT "REFINED SR14" TYPICAL SECTIONS SIERRA HIGHWAY SHEET 2 OF 2

Н	SR14-42
CV-	[№] . R3007-S14
SCALE	SCALE.


CONTRACT NO.

SHEET NO.

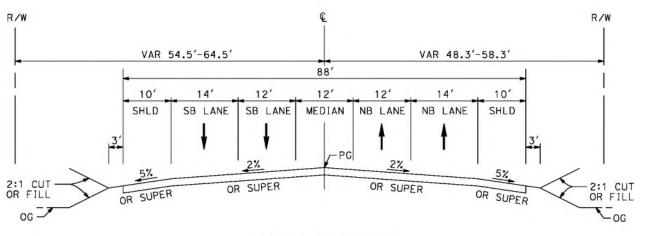


SIERRA HIGHWAY

STA 6+78.00 TO STA 34+50.00 MAJOR HIGHWAY PER LOS ANGELES COUNTY MASTER PLAN OF HIGHWAYS

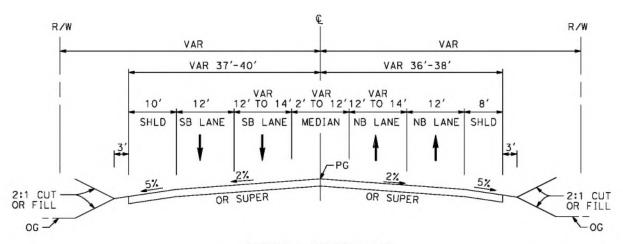


SIERRA HIGHWAY

STA 4+27 TO STA 6+78 MAJOR HIGHWAY PER LOS ANGELES COUNTY MASTER PLAN OF HIGHWAYS

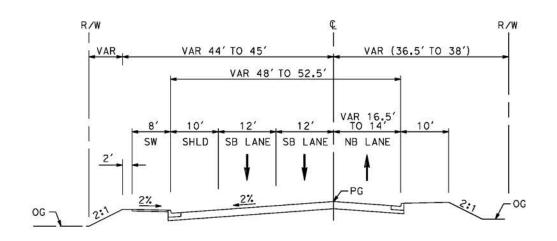


EAST TENTH STREET

STA 22+71 TO STA 32+38 SECONDARY ARTERIAL PER CITY OF PALMDALE GENERAL PLAN

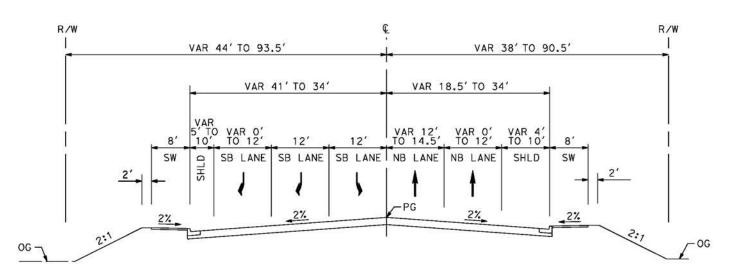

EAST TENTH STREET

STA 10+49 TO STA 22+71 SECONDARY ARTERIAL

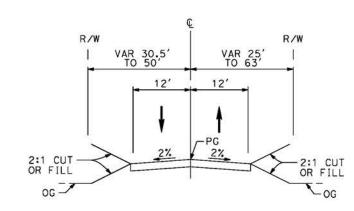

WATER TREATMENT PLANT ROAD ACCESS RD 2

STA 0+00 TO STA 8+00

PER CITY OF PALMDALE GENERAL PLAN

						DESIGNED BY J.C. ALAMILLA	
_		-				DRAWN BY A. SANZ	PE
-				7		CHECKED BY W. GUO	
-		+				IN CHARGE A. RELANO	
REV	DATE	BY	СНК	APP	DESCRIPTION	DATE 04/30/2021	

PEPD RECORD SET REV 02 NOT FOR CONSTRUCTION





CALIFORNIA HIGH-SPEED RAIL PROJECT PALMDALE TO BURBANK

ALIGNMENT "REFINED SR14" TYPICAL SECTIONS EAST TENTH STREET AND WATER TREATMENT PLANT ACCESS RD 2

NO.
-R3008-S14
SCALE

BY CHK APP

DESCRIPTION

PEPD RECORD SET
REV 02

NOT FOR
CONSTRUCTION

J.C. ALAMILLA

A. SANZ

W. GUO

A. RELANO

04/30/2021

SENER





ALIGNMENT "REFINED SR14"
TYPICAL SECTIONS
SAN FERNANDO ROAD
SHEET 1 OF 2

DRAWING	NO.
CV-	R3009-S14
SCALE	SCALE

CONTRACT NO.

VAR 30' TO 50' VAR 21' TO 31'

VAR 8 VAR 18' VAR 18' VAR 2.5'
TO 14' TO 24' TO 7'

SW NB LANE SB LANE

2' PG 2%

PG 2%

SCRRA
R/W

RET WALL WHERE ROAD
HIGHER THAN TRACKS

SCRRA
FG

SCRRA
FG

SAN FERNANDO ROAD AT BRANDFORD

STA 16+00 TO STA 24+00

PEPD RECORD SET
REV 02
NOT FOR
CONSTRUCTION





CALIFORNIA HIGH-SPEED RAIL PROJECT PALMDALE TO BURBANK

ALIGNMENT "REFINED SR14" TYPICAL SECTIONS SAN FERNANDO ROAD SHEET 2 OF 2

	CONTRACT NO. HSR14-42
	DRAWING NO. CV-R3010-S14
	NO SCALE
	SHEET NO.

CSHR
R/W
VAR
VAR 33' TO 41'

VAR 45'-53'

R/W
VAR 45'-53'

NB LANE
NB LANE
NB LANE
NB LANE
NB LANE
SB LANE
SW

CHSR FG

2''

2''

PG


2''


CHSR FG

CHSR F

SAN FERNANDO ROAD AT SHELDON

STA 2+48 TO STA 24+00

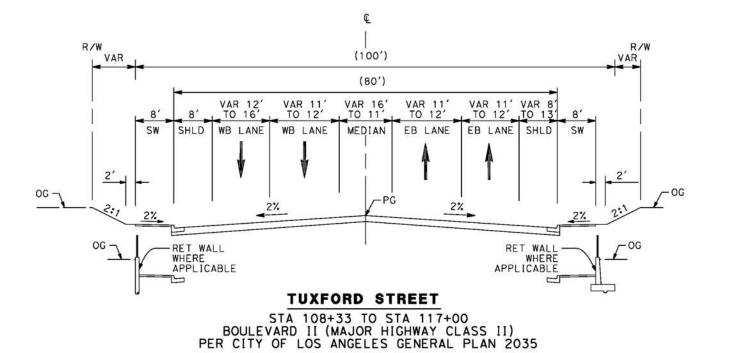

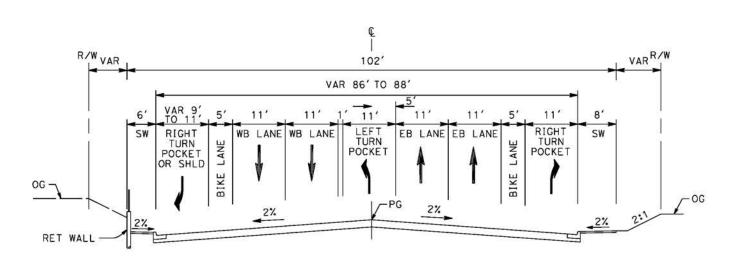

TUXFORD STREET

STA 105+00 TO STA 108+33
BOULEVARD II (MAJOR HIGHWAY CLASS II)
PER CITY OF LOS ANGELES GENERAL PLAN 2035

	1						J.C. ALAMILLA	
	4						A. SANZ	PEPD RECORD 8
\vdash	+		-				W. GUO	REV 02
e -	+						IN CHARGE A. RELANO	NOT FOR CONSTRUCTIO
Č -	EV	DATE	BY	СНК	APP	DESCRIPTION	DATE 04/30/2021	CONSTRUCTIO






CALIFORNIA HIGH-SPEED RAIL PROJECT PALMDALE TO BURBANK

ALIGNMENT "REFINED SR14" TYPICAL SECTIONS TUXFORD STREET


CV-R3011-S14
CV NOOTT ST
SCALE

SHEET NO.

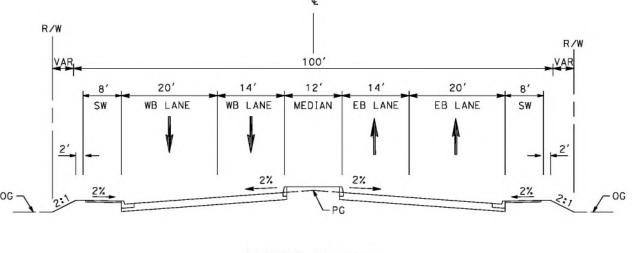

OLINDA STREET

STA 15+00 TO STA 17+50 COLLECTOR STREET PER CITY OF LOS ANGELES GENERAL PLAN 2035

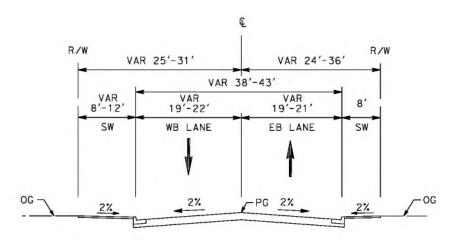

OLINDA STREET

STA 13+50 TO STA 15+00 AND STA 17+50 TO STA 18+20 COLLECTOR STREET PER CITY OF LOS ANGELES GENERAL PLAN 2035

						J.C. ALAMILLA	
						A. SANZ	PEPD RECORD SET
						W. GUO	REV 02
						IN CHARGE A. RELANO	NOT FOR CONSTRUCTION
REV	DATE	BY	СНК	APP	DESCRIPTION	DATE 04/30/2021	CONSTRUCTION





CALIFORNIA HIGH-SPEED RAIL PROJECT PALMDALE TO BURBANK

ALIGNMENT "REFINED SR14" TYPICAL SECTIONS OLINDA STREET

CONTRACT NO. HSR14-42
CV-R3012-S14
NO SCALE

SHEET NO.



PEPD RECORD SET REV 02

CONSTRUCTION

R/W

SENER



R/W


CALIFORNIA HIGH-SPEED RAIL PROJECT PALMDALE TO BURBANK

ALIGNMENT "REFINED SR14" TYPICAL SECTIONS VALLEY FORGE AND EAST AVE R11

CONTRACT NO.	
CONTRACT NO. HSR14-42	
ORAWING NO. CV-R3013-S14	
NO SCALE	
SHEET NO.	


VALLEY FORGE


STA 10+34 TO 14+98
RESIDENTIAL ENTRANCE STREET (E)
PER CITY OF PALMDALE GENERAL PLAN

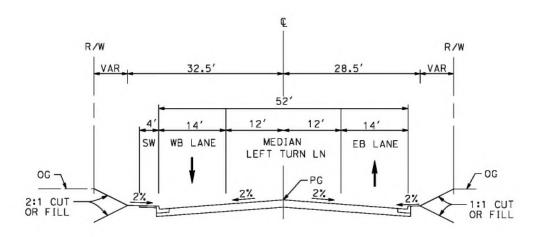

EAST AVENUE R11

STA 10+36 TO STA 18+38 LOCAL INTERIOR STREET (F1) PER CITY OF PALMDALE GENERAL PLAN

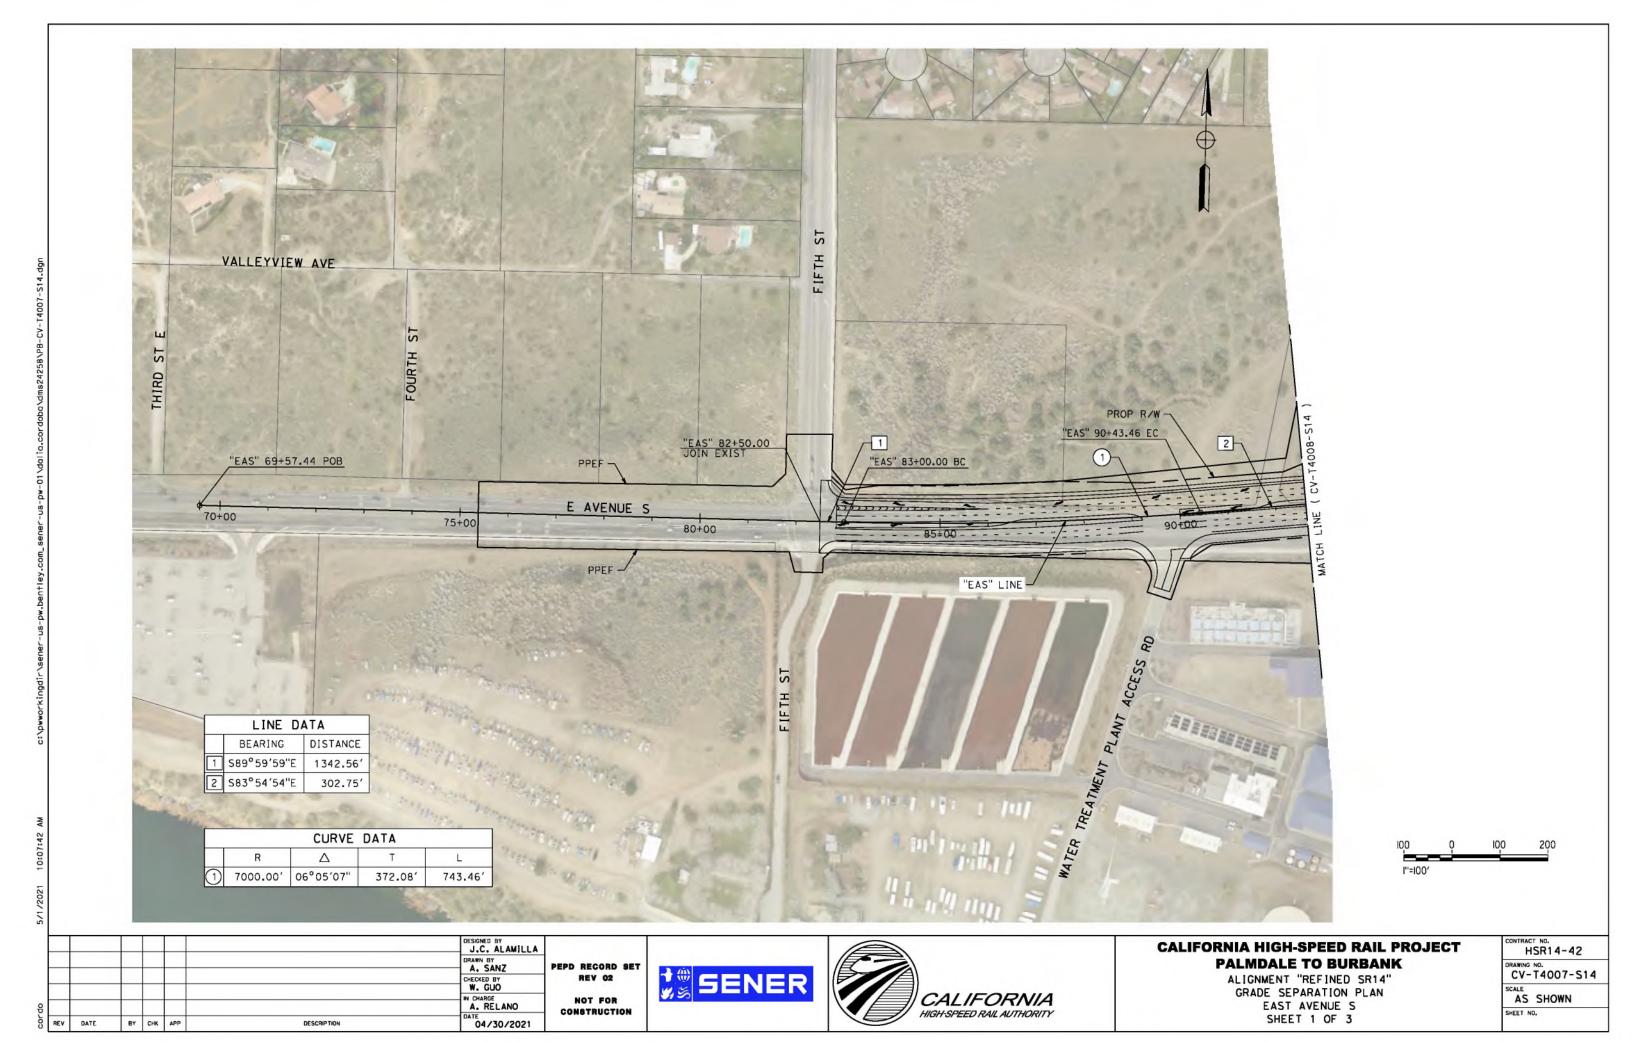

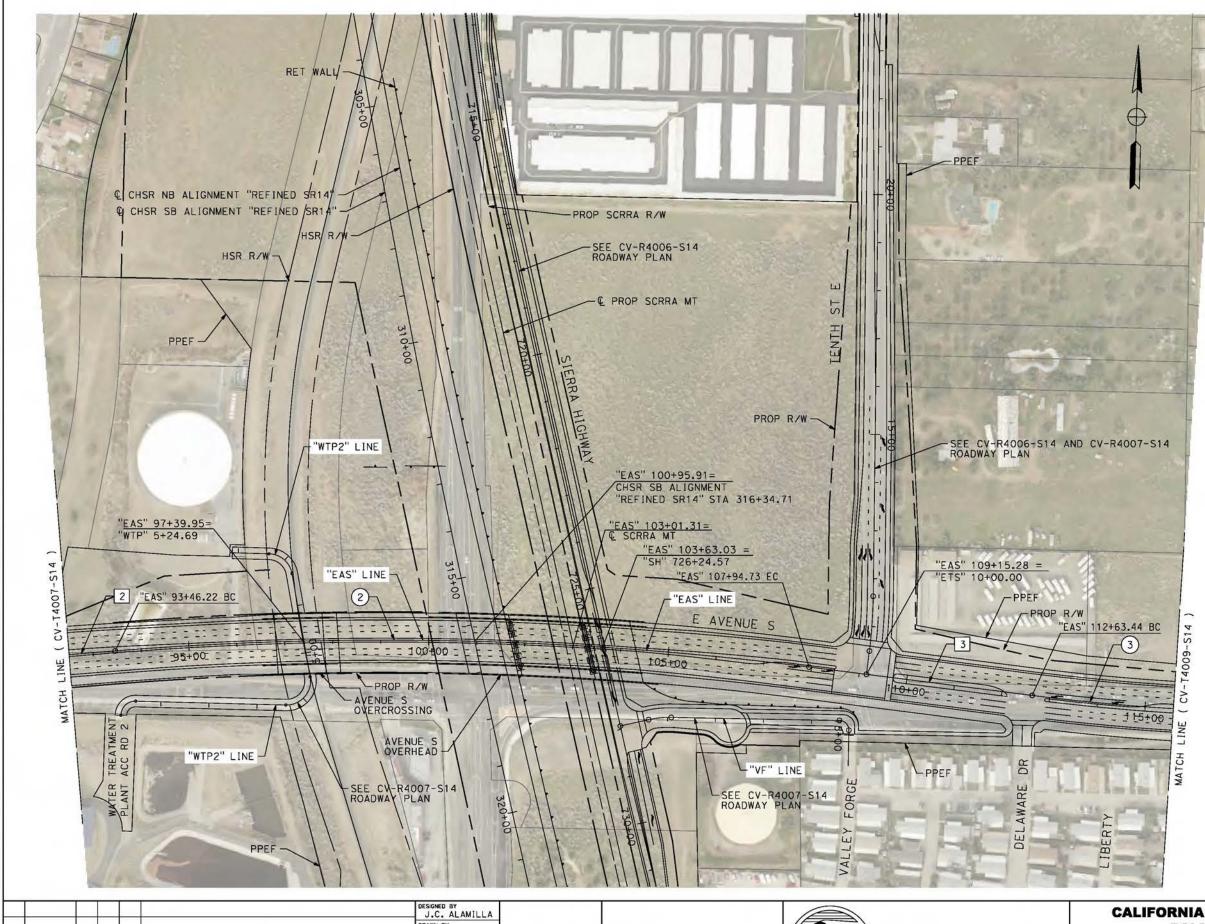

	LINE D	ATA
	BEARING	DISTANCE
2	N83°54′54"E	302.75
3	S84°14′45″E	468.71

		CURVE	DATA	
	R	Δ	Т	L
2	7010.00'	11°50′22"	726.85	1448.51
3	4500.00'	5°48′55"	228.56	456.72



						J.C. ALAMILLA
_						DRAWN BY A. SANZ
-						W. GUO
-		-				IN CHARGE A. RELANO
REV	DATE	BY	СНК	APP	DESCRIPTION	DATE 04/30/2021

PEPD RECORD SET CONSTRUCTION

REV 02


NOT FOR




CALIFORNIA HIGH-SPEED RAIL PROJECT PALMDALE TO BURBANK

ALIGNMENT "REFINED SR14" GRADE SEPARATION PLAN EAST AVENUE S SHEET 2 OF 3

CONTRAC	
Н	ISR14-42
DRAWING	NO.
CV-	T4008-S14
SCALE	DOS TRANSPORTED TO A LONG TO A
	SHOWN

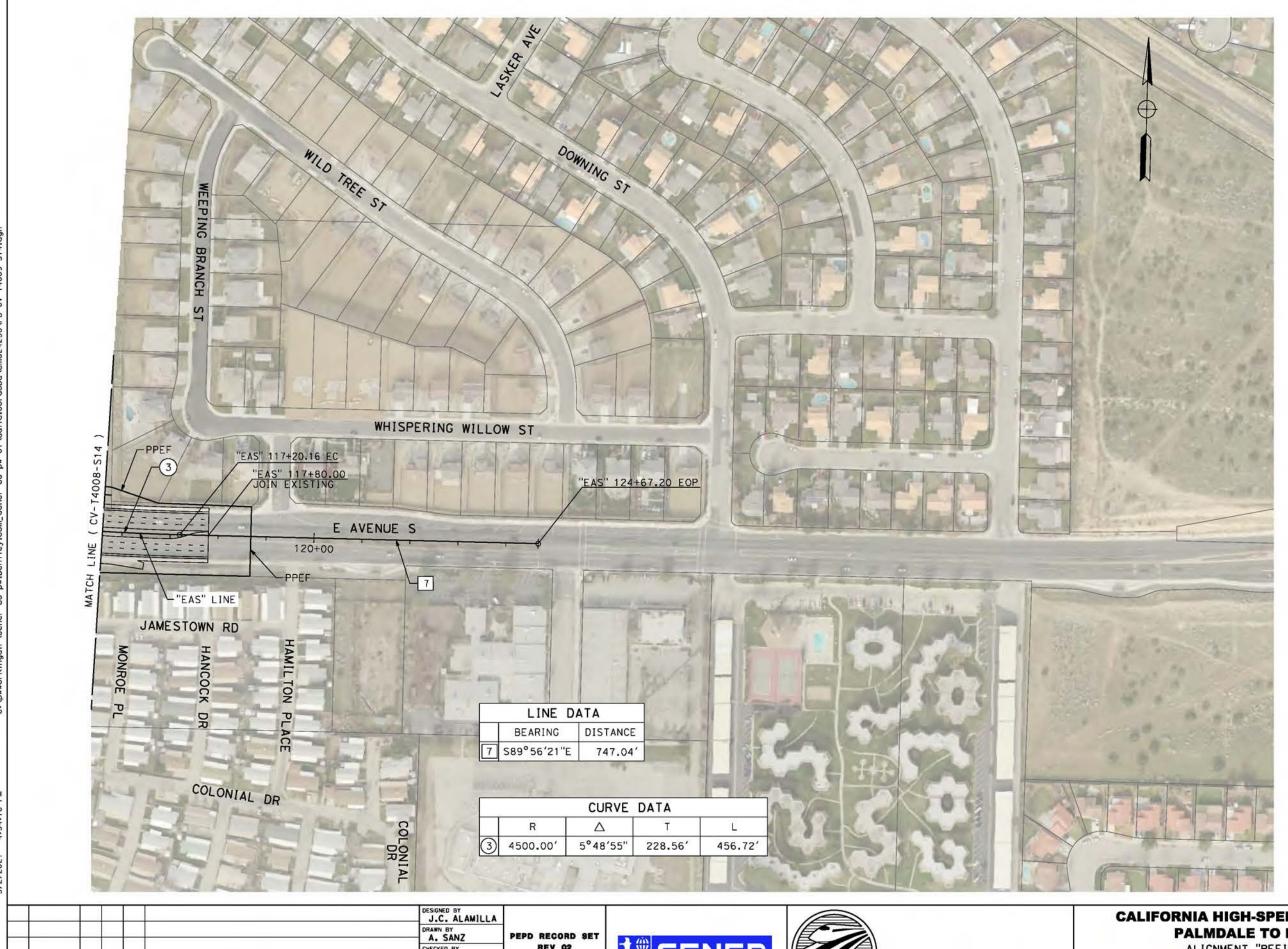

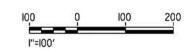

					DESIGNED BY J.C. ALAMILLA
					DRAWN BY A. SANZ
-		9 2			W. GUO
		+	-		IN CHARGE A. RELANO
REV	DATE	BY	СНК	APP DESC	DATE 04/30/2021

NOT FOR

CONSTRUCTION






CALIFORNIA HIGH-SPEED RAIL PROJECT PALMDALE TO BURBANK

ALIGNMENT "REFINED SR14" GRADE SEPARATION PLAN EAST AVENUE S SHEET 3 OF 3

HSR14-42					
DRAWING NO. CV-T4009-S14					
AS SHOWN					
SHEET NO.					

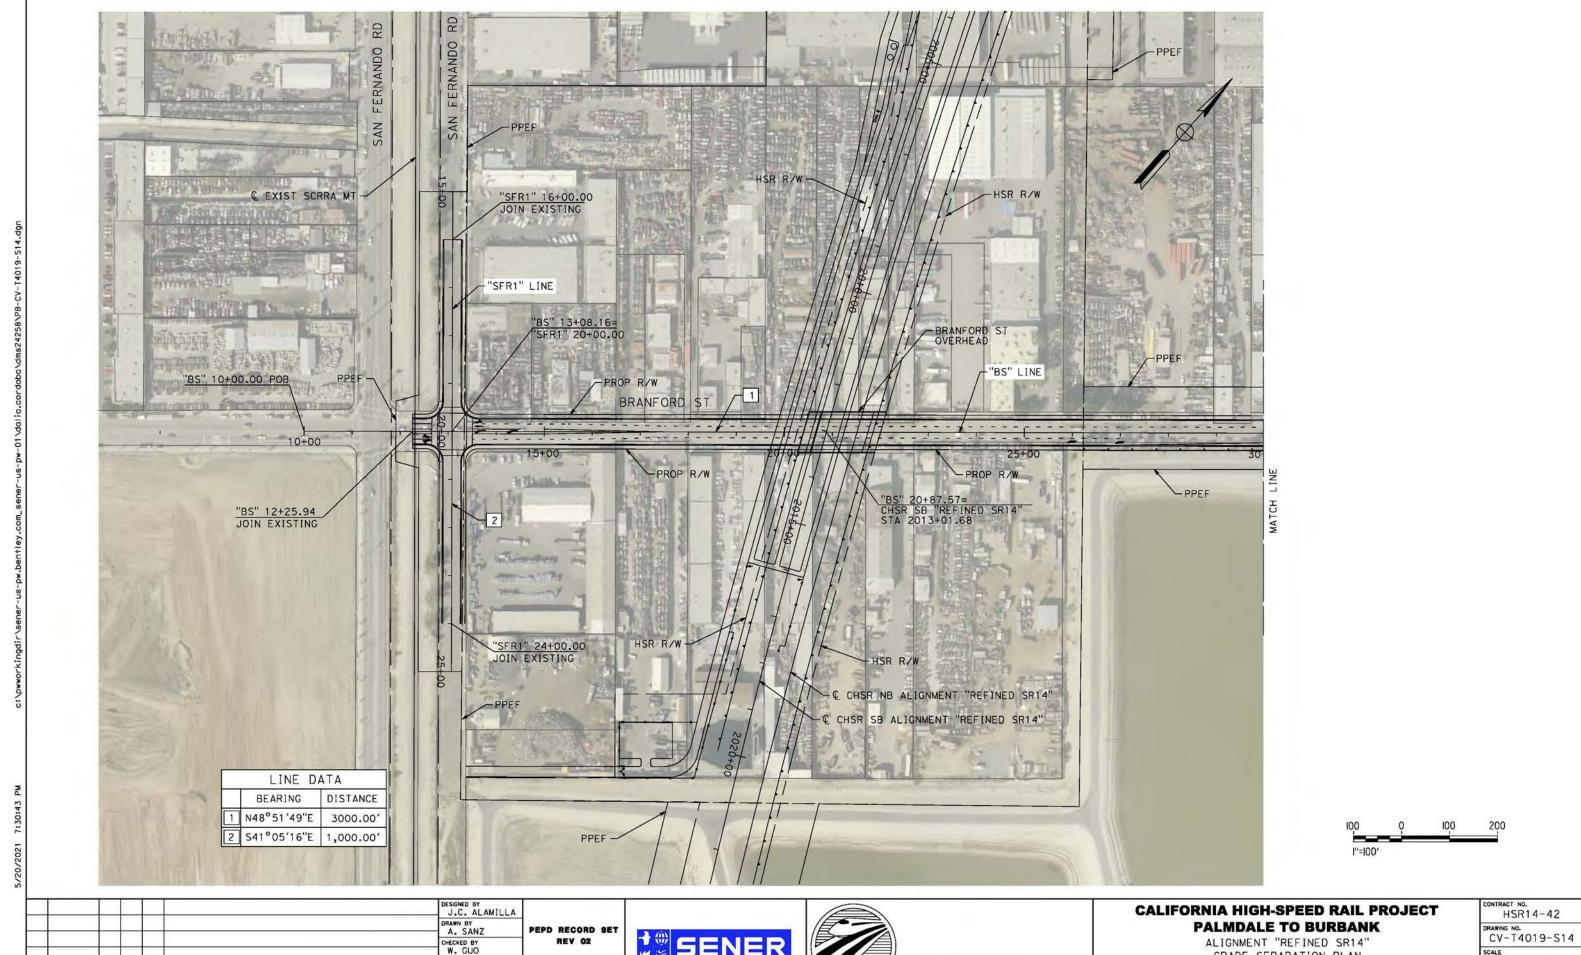

BY CHK APP

DESCRIPTION

NOT FOR CONSTRUCTION

A. RELANO


04/30/2021

SENER



GRADE SEPARATION PLAN BRANFORD STREET AND SAN FERNANDO ROAD "SFR1" SHEET 1 OF 2

HSR14-42				
DRAWING CV-	NO. T4019-S14			
SCALE AS	SHOWN			
SHEET N	0.			

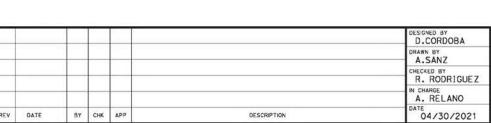

PEPD RECORD SET REV 02 NOT FOR

CONSTRUCTION





CALIFORNIA HIGH-SPEED RAIL PROJECT

PALMDALE TO BURBANK


ALIGNMENT "REFINED SR14"


GRADE SEPARATION PLAN


BRANDFORD STREET


SHEET 2 OF 2


OJECT	CONTRACT NO. HSR14-42
	DRAWING NO. CV-T4020-S14
	AS SHOWN
	SHEET NO

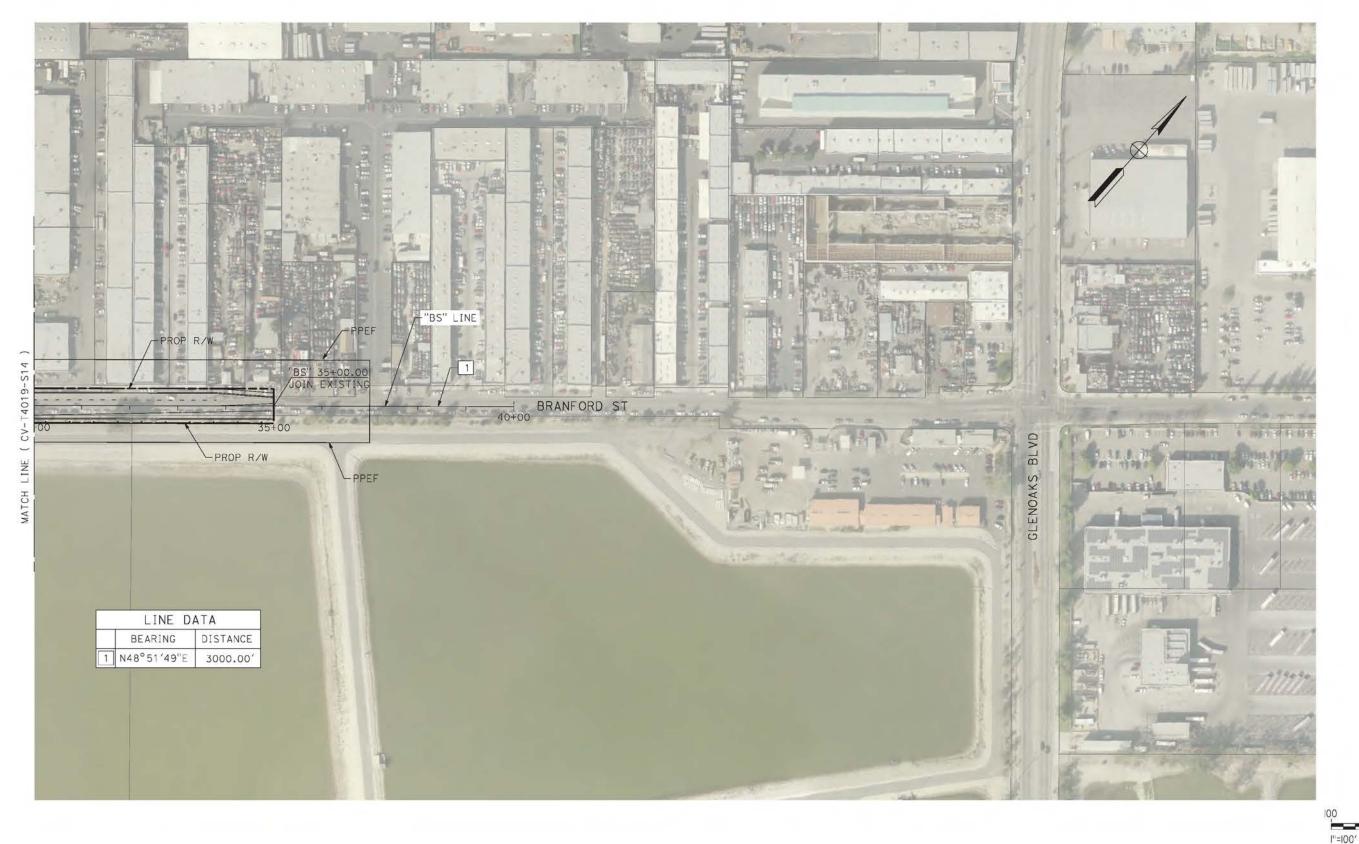


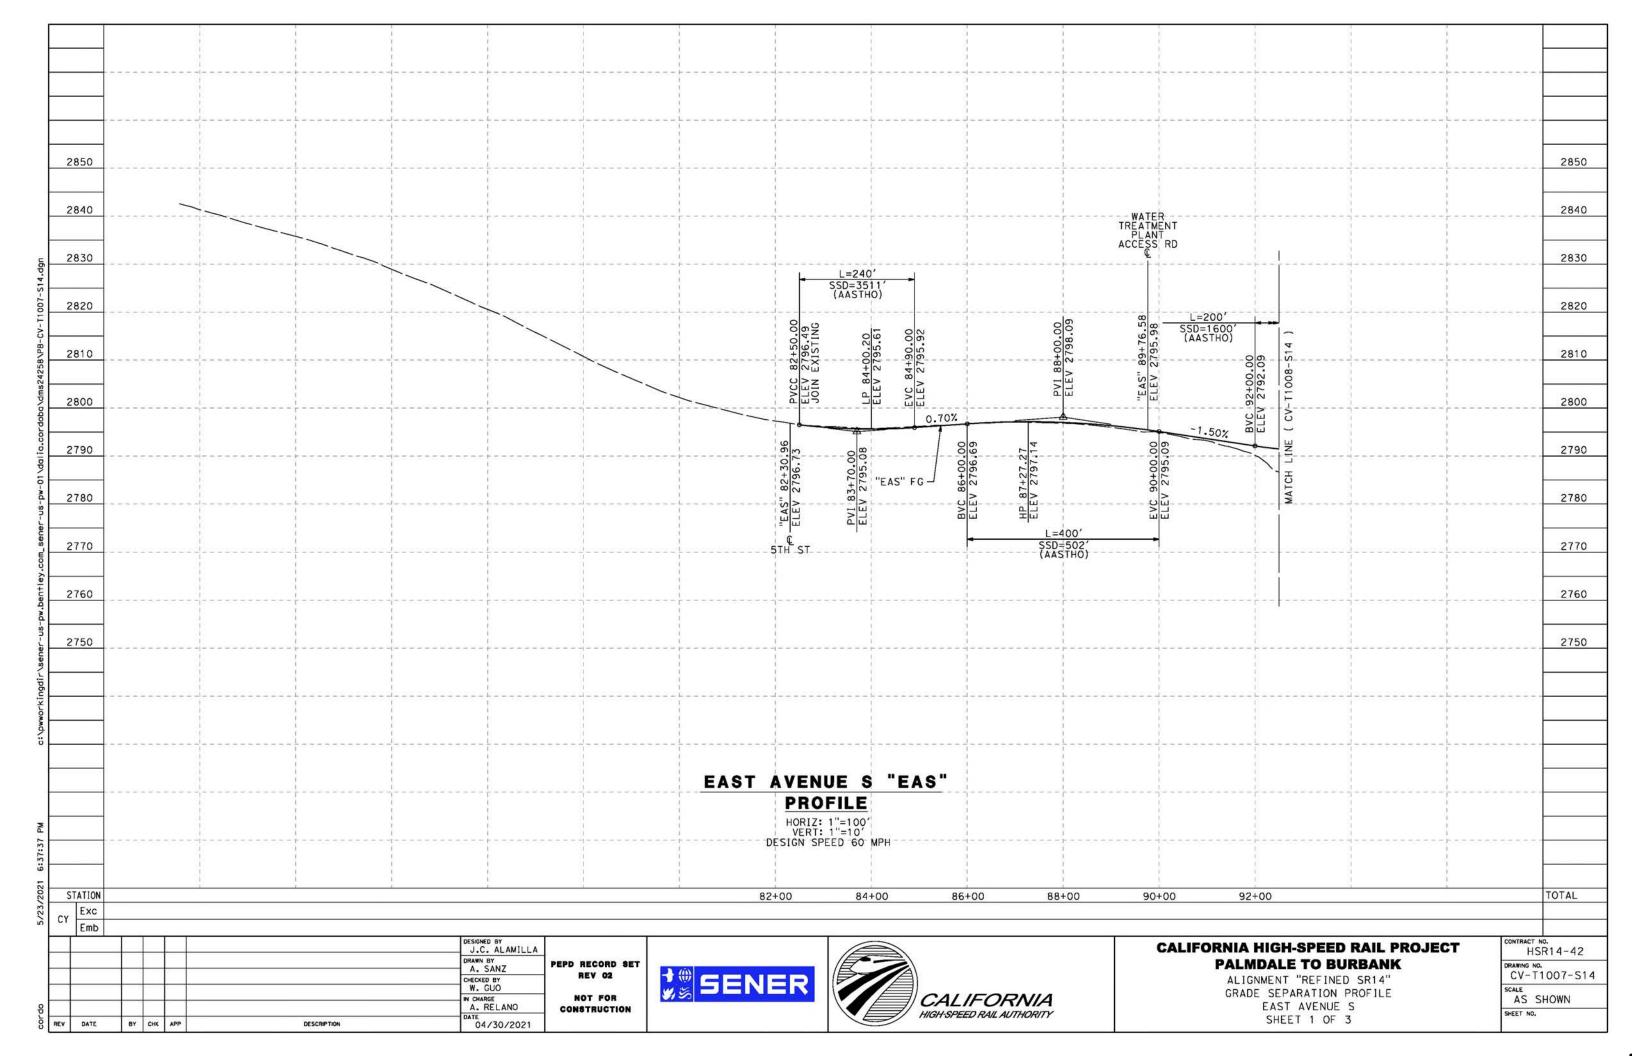


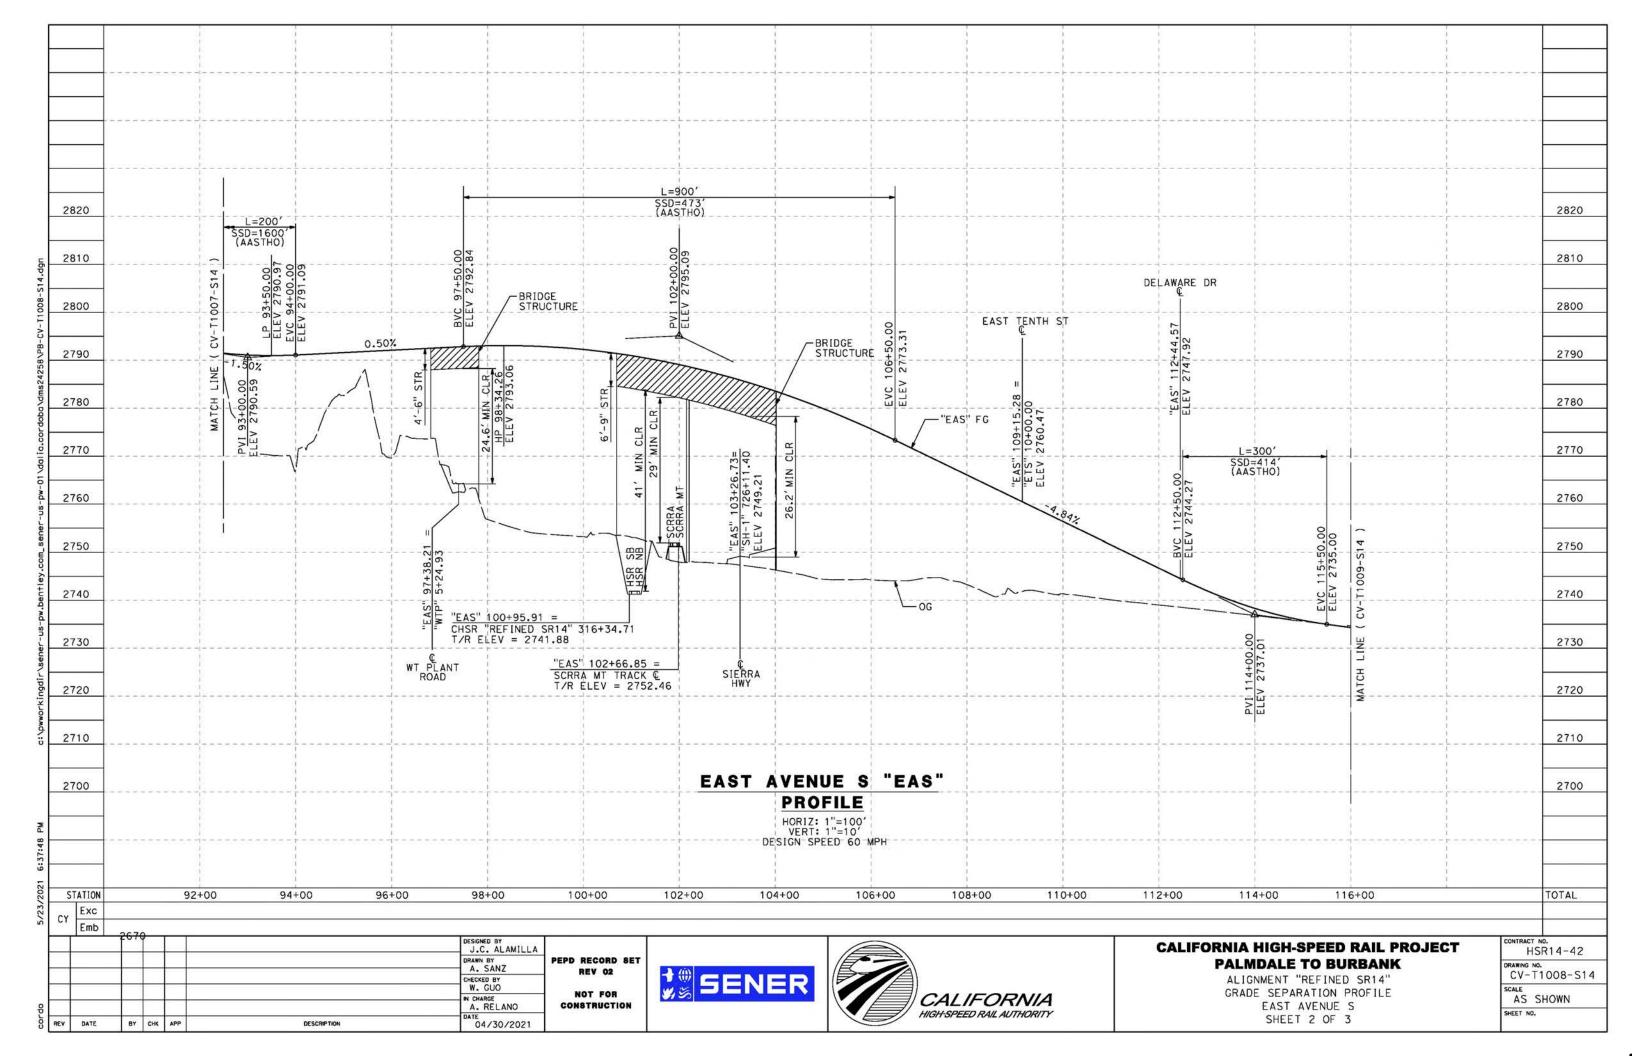

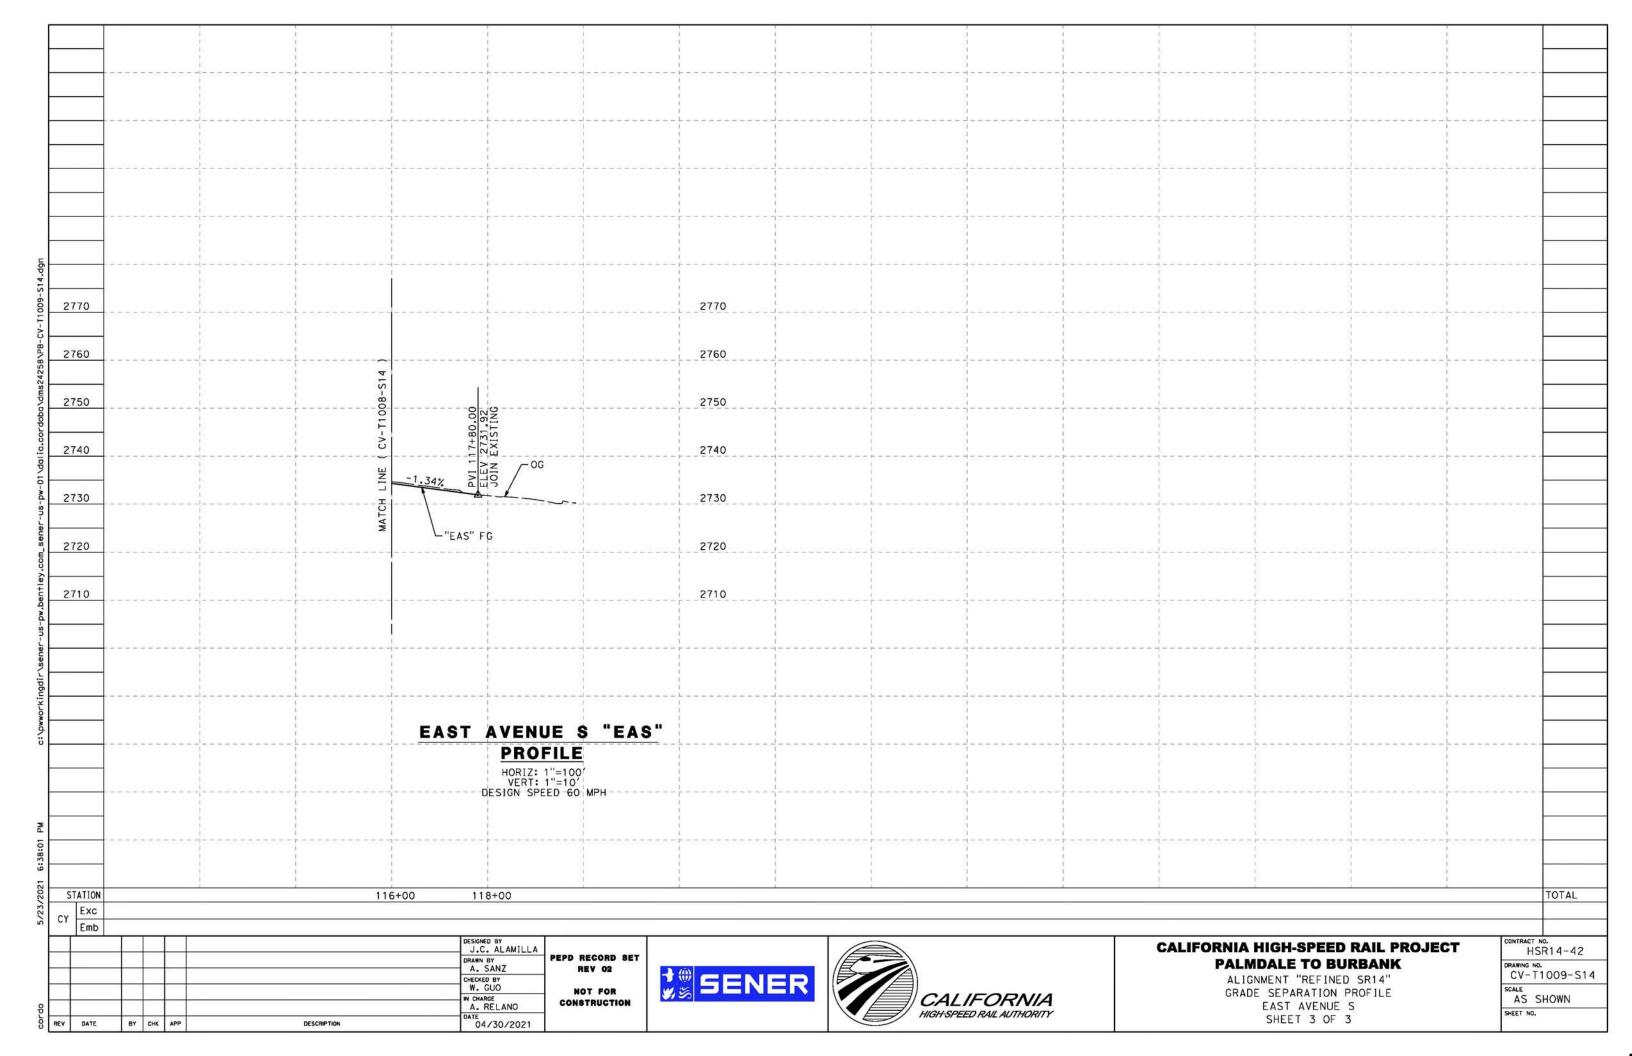

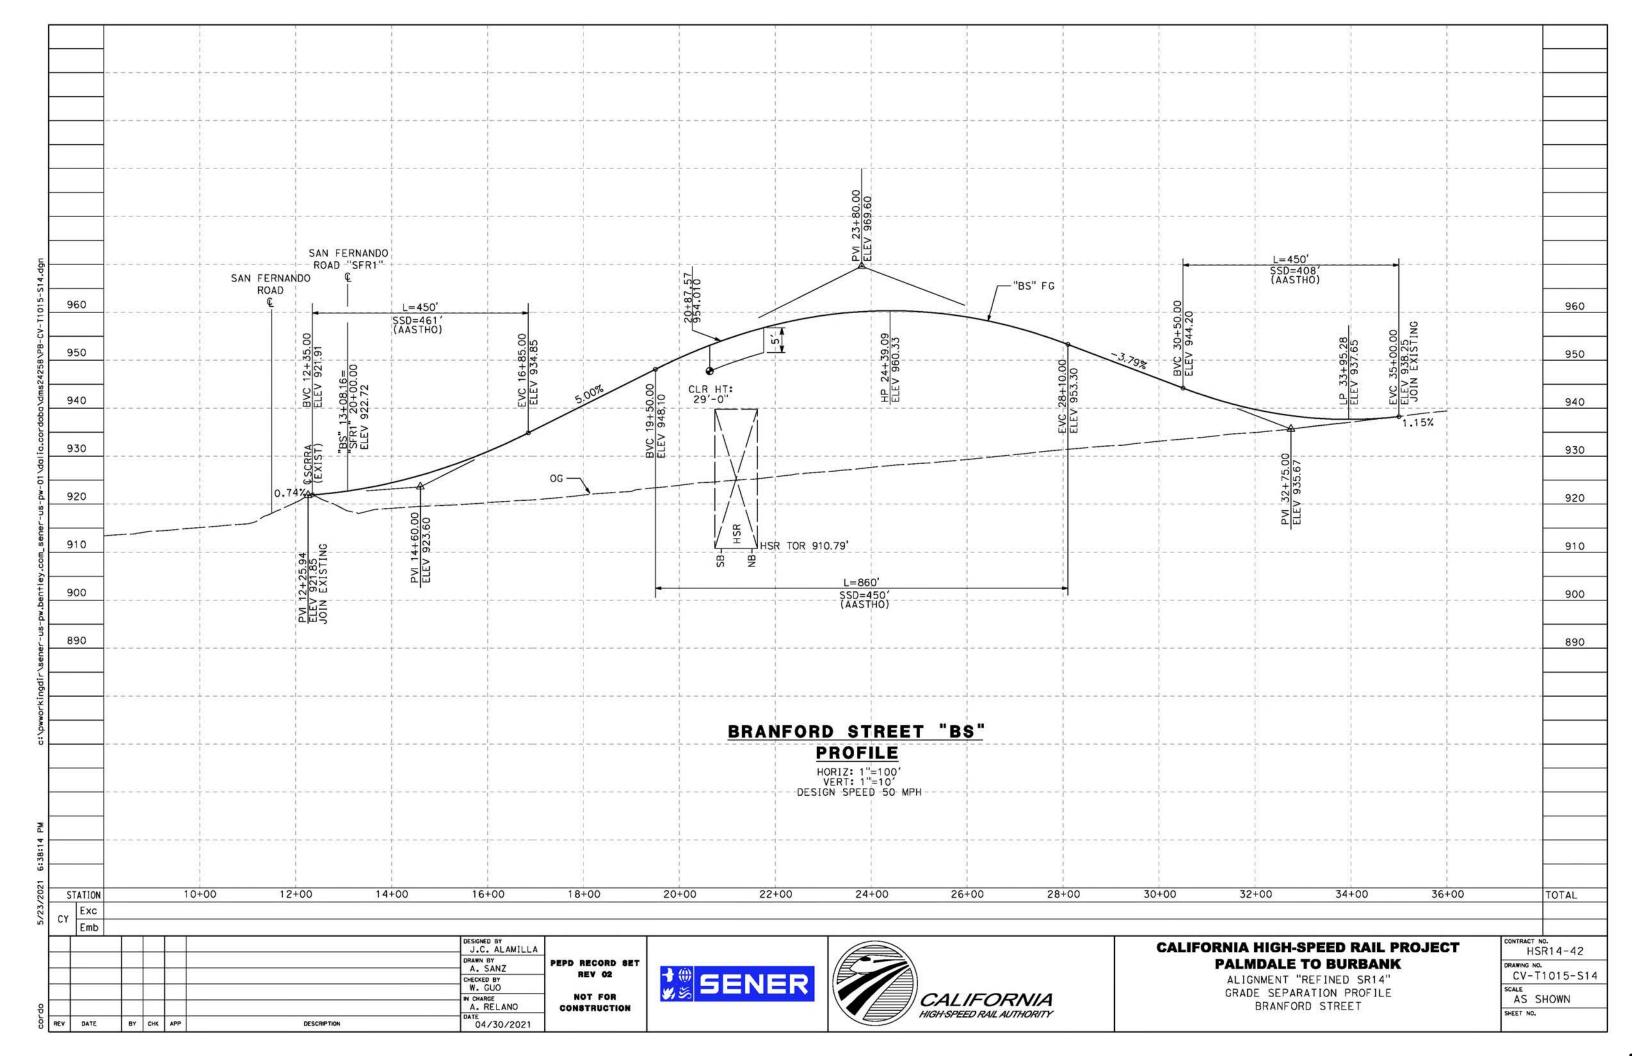

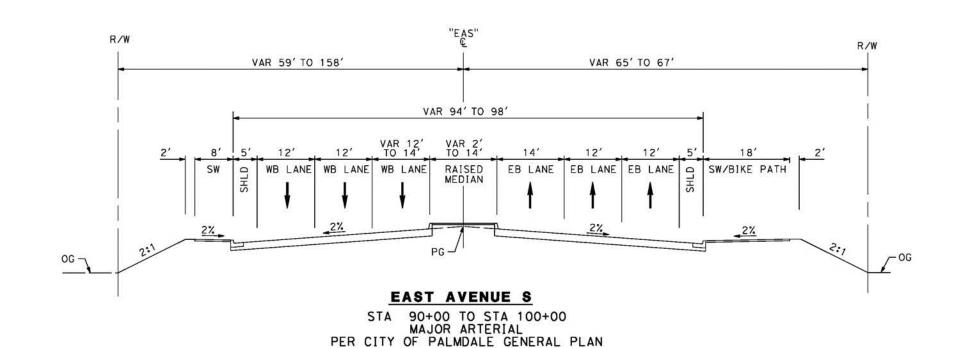

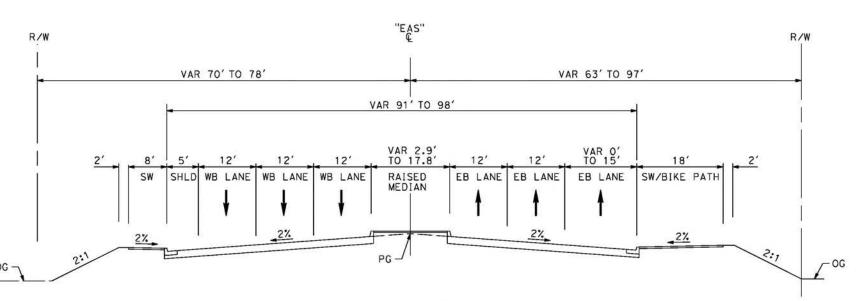

EAST AVENUE S

STA 83+84 TO STA 90+00 MAJOR ARTERIAL PER CITY OF PALMDALE GENERAL PLAN

-							DESIGNED BY	Ī
	-4		-		22		J.C. ALAMILLA	Į.
			-				DRAWN BY A. SANZ	PEPD RECORD SET
			+				W. GUO	REV 02
유			+				A. RELANO	NOT FOR CONSTRUCTION
COL	REV	DATE	ВҮ	СНК	APP	DESCRIPTION	DATE 04/30/2021	CONSTRUCTION








CALIFORNIA HIGH-SPEED RAIL PROJECT PALMDALE TO BURBANK

ALIGNMENT "REFINED SR14" TYPICAL SECTIONS EAST AVENUE S SHEET 1 OF 2

HSR14-42			
DRAWING CV-	[№] . T3001-S14		
SCALE NO	SCALE		
CUECT N	n .		

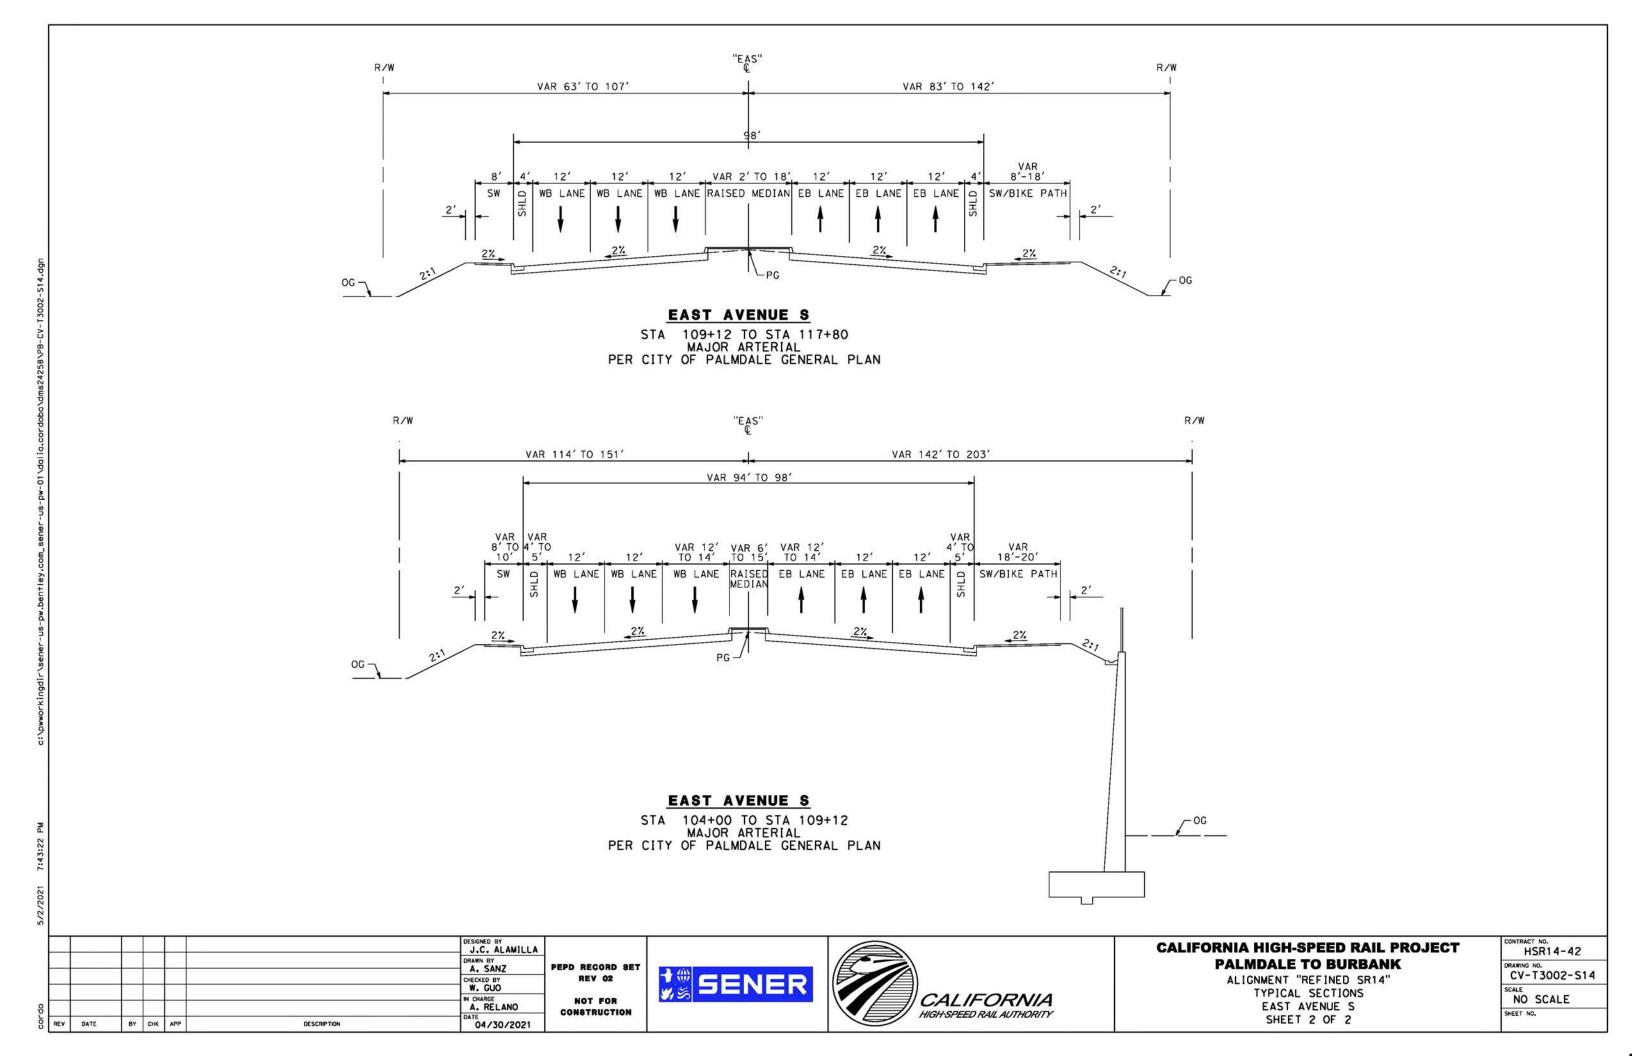

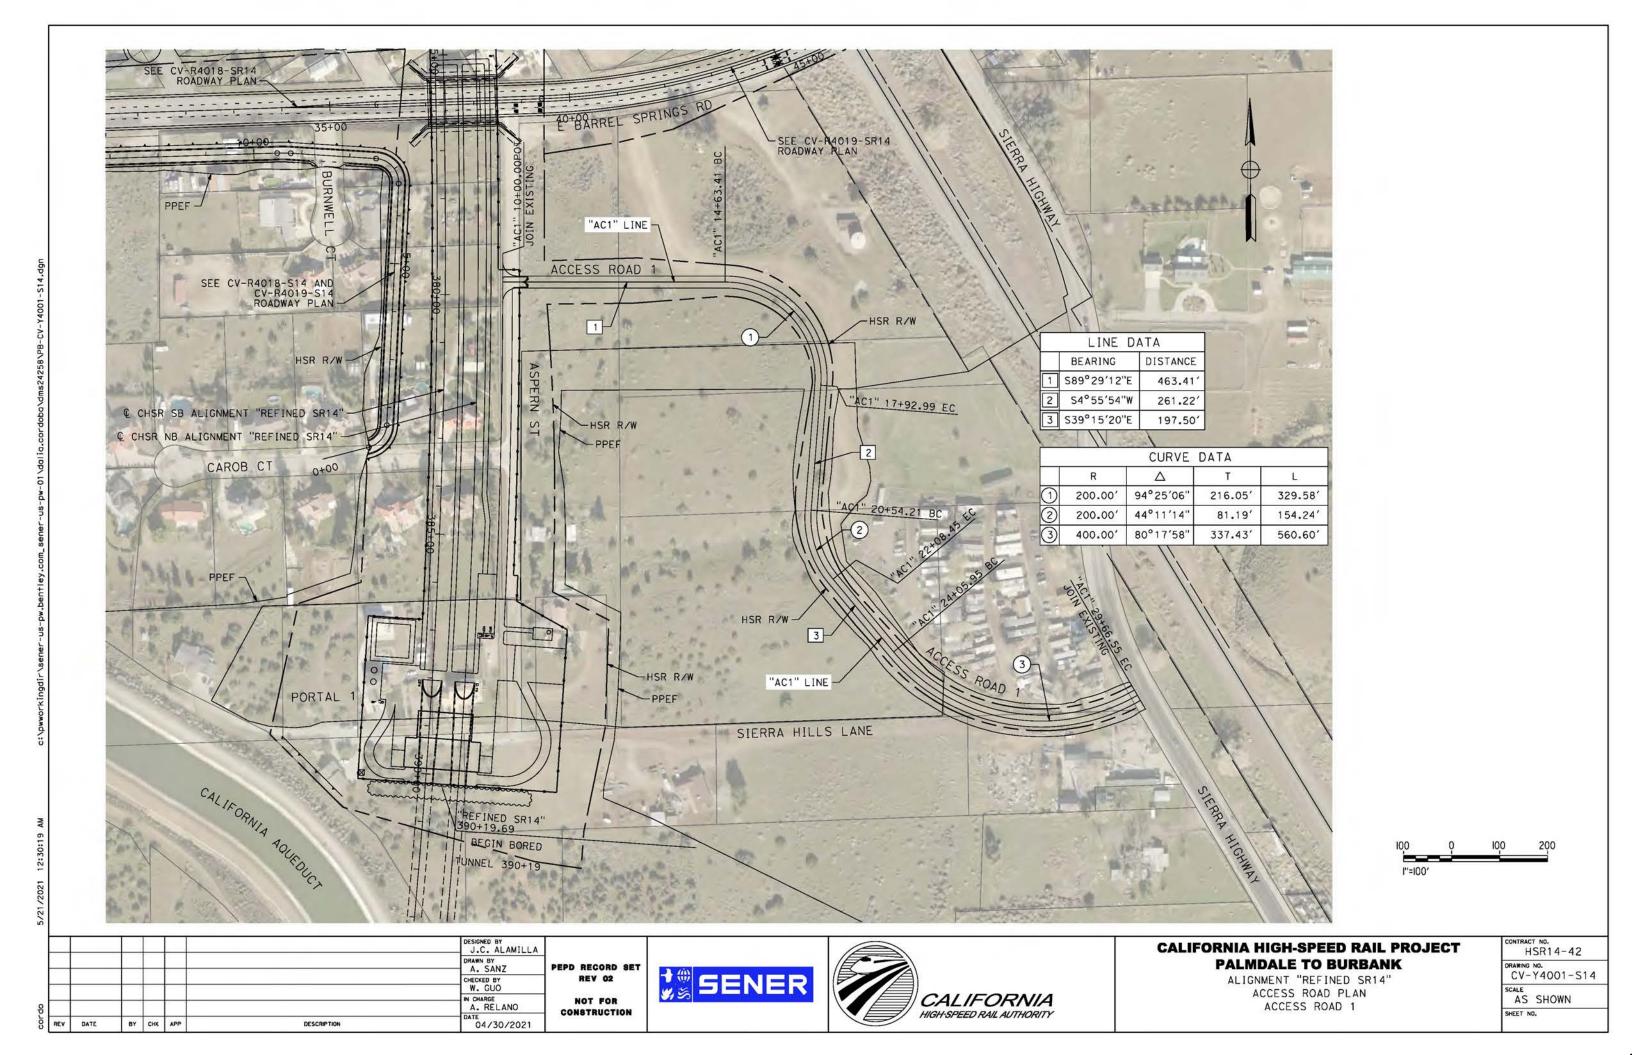

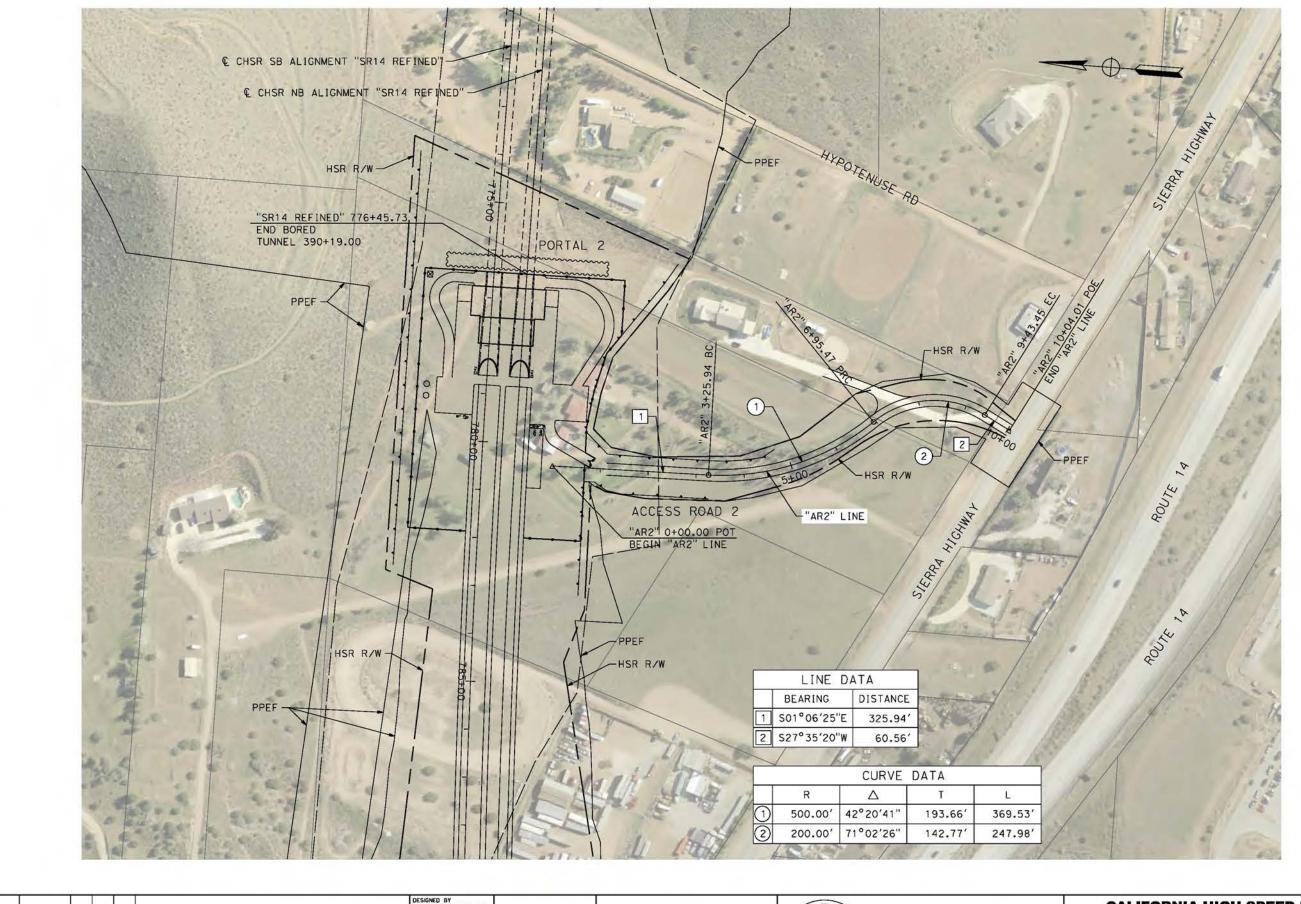



						J.C. ALAMILLA
						DRAWN BY A. SANZ
		-				CHECKED BY W. GUO
-						IN CHARGE A. RELANO
REV	DATE	BY	СНК	APP	DESCRIPTION	DATE 04/30/2021

PEPD RECORD SET REV 02 NOT FOR CONSTRUCTION








CALIFORNIA HIGH-SPEED RAIL PROJECT PALMDALE TO BURBANK

ALIGNMENT "REFINED SR14" ACCESS ROAD PLAN ACCESS ROAD 2

	SR14-42
DRAWING CV-	NO. Y4003-S14
SCALE	SHOWN
SHEET N	n.

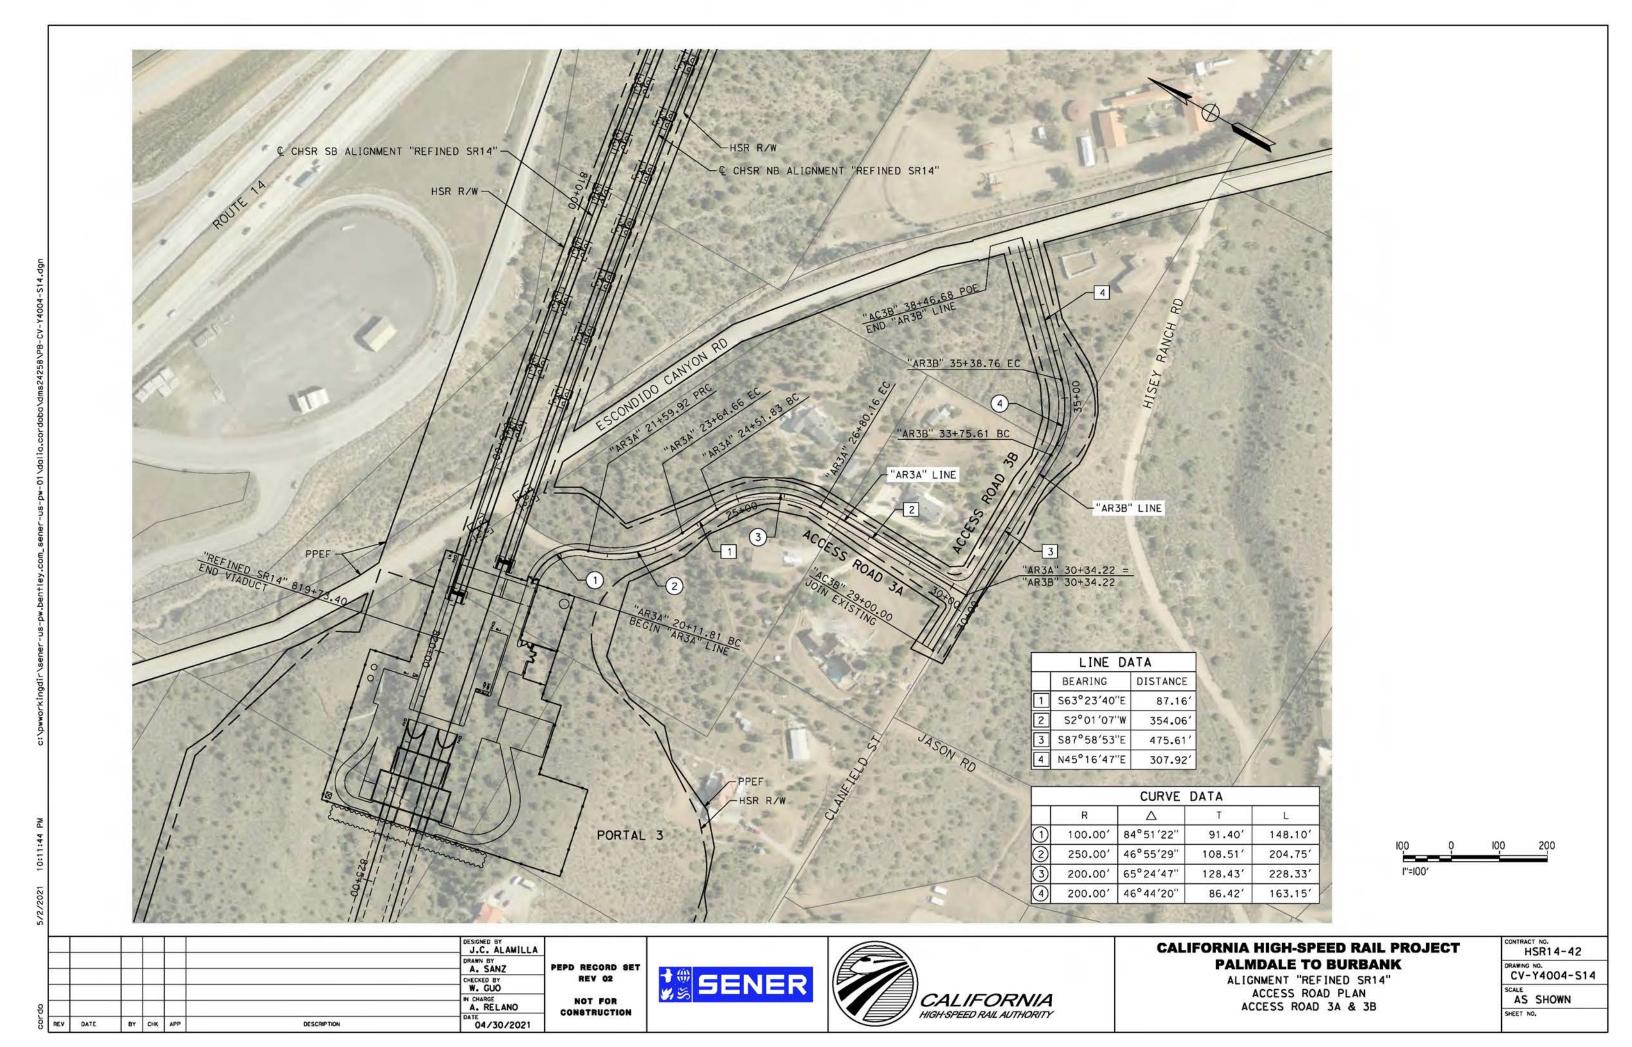

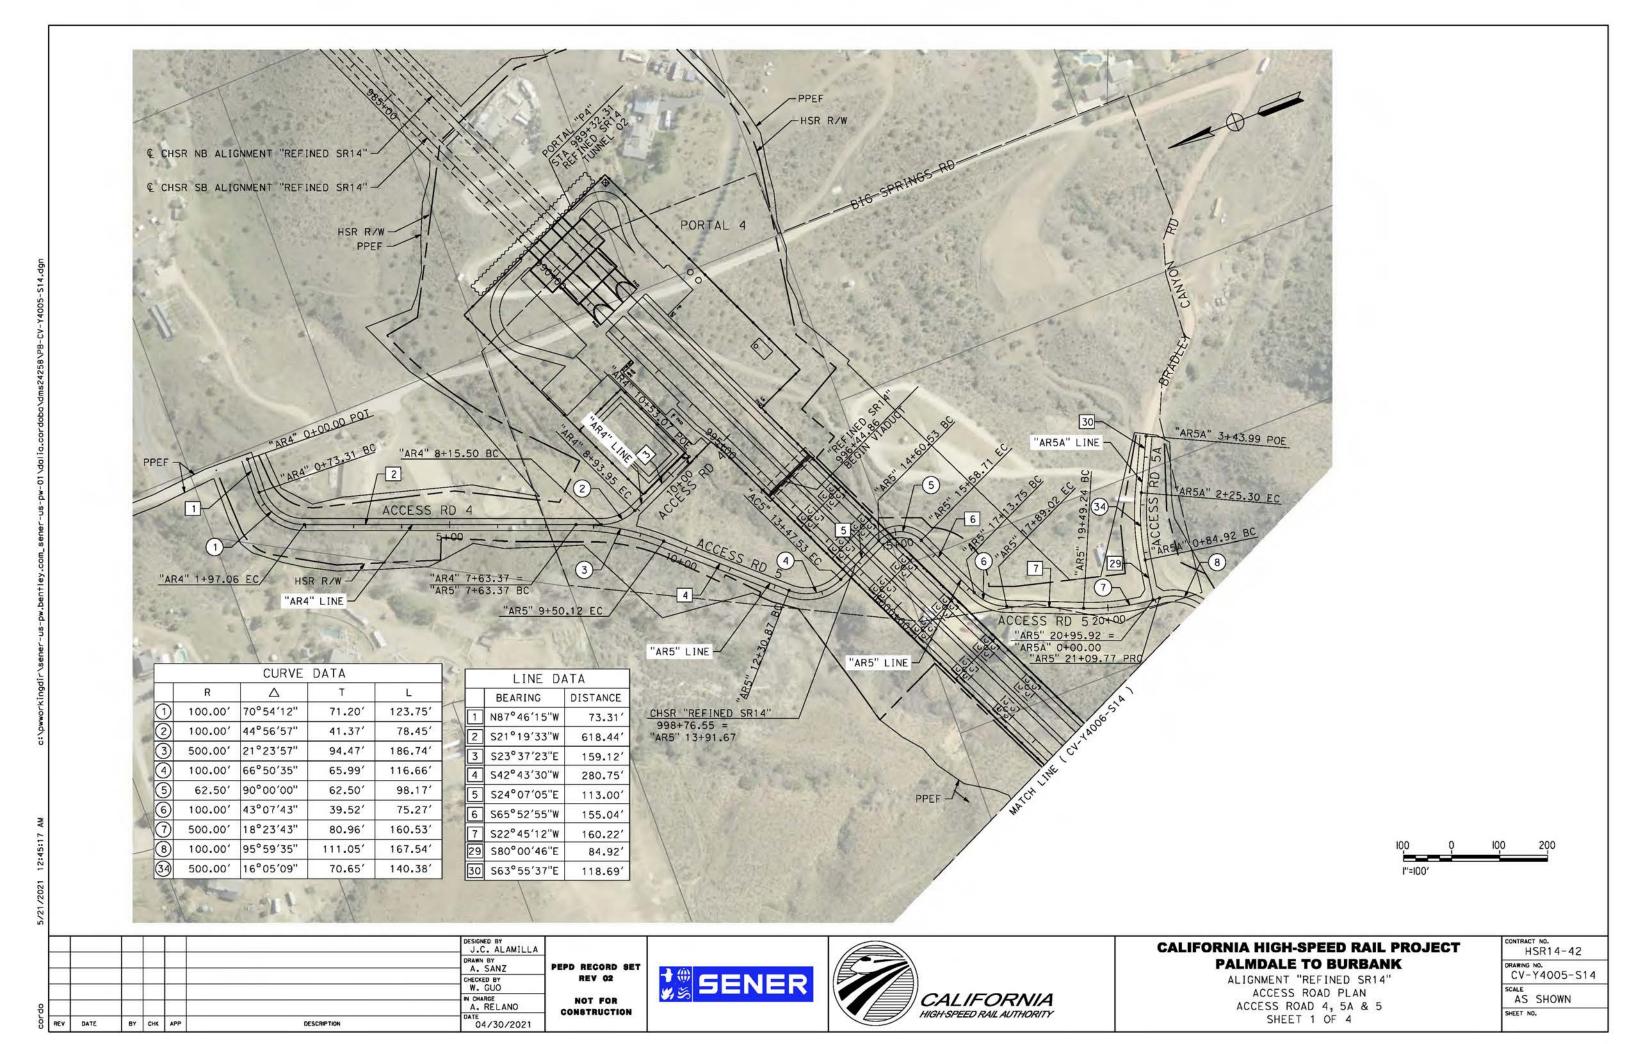

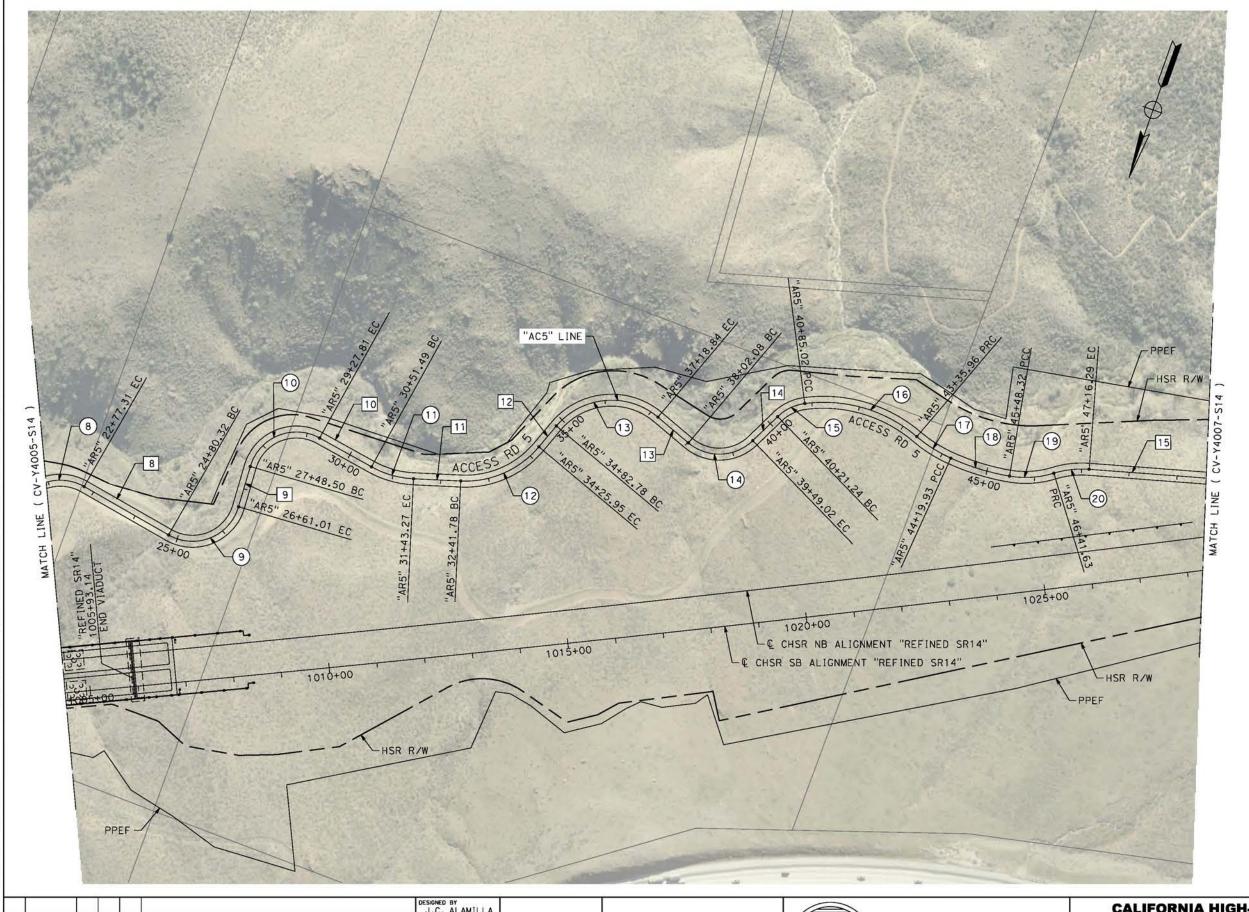

	LINE DA	ATA
	BEARING	DISTANCE
8	N79°38′56"W	203.01′
9	S3°10′34"E	87.49
10	N80°26′12"W	123.68'
11	S73°16′13"W	98.51′
12	S20°30′40"W	56.83′
13	N69°19′15"W	83.24
14	S26°29′13"W	72.22
15	S74°51′34"W	289.01'

		CURVE	DATA	
	R	Δ	T	L
8	100.00	95°59′35"	111.05'	167.54
9	100.00	103°31′38"	126.91	180.69
10	100.00'	102°44′21"	125.13′	179.31
1	200.00'	26°17′35"	46.71′	91.78
13	200.00'	52°45′33"	99.19'	184.16
13	150.00'	90°10′06"	150.44	236.06
19	100.00	84°11′32"	90.34	146.94
13	100.00'	36°32′31"	33.02'	63.78′
19	300.00	47°55′33"	133.34	250.94
1	300.00'	16°02′17"	42.26′	83.98′
13	500.00'	14°42′42"	64.55′	128.38
19	200.00'	26°44′01"	47.52	93.32'
20	200.00'	21°23′18"	37.77'	74.66



						DESIGNED BY J.C. ALAMILLA	Г
		+				DRAWN BY A. SANZ	,
- 1		+		A		W. GUO	
		+				IN CHARGE A. RELANO	
REV	DATE	BY	СНК	APP	DESCRIPTION	DATE 04/30/2021	1

PEPD RECORD SET REV 02 NOT FOR

CONSTRUCTION








CALIFORNIA HIGH-SPEED RAIL PROJECT PALMDALE TO BURBANK


ALIGNMENT "REFINED SR14"
ACCESS ROAD PLAN
ACCESS ROAD 5
SHEET 2 OF 4

CC	INTRACT NO.
200	HSR14-42
ne	RAWING NO. CV-Y4006-S14
SC	AS SHOWN

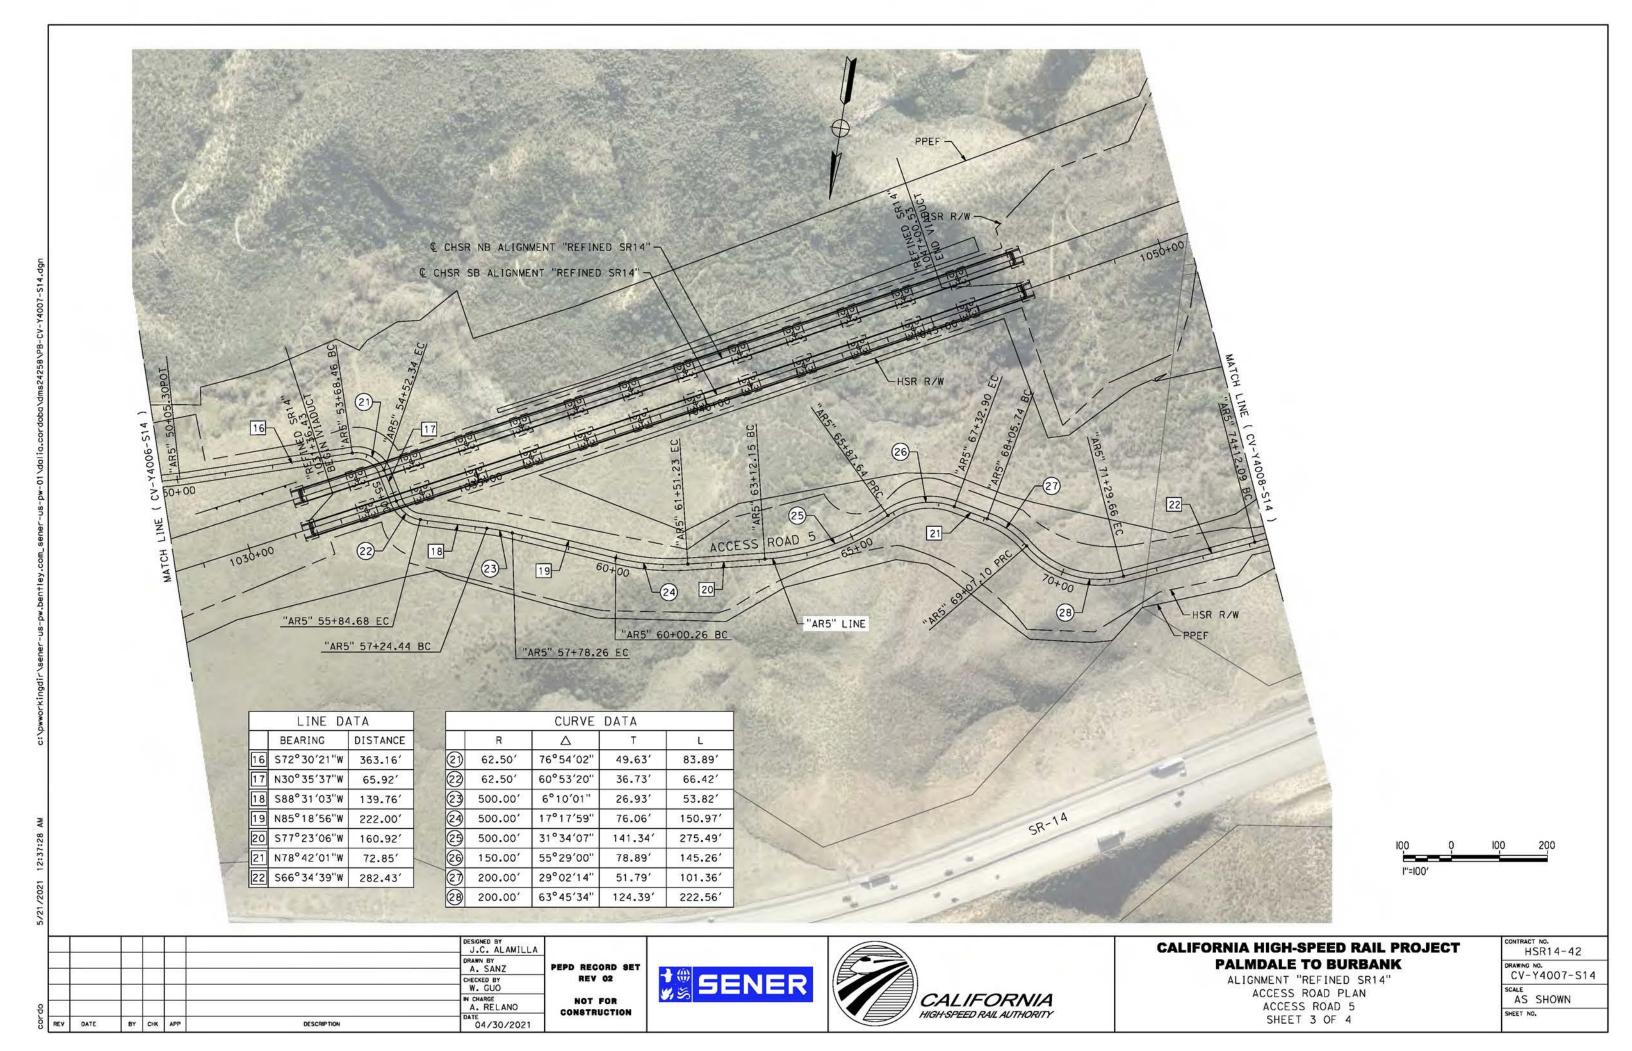

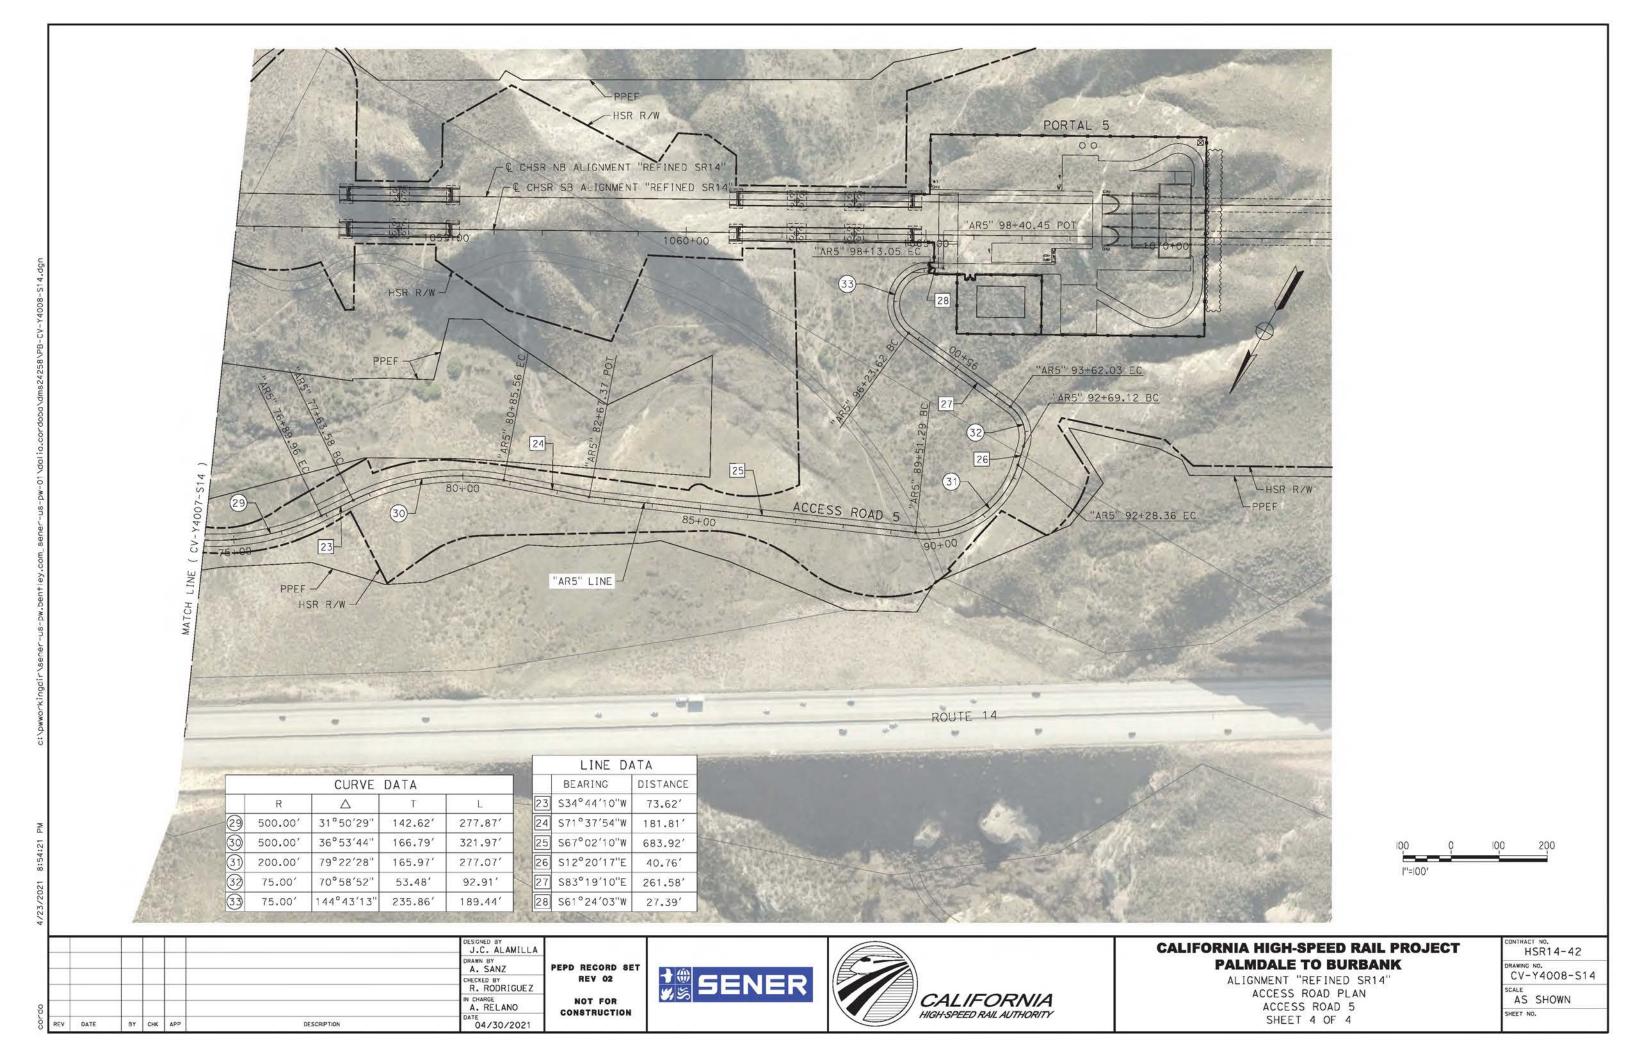

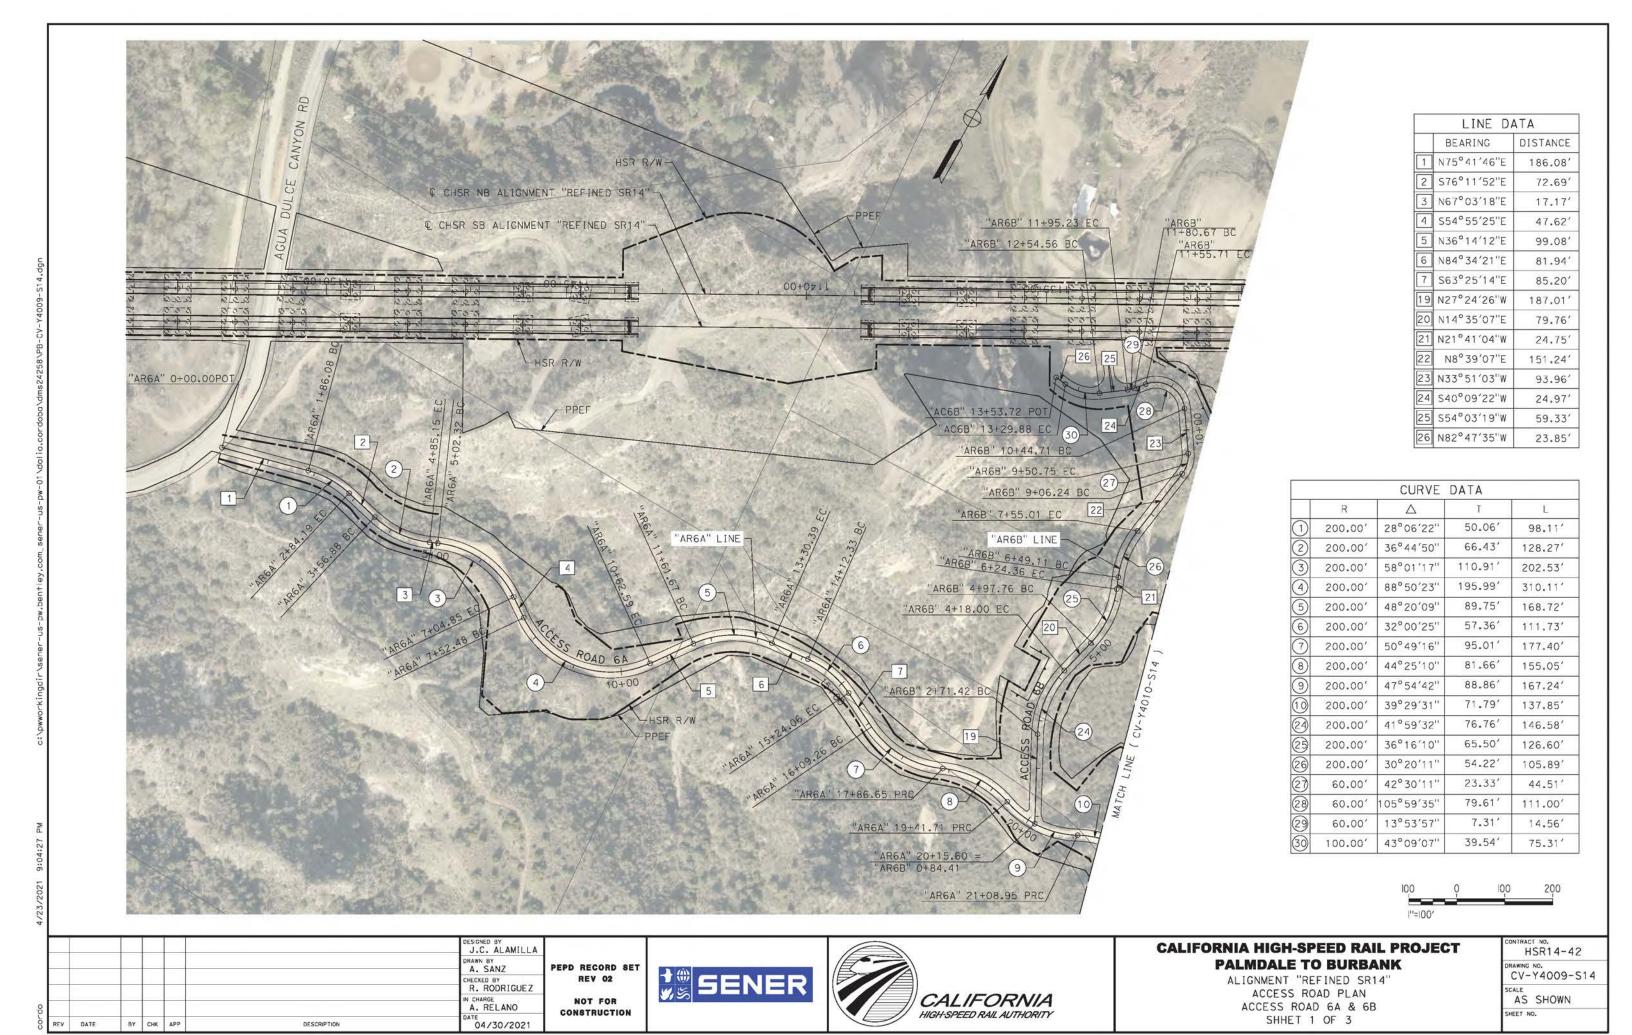

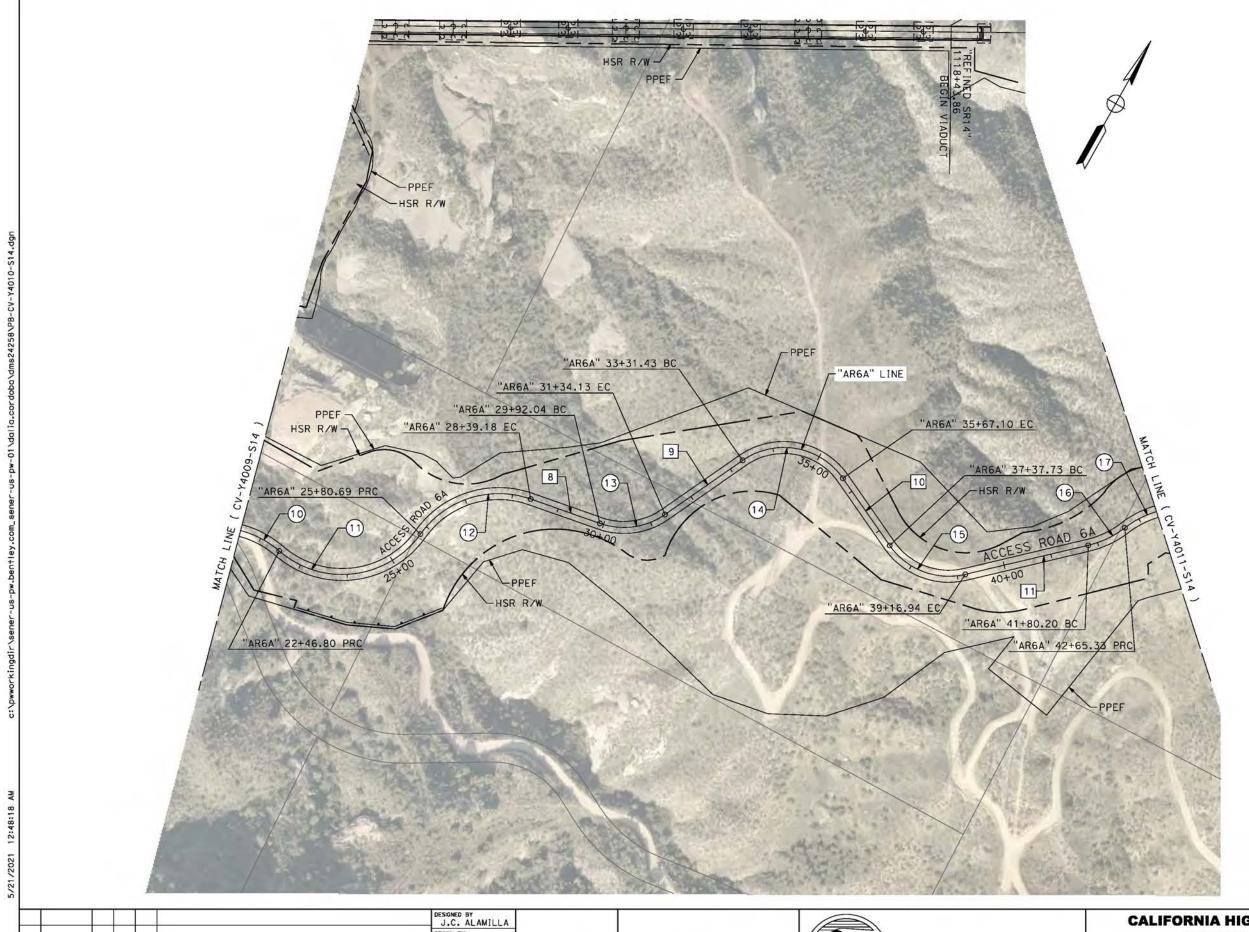

	LINE D	ATA
	BEARING	DISTANCE
8	N80°09'24"E	152.86
9	N25°52′58"E	197.31
10	S64°05′52"E	170.62
11	N47°26′53"E	263.26

	,	CURVE DATA				
	R	Δ	T	L,		
10	200.00'	39°29′31"	71.79′	137.85		
1	200.00'	95°39′08"	220.77′	333.89		
13	200.00'	74°03′02"	150.05'	258.49'		
13	150.00'	54°16′25"	76.88′	142.09'		
13	150.00'	90°01′09"	150.05′	235.67'		
13	150.00′	68°27′15"	102.04	179.21		
16	200.00'	24°23′13"	43.22'	85.13		
1	200.00'	55°21′38"	104.91′	193.24		



						J.C. ALAMILLA	Γ
		-				DRAWN BY A. SANZ	1
						CHECKED BY W. GUO	
		+				IN CHARGE A. RELANO	
REV	DATE	BY	СНК	APP	DESCRIPTION	DATE 04/30/2021	

PEPD RECORD SET REV 02 NOT FOR

CONSTRUCTION







CALIFORNIA HIGH-SPEED RAIL PROJECT PALMDALE TO BURBANK

ALIGNMENT "REFINED SR14"
ACCESS ROAD PLAN
ACCESS ROAD 6A
SHEET 2 OF 3

CONTRAC	T NO.
Н	SR14-42
DRAWING CV-	NO. Y4010-S14
SCALE	SHOWN

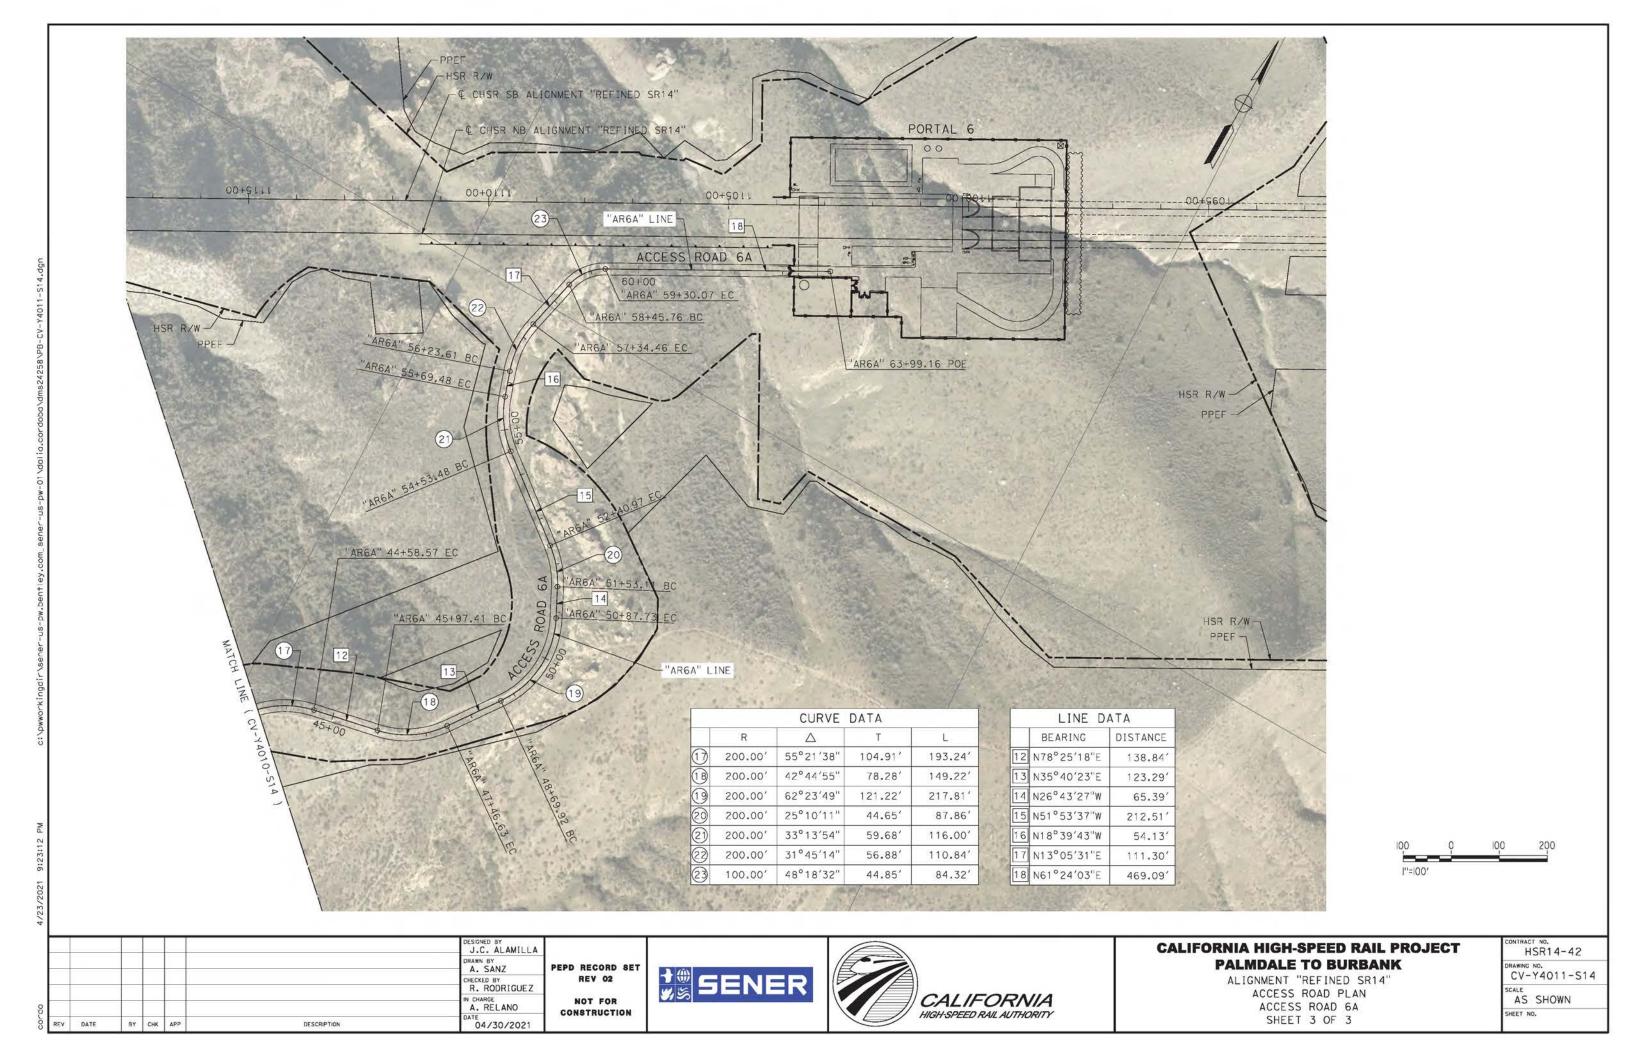

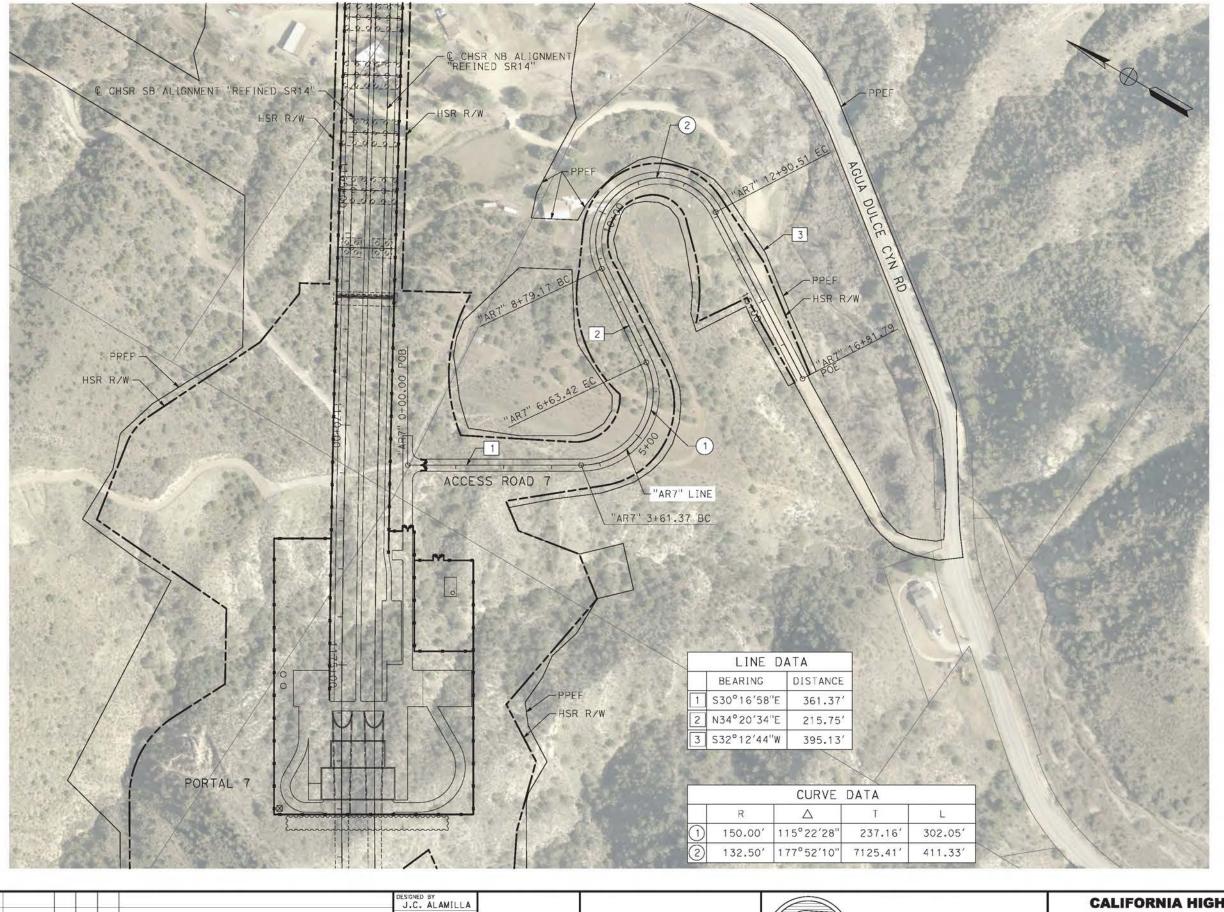



						J.C. ALAMILLA
						DRAWN BY A. SANZ
						CHECKED BY R. RODRIGUEZ
						IN CHARGE A. RELANO
REV	DATE	BY	CHK	APP	DESCRIPTION	DATE 04/30/2021

PEPD RECORD SET REV 02 NOT FOR

CONSTRUCTION








CALIFORNIA HIGH-SPEED RAIL PROJECT PALMDALE TO BURBANK


ALIGNMENT "REFINED SR14" ACCESS ROAD PLAN ACCESS ROAD 7

١	HSR14-42
1	CV-Y4012-S14
1	AS SHOWN
ŀ	SHEET NO.

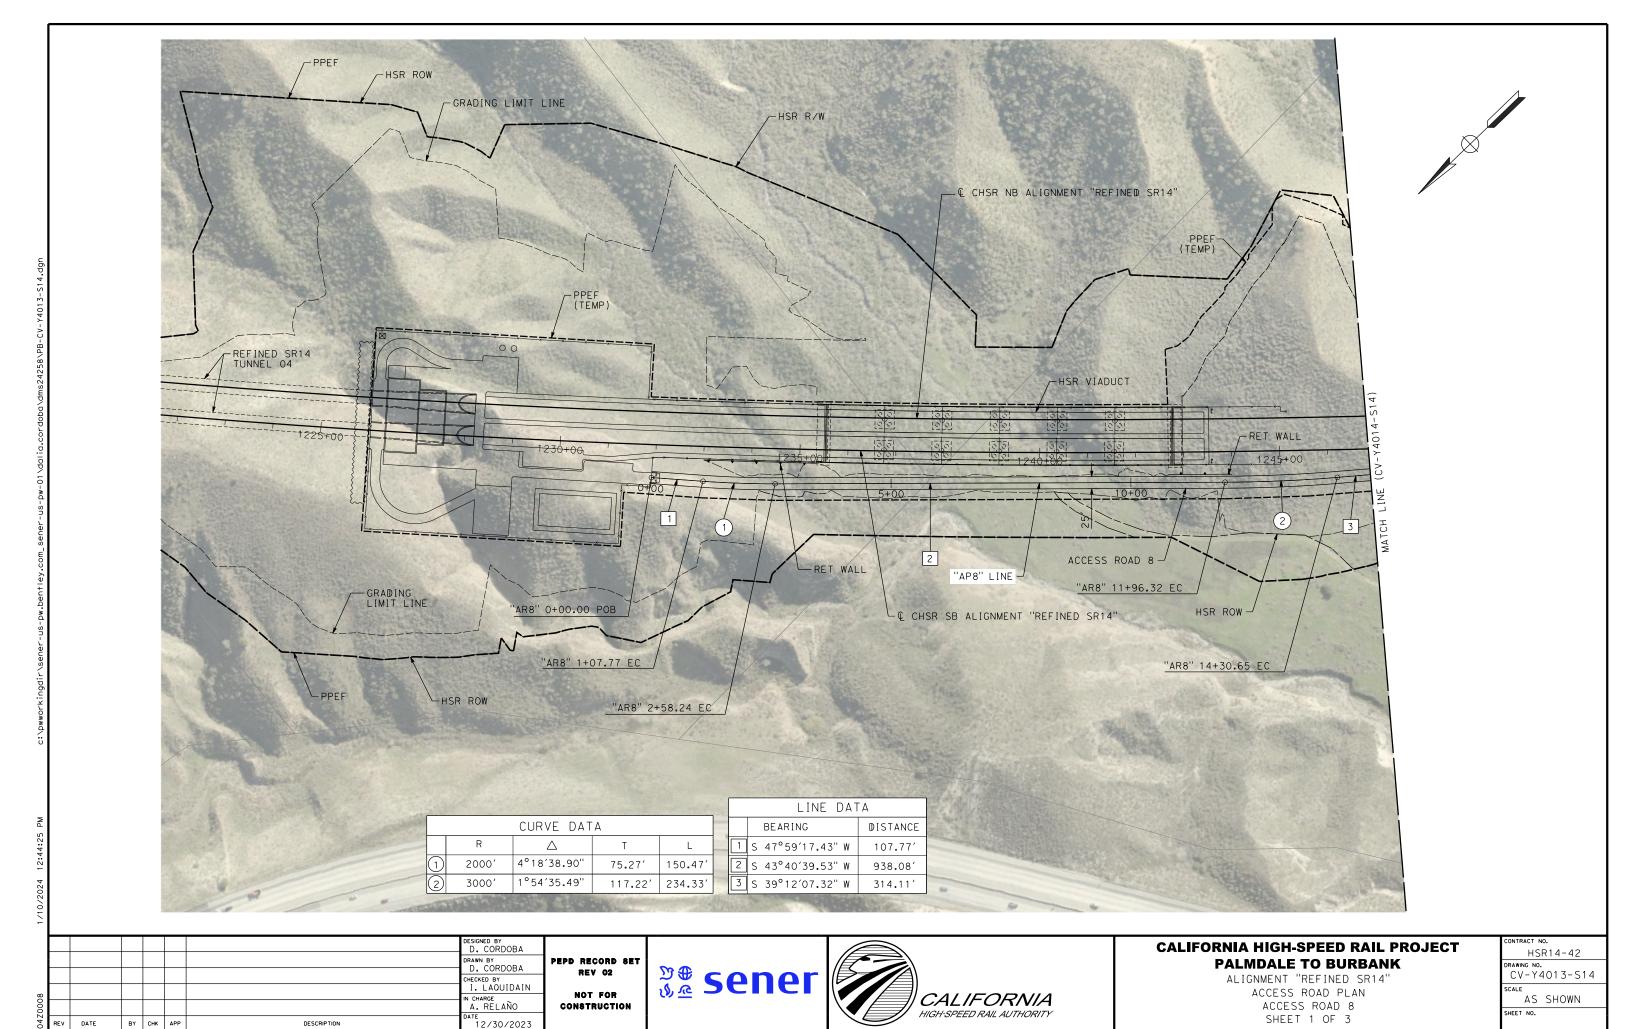

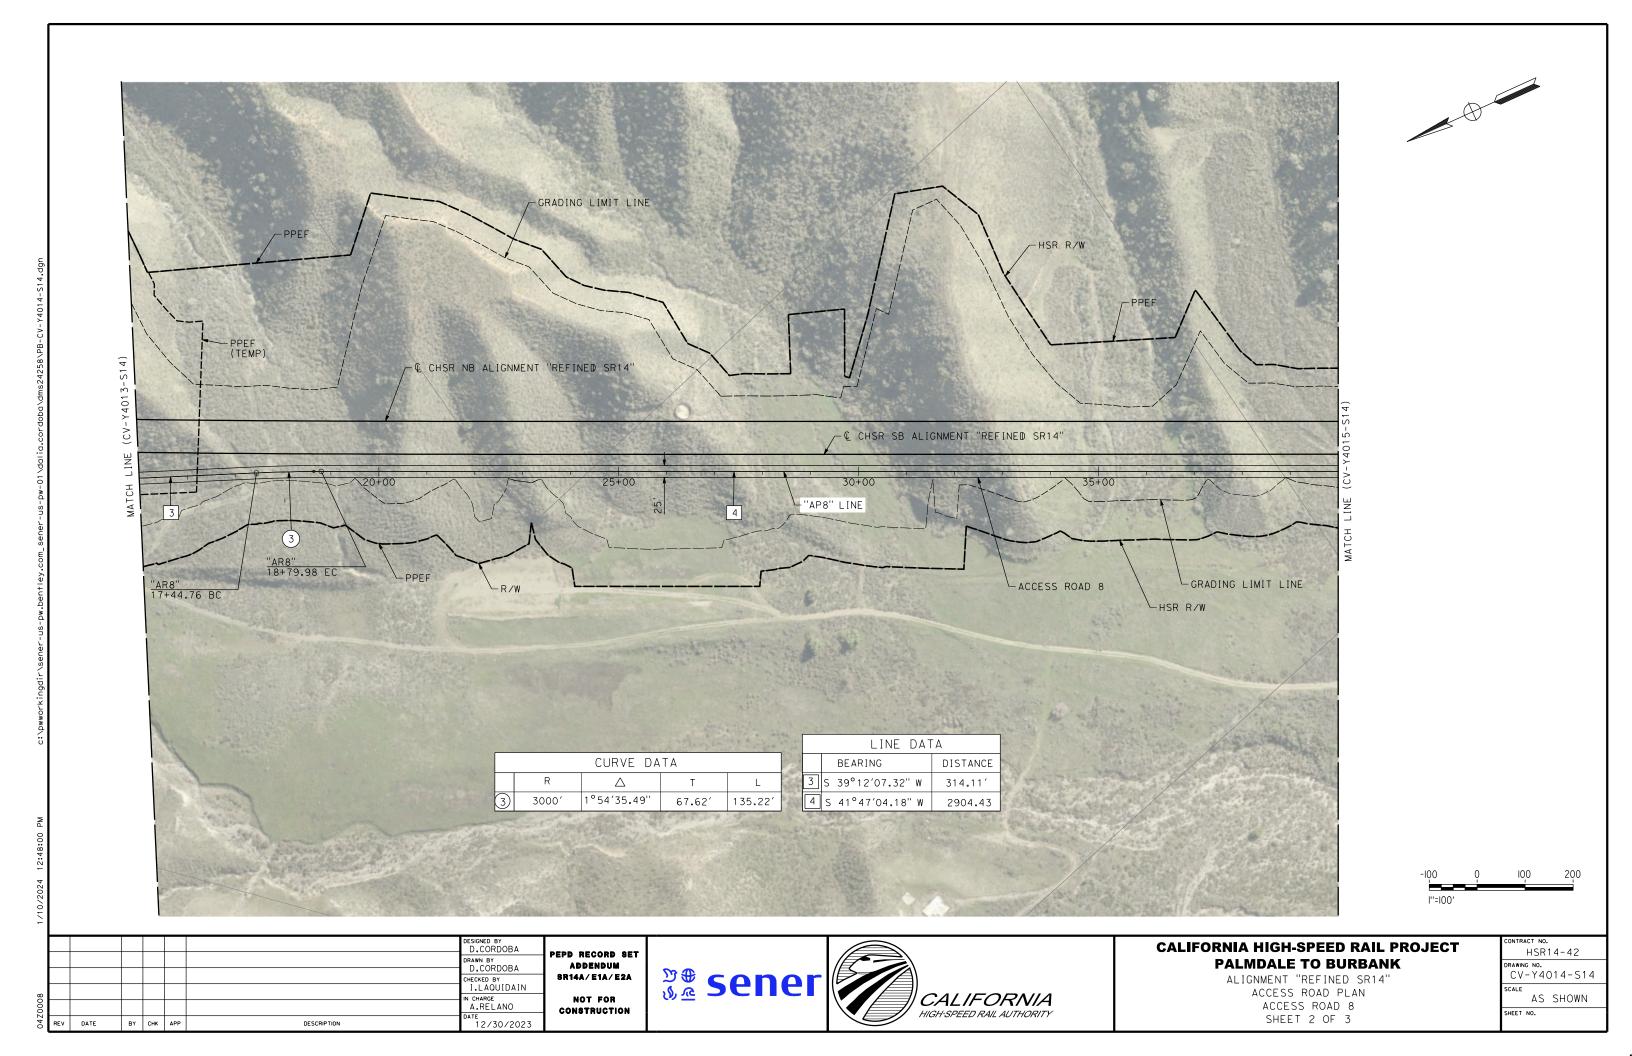

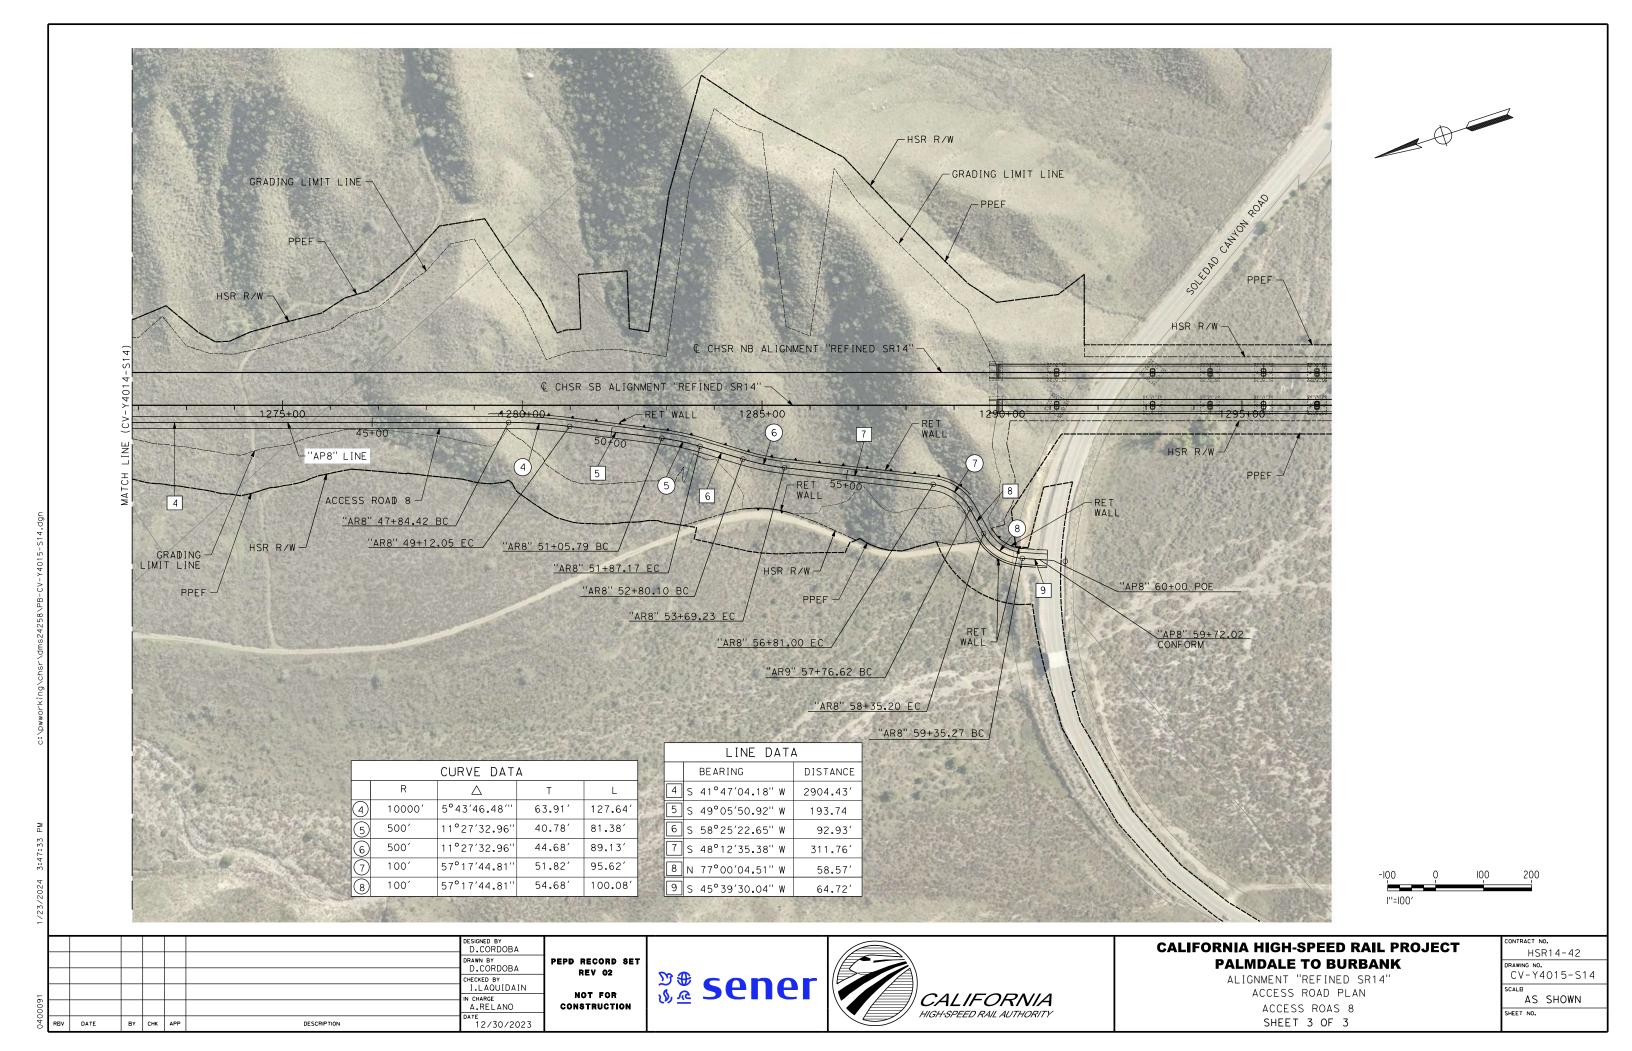

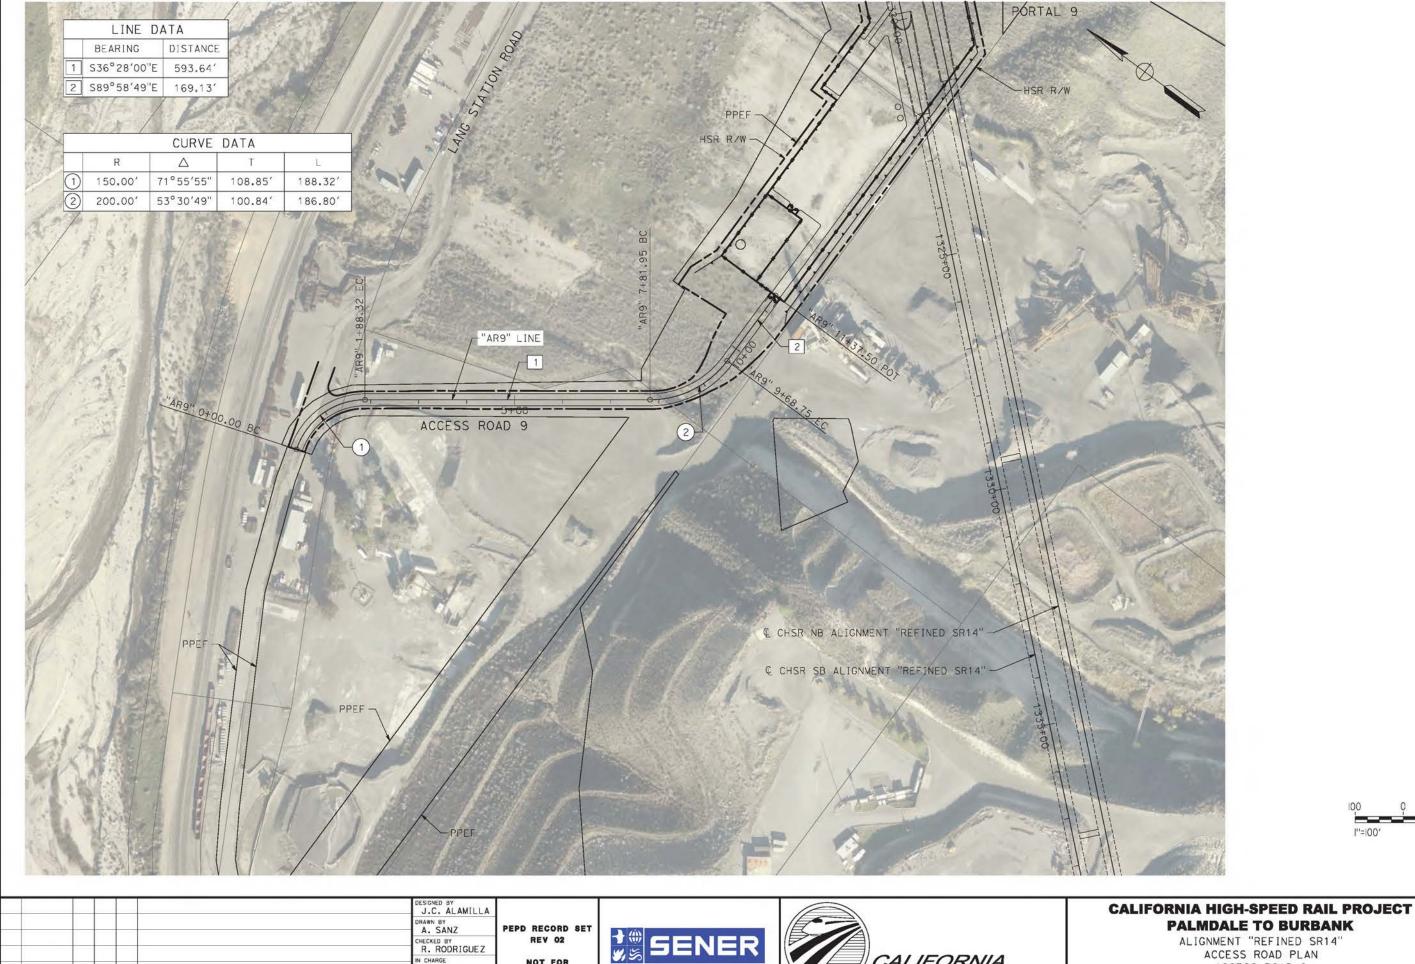

CALIFORNIA HIGH-SPEED RAIL AUTHORITY

R. RODRIGUEZ

04/30/2021

A. RELANO

BY CHK APP

DESCRIPTION

REV 02


NOT FOR


CONSTRUCTION


HSR14-42 CV-Y4016-S14 AS SHOWN


ACCESS ROAD 9


ALIGNMENT "REFINED SR14" ACCESS ROAD PLAN

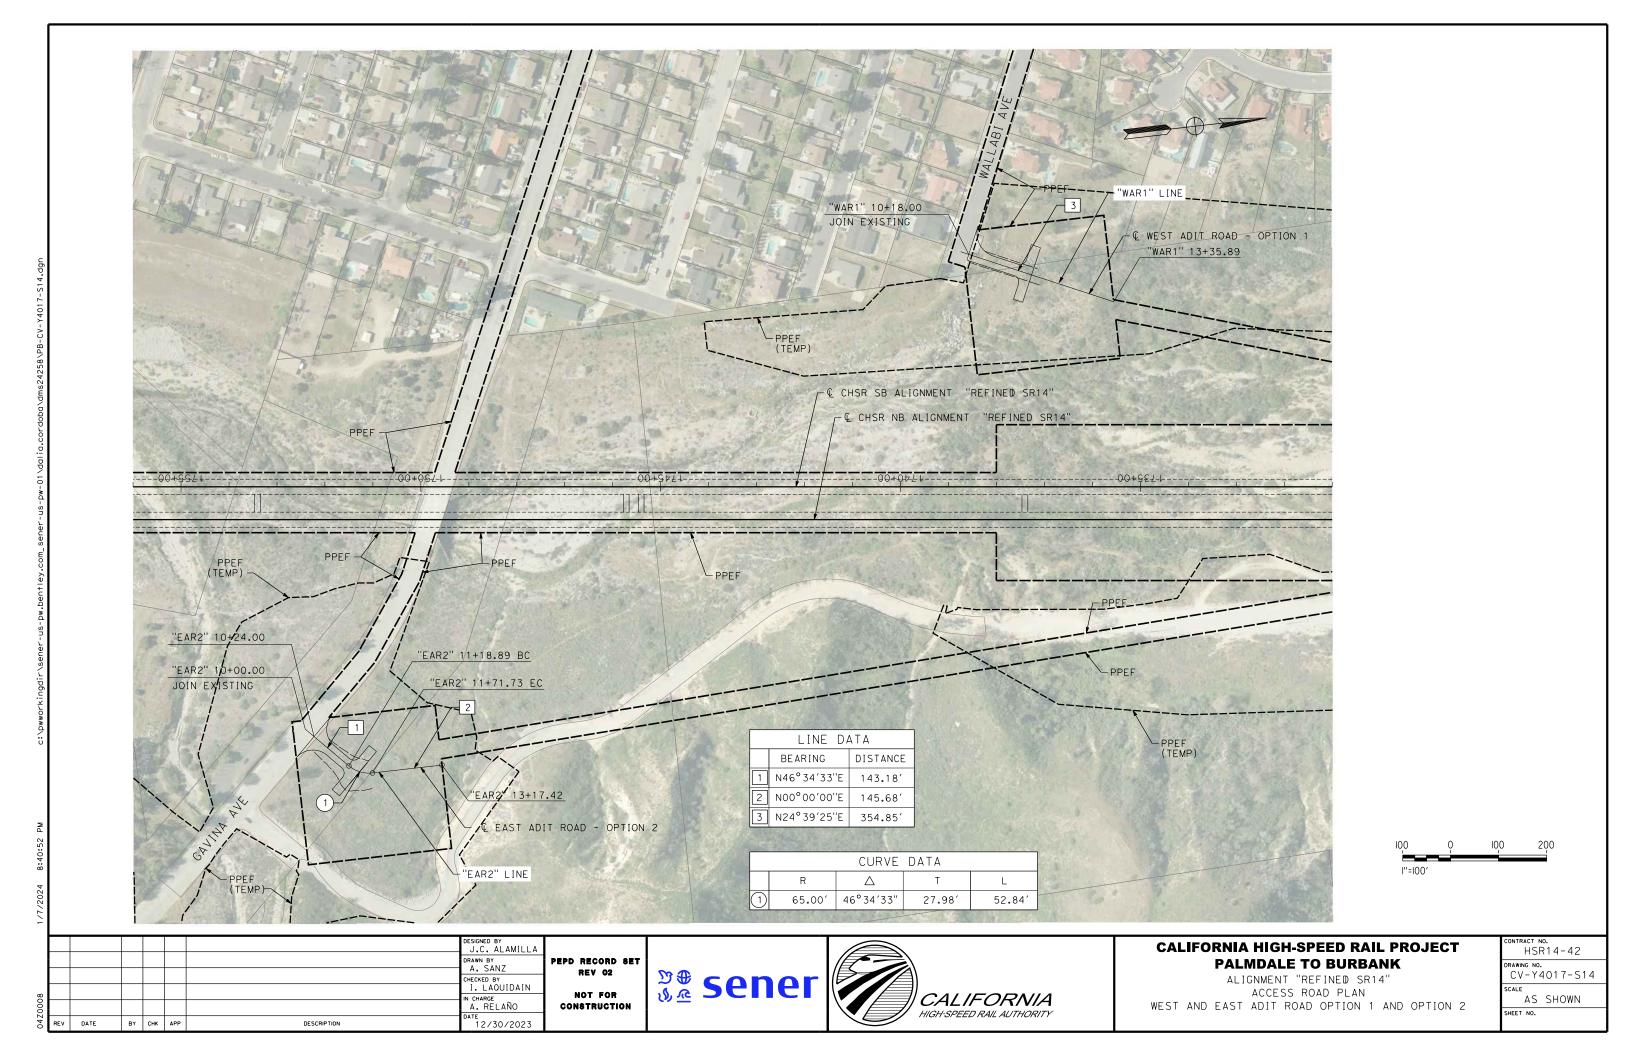


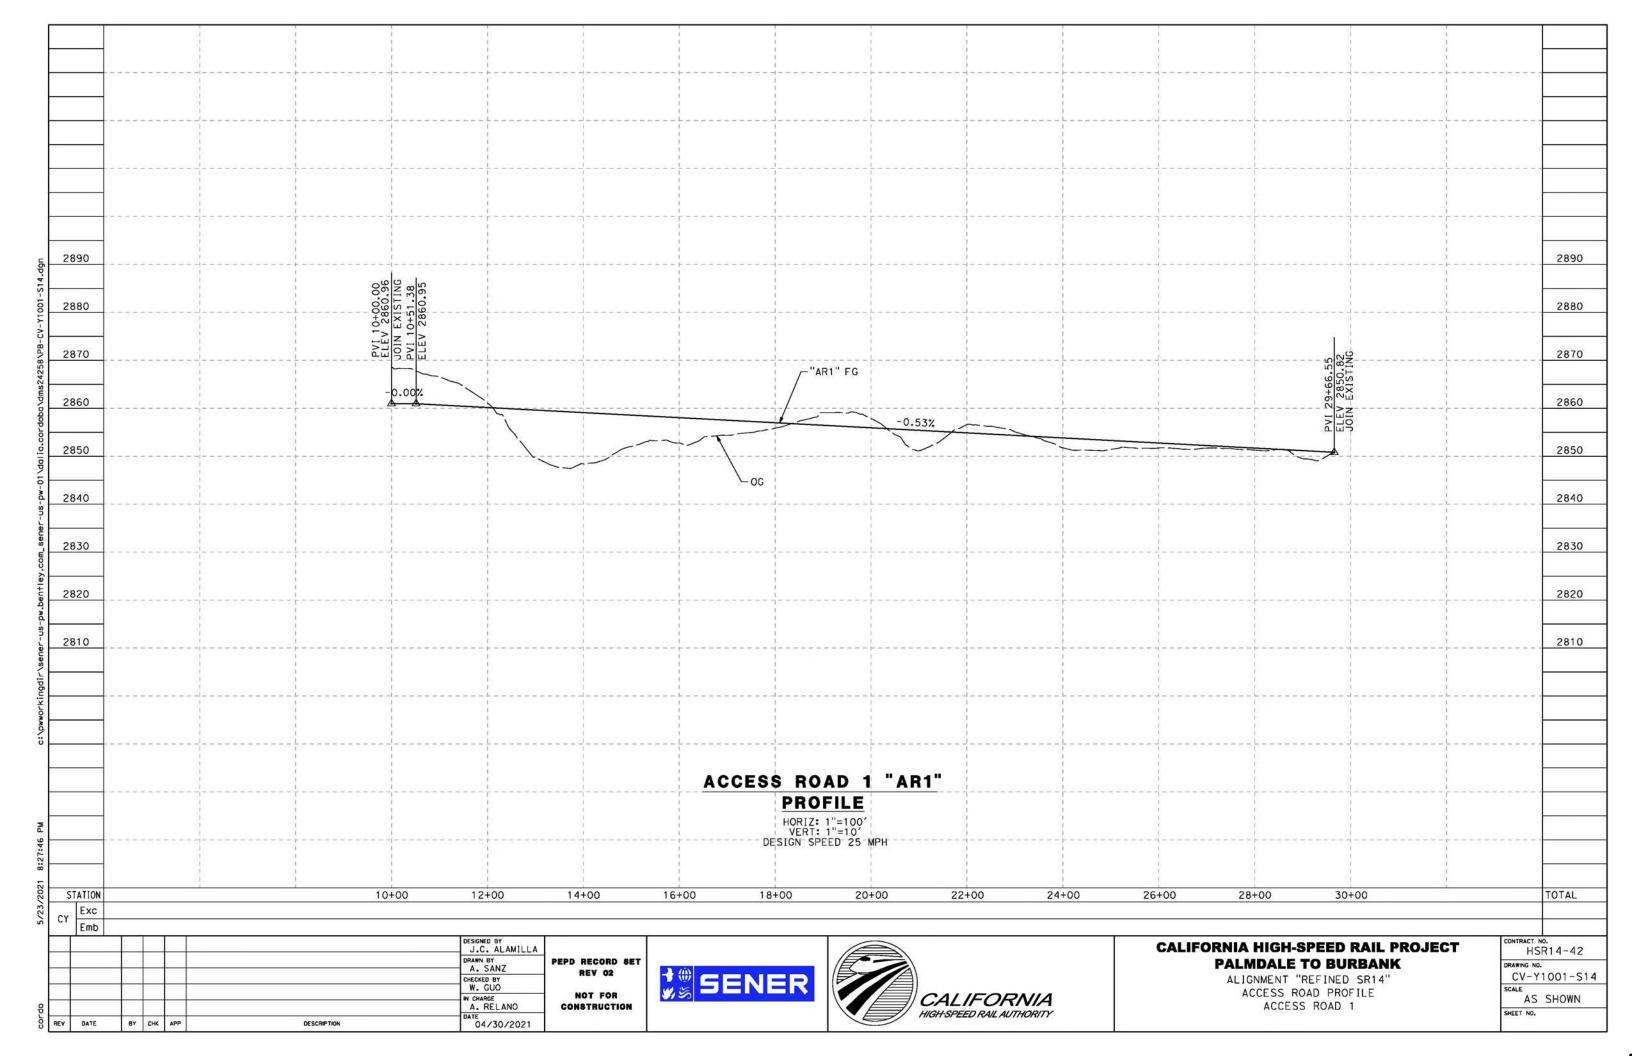


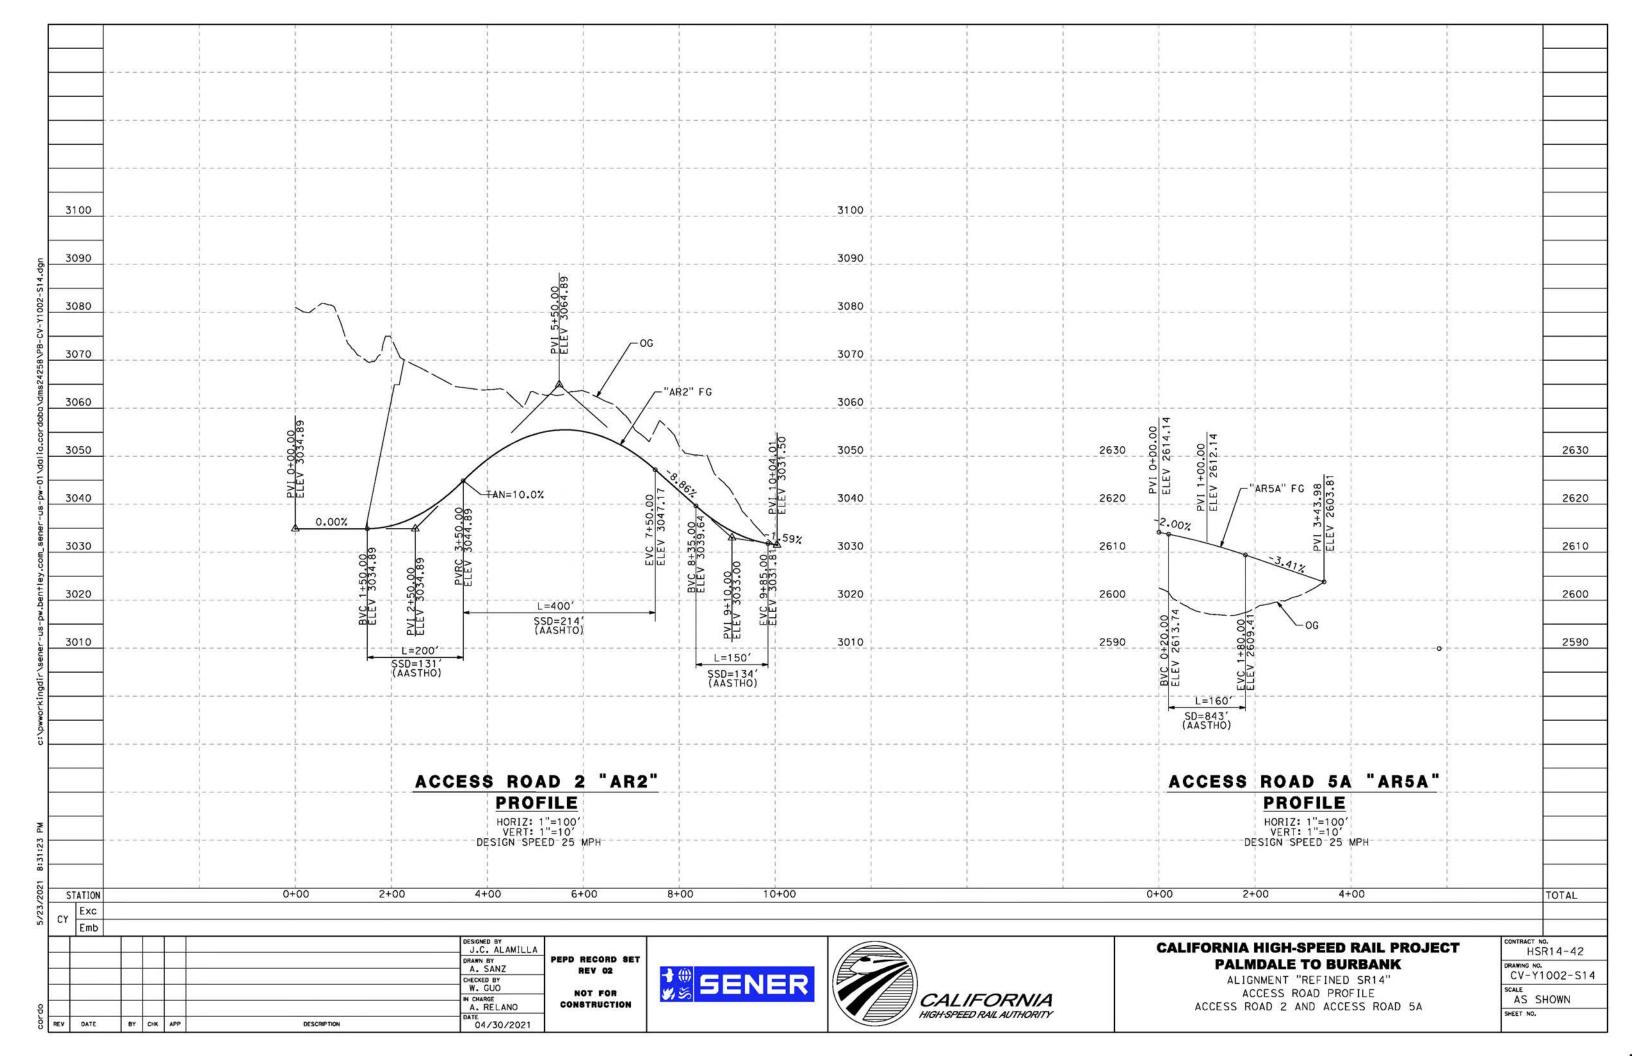


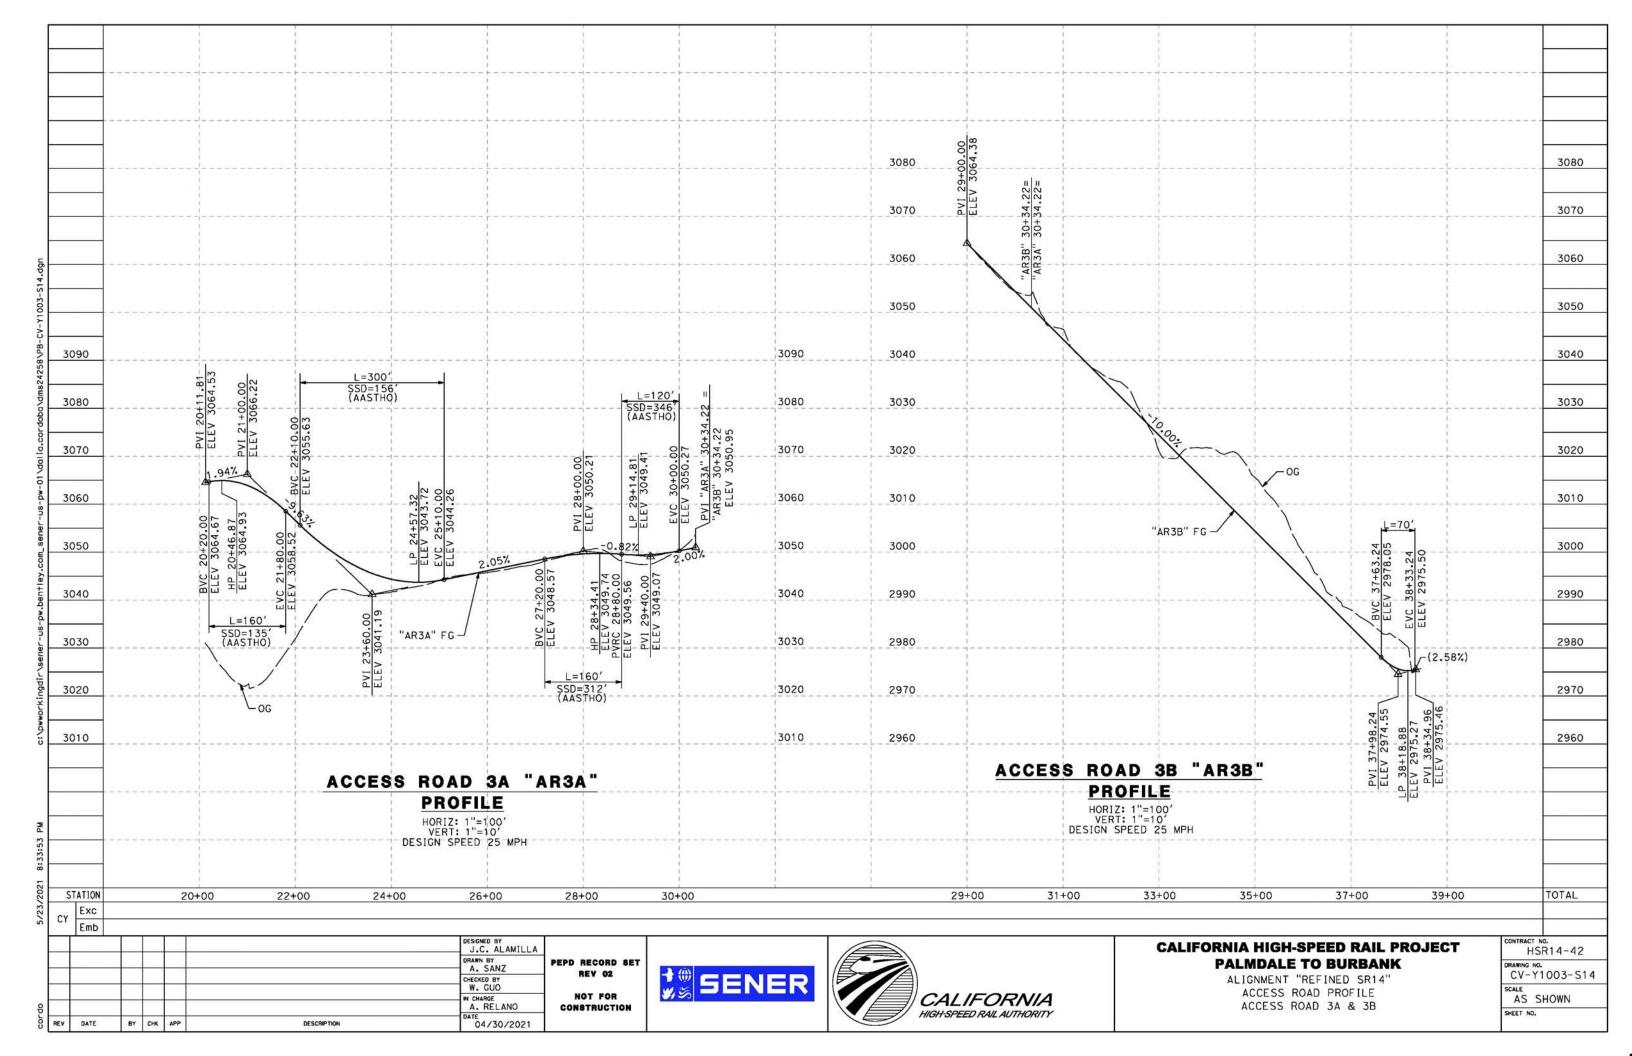


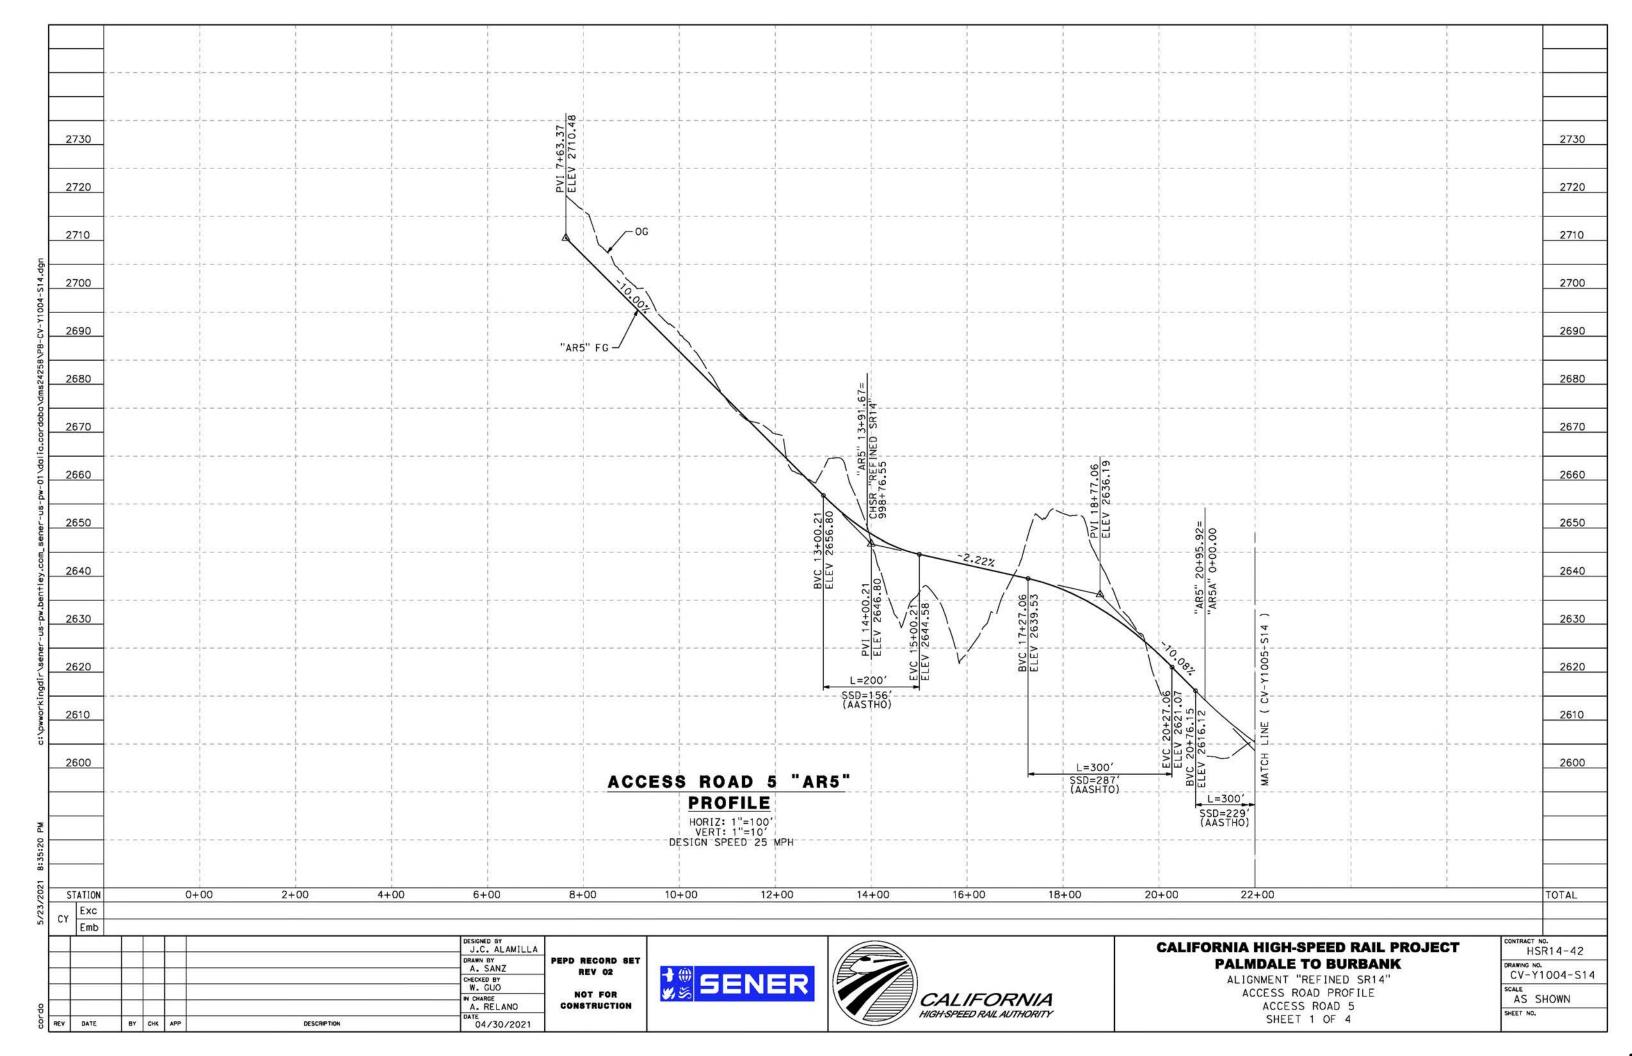


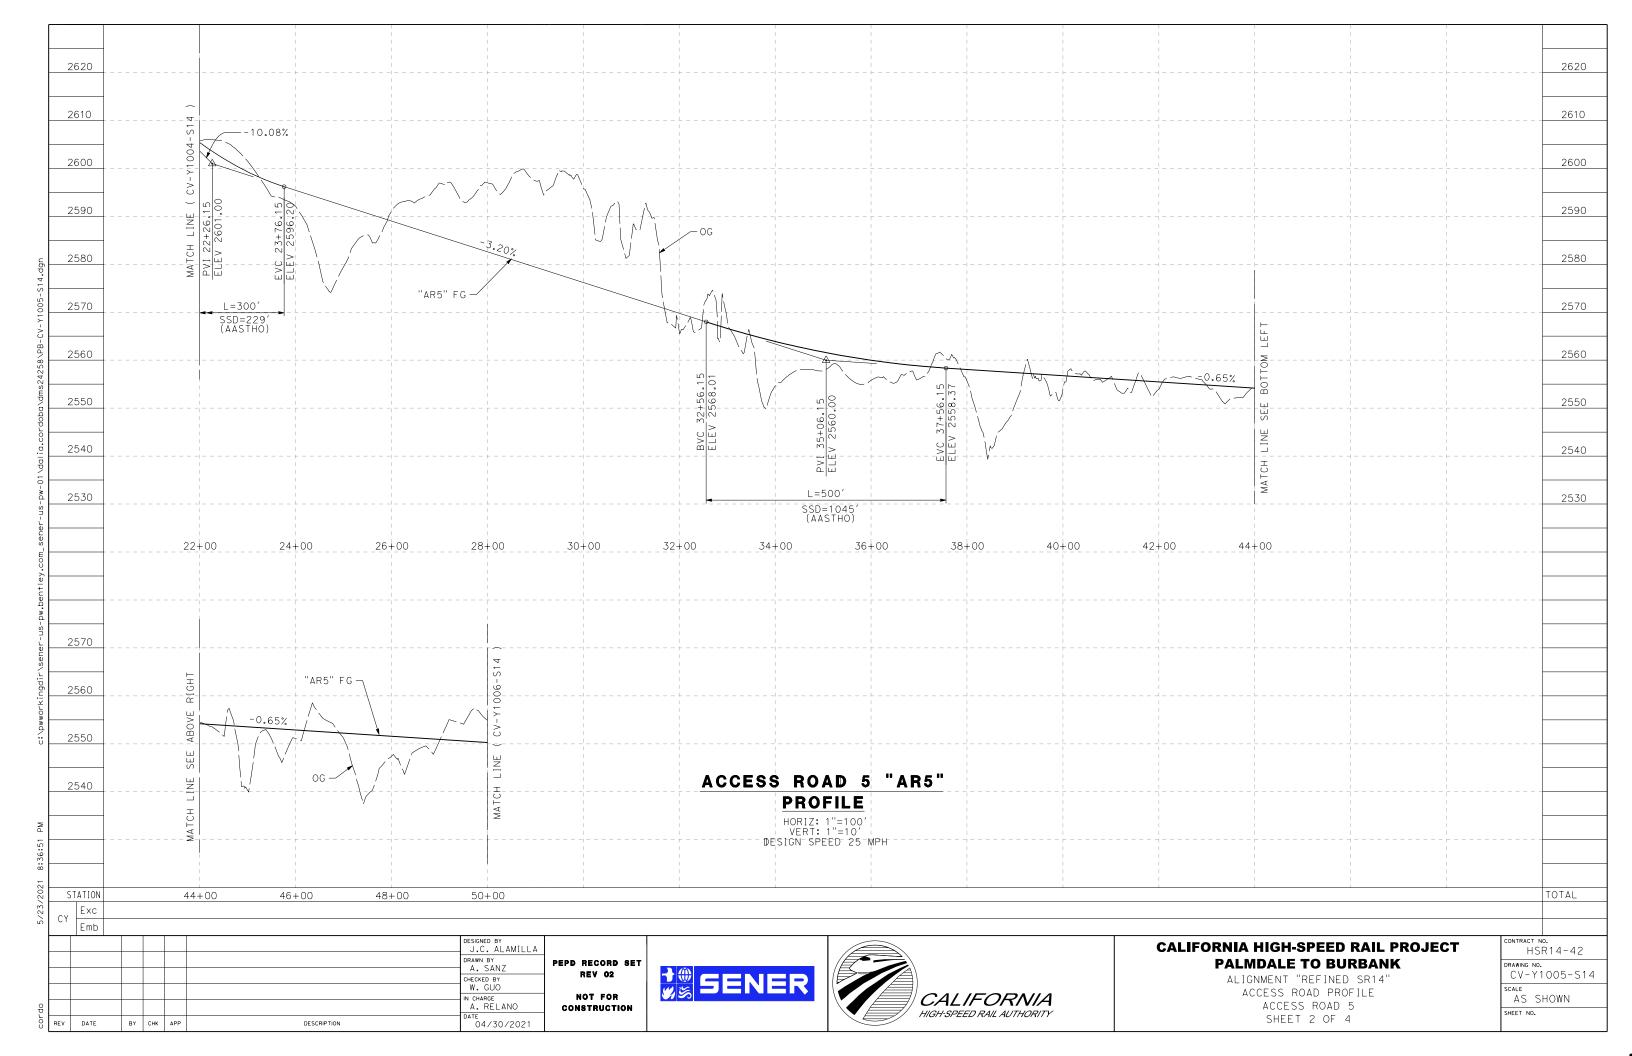


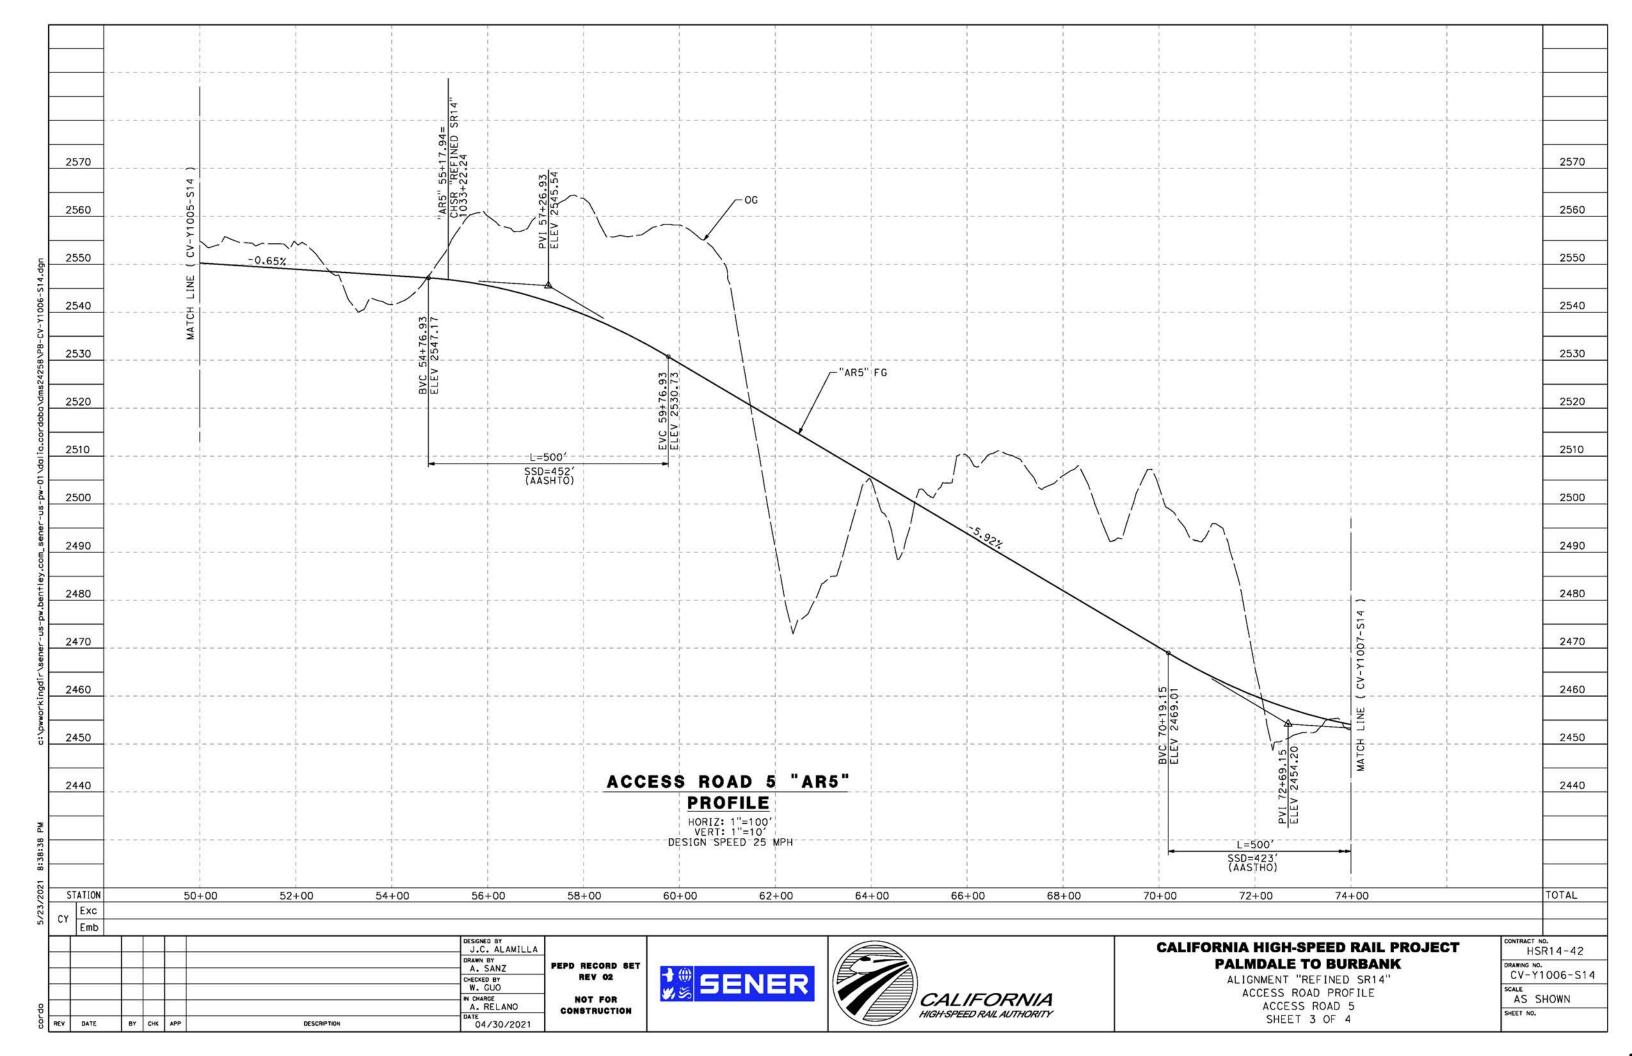


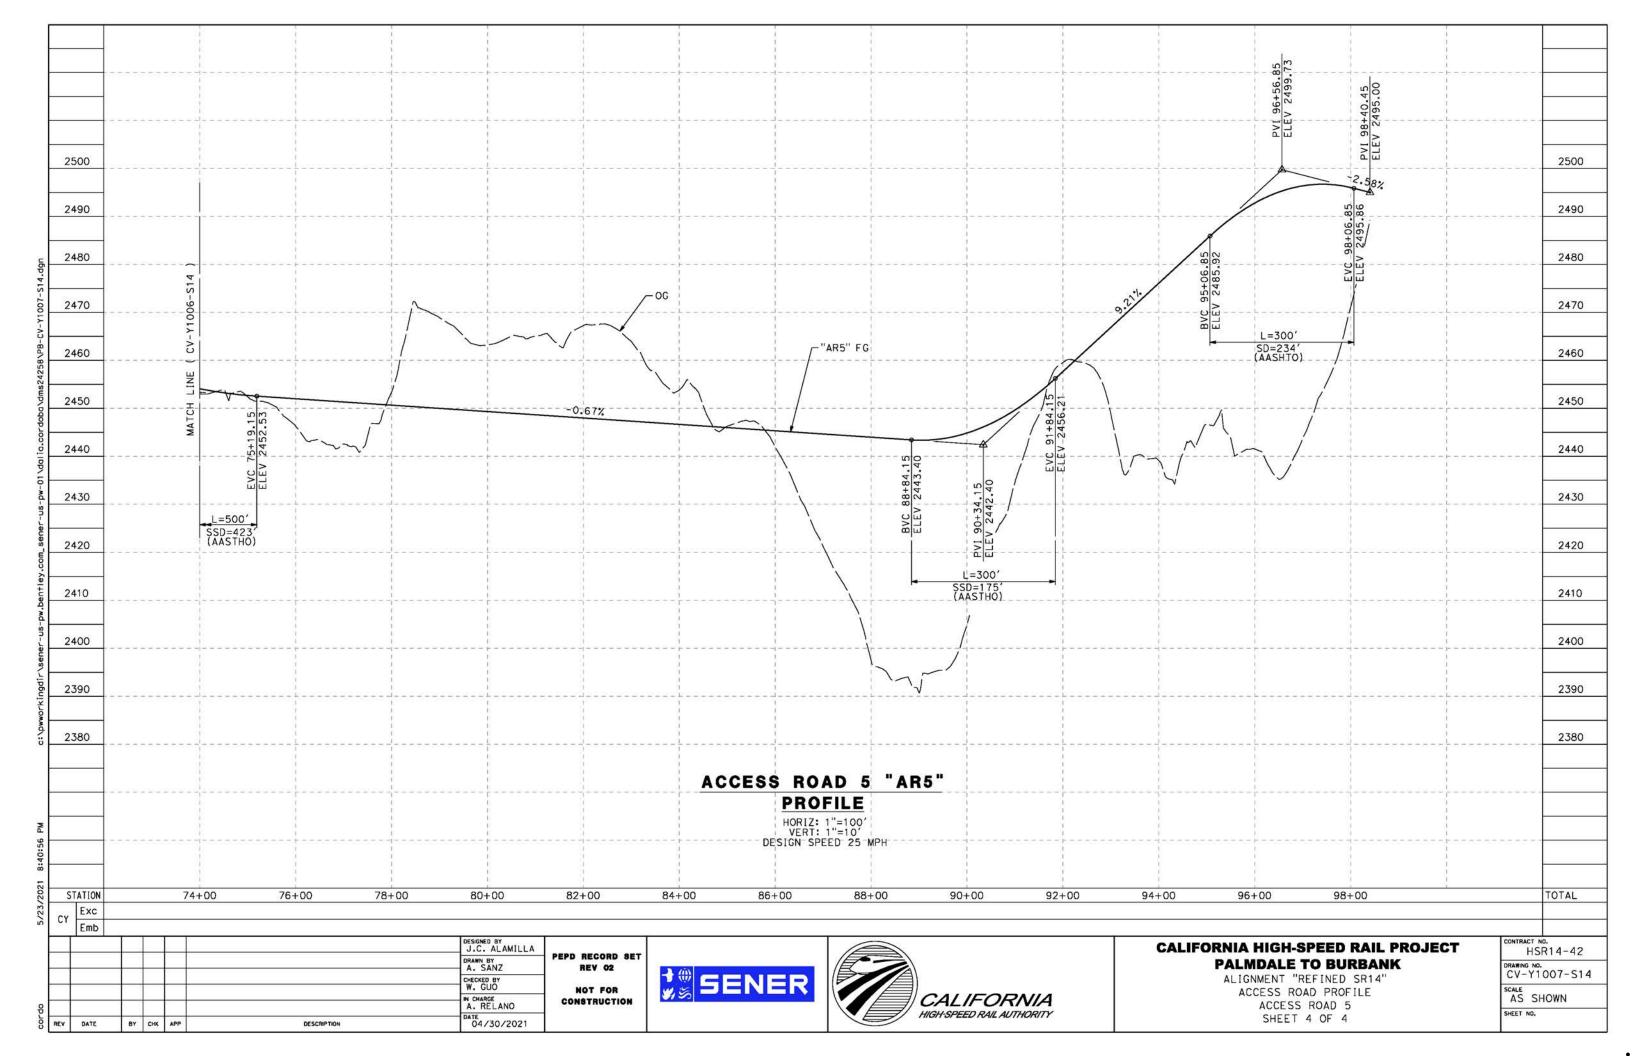


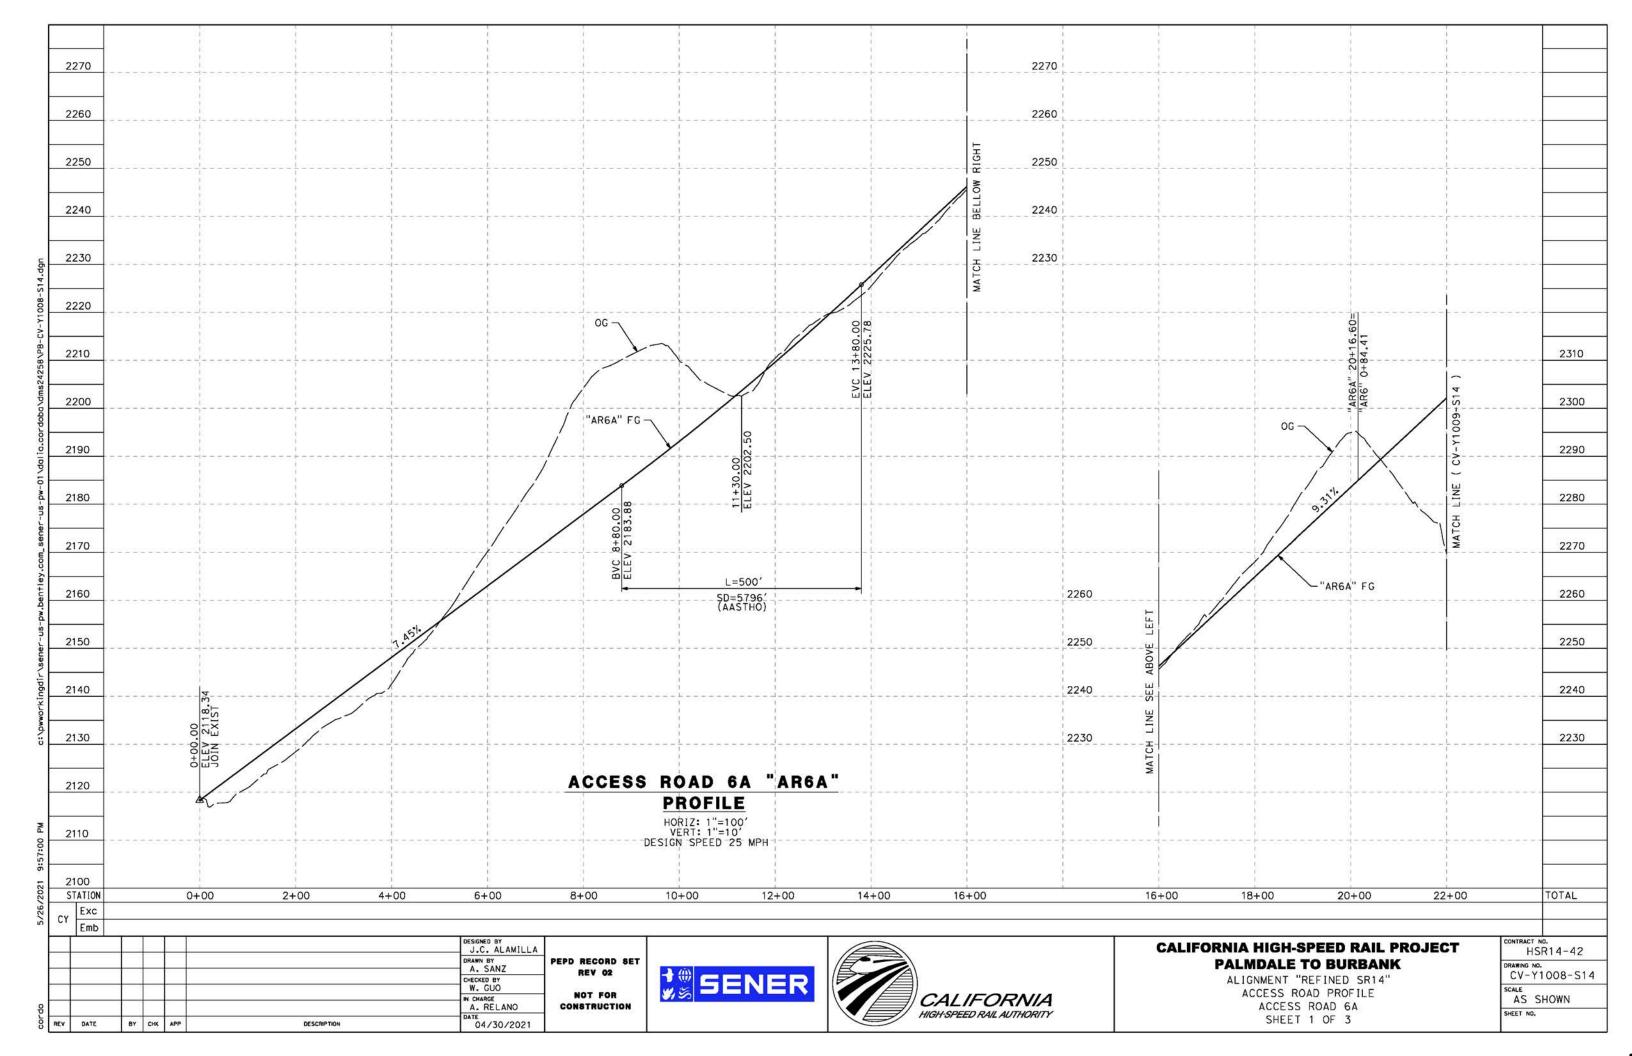


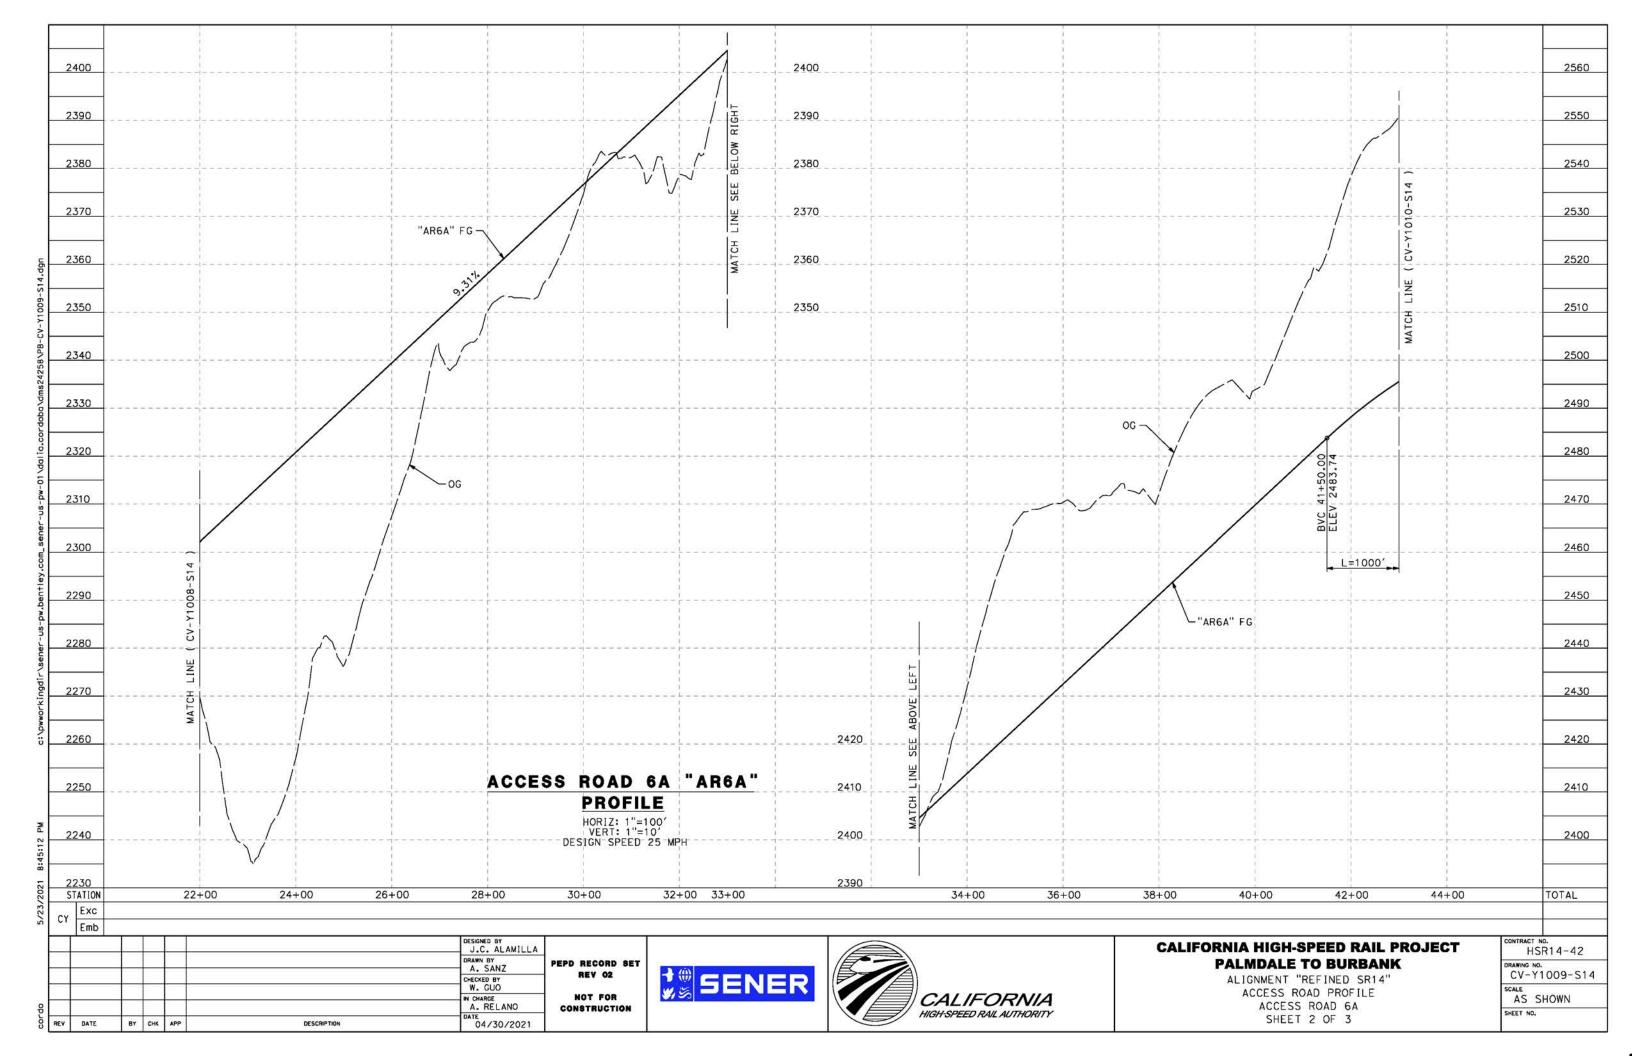


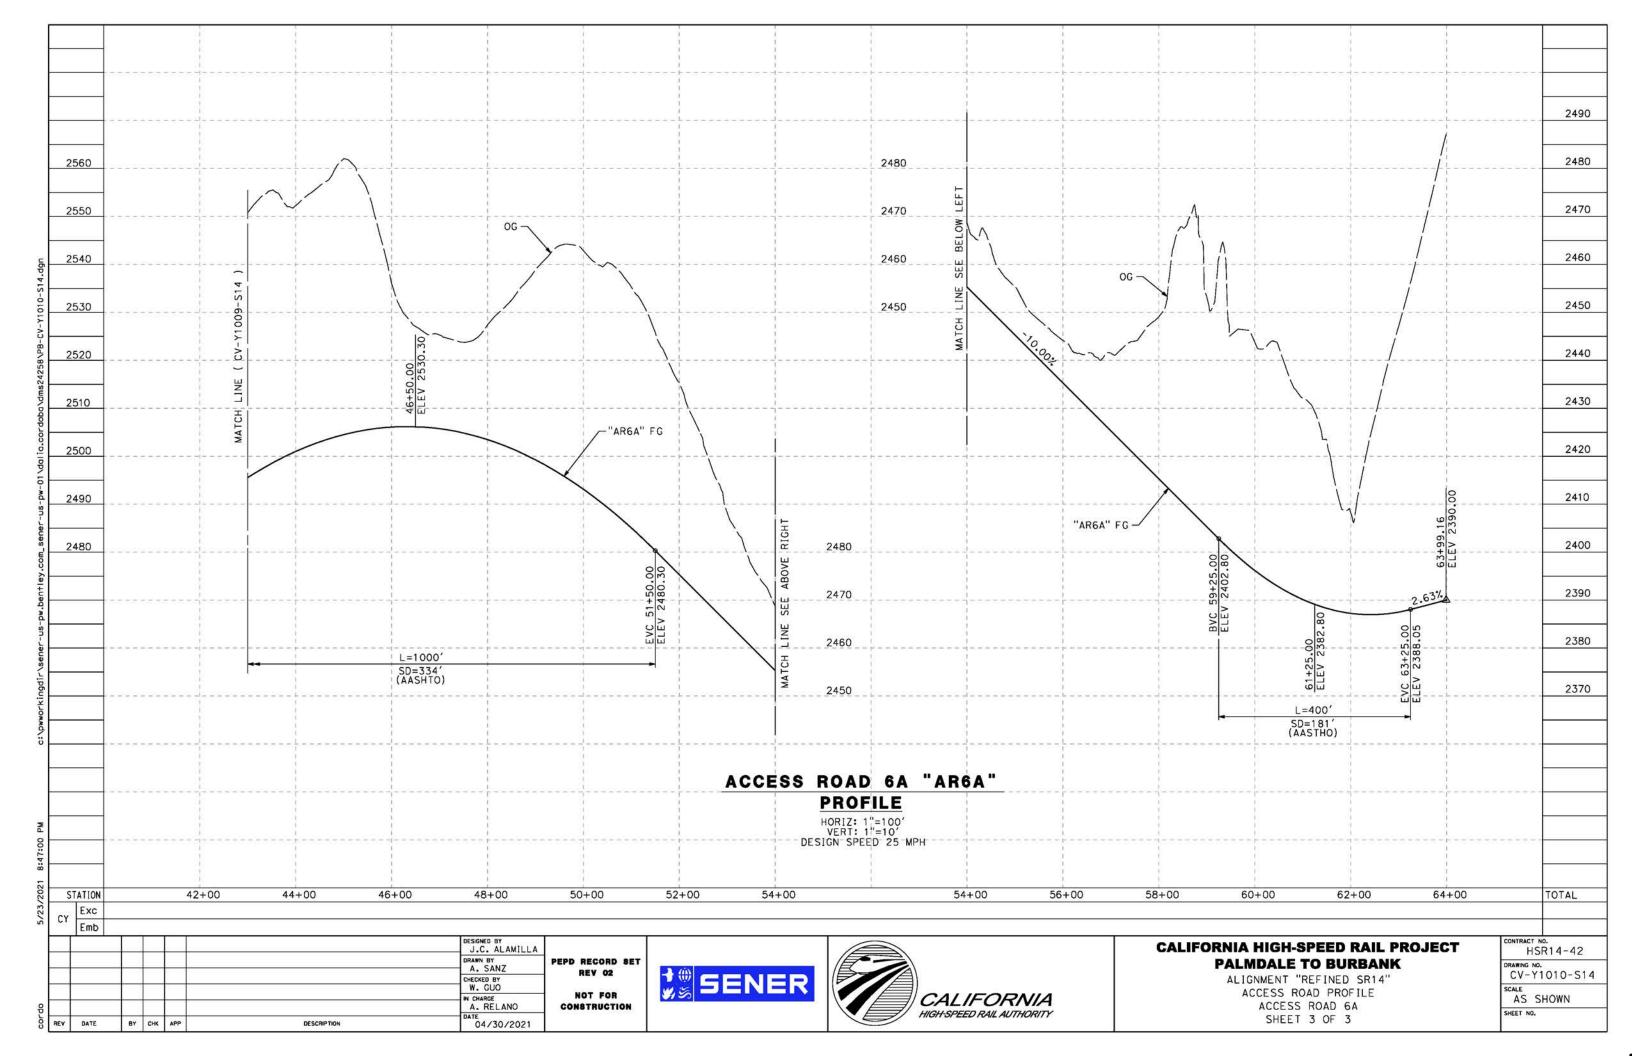


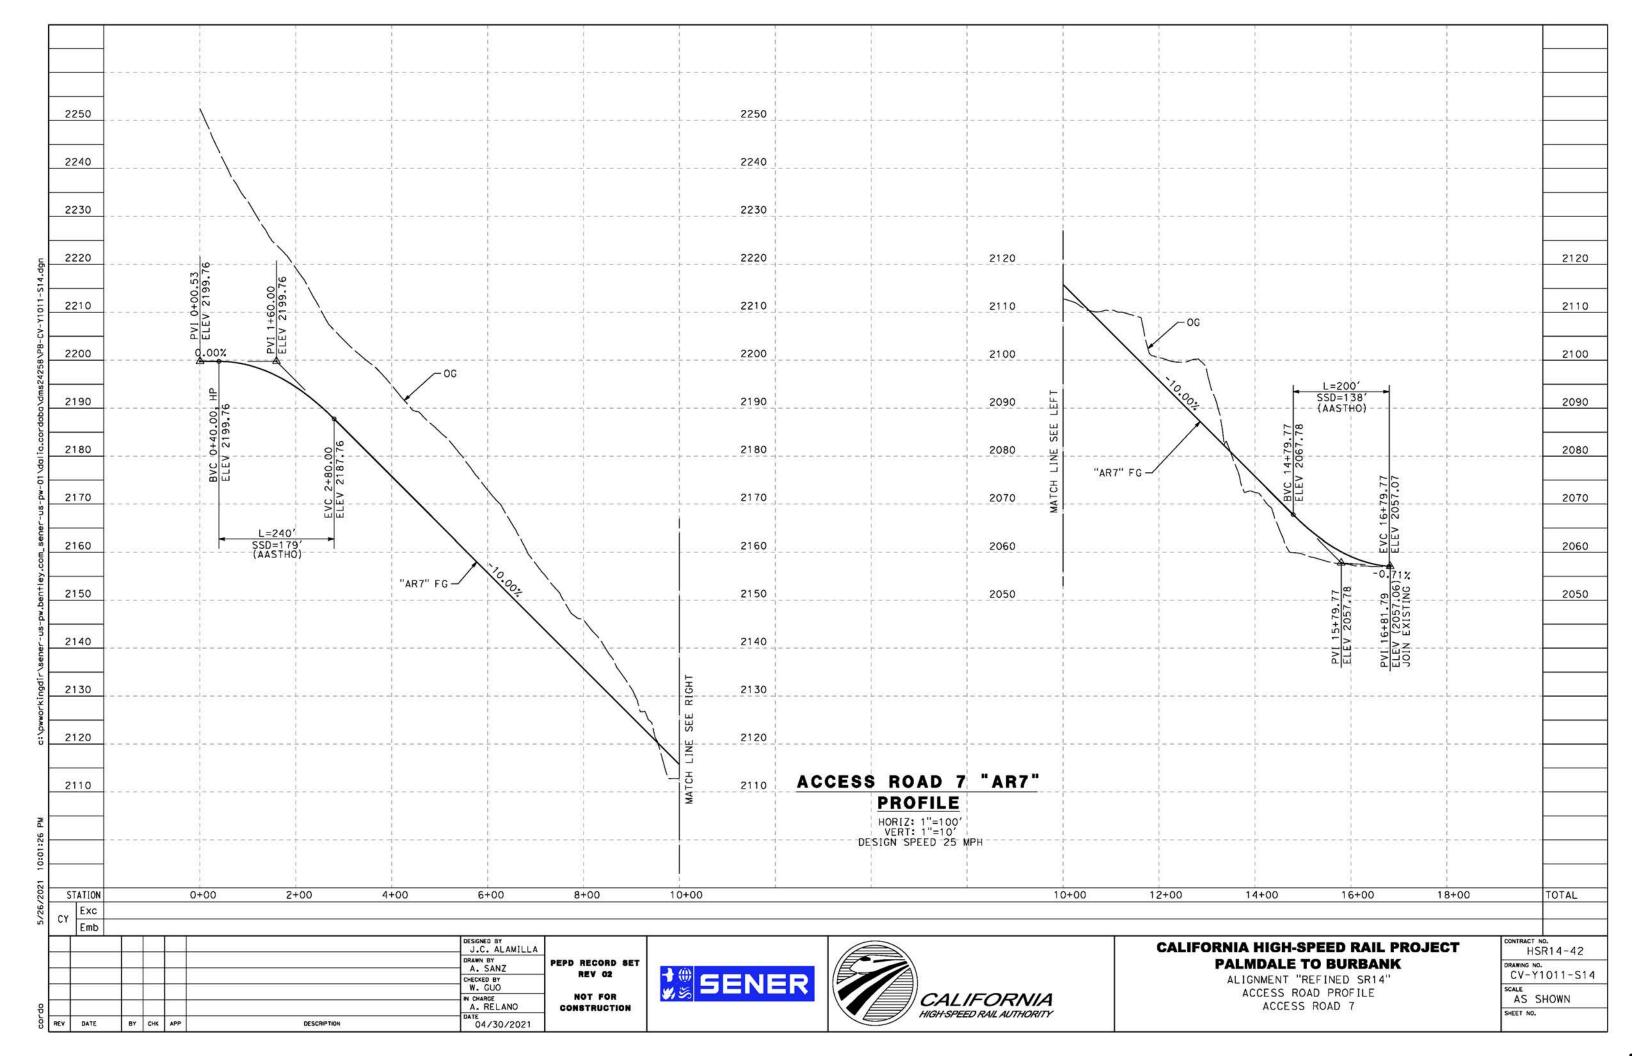


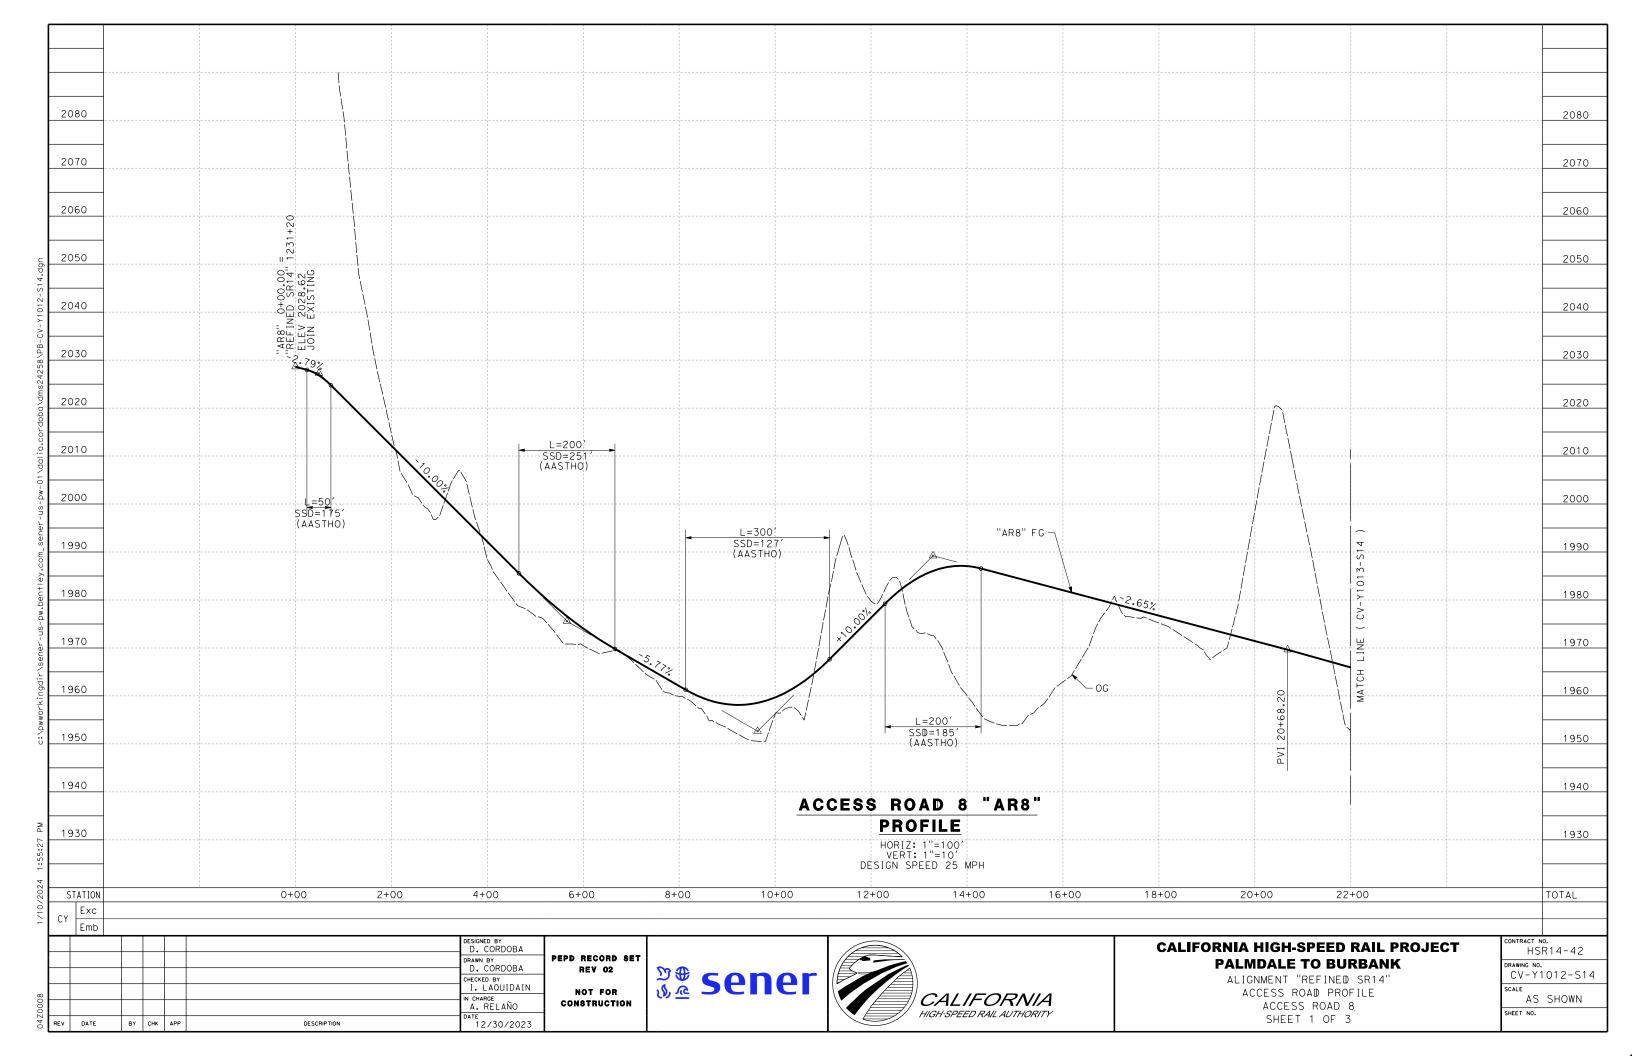


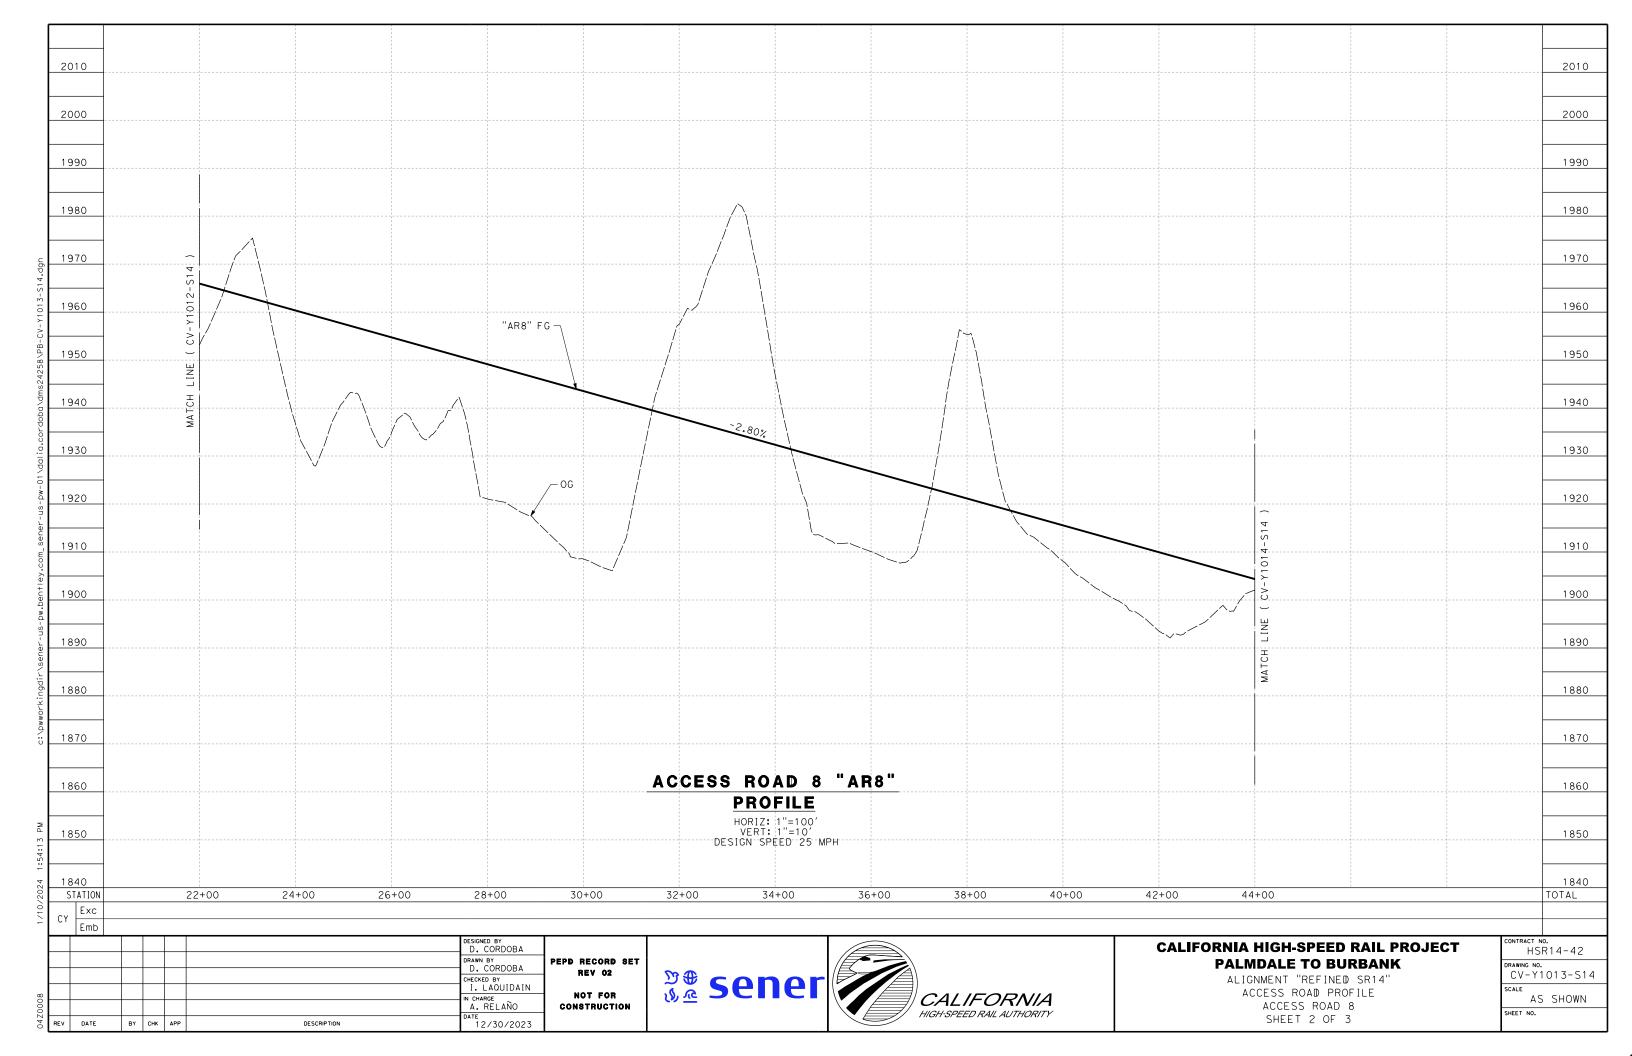

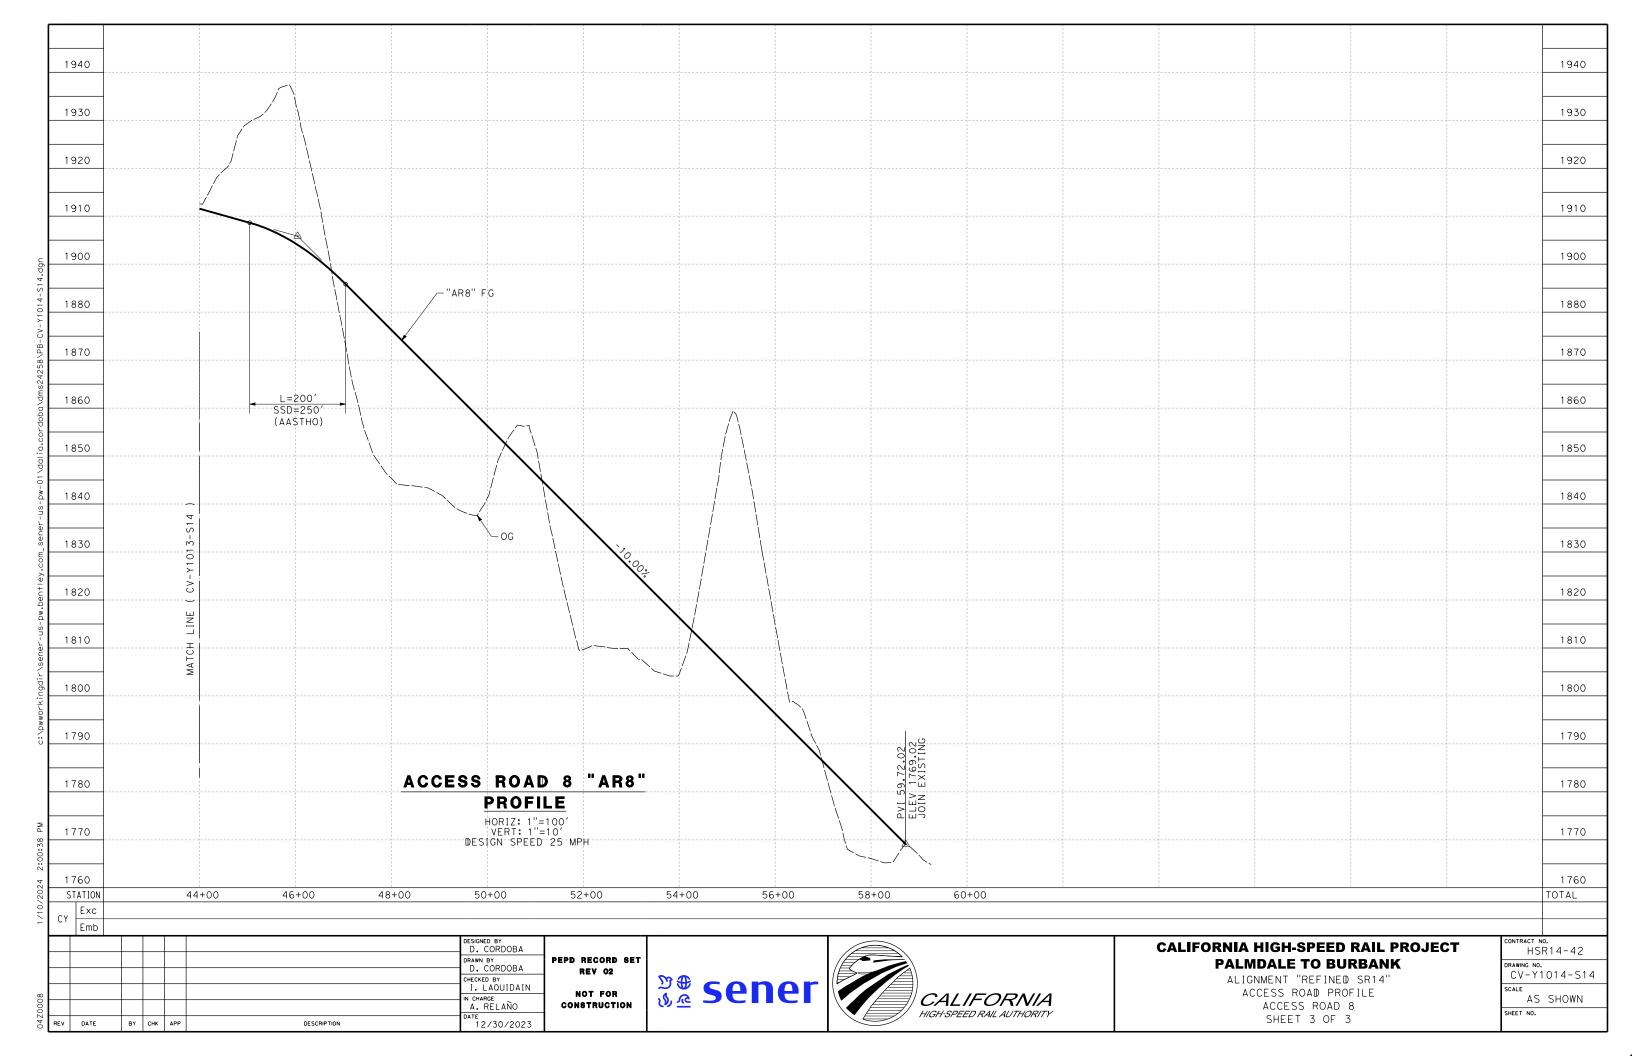


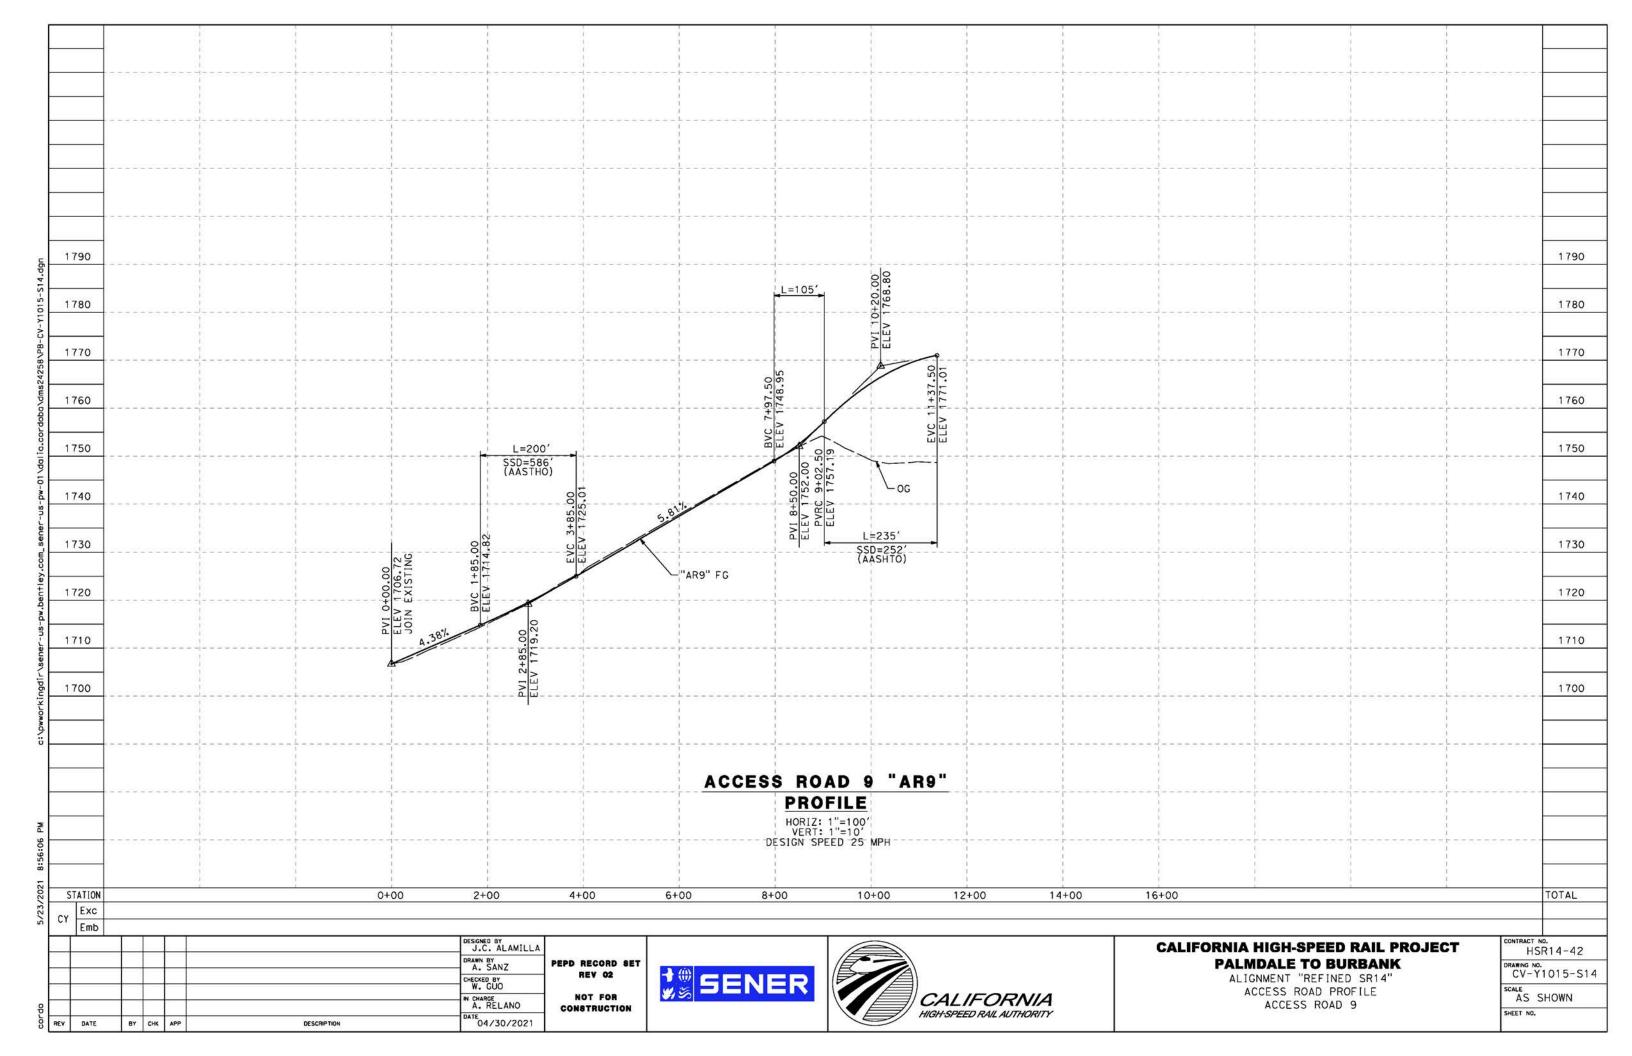


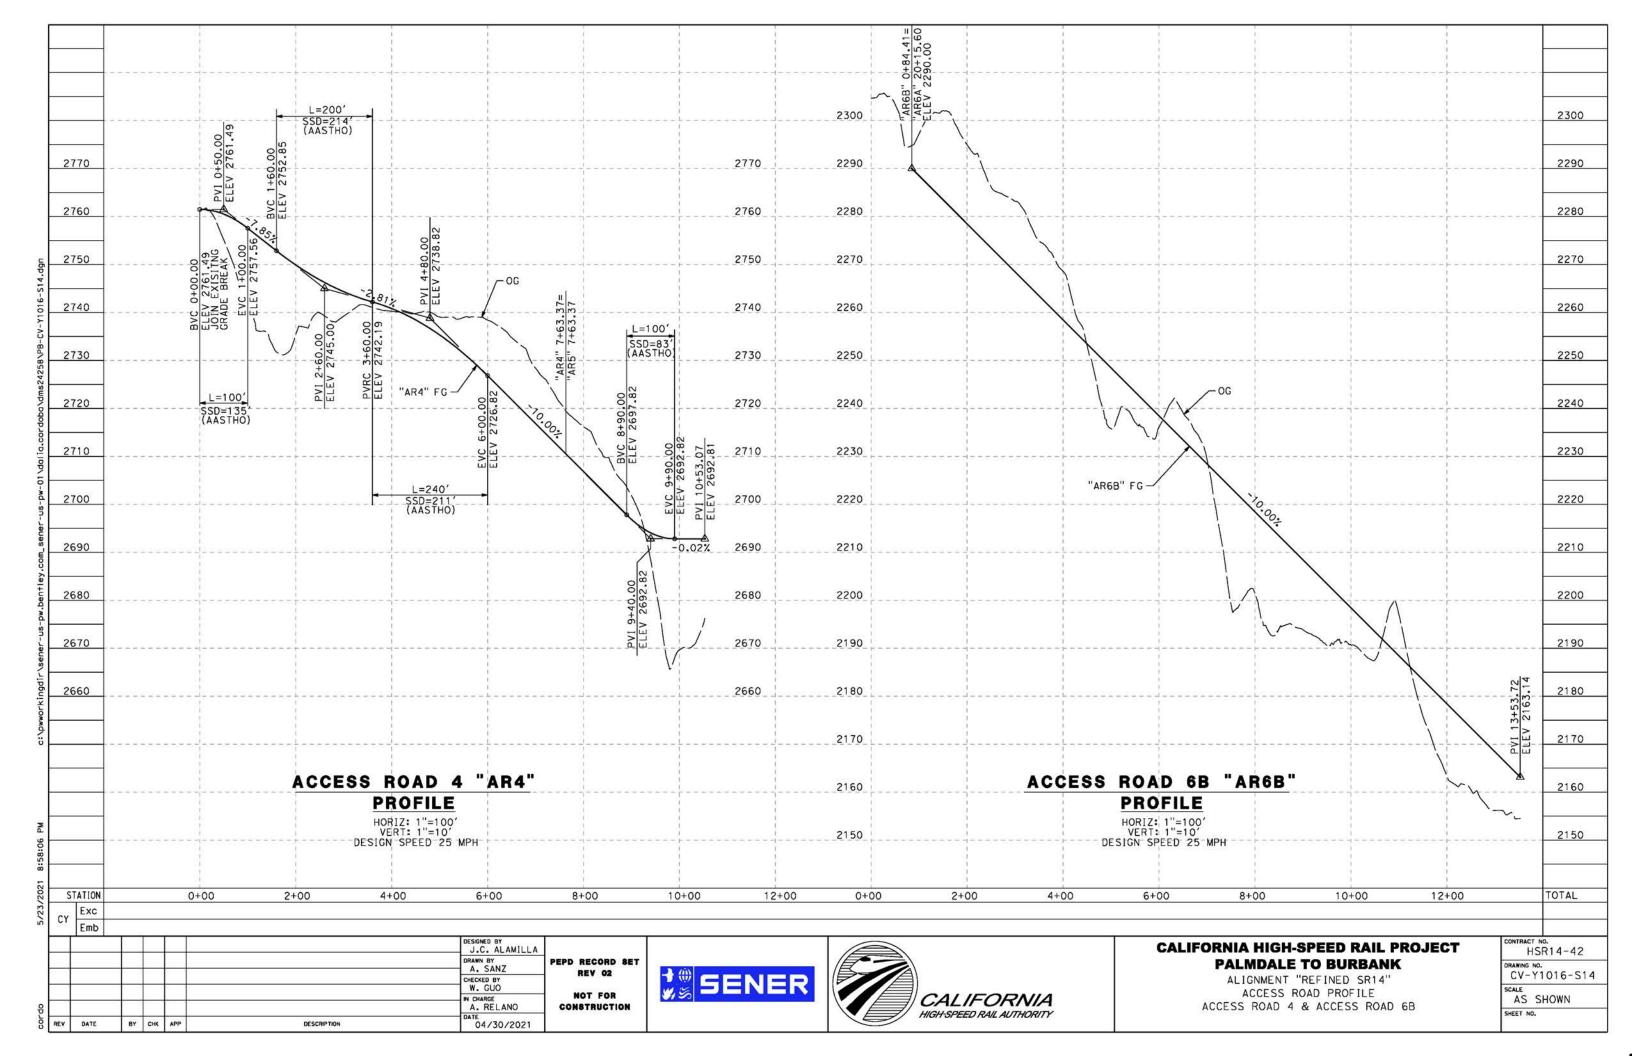


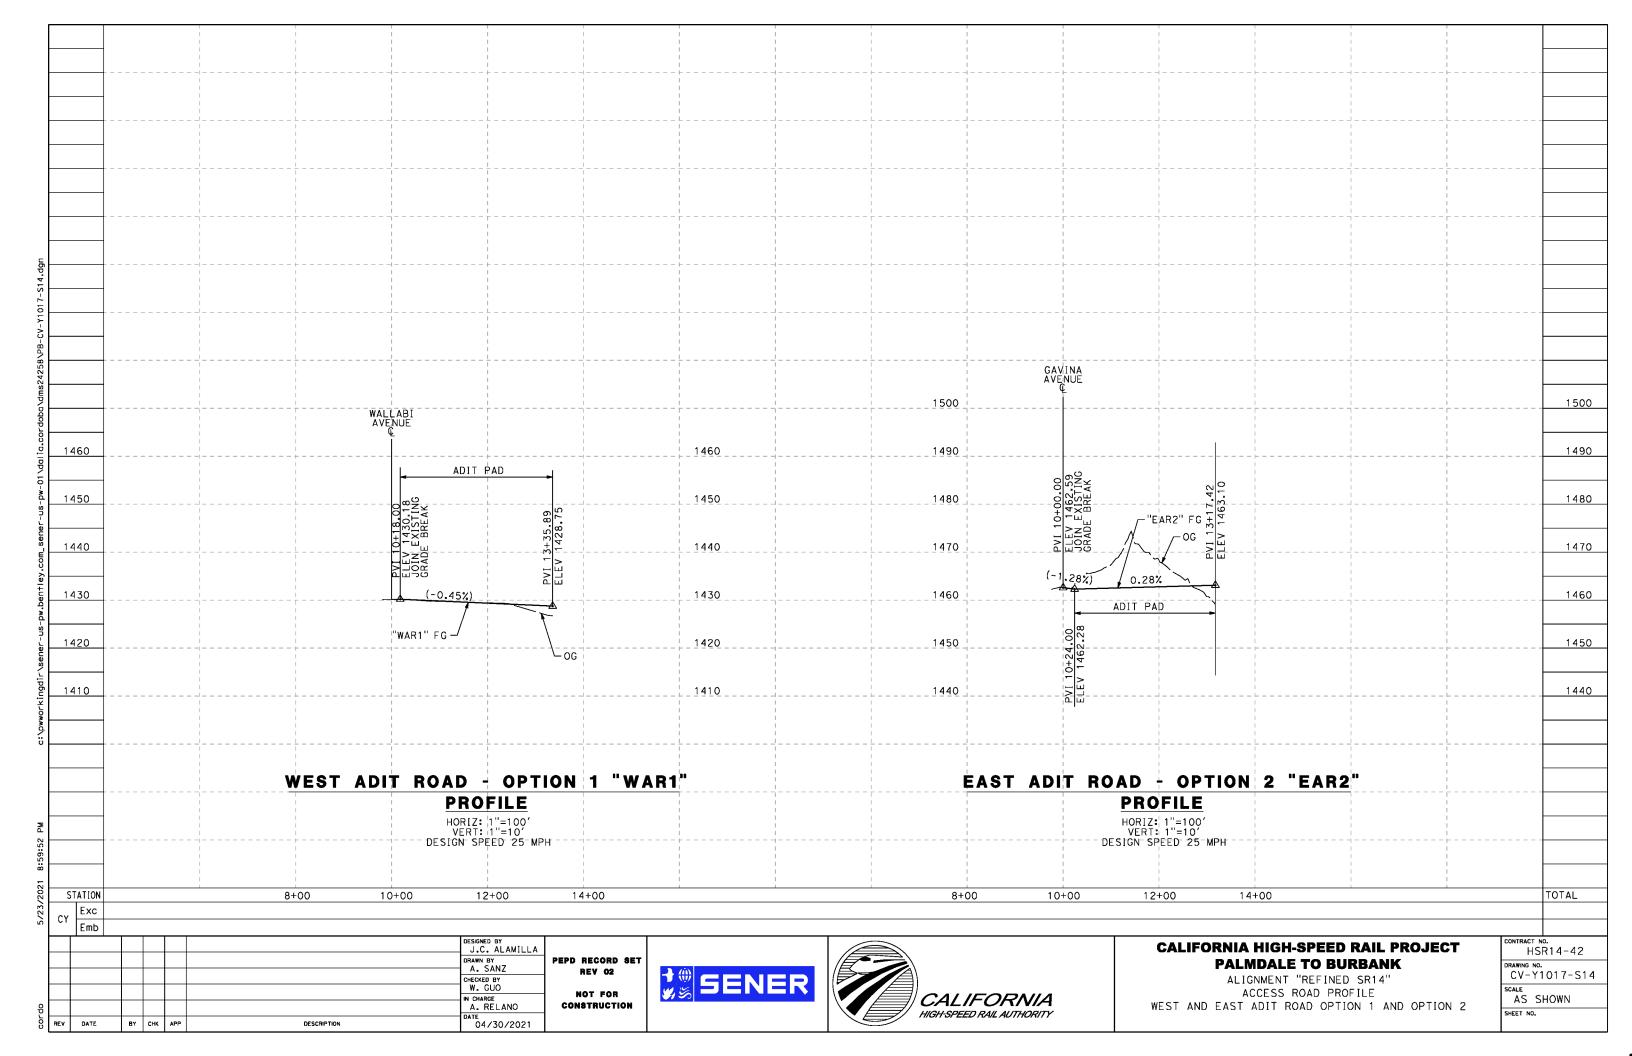




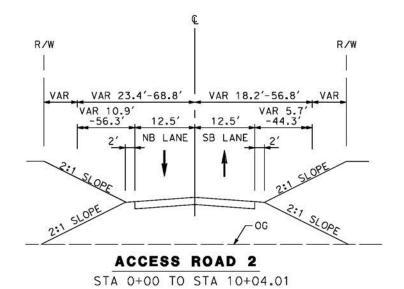

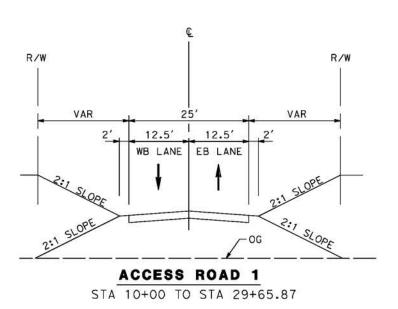

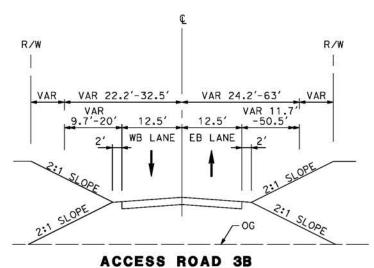

STA 29+00 TO STA 38+34.96

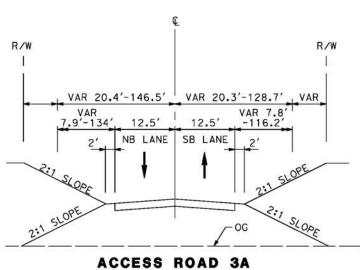

STA 20+12.81 TO STA 30+34.22

						DESIGNED BY J.C. ALAMILLA	
						DRAWN BY A. SANZ	PE
-		+				CHECKED BY W. GUO	
						IN CHARGE A. RELANO	
REV	DATE	BY	СНК	APP	DESCRIPTION	DATE 04/30/2021	

PEPD RECORD SET REV 02 NOT FOR CONSTRUCTION





CALIFORNIA HIGH-SPEED RAIL PROJECT PALMDALE TO BURBANK


ALIGNMENT "REFINED SR14"
TYPICAL SECTIONS
ACCESS ROAD 1, 2, 3A AND 3B


HSR14-42					
DRAWING CV-	NO. Y3001-S14				
SCALE	SCALE				
SHEET N					



BY CHK APP

DESCRIPTION

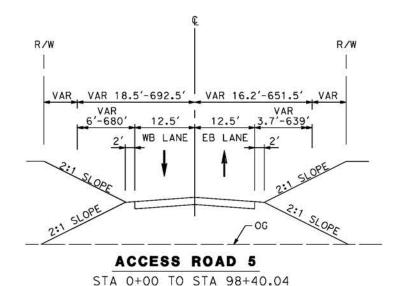

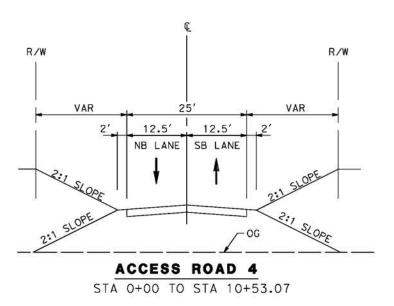


J.C. ALAMILLA

DRAWN BY A. SANZ


W. GUO

A. RELANO

04/30/2021

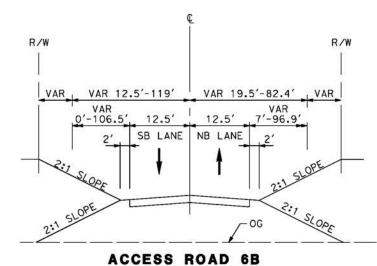

STA 0+84.41 TO STA 13+53.00

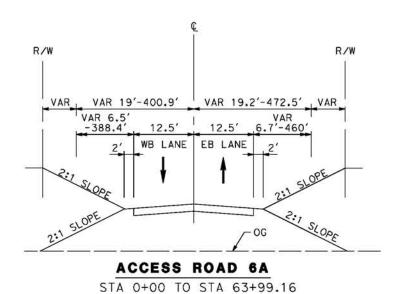



ALIGNMENT "REFINED SR14"
TYPICAL SECTIONS
ACCESS ROAD 4, 5, 6A AND 6B

CONTRAC	
Н	SR14-42
DRAWING	NO.
CV-	Y3002-S14
SCALE	
NIO	SCALE


PEPD RECORD SET
REV 02

NOT FOR
CONSTRUCTION









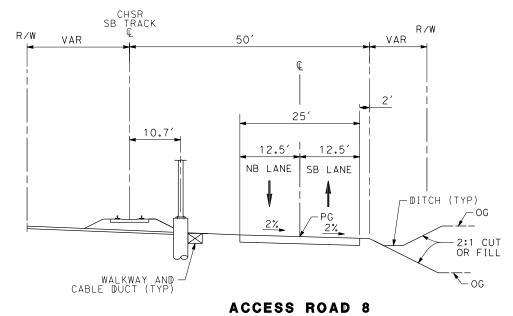


STA 0+00.00 TO STA 1+07.32 STA 12+10.90 TO STA 47+42.81

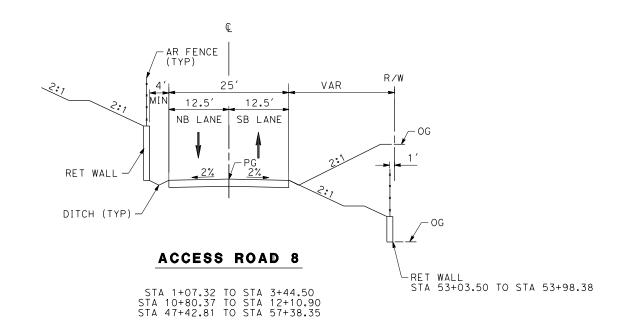

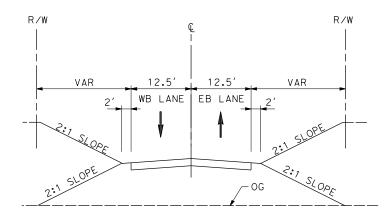

ACCESS ROAD 8

STA 3+44.50 TO STA 10+80.37 STA 57+38.35 TO STA 58+33.44 STA 59+58.08 TO STA 59+72.02

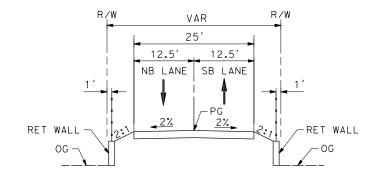

ACCESS ROAD 8

STA 58+33.44 TO STA 59+58.08

							DESIGNED BY J.C. ALAMILLA	
							DRAWN BY D. CORDOBA	PE
							CHECKED BY I. LAQUIDAIN	
04Z0008							IN CHARGE A. RELAÑO	
042	REV	DATE	ВҮ	СНК	APP	DESCRIPTION	02/07/2024	

PEPD RECORD SET
REV 02
NOT FOR
CONSTRUCTION


୬**⊕** sener




CALIFORNIA HIGH-SPEED RAIL PROJECT PALMDALE TO BURBANK

ALIGNMENT "REFINED SR14" TYPICAL SECTIONS ACCESS ROAD 8


CONTR	ACT NO).	
	HSR	114-42	
DRAWIN	IG NO.		
CV	- Y 3	003-S1	4
SCALE			
	NO	SCALE	
SHEET	NO.		

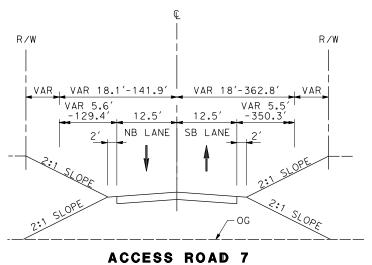


STA 0+00 TO STA 16+79.77

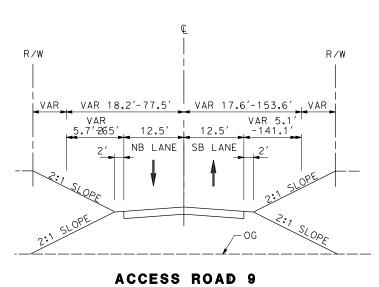

STA 0+00 TO STA 11+37.50

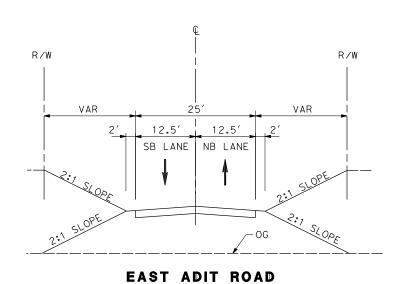

STA 10+00.00 TO STA 13+17.42

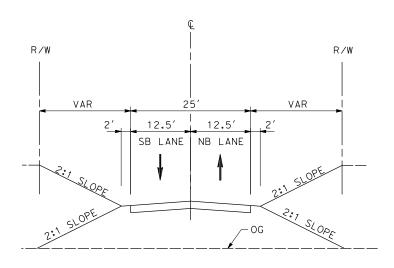

STA 10+18.00 TO STA 13+35.89

							DESIGNED BY J.C. ALAMILLA	
							DRAWN BY D. CORDOBA	PEI
							CHECKED BY I. LAQUIDAIN	
8000							IN CHARGE A. RELANO	, ا
)4Z(REV	DATE	BY	СНК	APP	DESCRIPTION	DATE 12/30/2023	

REV 02

NOT FOR CONSTRUCTION





CALIFORNIA HIGH-SPEED RAIL PROJECT PALMDALE TO BURBANK

ALIGNMENT "REFINED SR14"


TYPICAL SECTIONS

EAST ADIT ROAD AND WEST ADIT ROAD, ACCESS ROAD 7, 9


CONTRACT NO. HSR14-42
DRAWING NO. CV-Y3004-S14
NO SCALE



Palmdale to Burbank Project Section

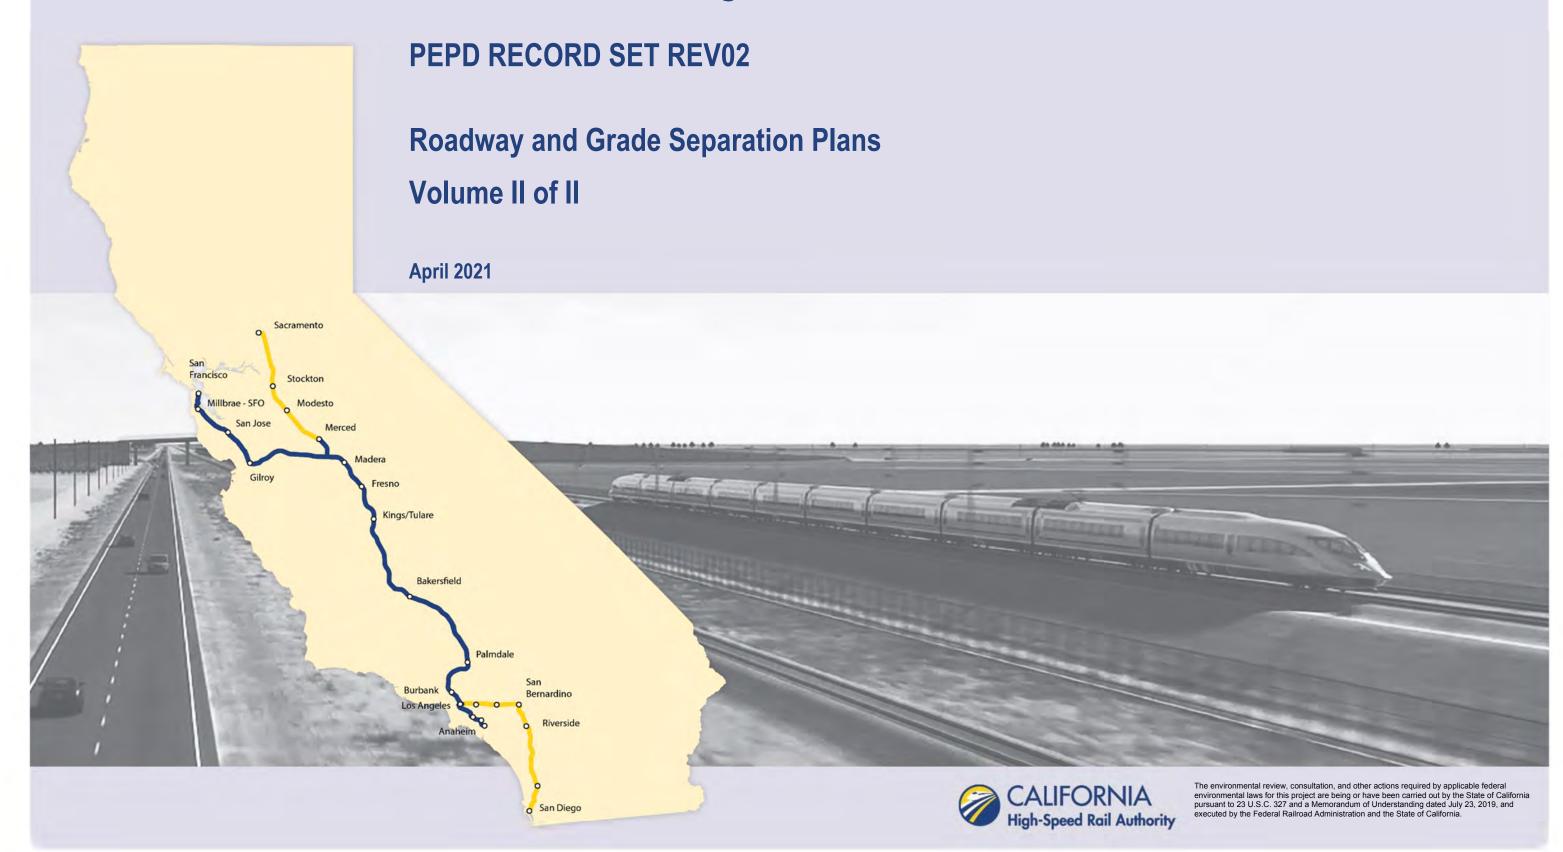



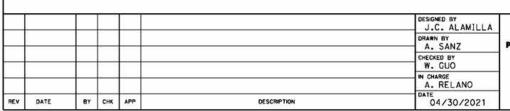

CV-R4006-E

SIXTH ST

FIFTH ST

PEPD RECORD SET
REV 02

NOT FOR
CONSTRUCTION



- € CHSR ALIGNMENT "E1"

CV-R4009-E1


CV-R4008-E1

LAKE PALMDALE

<u>E1</u>

CV-R4007-E1



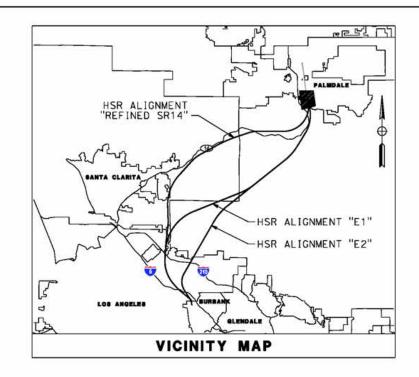




GRADE SEPARATION PLAN



CALIFORNIA HIGH-SPEED RAIL PROJECT PALMDALE TO BURBANK

ALIGNMENT "E1"
ROADWAY AND GRADE SEPARATION PLAN
KEY MAP
SHEET 1 OF 4

CONTR	ACT NO. HSR14-42
DRAWIN C'	vs №. V-B0001-E1
SCALE	S SHOWN
SHEET	NO.

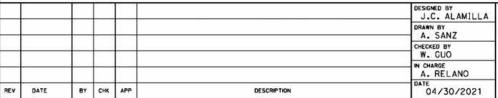


CV-R4023-E1

PEPD RECORD SET REV 02 NOT FOR

CONSTRUCTION





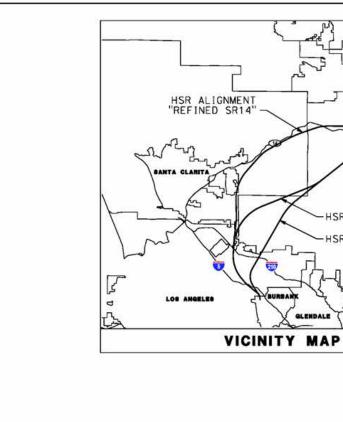



C CHSR ALIGNMENT "E1" -

E1

SIERRA HIGHWAY

CV-R4018-E1

CV-R4019-E1

CV-R4020-E1

ROADWAY PLAN AND ACCESS ROAD PLAN

GRADE SEPARATION PLAN

1000 0 1000 2000

CALIFORNIA HIGH-SPEED RAIL PROJECT PALMDALE TO BURBANK

ALIGNMENT "E1"
ROADWAY AND GRADE SEPARATION PLAN
KEY MAP
SHEET 2 OF 4

CONTRACT NO. HSR14-42
DRAWING NO. CV-B0002-E1
SCALE AS SHOWN
2 22 72

MEST TY

-HSR ALIGNMENT "E1" -HSR ALIGNMENT "E2"




PEPD RECORD SET
REV 02
NOT FOR
CONSTRUCTION

<u>E1</u>

C CHSR ALIGNMENT "E1"





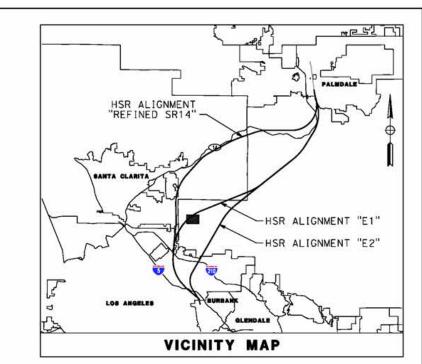

LEGEND:

ROADWAY PLAN AND ACCESS ROAD PLAN

GRADE SEPARATION PLAN

1000 0 1000 2000

CALIFORNIA HIGH-SPEED RAIL PROJECT PALMDALE TO BURBANK

ALIGNMENT "E1"
ROADWAY AND GRADE SEPARATION PLAN
KEY MAP
SHEET 3 OF 4


CONTRACT NO. HSR14-42
ORAWING NO. CV-B0003-E1
SCALE AS SHOWN
SHEET NO.


J.C. ALAMILLA DRAWN BY A. SANZ W. GUO A. RELANO 04/30/2021 BY CHK APP DESCRIPTION

PEPD RECORD SET REV 02 NOT FOR CONSTRUCTION





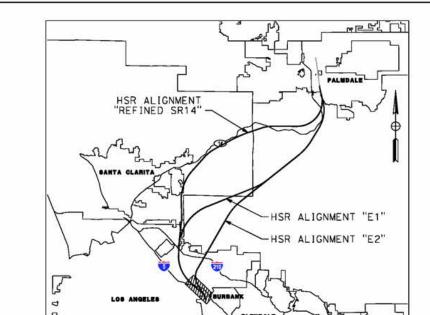

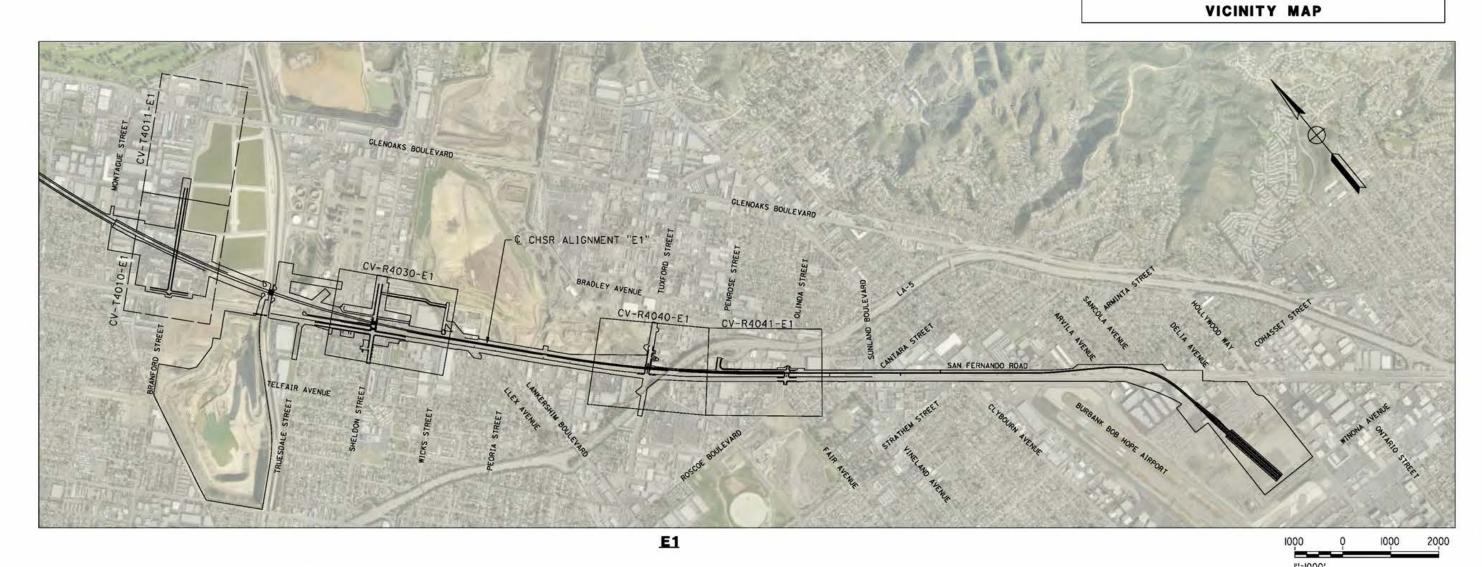

LEGEND:

ROADWAY PLAN


GRADE SEPARATION PLAN

CALIFORNIA HIGH-SPEED RAIL PROJECT PALMDALE TO BURBANK

ALIGNMENT "E1"
ROADWAY AND GRADE SEPARATION PLAN
KEY MAP SHEET 4 OF 4

	HSR14-42
	CV-BOOO4-E
	SCALE AS SHOWN

SHEET NO.

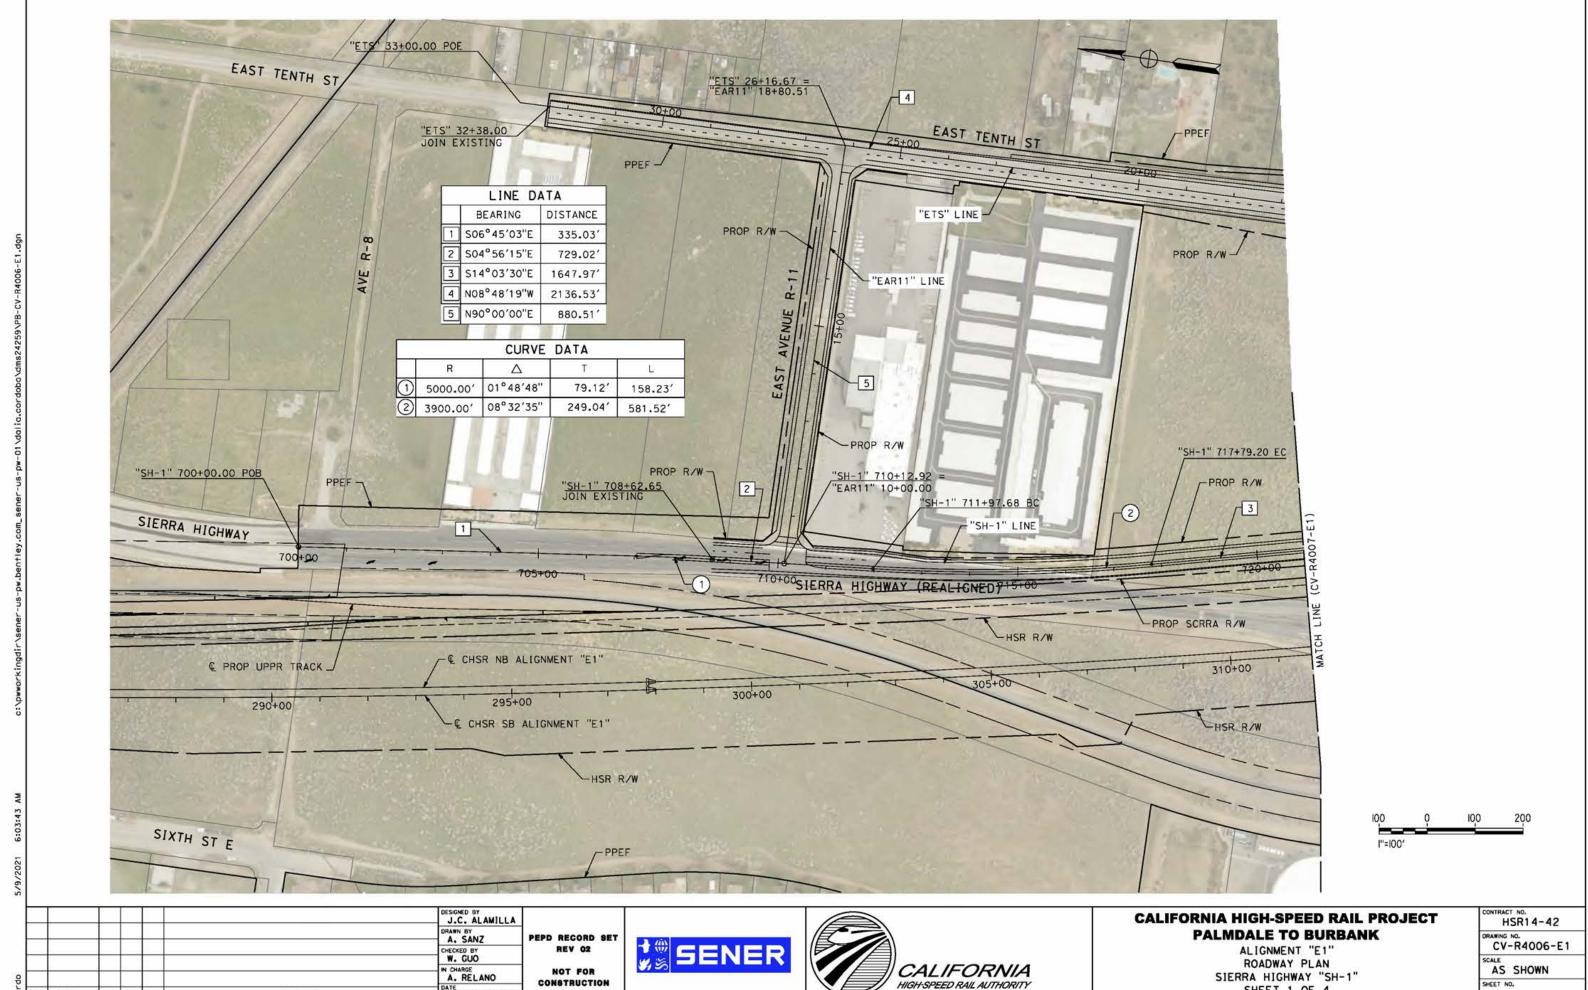


04/30/2021


DATE


BY CHK APP


DESCRIPTION

SHEET 1 OF 4

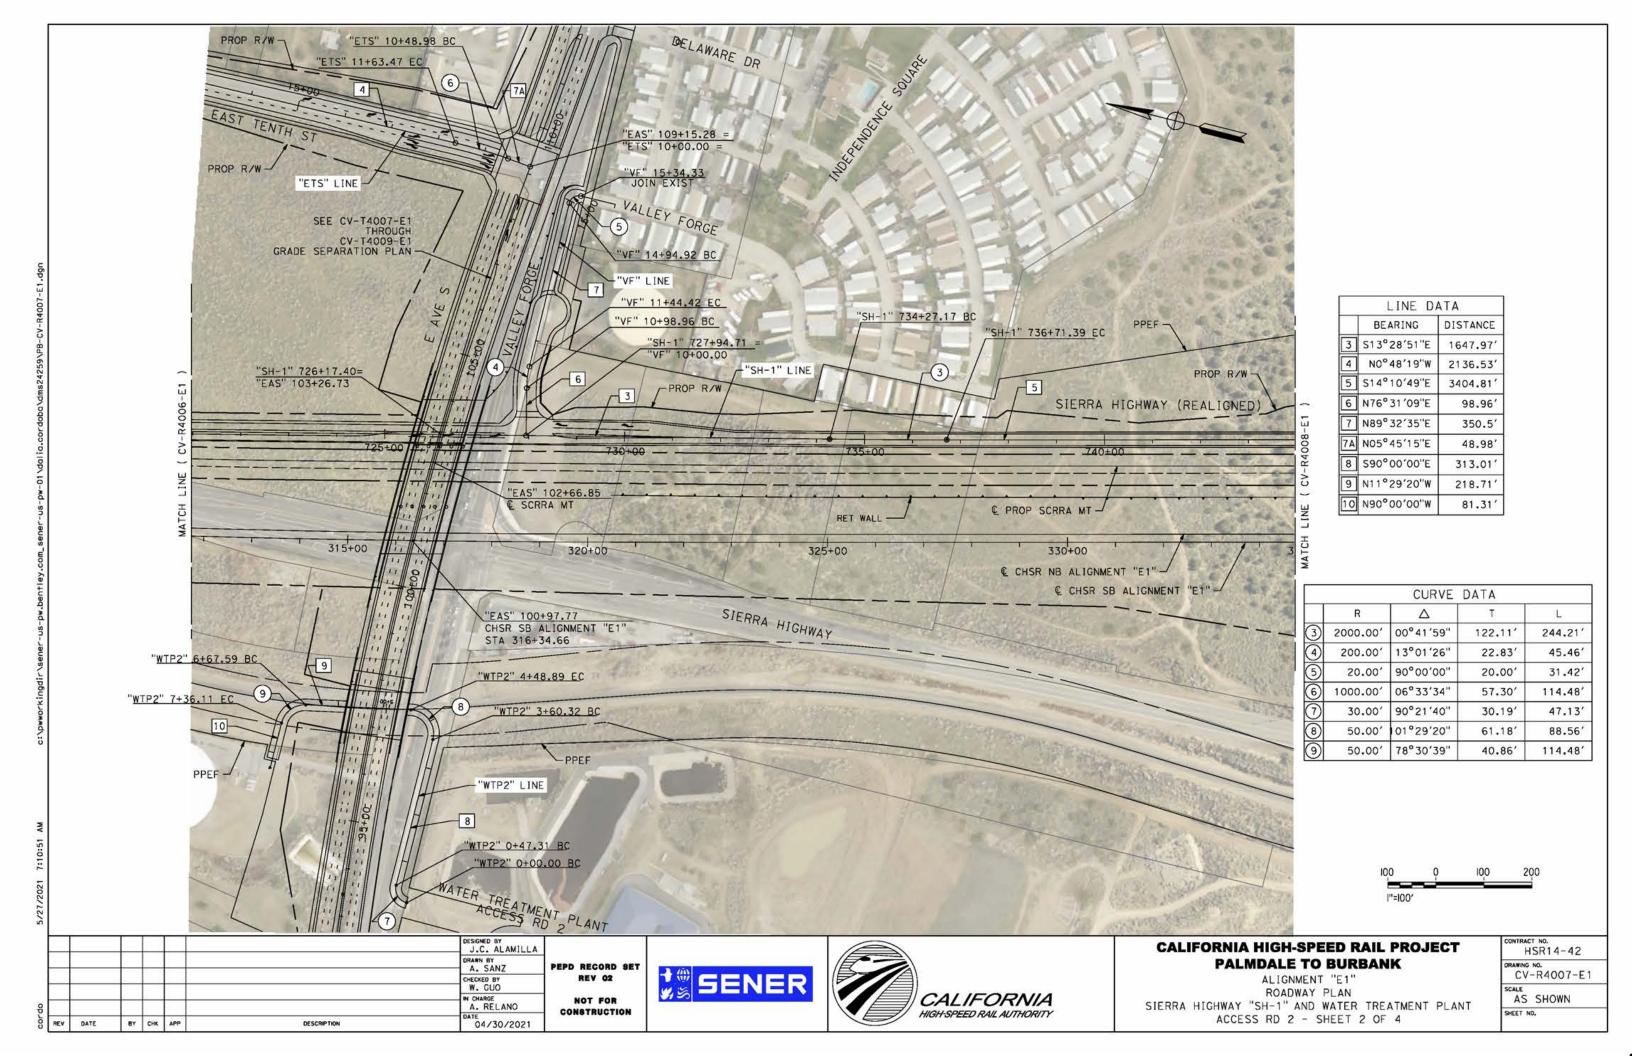

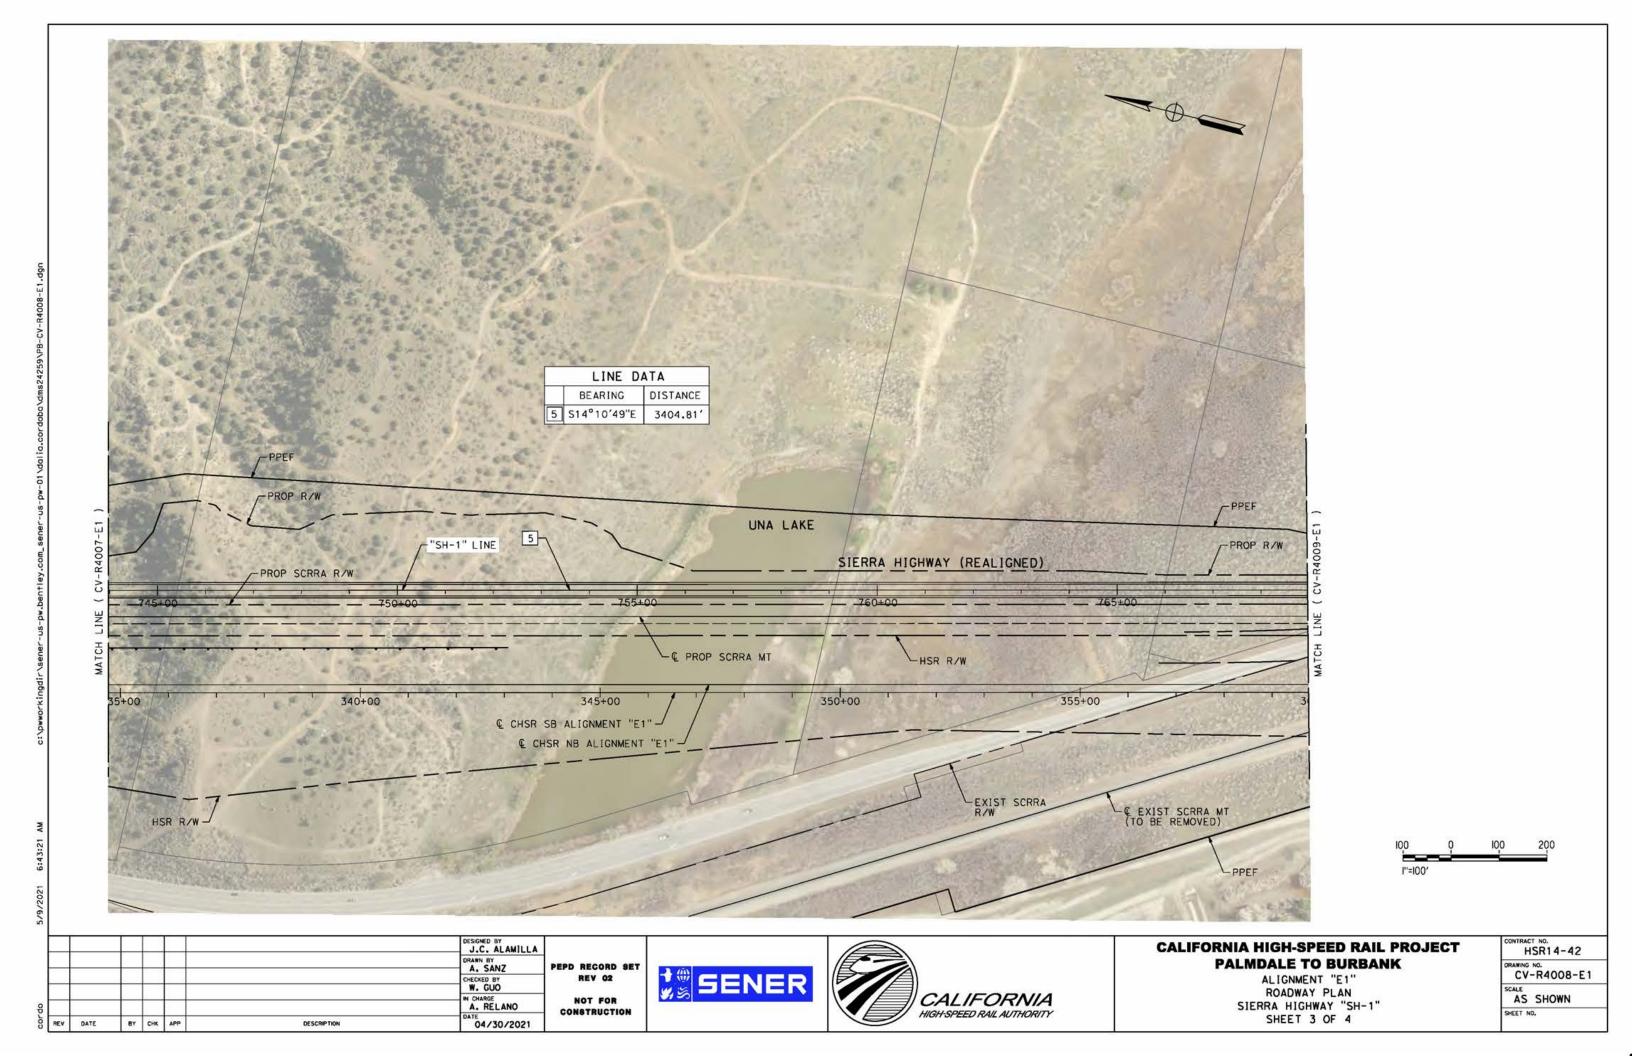

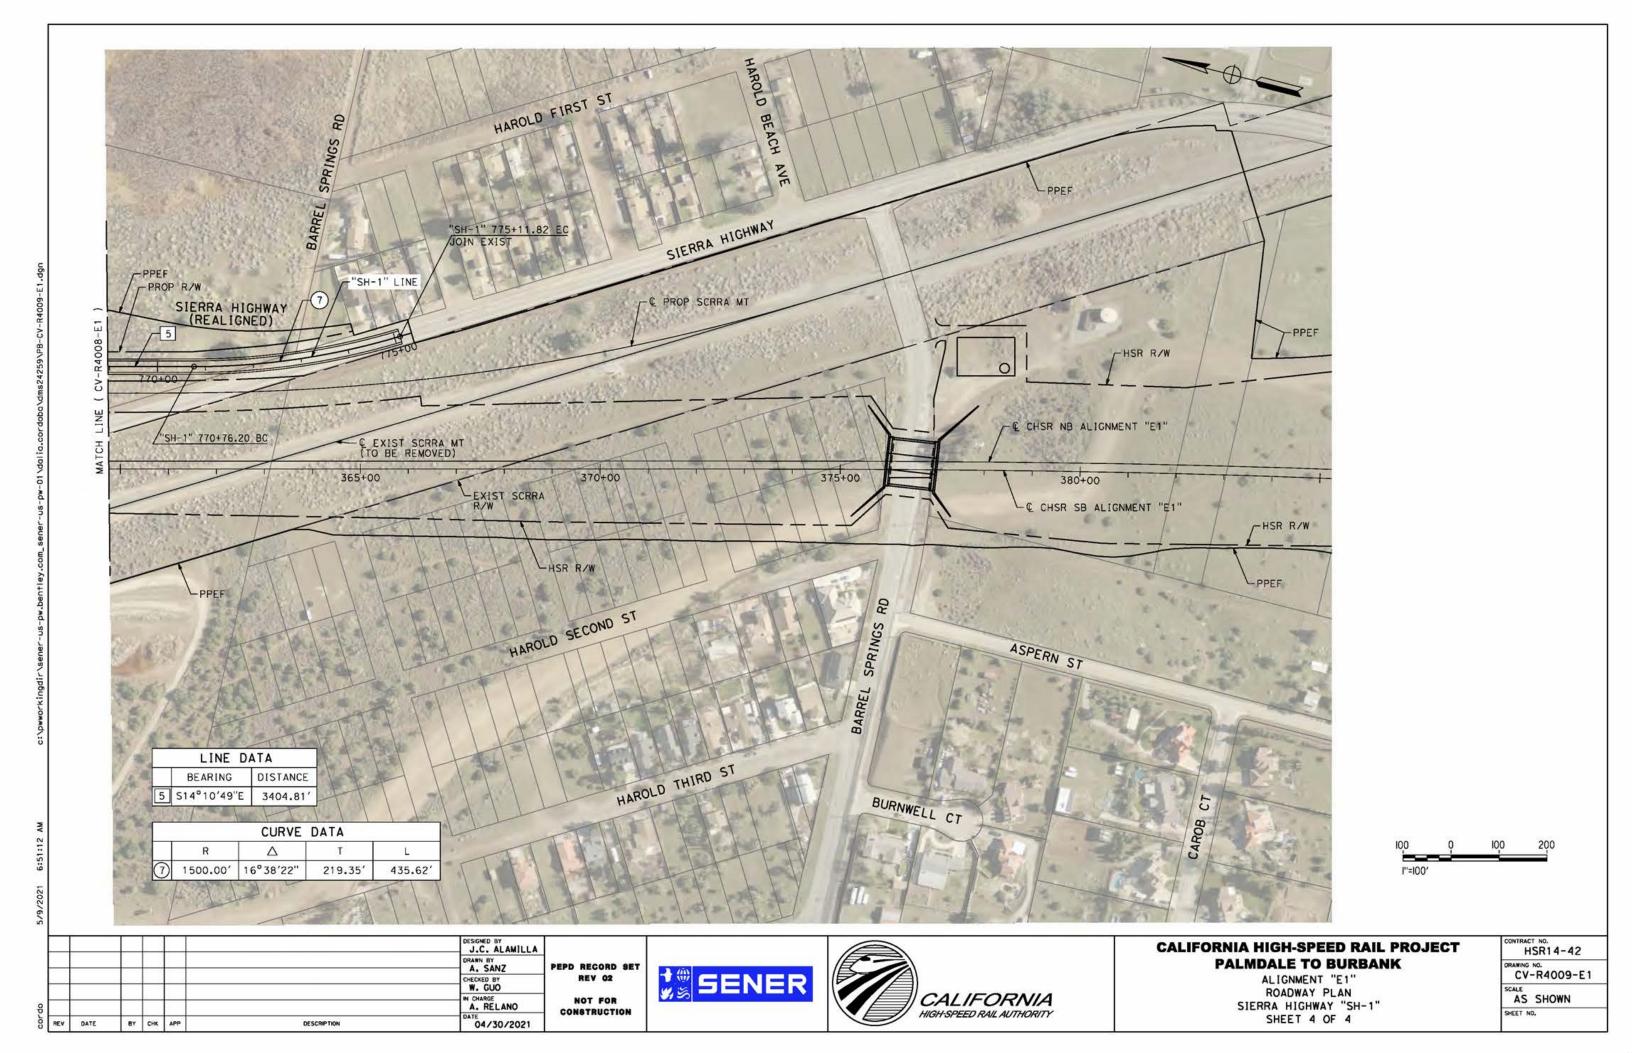

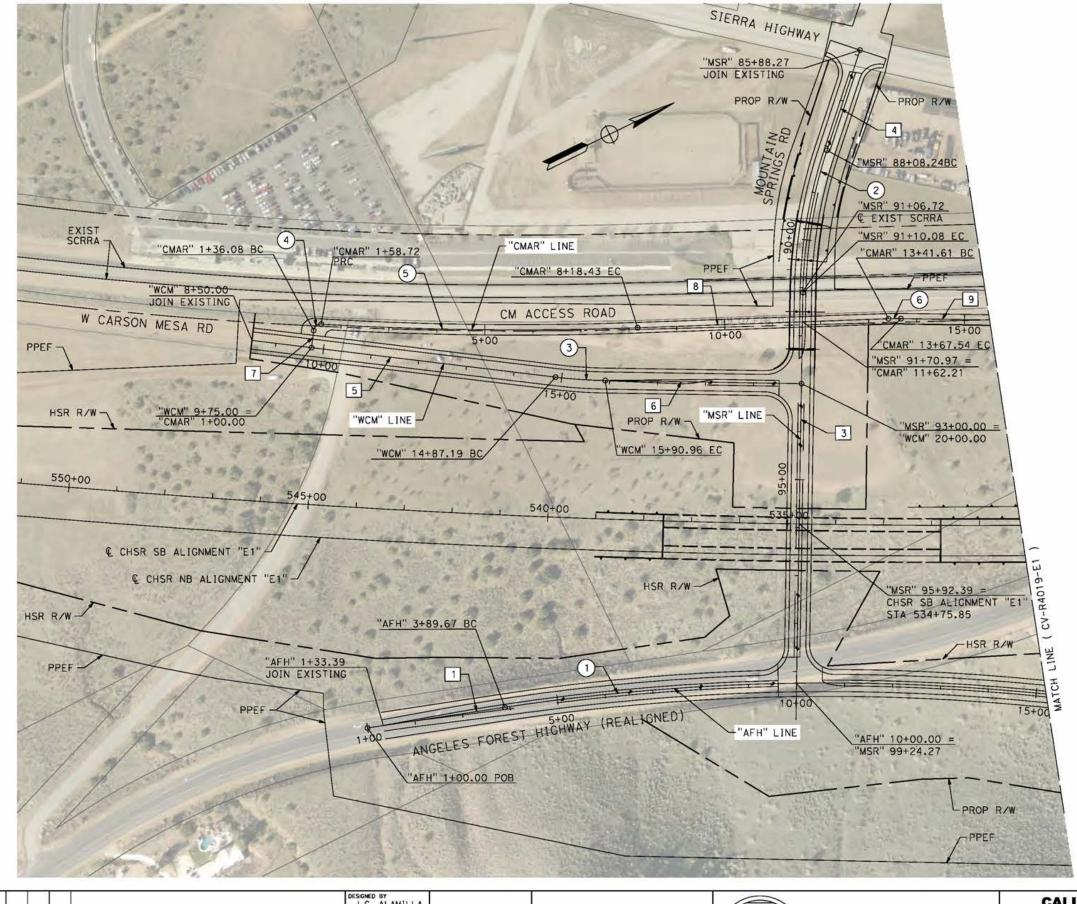

The second secon					
	BEARING	DISTANCE			
1	N17°29'36"E	256.29'			
3	S62°58′16"E	814.19			
4	S45°40′37"E	219.97'			
5	N32°58′29"E	664.55			
6	N27°01'44"E	409.04			
7	N57°01'31"W	36.08			
8	N24°02′23"E	523.18			
9	N27°01'44"E	360.52			

		CURVE	DATA	
	R	Δ	Т	L
1	4500.00'	15°15′24"	602.75′	1198.37'
2	1000.00	17°17′39"	152.08'	301.84
3	1000.00'	05°56′46"	51.94	103.78
4	15.00'	86°27′45"	14.10	22.64
5	7003.00	05°23′51"	330.10'	659.71
6	497.00	2°59′20"	12.97′	25.93



						J.C. ALAMILLA
\dashv		\perp				DRAWN BY A. SANZ
-		+	-			W. GUO
		+				IN CHARGE A. RELANO
REV	DATE	BY	CHK	APP	DESCRIPTION	DATE 04/30/2021

PEPD RECORD SET REV 02 NOT FOR CONSTRUCTION






CALIFORNIA HIGH-SPEED RAIL PROJECT PALMDALE TO BURBANK

ALIGNMENT "E1"
ROADWAY PLAN
ANGELES FOREST HIGHWAY, W CARSON MESA ROAD
AND MOUNTAIN SPRINGS ROAD

CONTRA	CT NO. HSR14-42
DRAWING C V	: NO. '-R4018-E1
SCALE	SHOWN

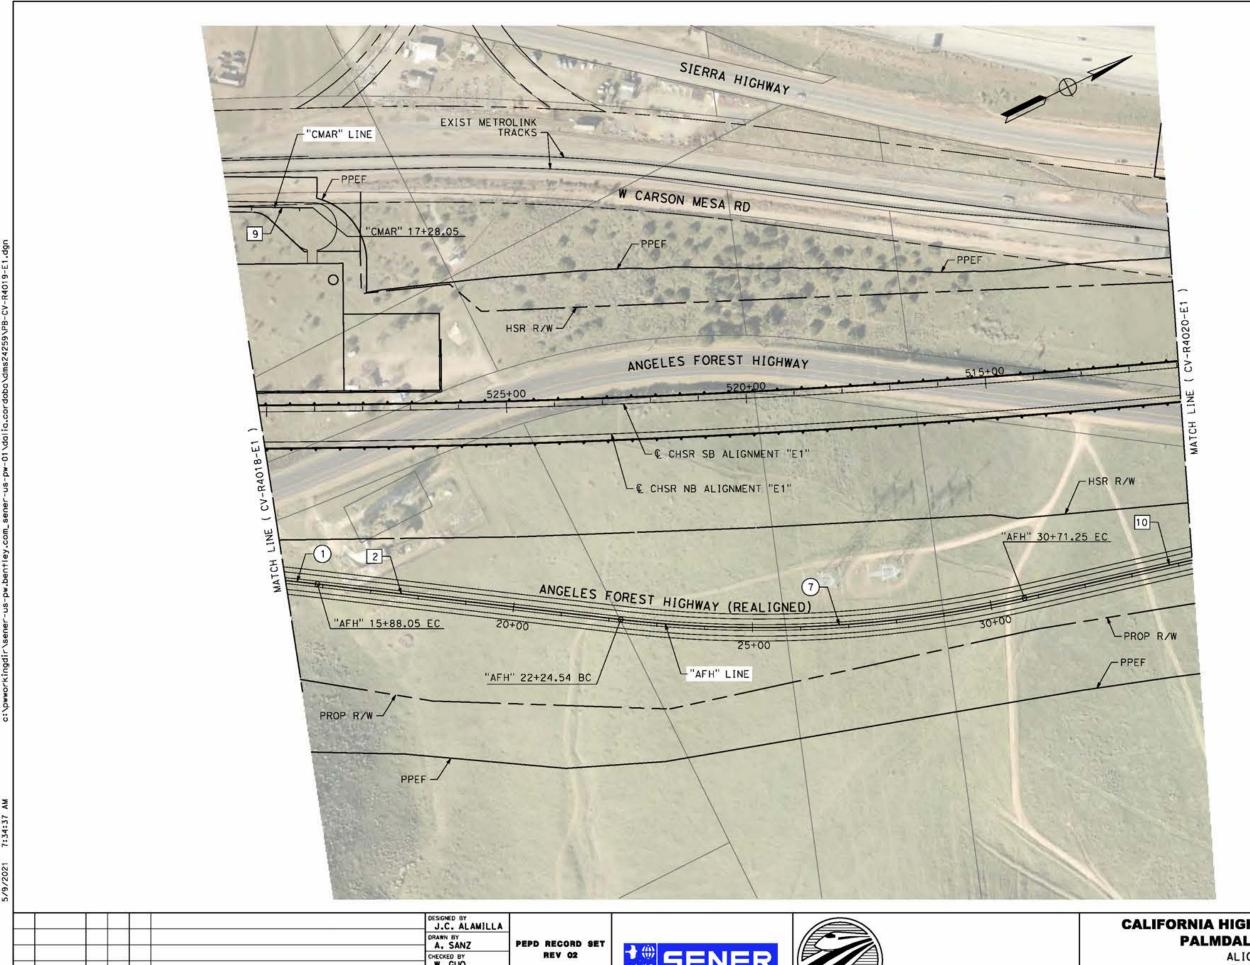

	LINE DA	ATA
	BEARING	DISTANCE
2	N32°45′05"E	636.49
9	N27°01′44"E	360.52
10	N13°20'47"E	731.75

		CURVE	DATA	
	R	Δ	T	L
1	4500.00'	15°15′29"	602.75	1198.37"
7	2500.00'	19°24′18"	427.45′	846.71



\Box						DESIGNED BY J.C. ALAMILLA
\perp		_				DRAWN BY A. SANZ
+		+	-			W. GUO
\dashv		1	-	\vdash		IN CHARGE A. RELANO
REV	DATE	BY	CHK	APP	DESCRIPTION	DATE 04/30/2021



NOT FOR


CONSTRUCTION



CALIFORNIA HIGH-SPEED RAIL PROJECT PALMDALE TO BURBANK

ALIGNMENT "E1" ROADWAY PLAN ANGELES FOREST HIGHWAY

Н	T NO. SR14-42
DRAWING CV	[№] . -R4019-E1
SCALE	SHOWN

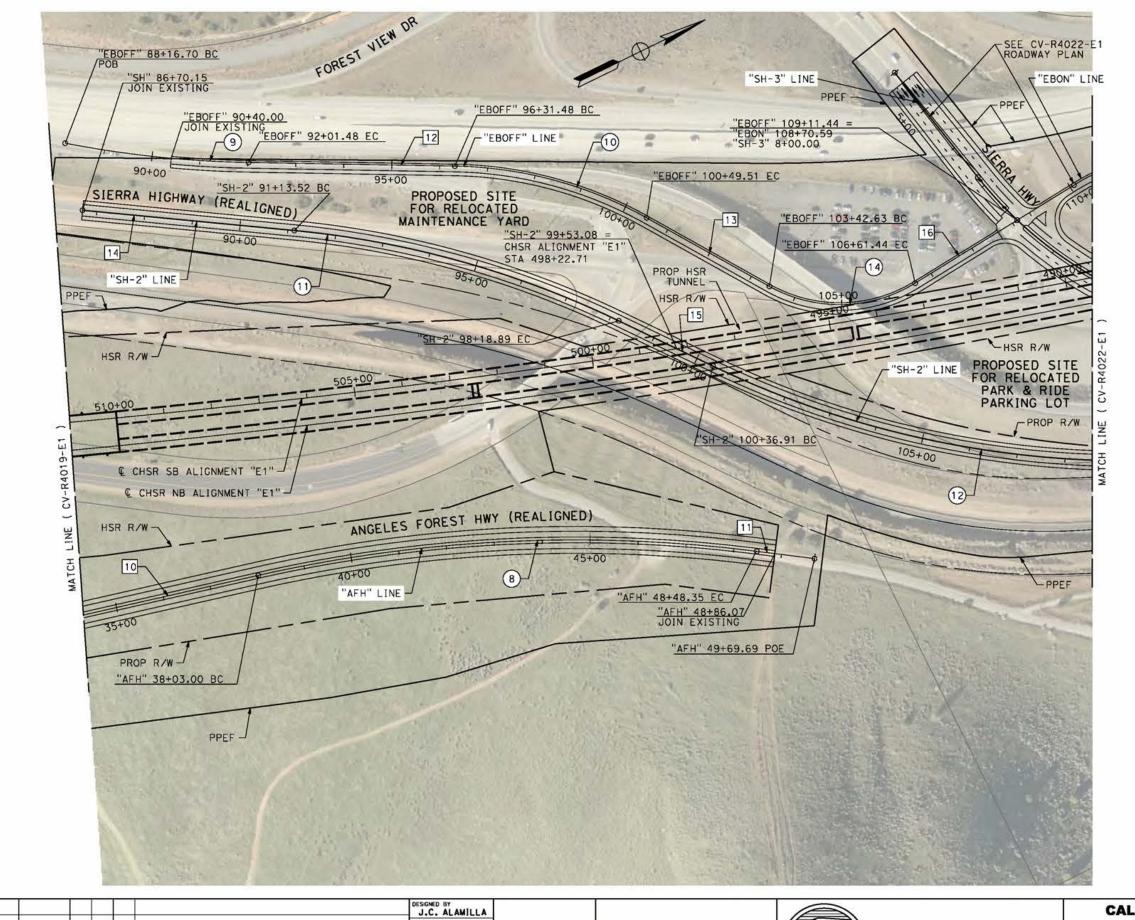

	LINE D	ATA
	BEARING	DISTANCE
10	N13°20'47"E	731.75
11	S33°18′40"E	121.14
12	N27°05′44"E	430.00
13	N55°16′24"E	293.12
14	N31°32′53″E	443.36
15	N51°45′19"E	218.02
16	NO5° 36'55"W	250.00

1 15	CURVE DATA			
	R	Δ	T	L
8	3000.00'	19°57′53"	528.03′	1045.35
9	2200.00'	10°01′16"	192.88'	384.78
10	850.00'	28°10′40"	213.33'	418.03
1	2000.00'	20°12′27"	356.39'	705.37
13	2000.00'	29°08′56"	520.01′	1017.49
13	300.00	60°53′19"	176.32	318.81



						J.C. ALAMILLA	
\dashv		1				DRAWN BY A. SANZ	
\dashv		+				CHECKED BY W. GUO	
		+	H			IN CHARGE A. RELANO	
REV	DATE	BY	CHK	APP	DESCRIPTION	DATE 04/30/2021	

PEPD RECORD SET REV 02 NOT FOR

CONSTRUCTION






CALIFORNIA HIGH-SPEED RAIL PROJECT PALMDALE TO BURBANK


ALIGNMENT "E1"

ROADWAY PLAN

ANGELES FOREST HIGHWAY AND ROUTE 14 EB OFF-RAMP

CONTRAC	T NO. SR14-42
CV-	[№] . -R4020-E1
SCALE	SHOWN
SHEET N	0.

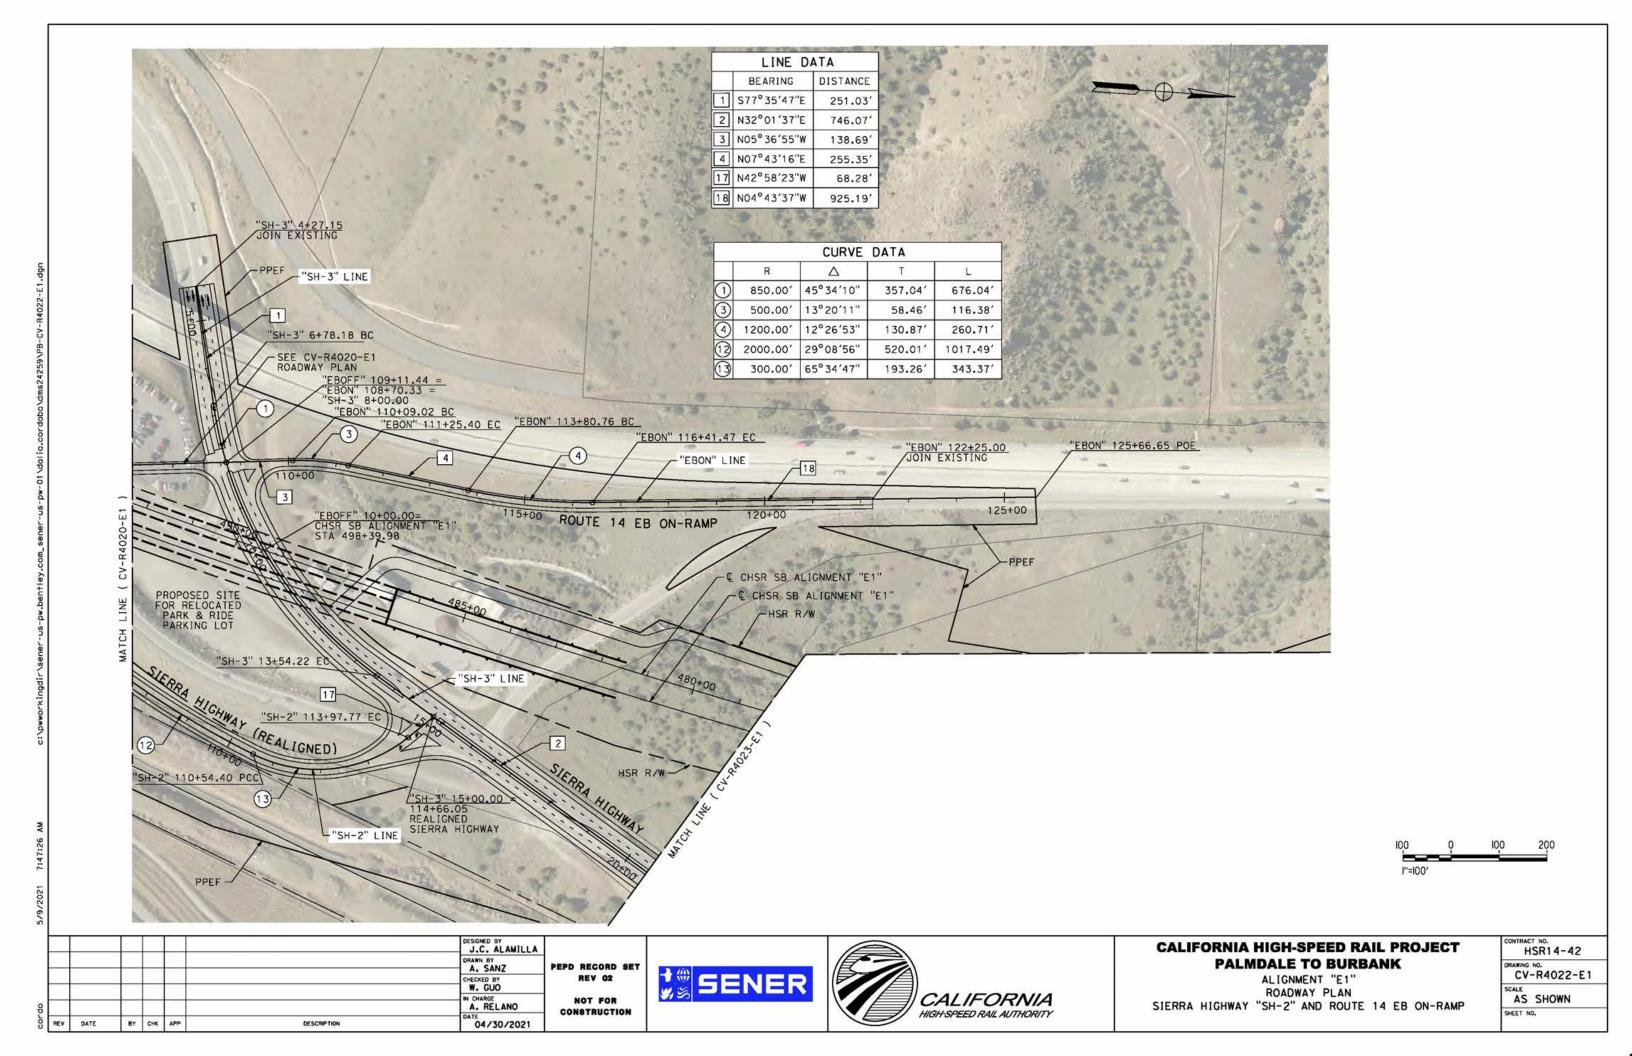

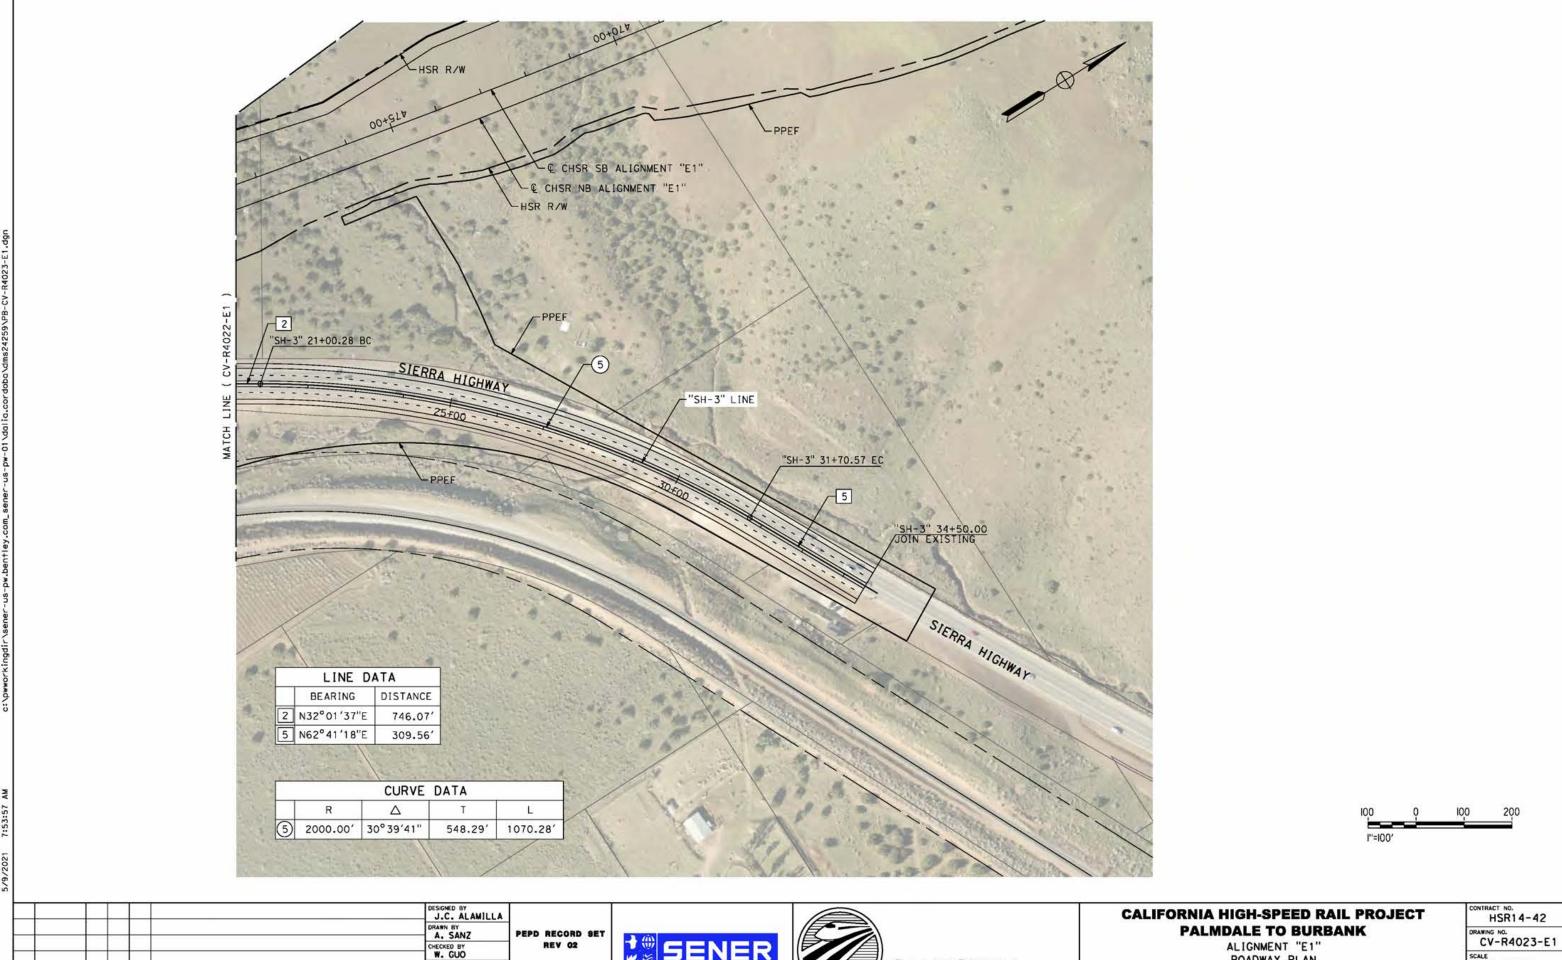

BY CHK APP DESCRIPTION

NOT FOR CONSTRUCTION

A. RELANO

04/30/2021

SENER



ALIGNMENT "E1" ROADWAY PLAN SIERRA HIGHWAY "SH-3"

HSR14-42		
CV-	[№] . -R4023-E1	
SCALE	SHOWN	
SHEET N	n.	

HIGH-SPEED RAIL AUTHORITY


AND ACCESS RD

CONSTRUCTION

04/30/2021

BY CHK APP

DESCRIPTION

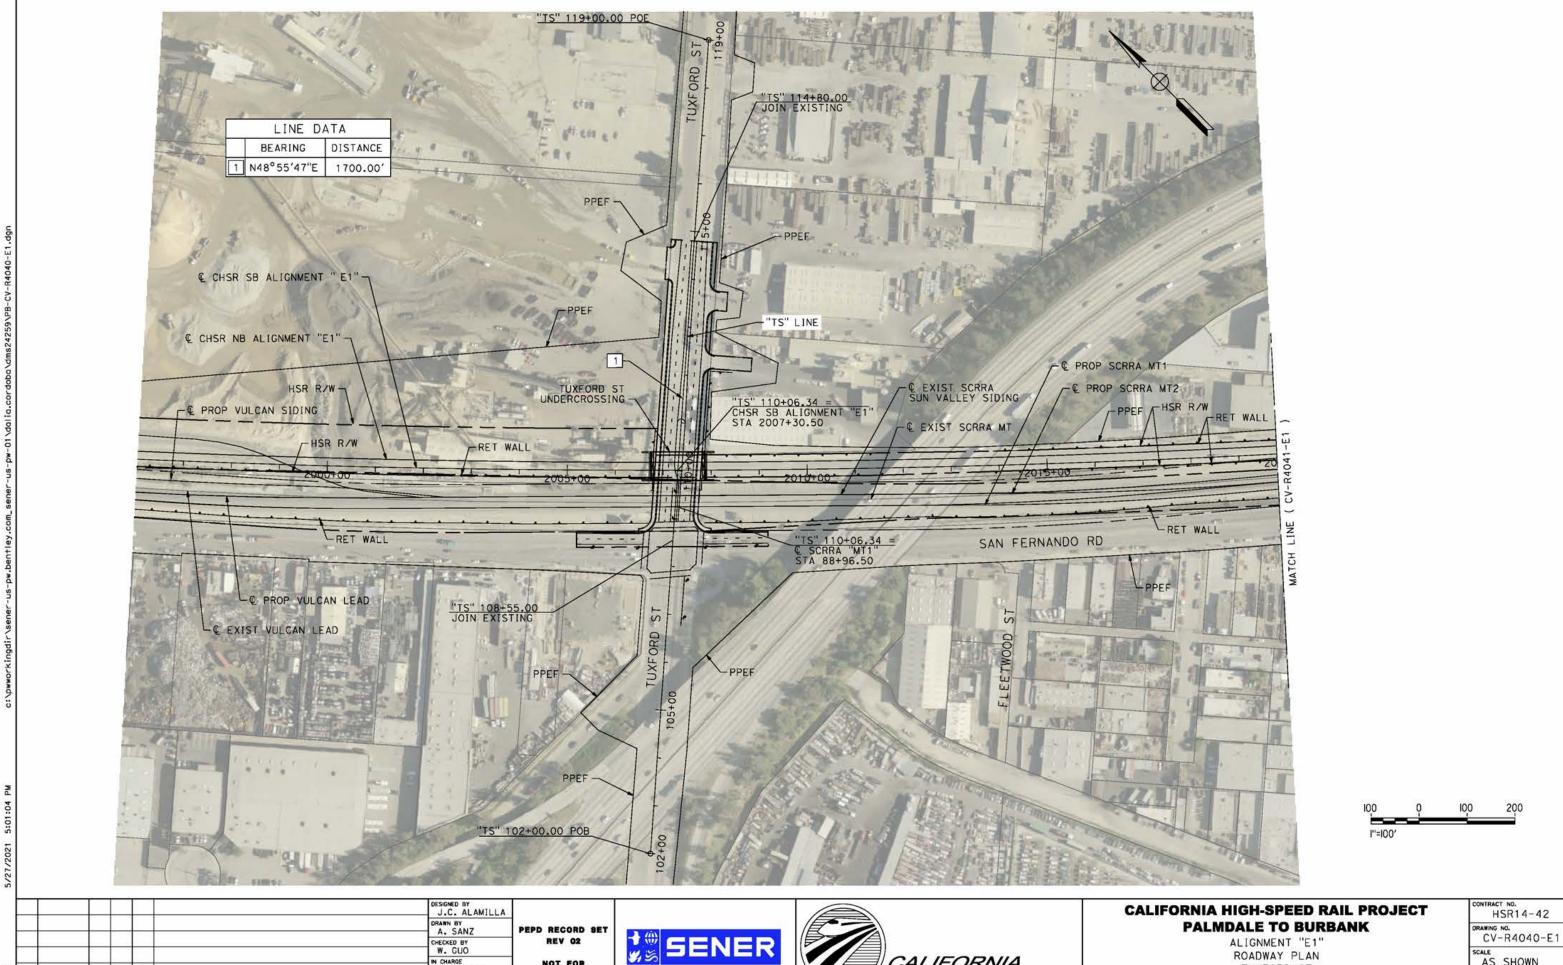

A. RELANO

BY CHK APP

DESCRIPTION

04/30/2021

NOT FOR

CONSTRUCTION


CALIFORNIA

HIGH-SPEED RAIL AUTHORITY

AS SHOWN SHEET NO.

ROADWAY PLAN

TUXFORD ST

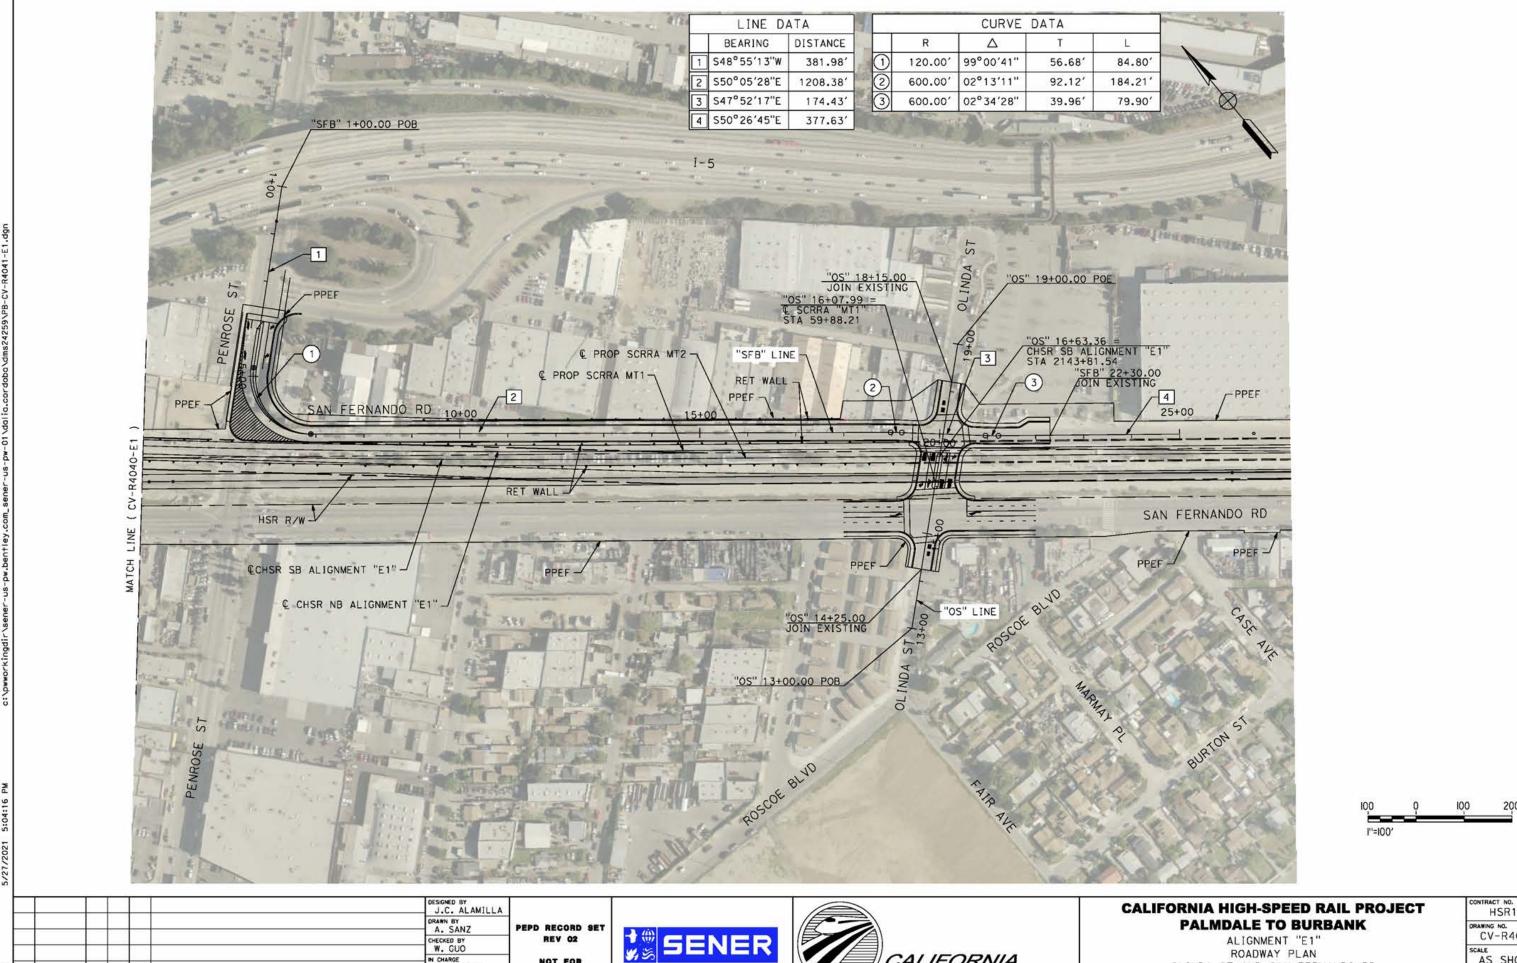

A. RELANO

BY CHK APP

DESCRIPTION

04/30/2021

NOT FOR


CONSTRUCTION


HSR14-42 CV-R4041-E1 AS SHOWN


OLINDA ST AND SAN FERNANDO RD


ROADWAY PLAN


CALIFORNIA HIGH-SPEED RAIL AUTHORITY

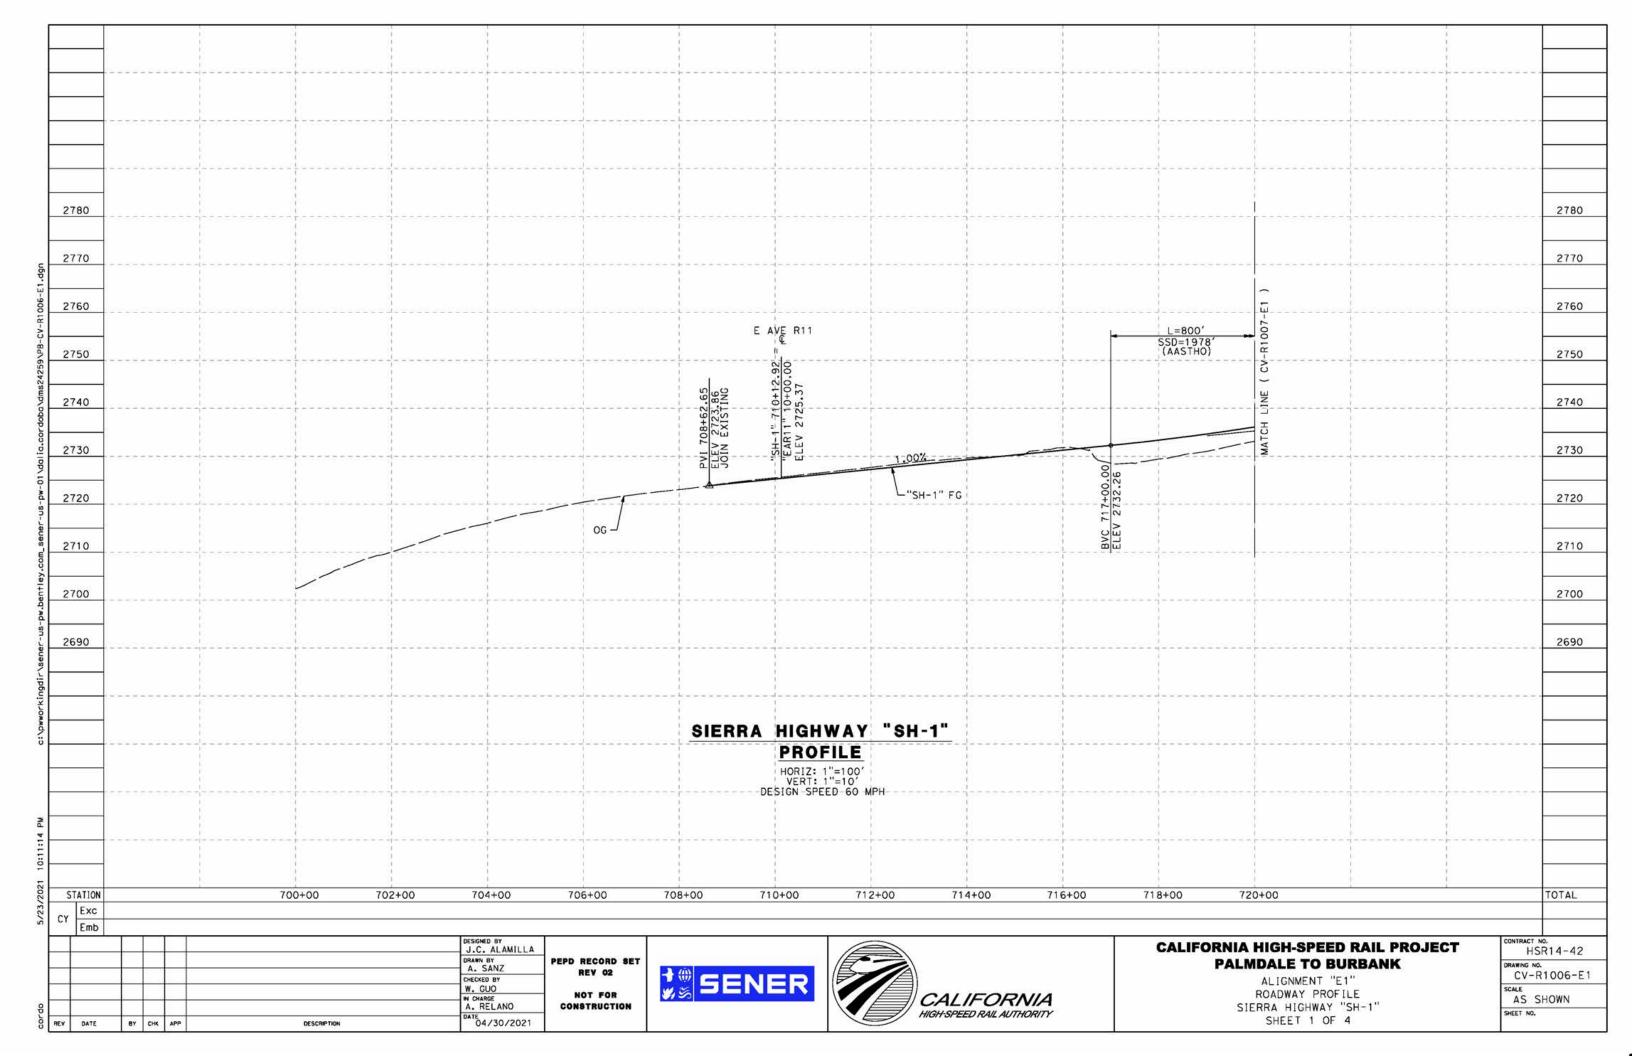


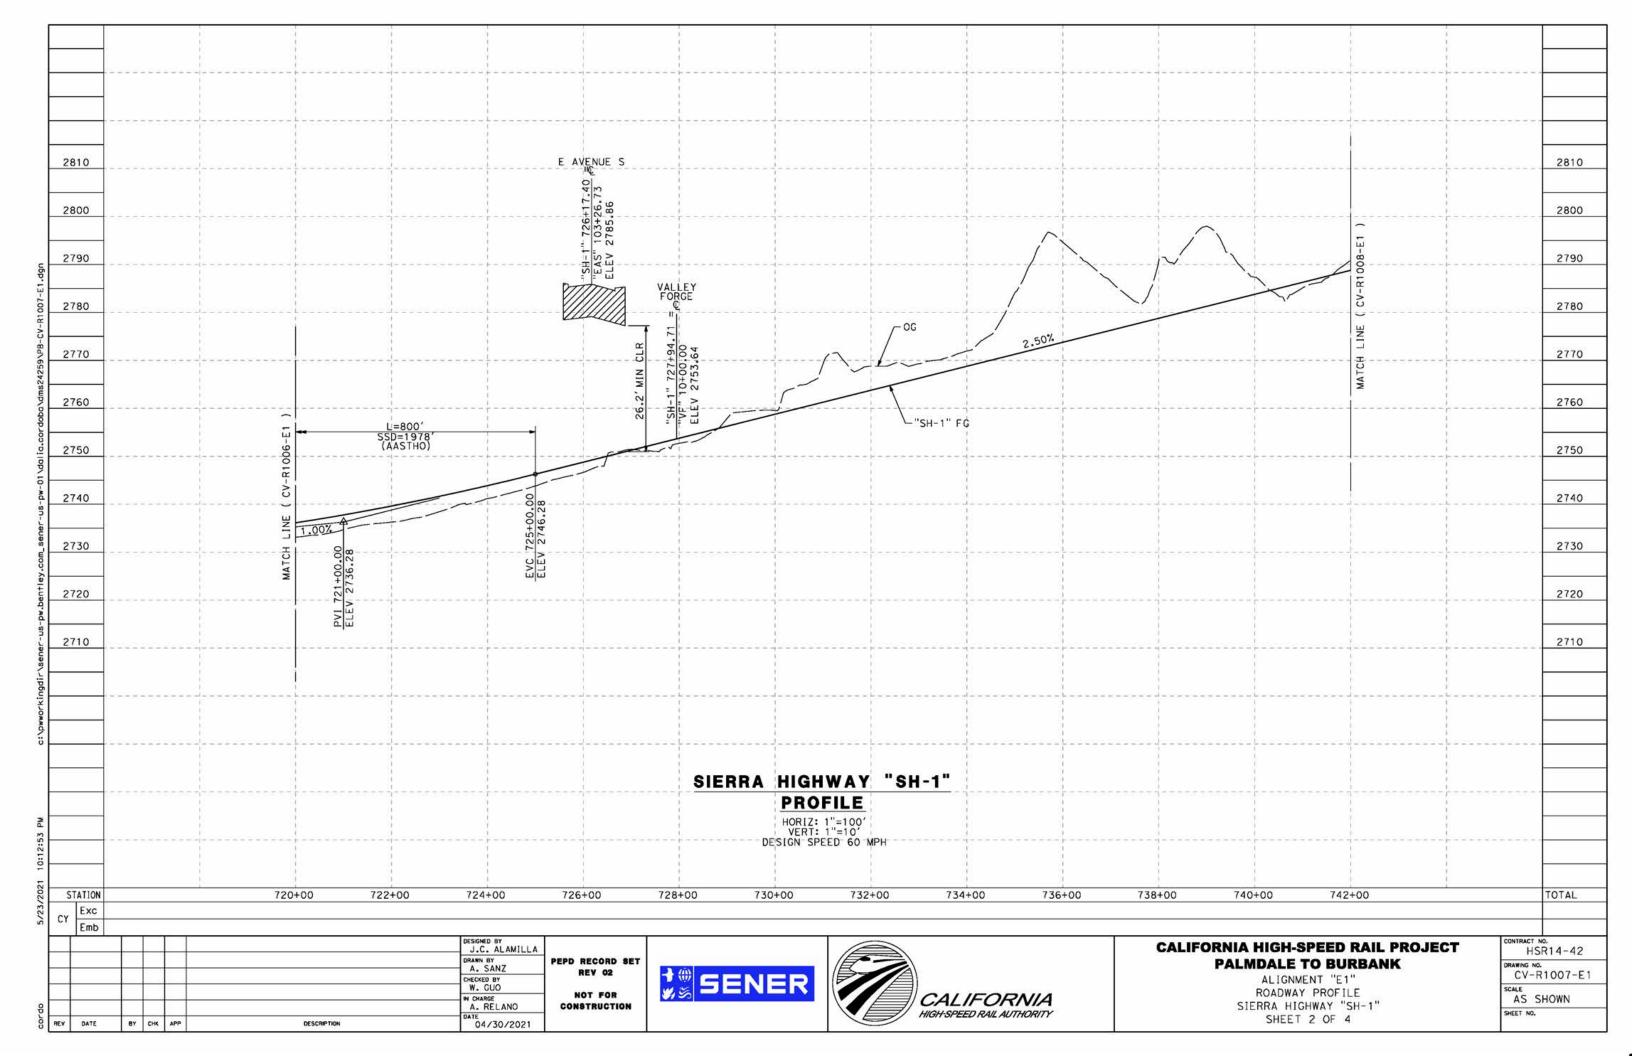


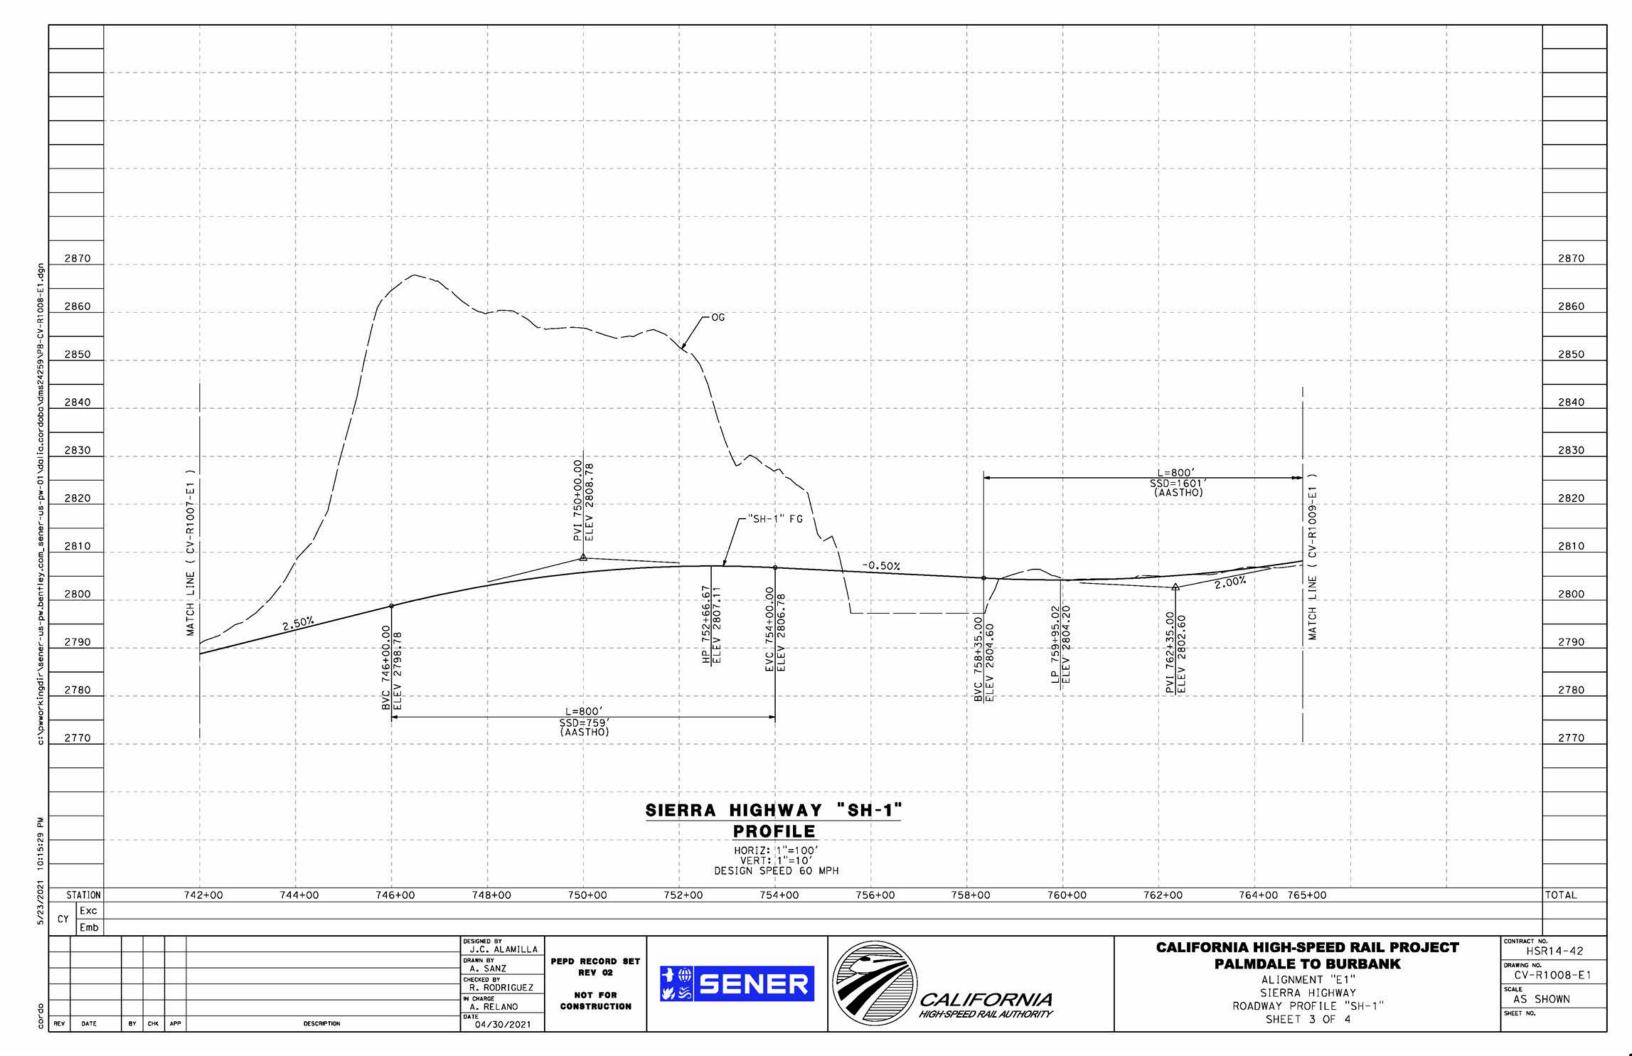


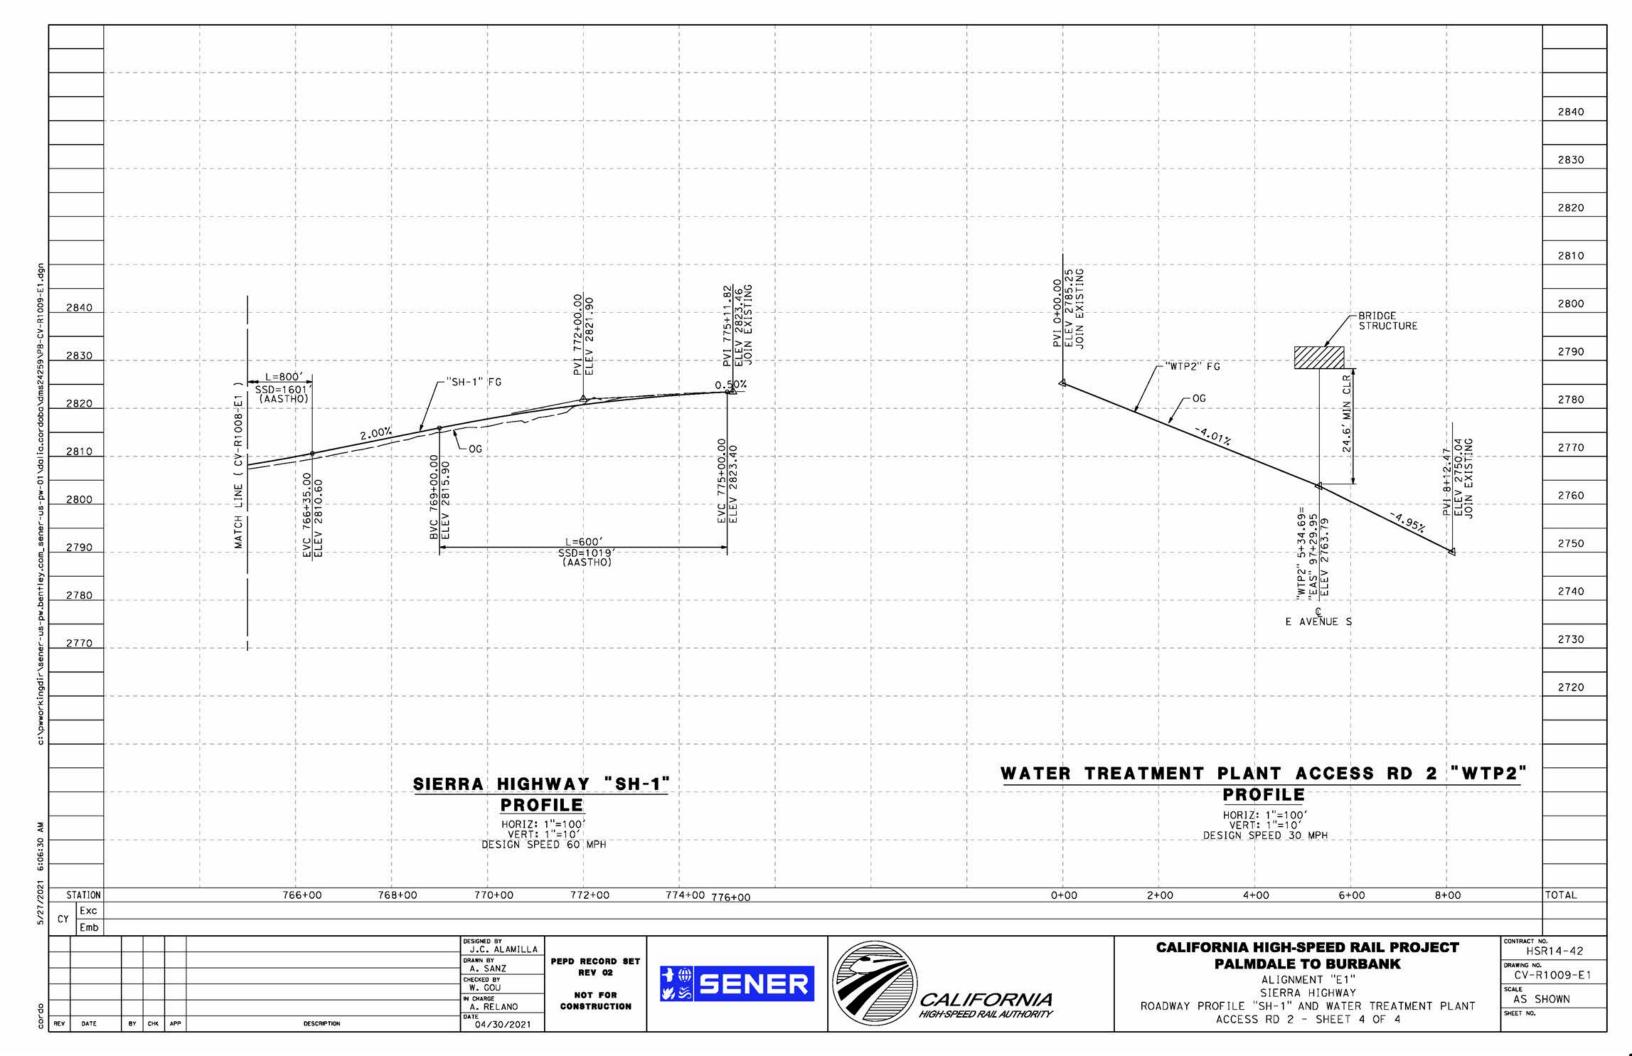


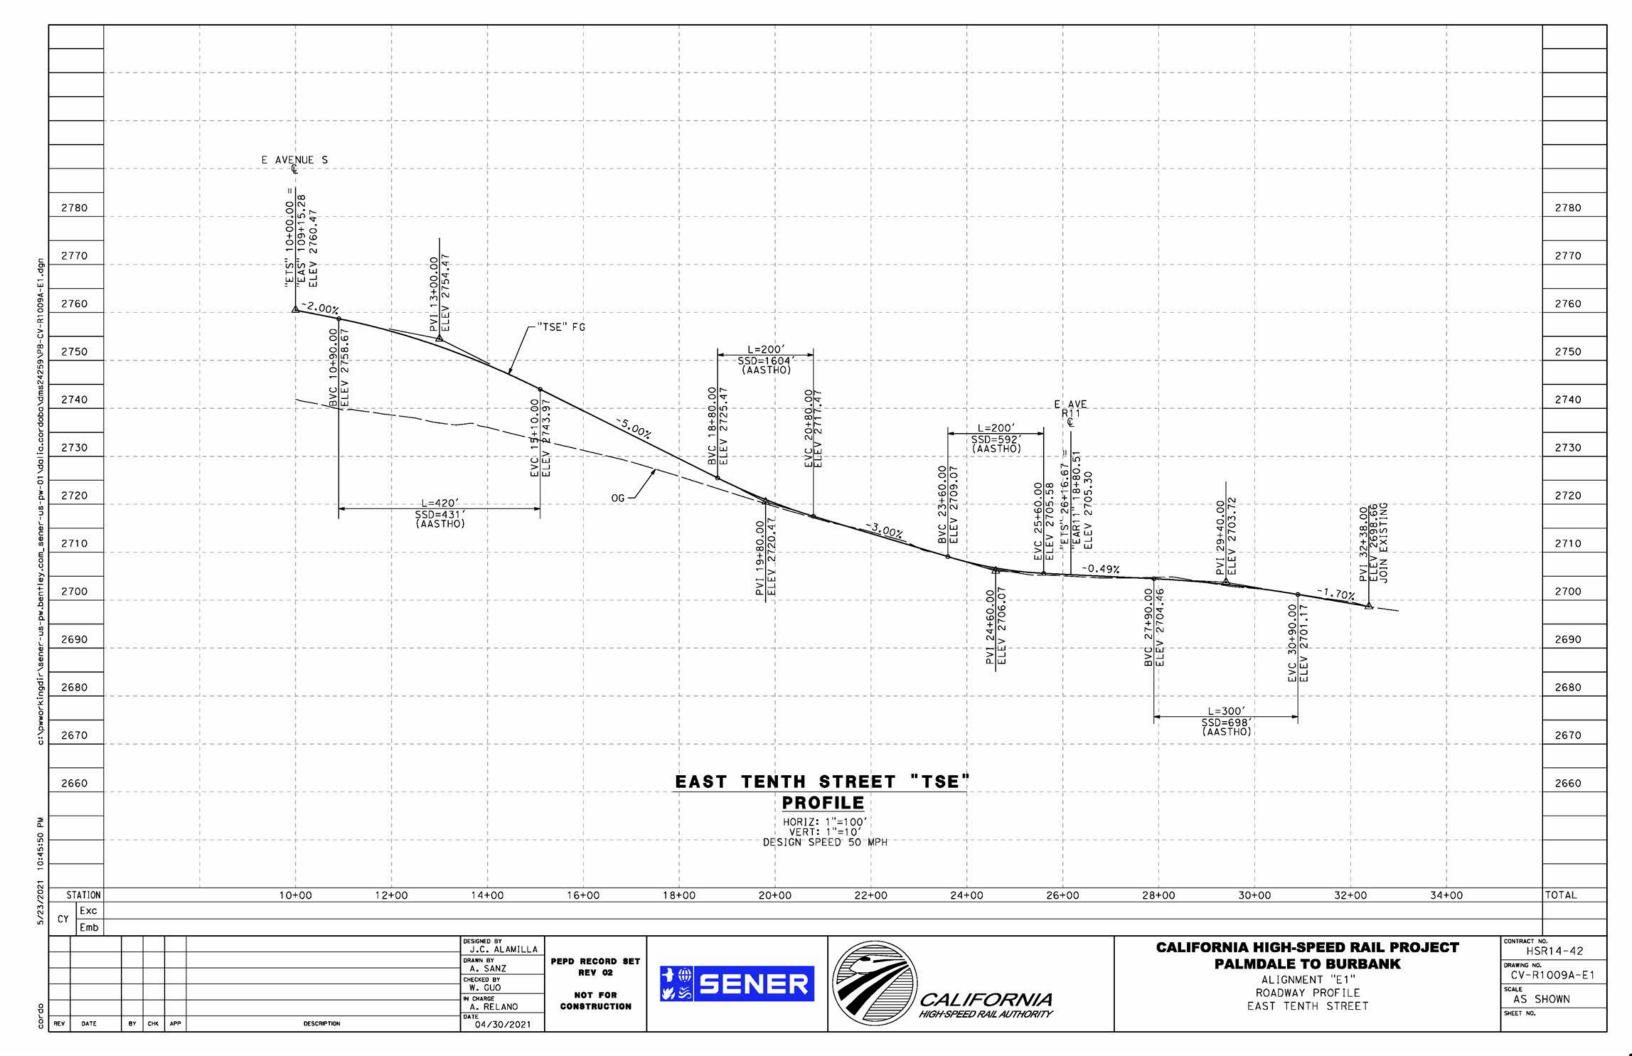


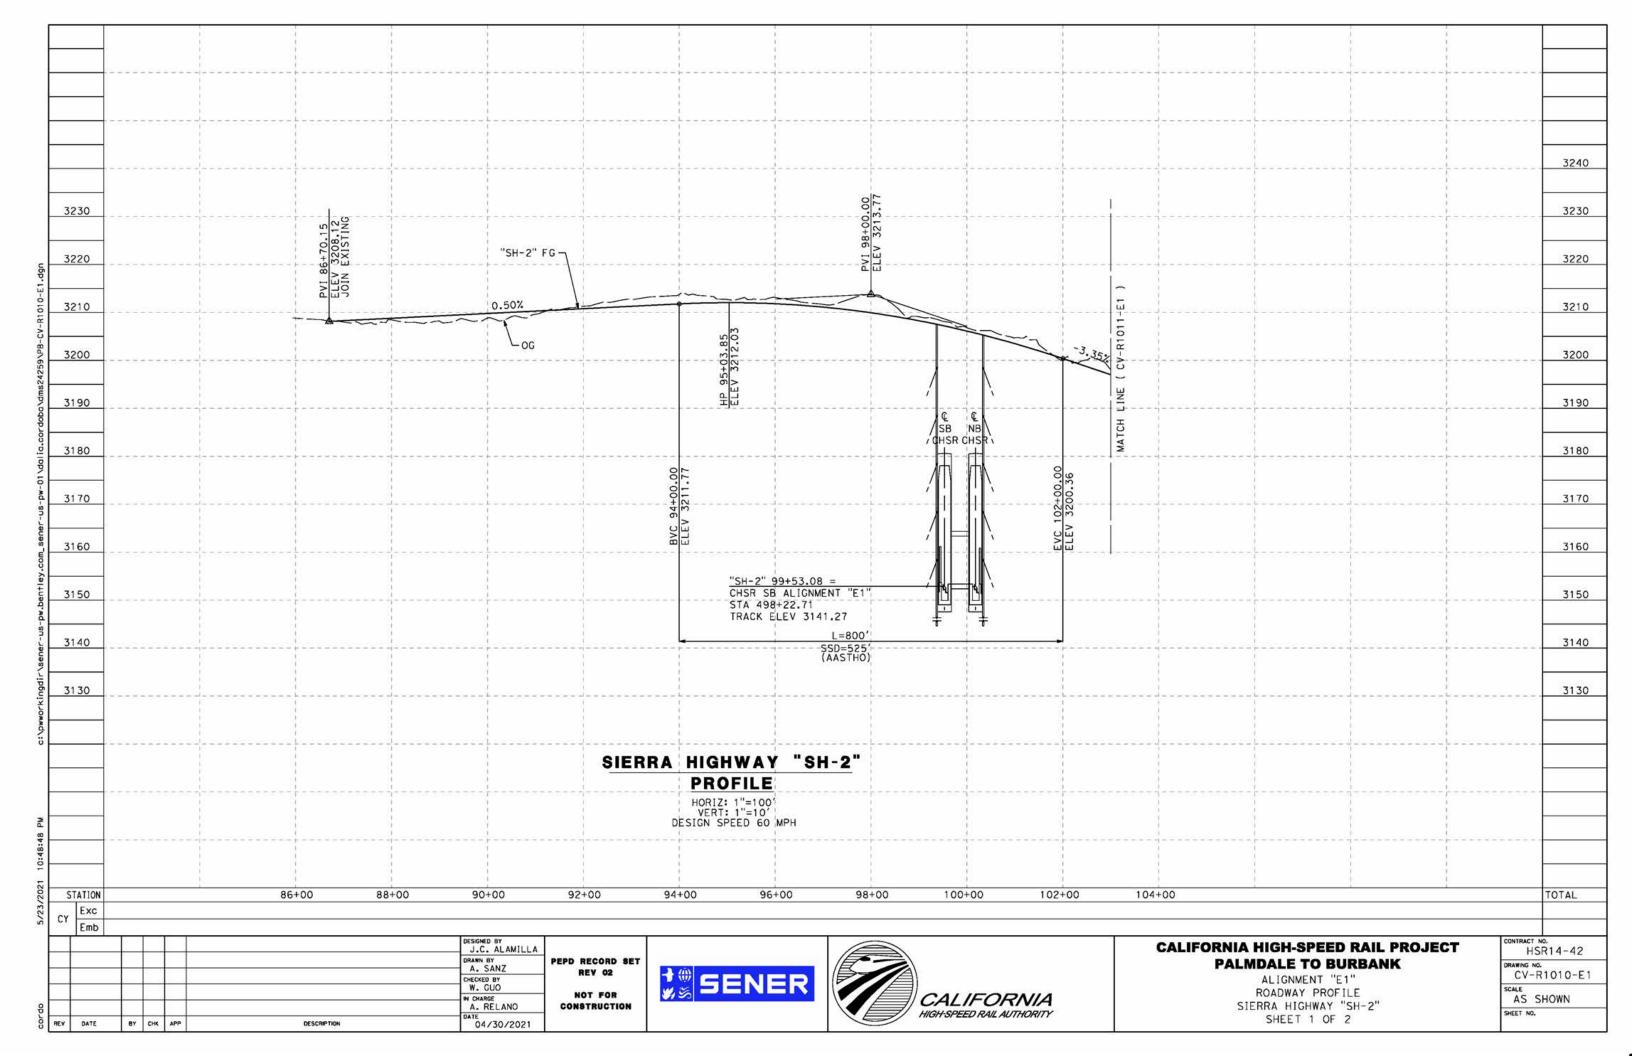


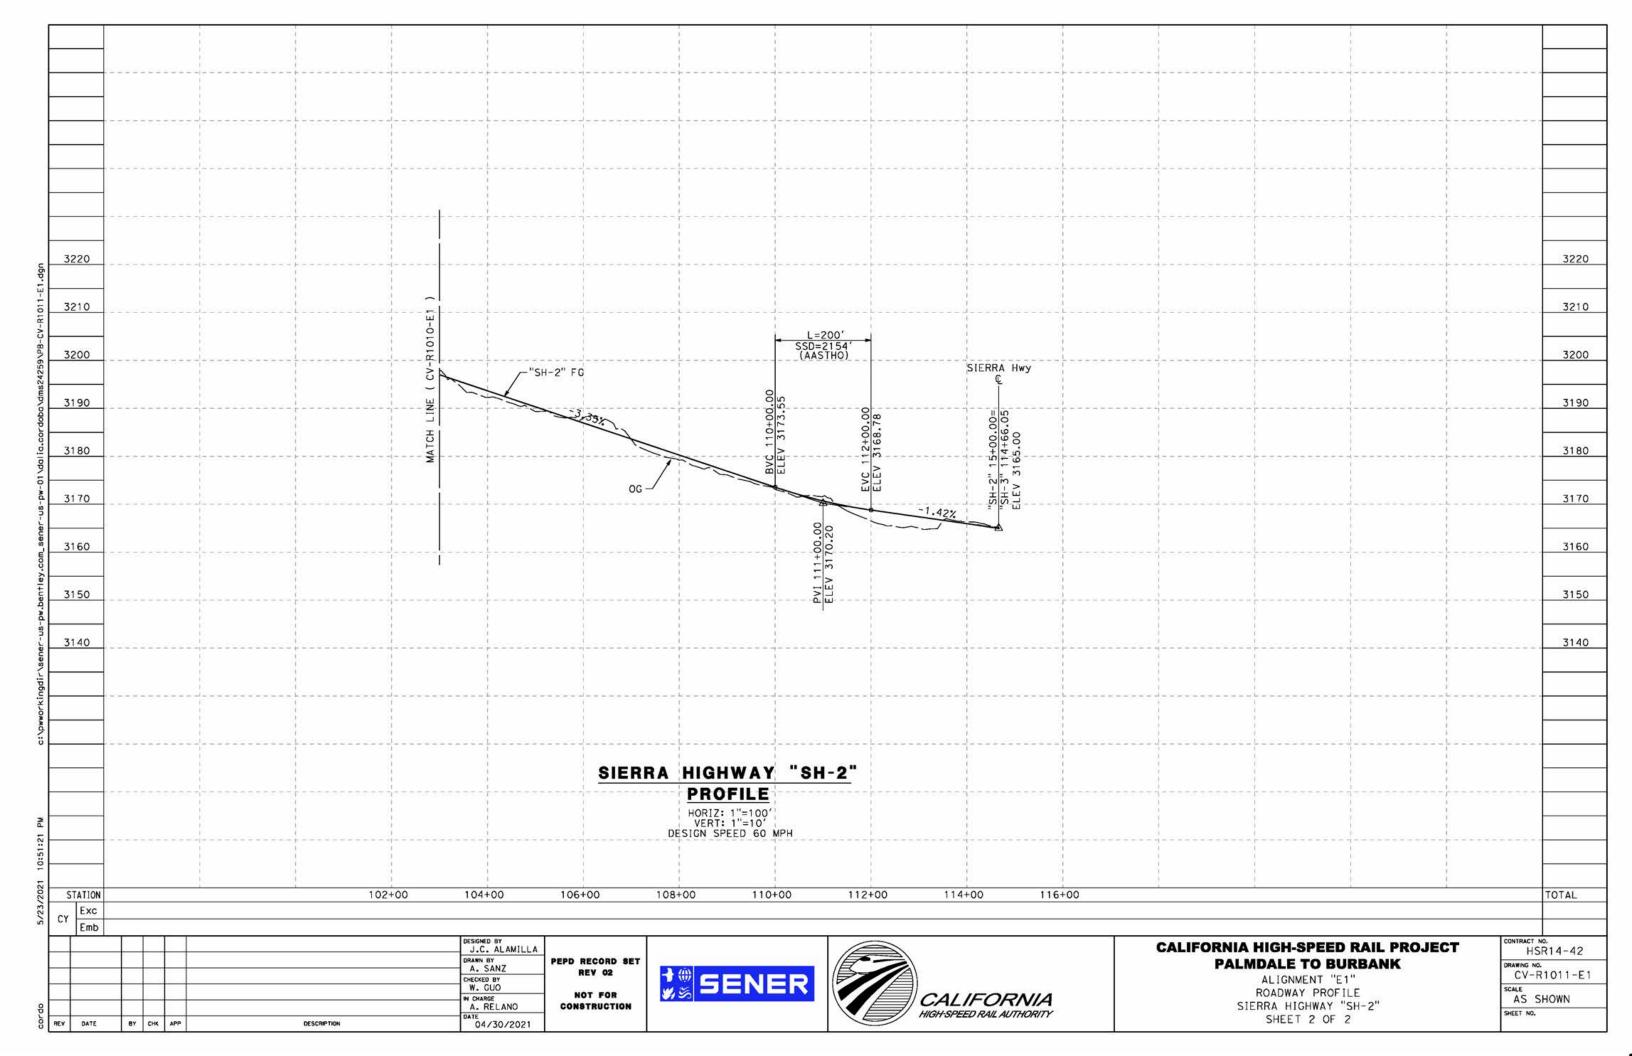


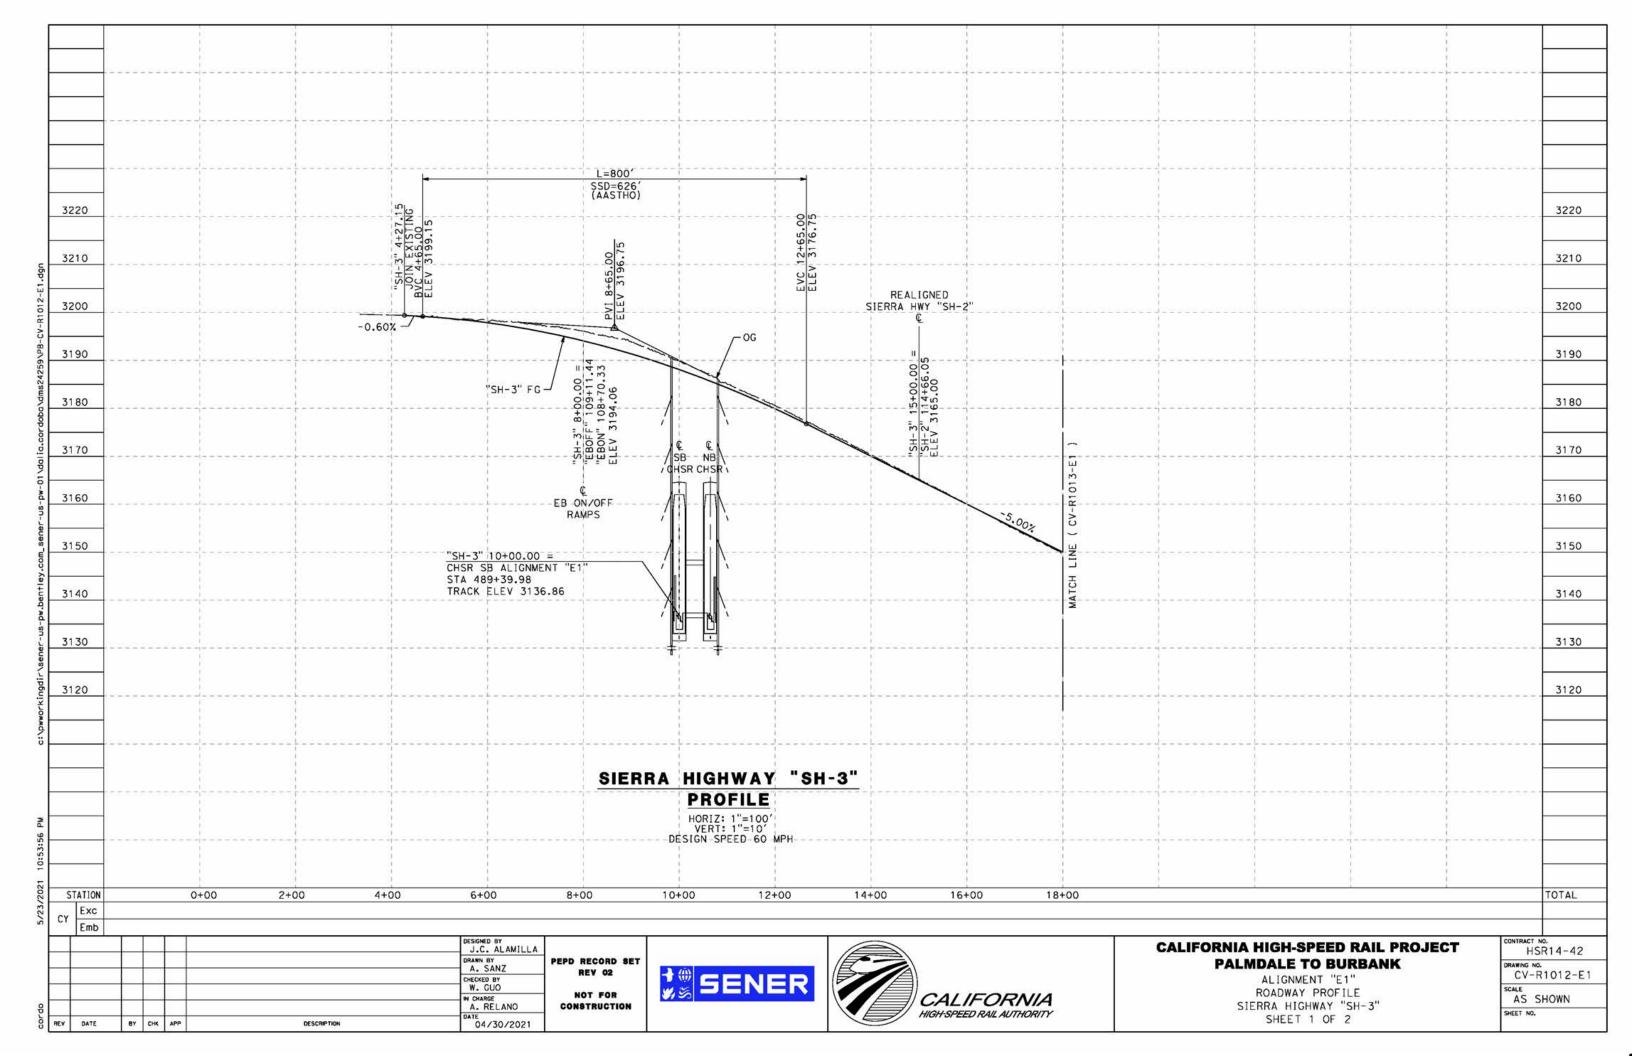


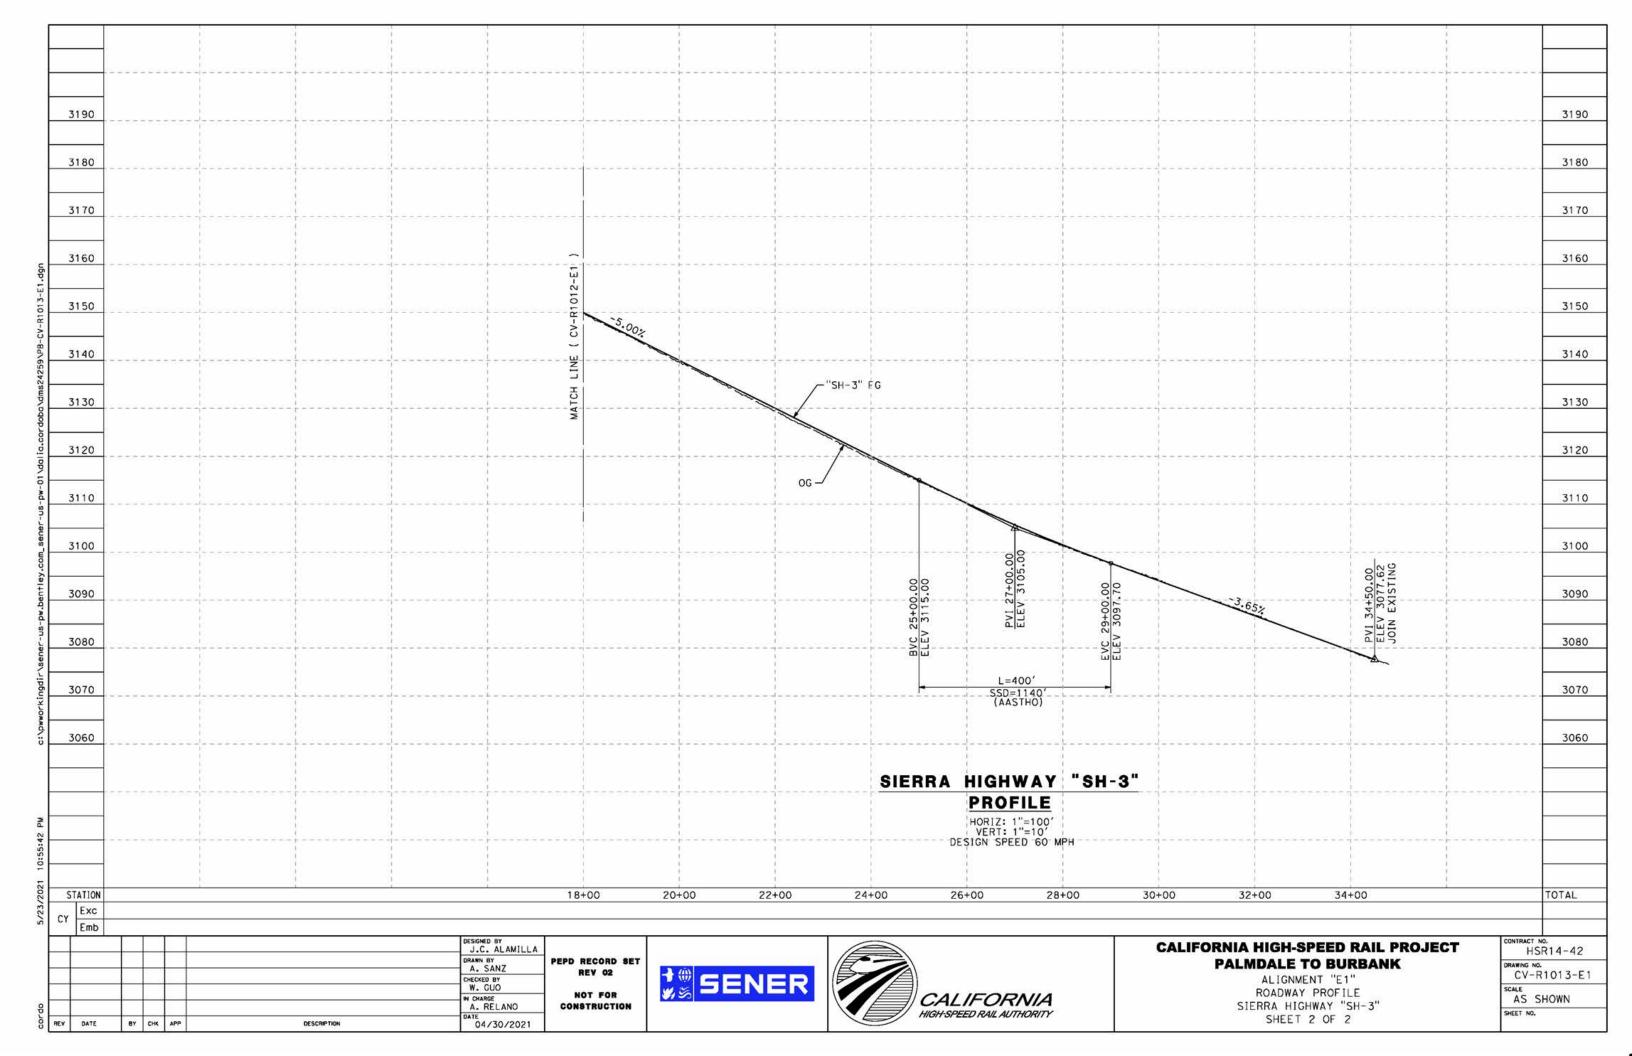


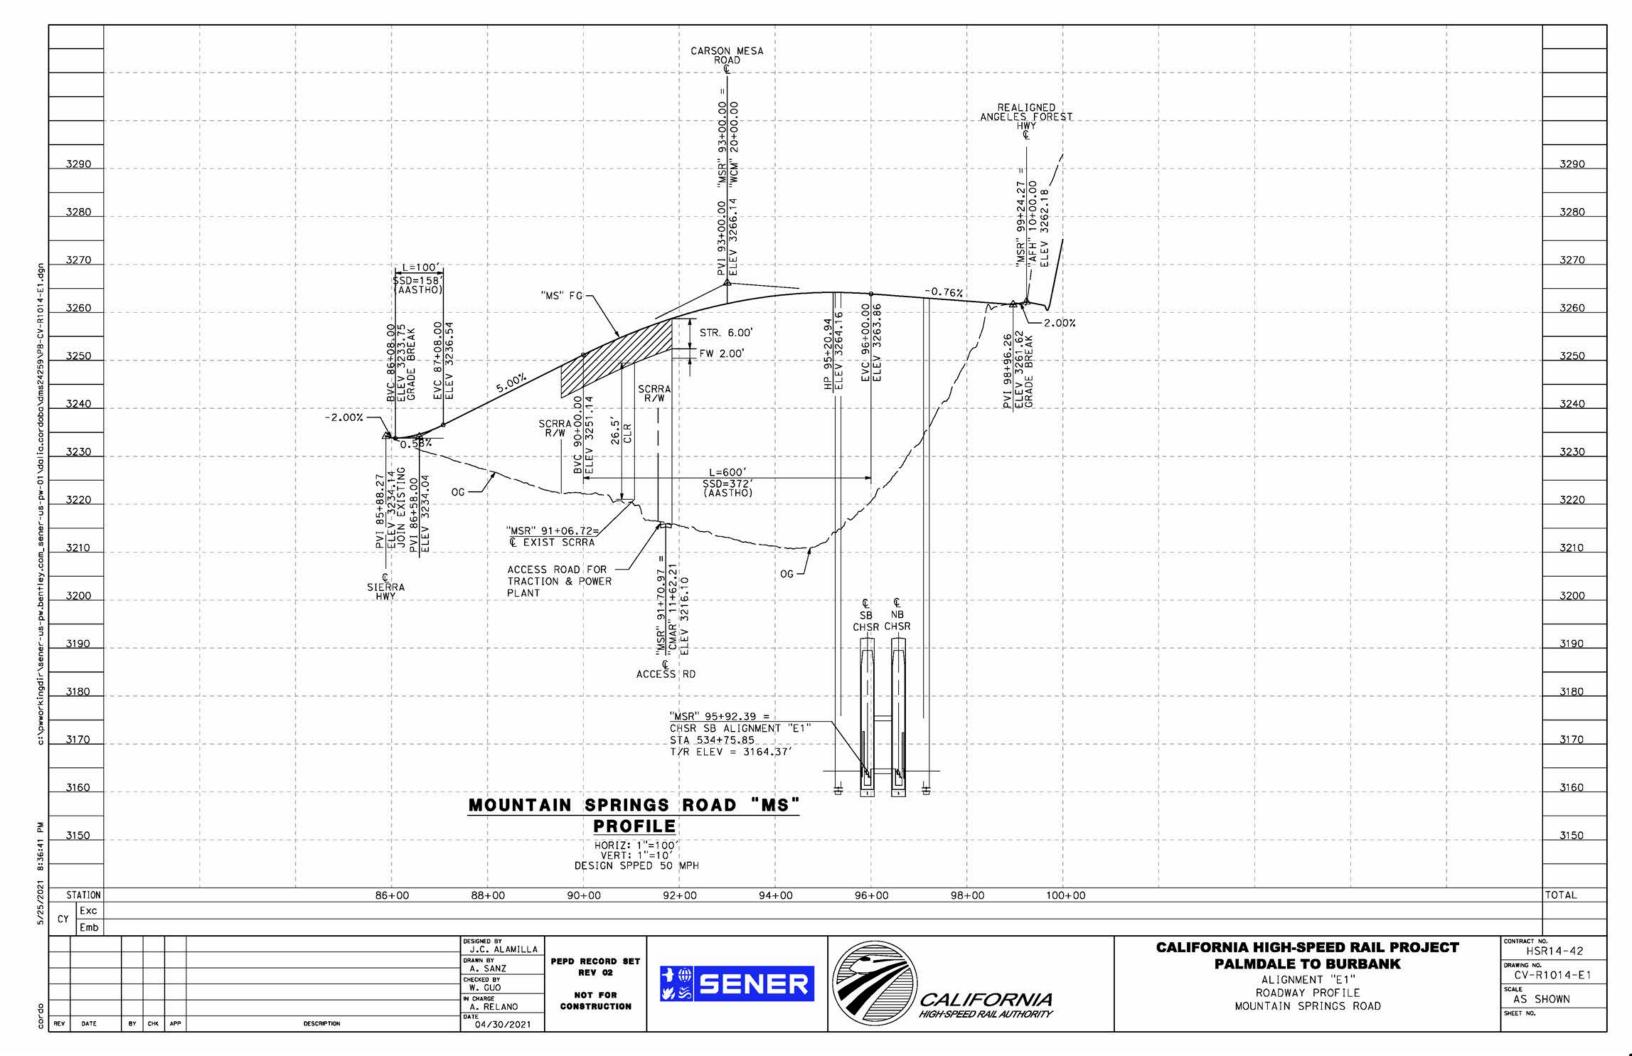


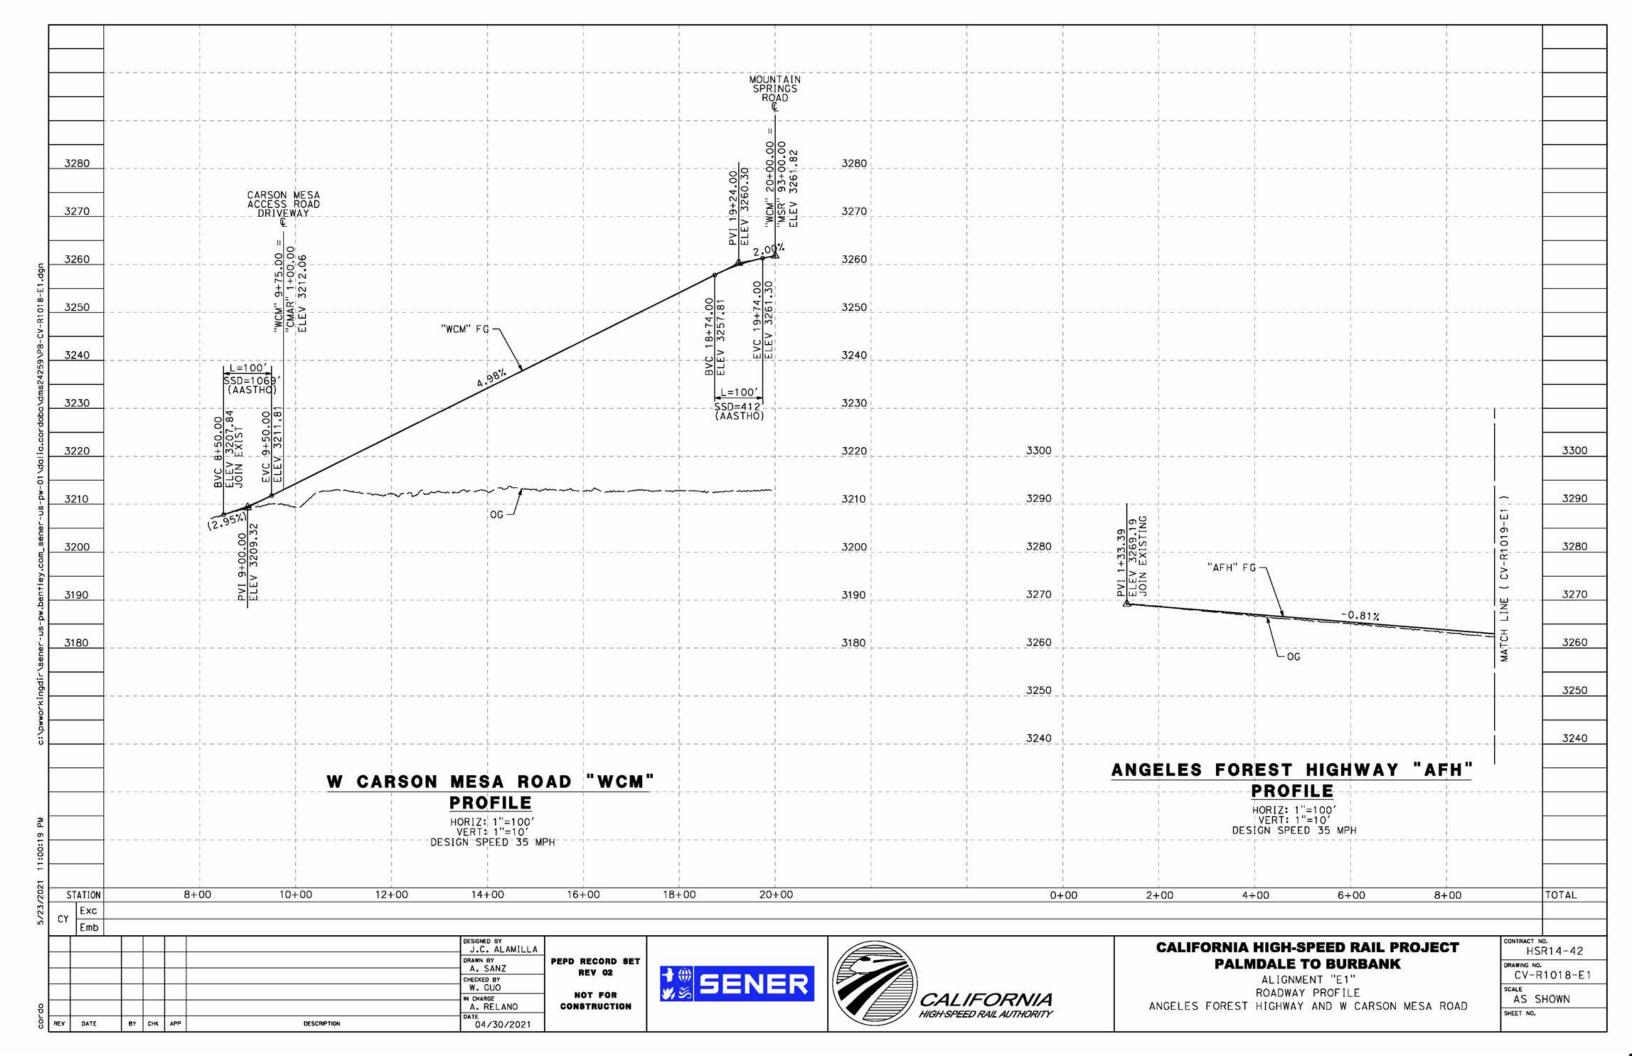


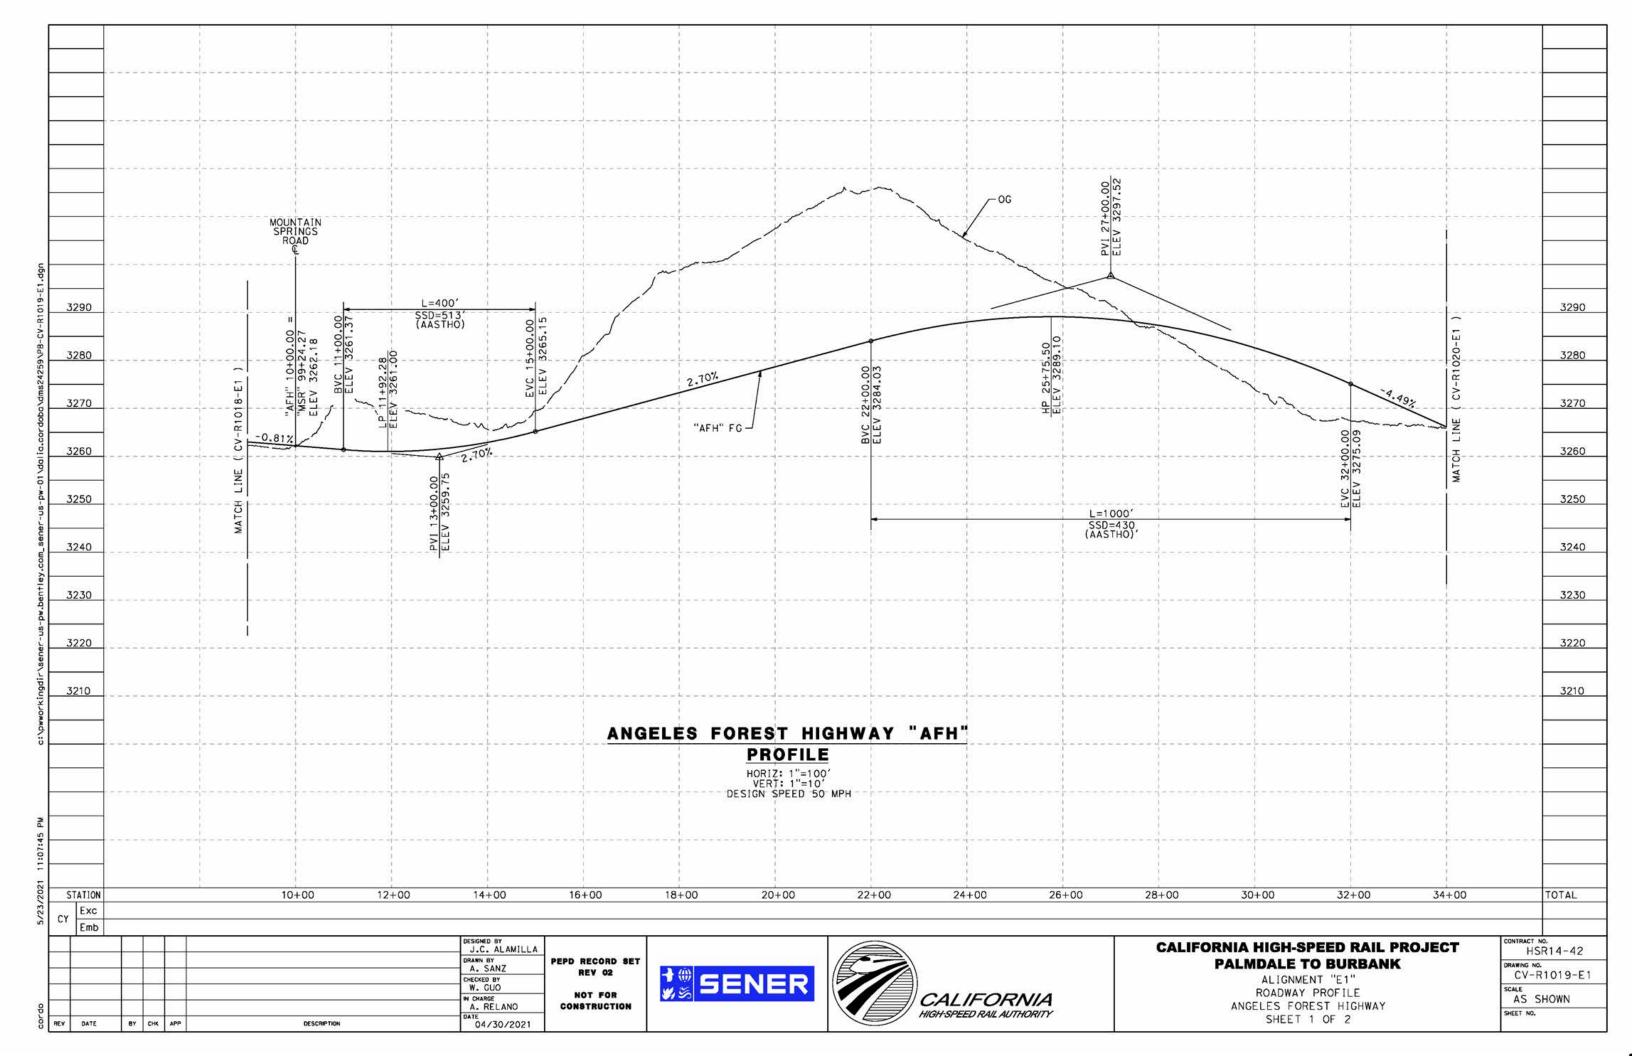


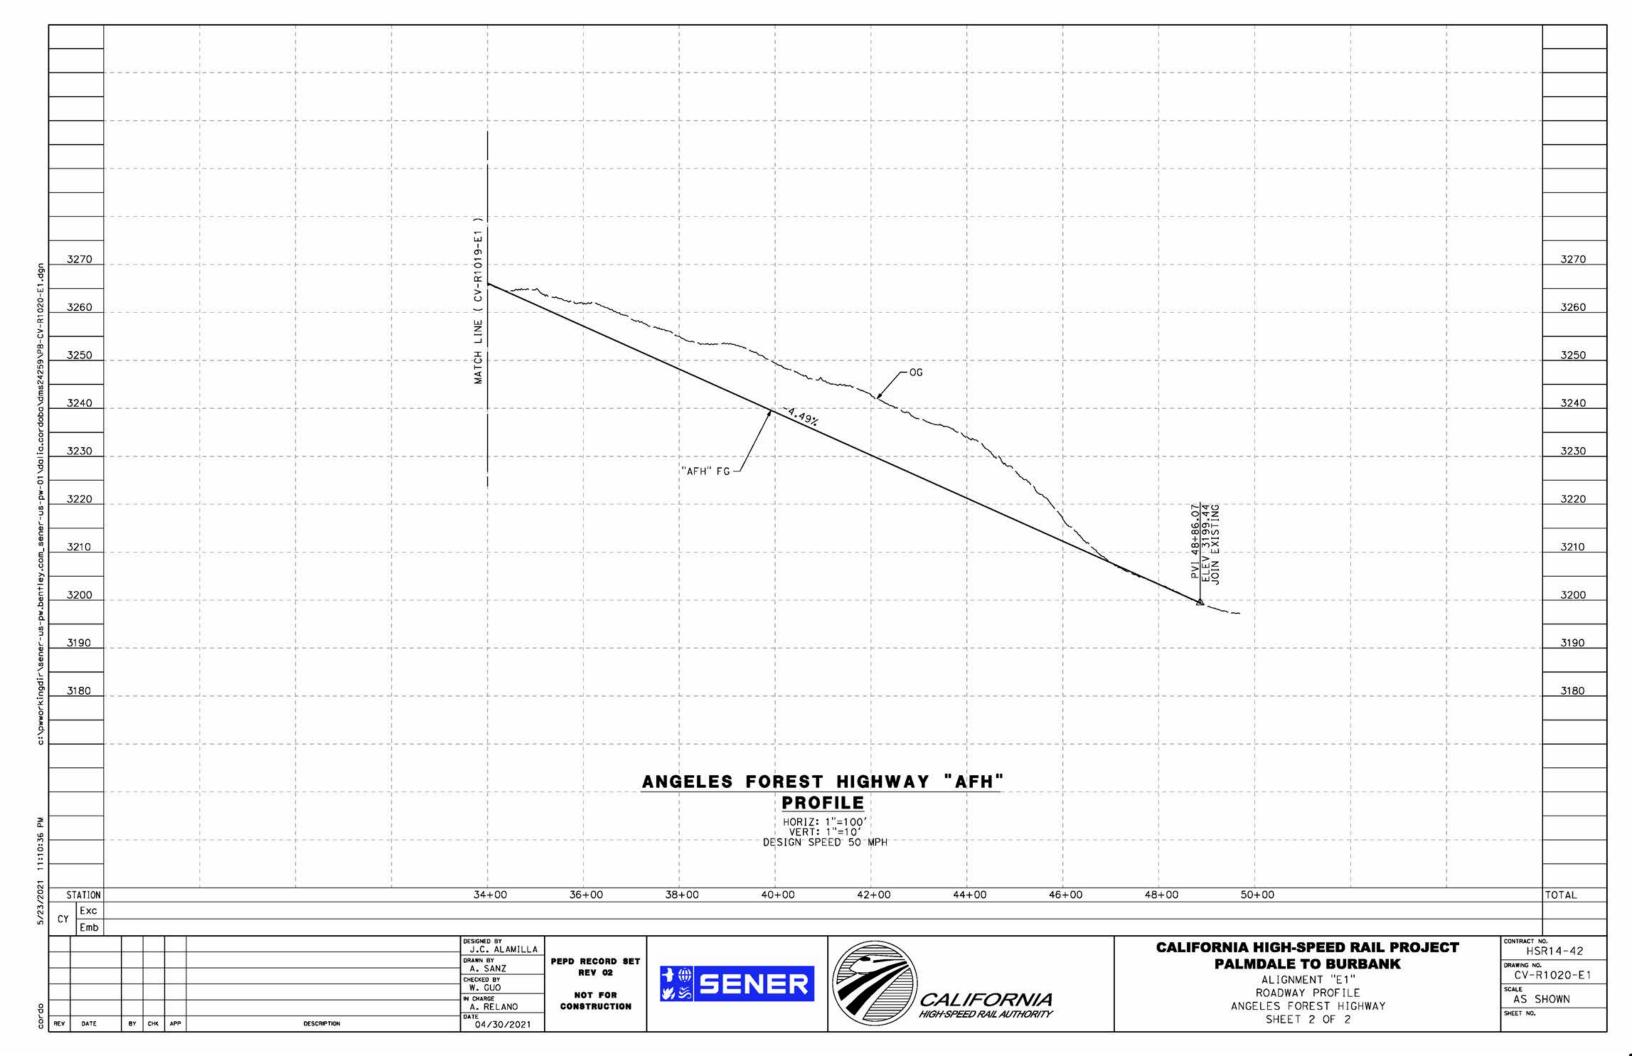


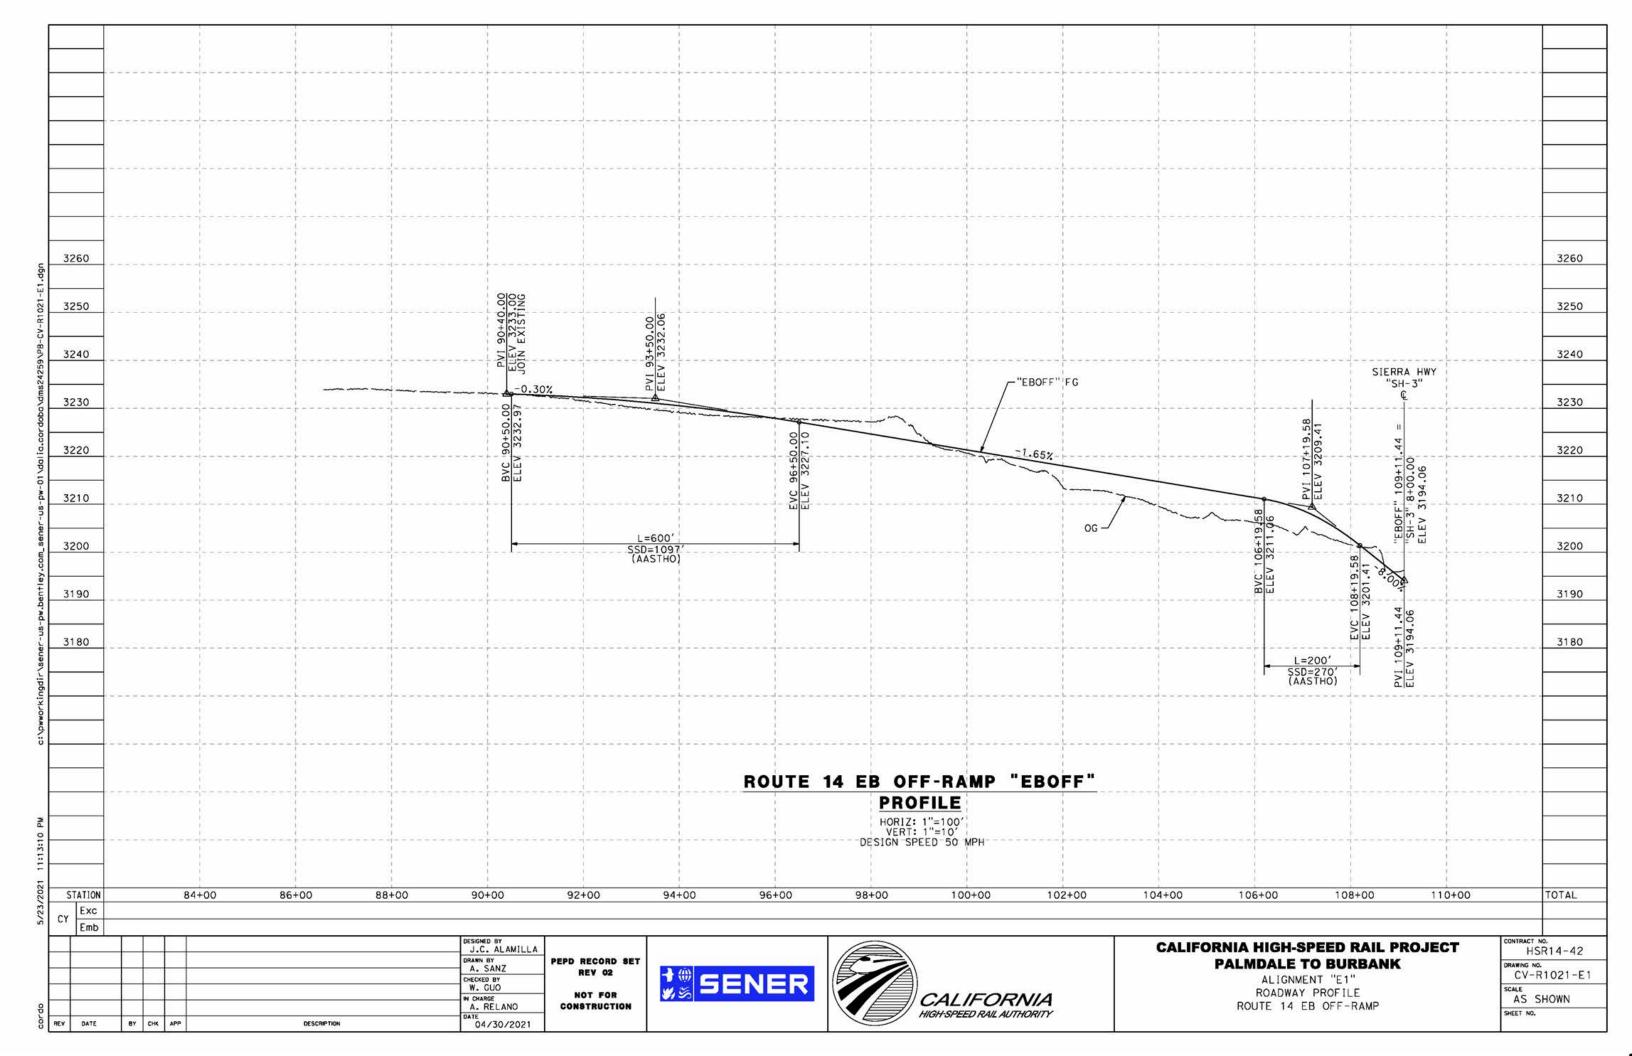


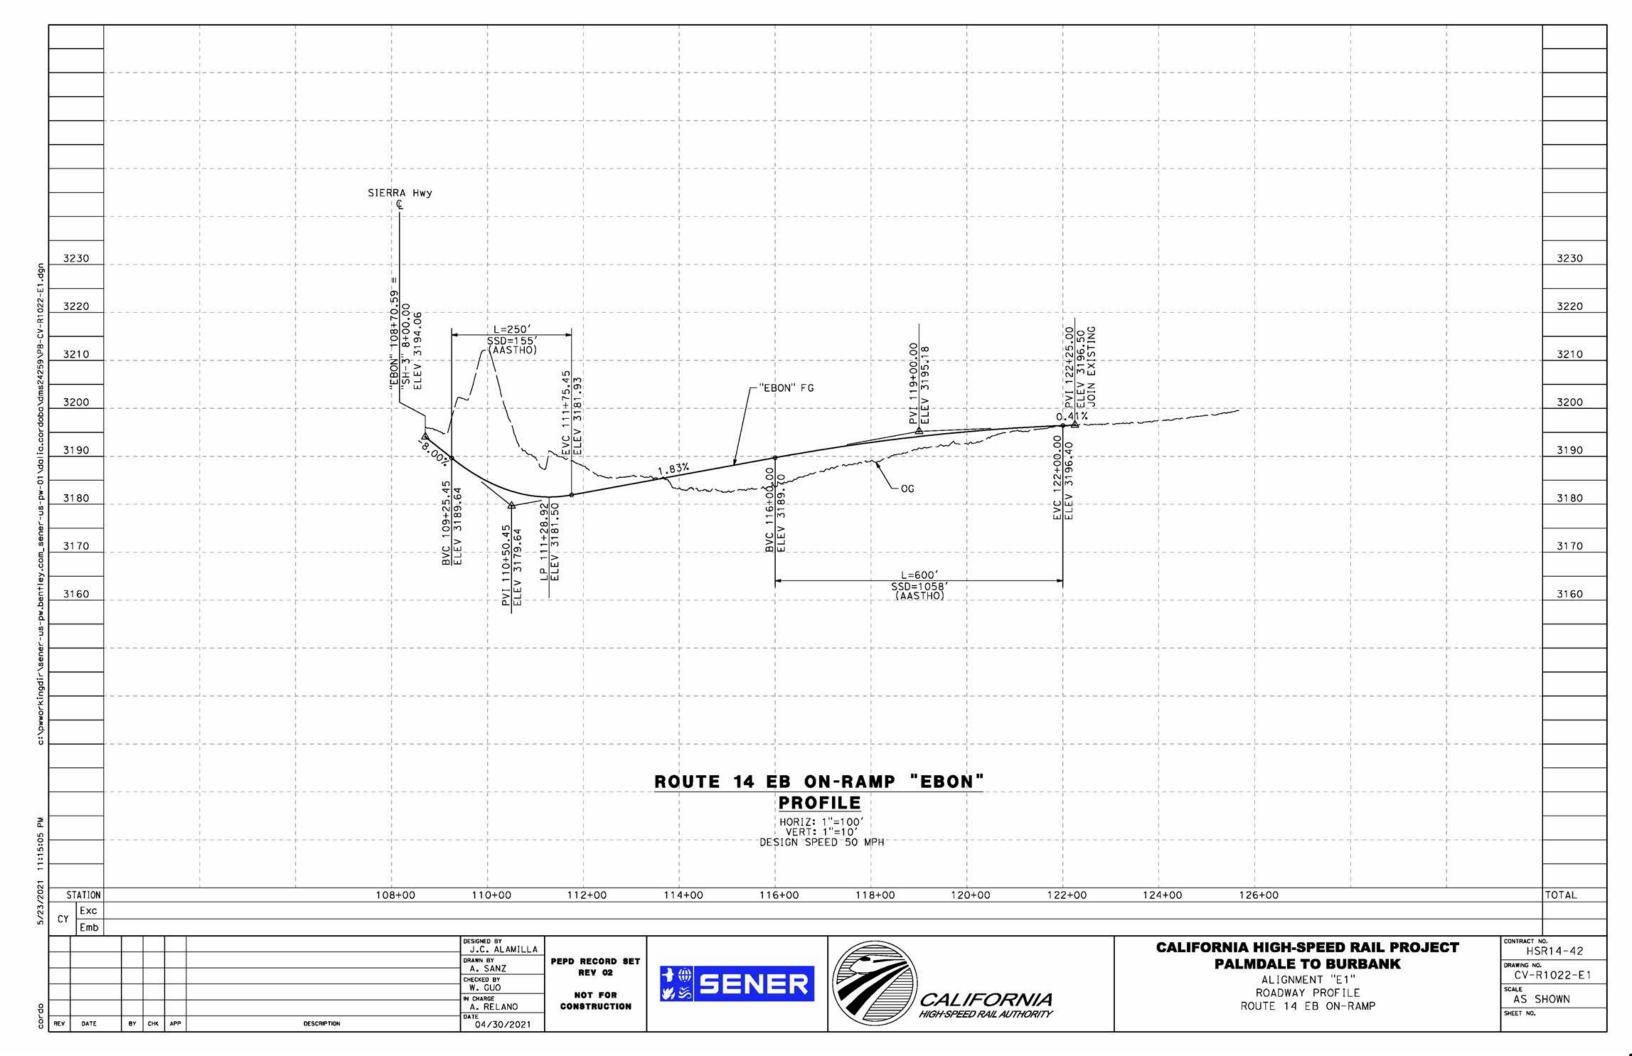


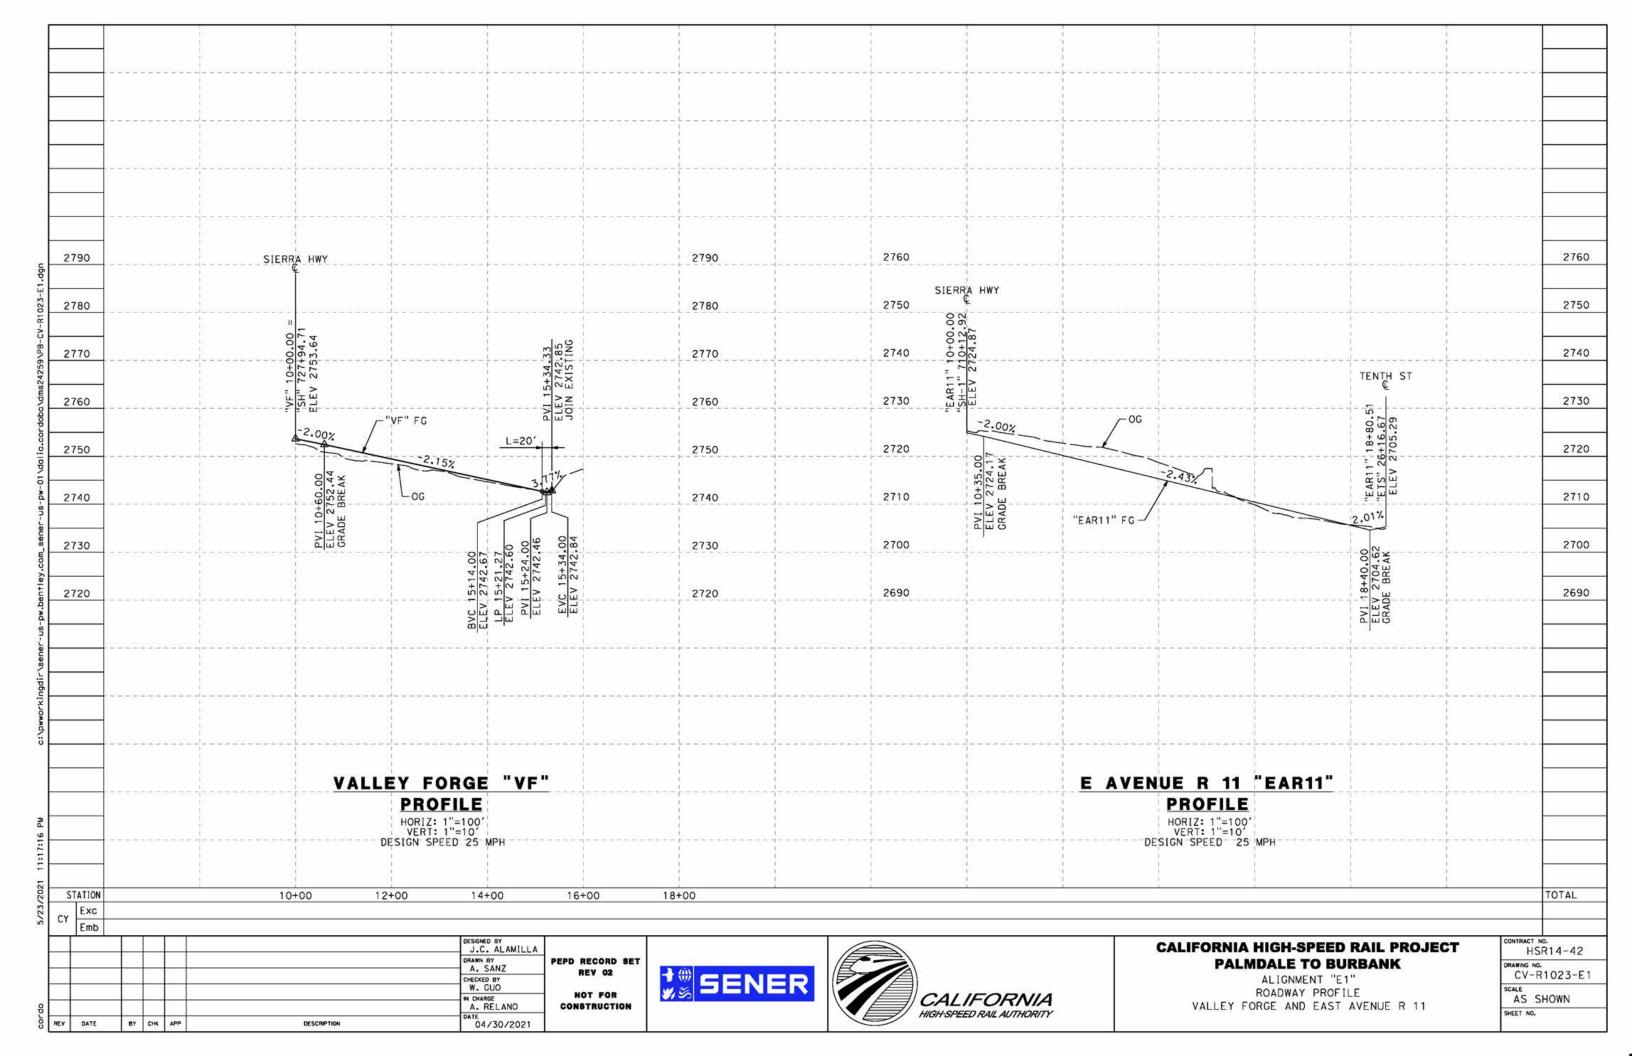


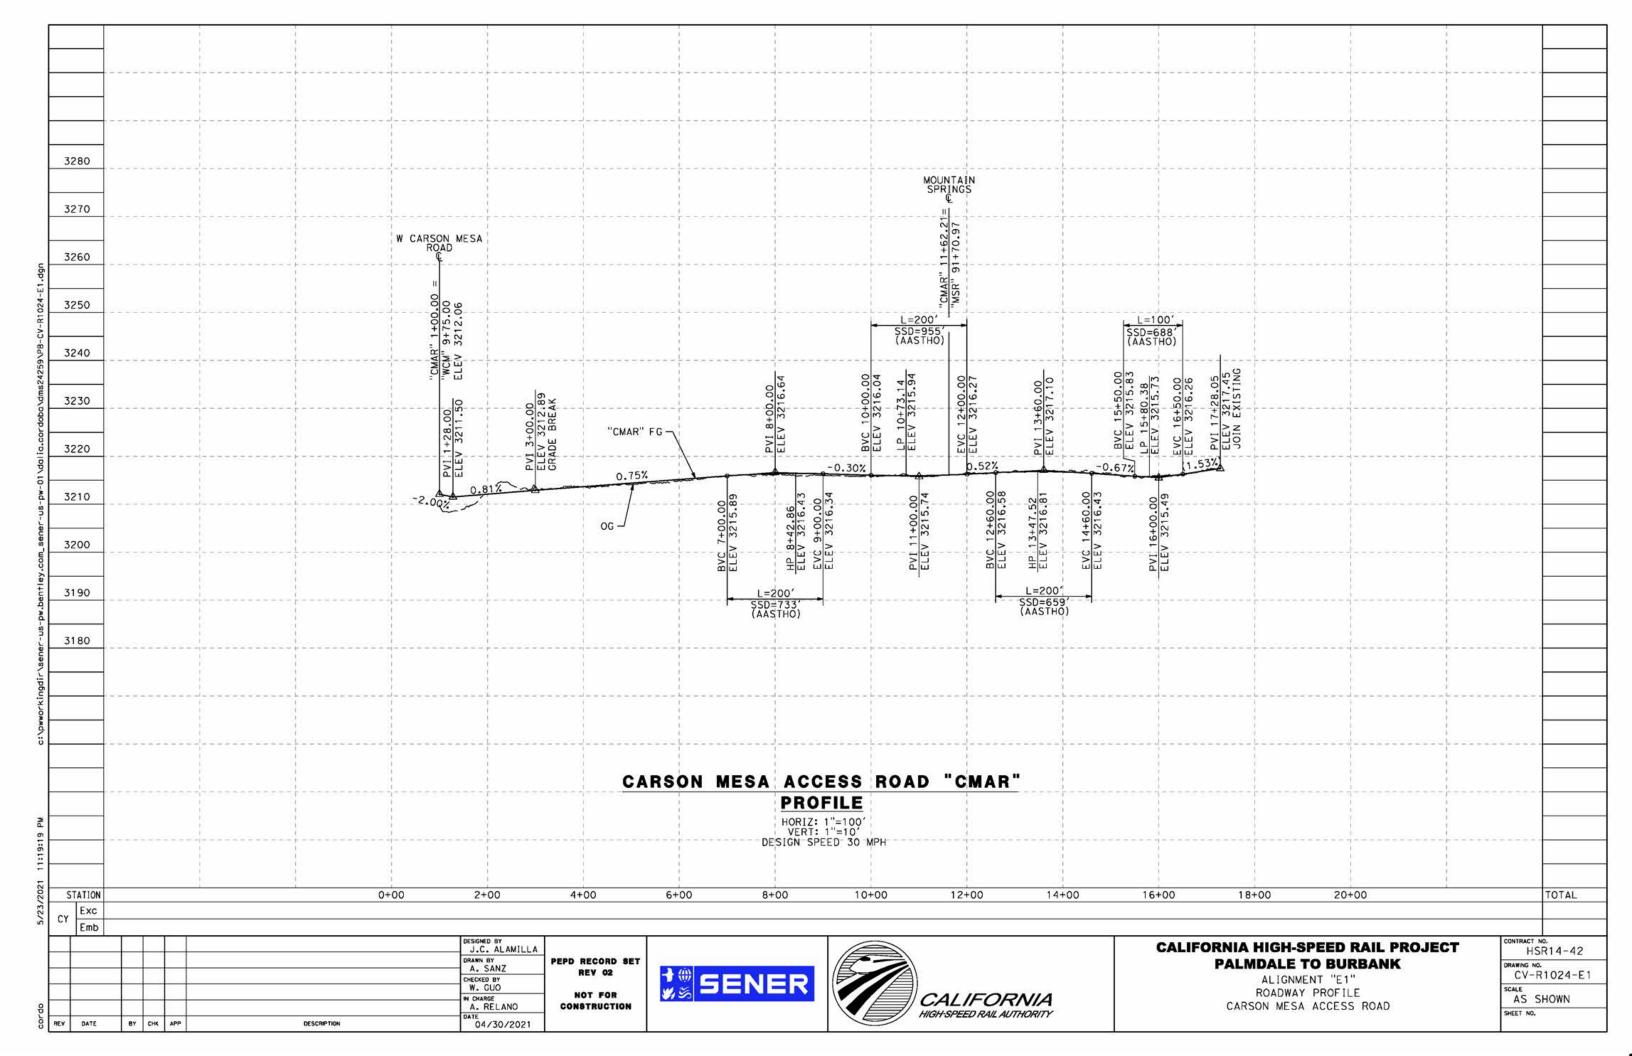


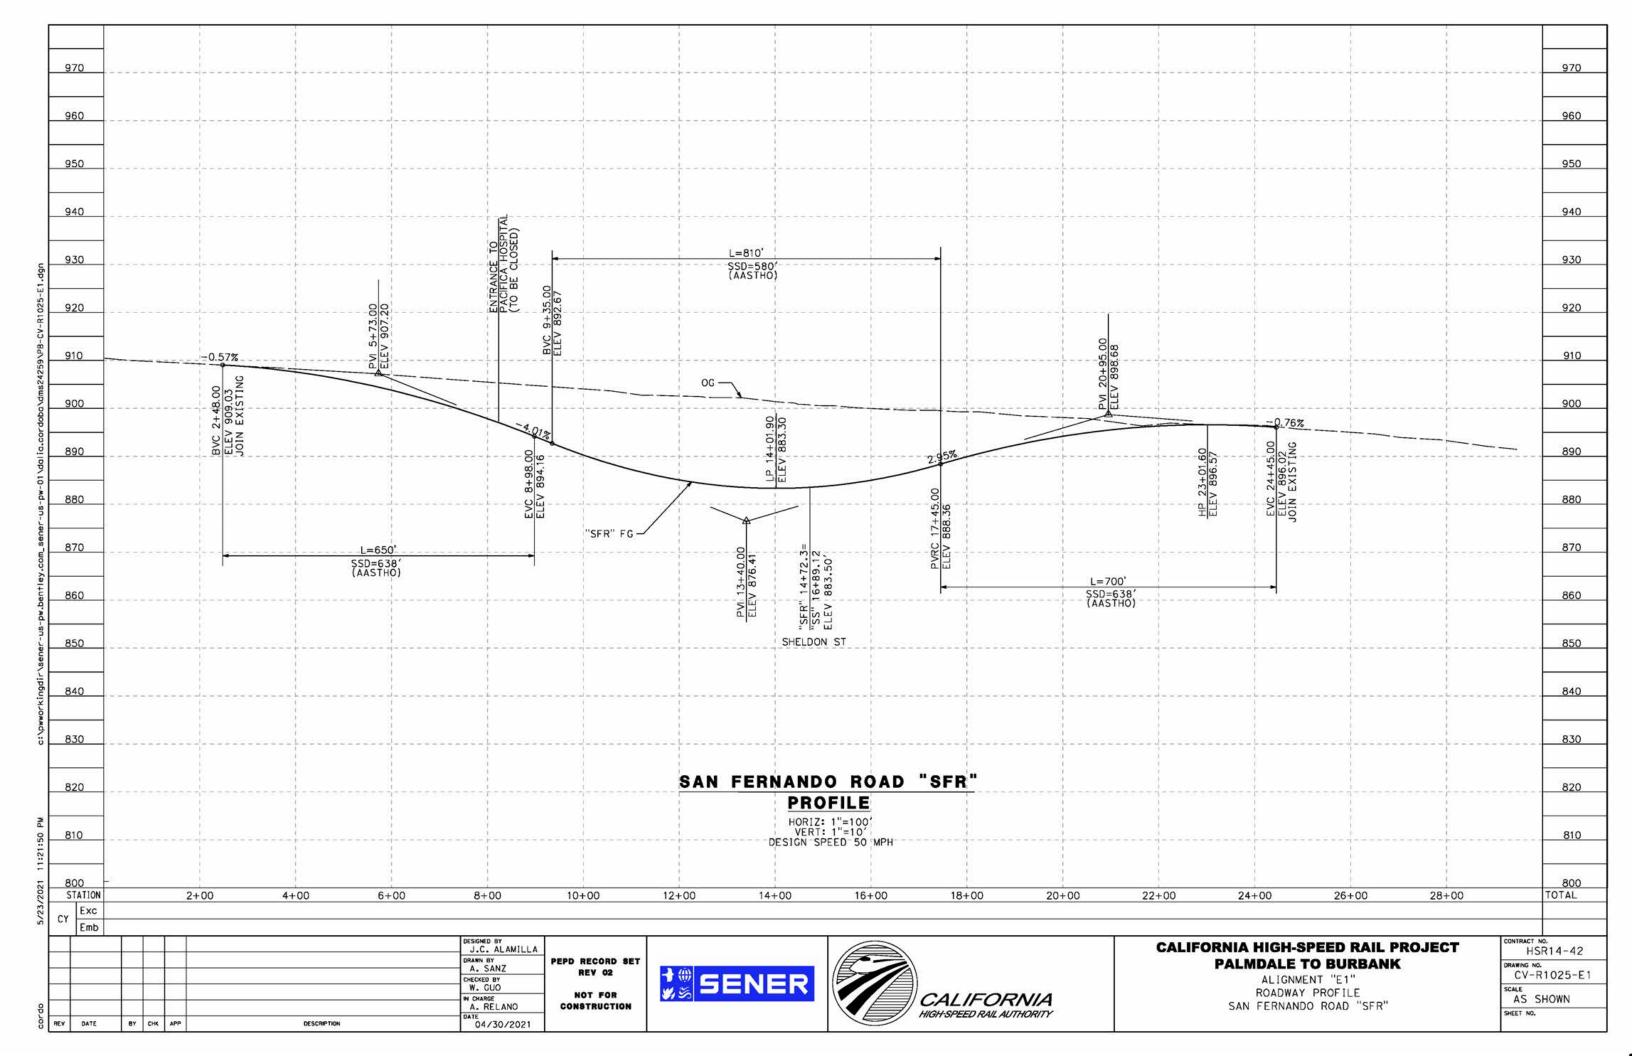


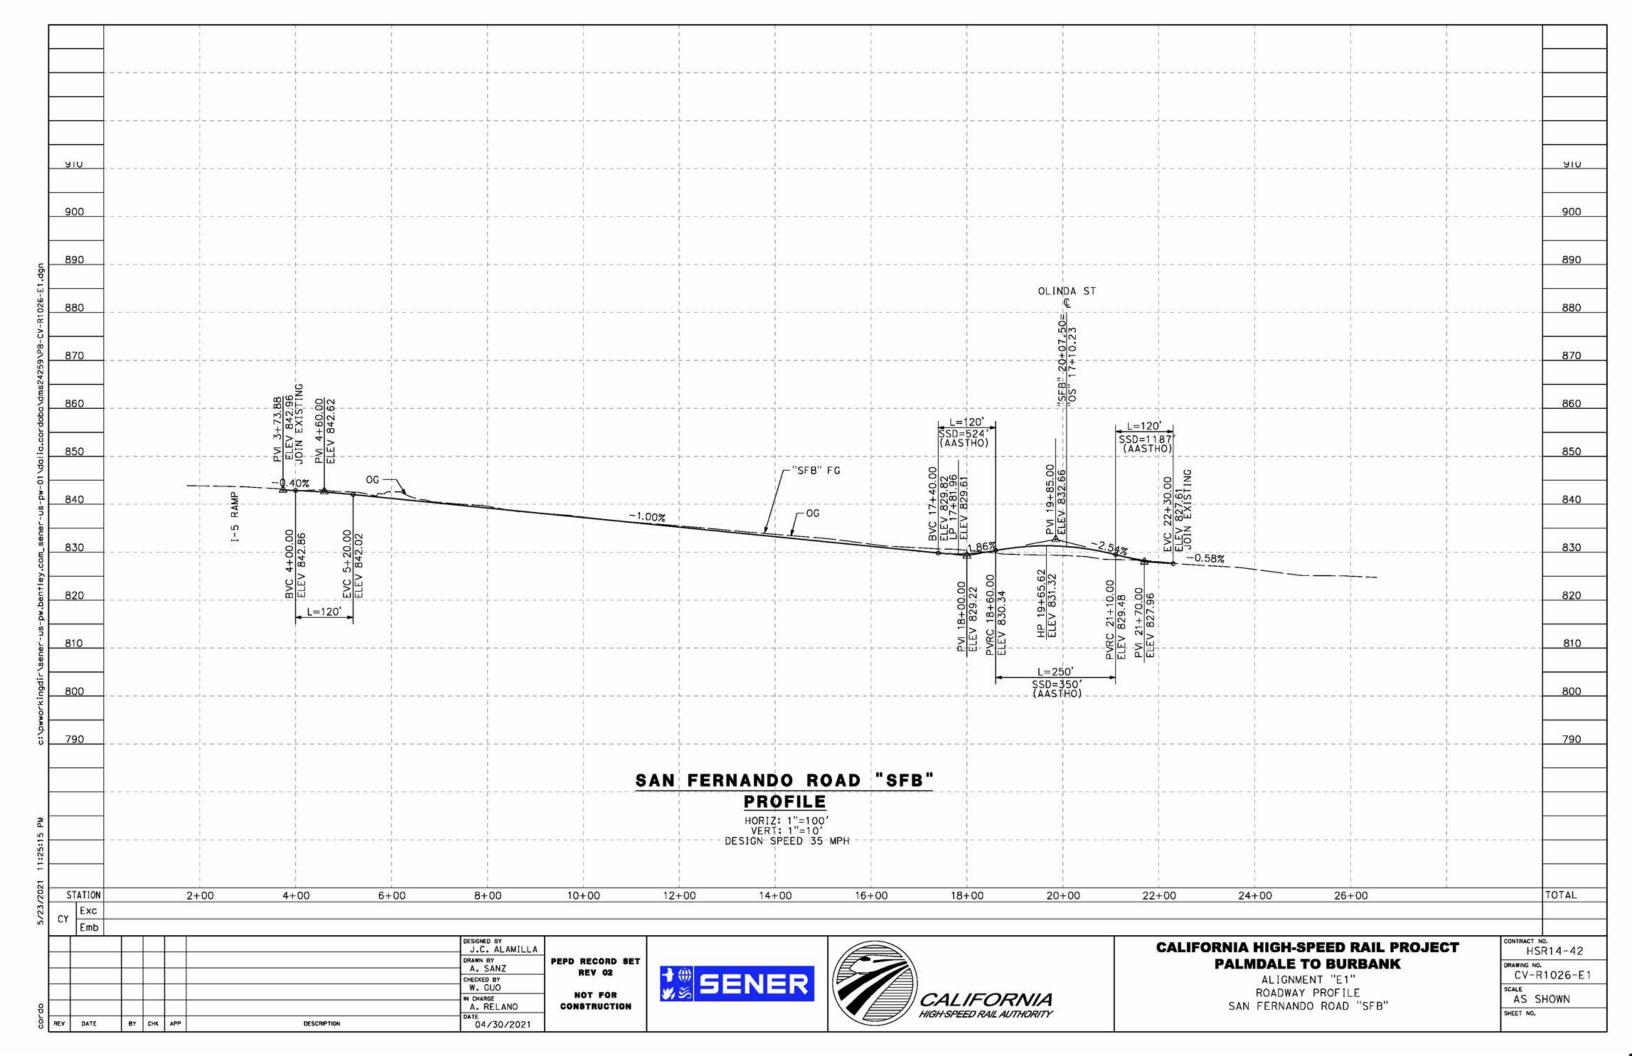


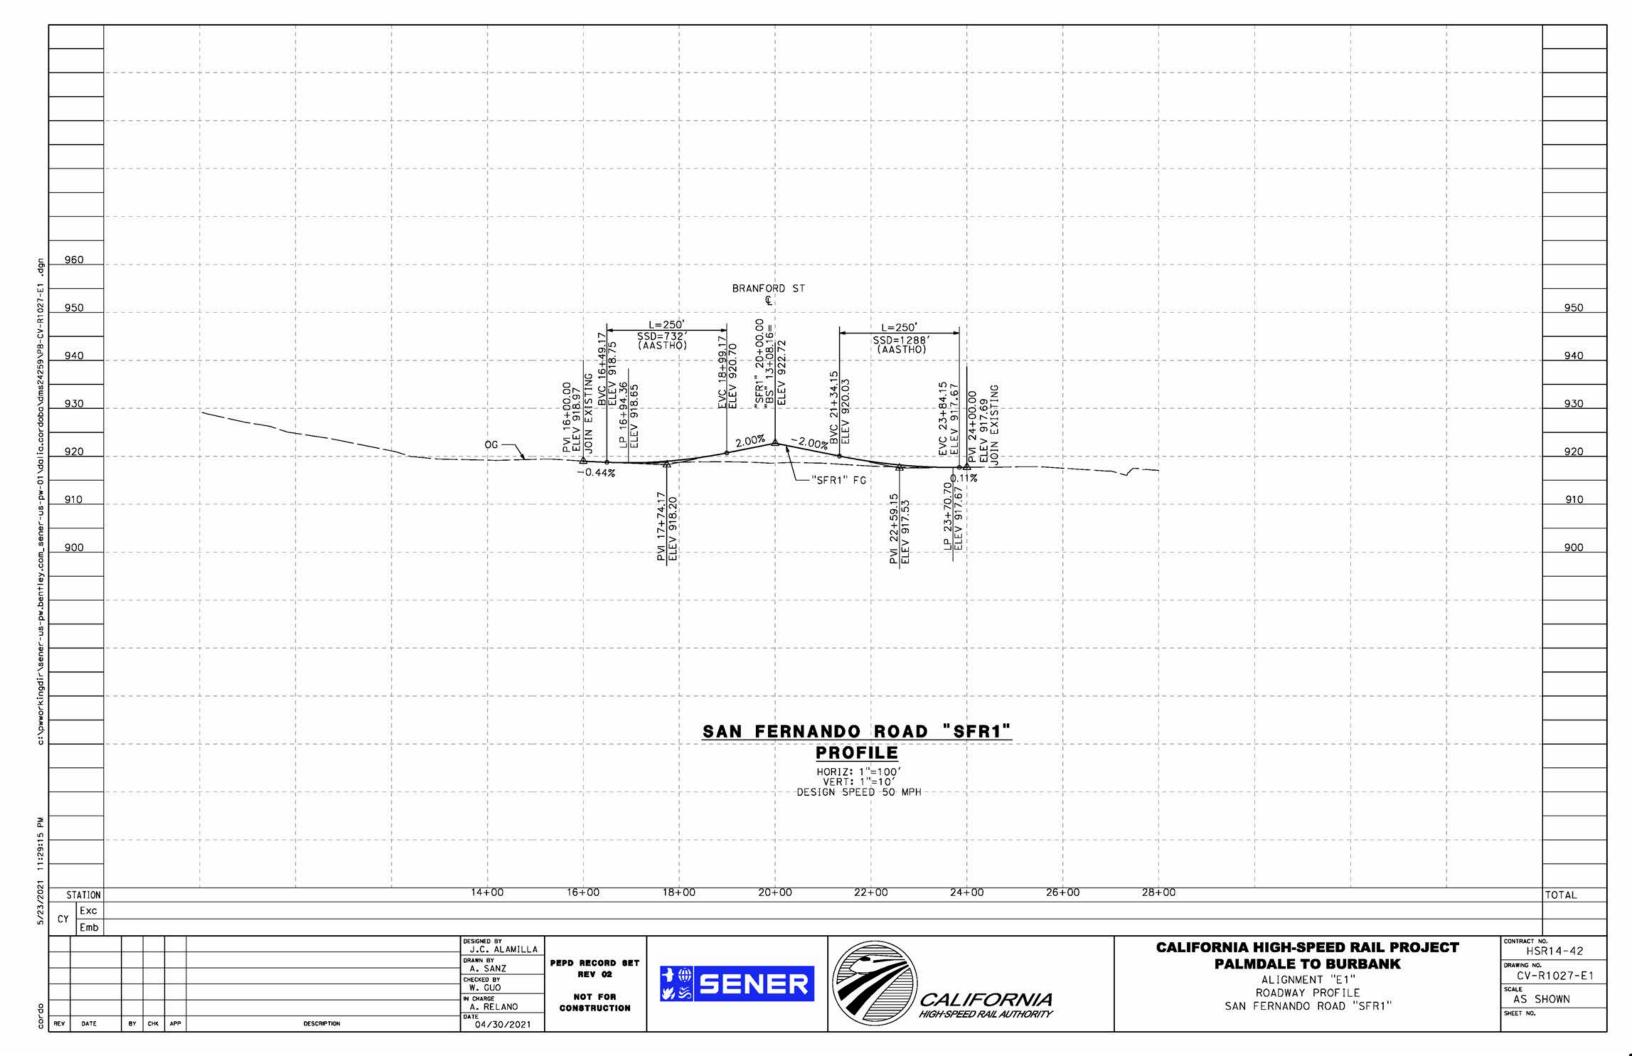

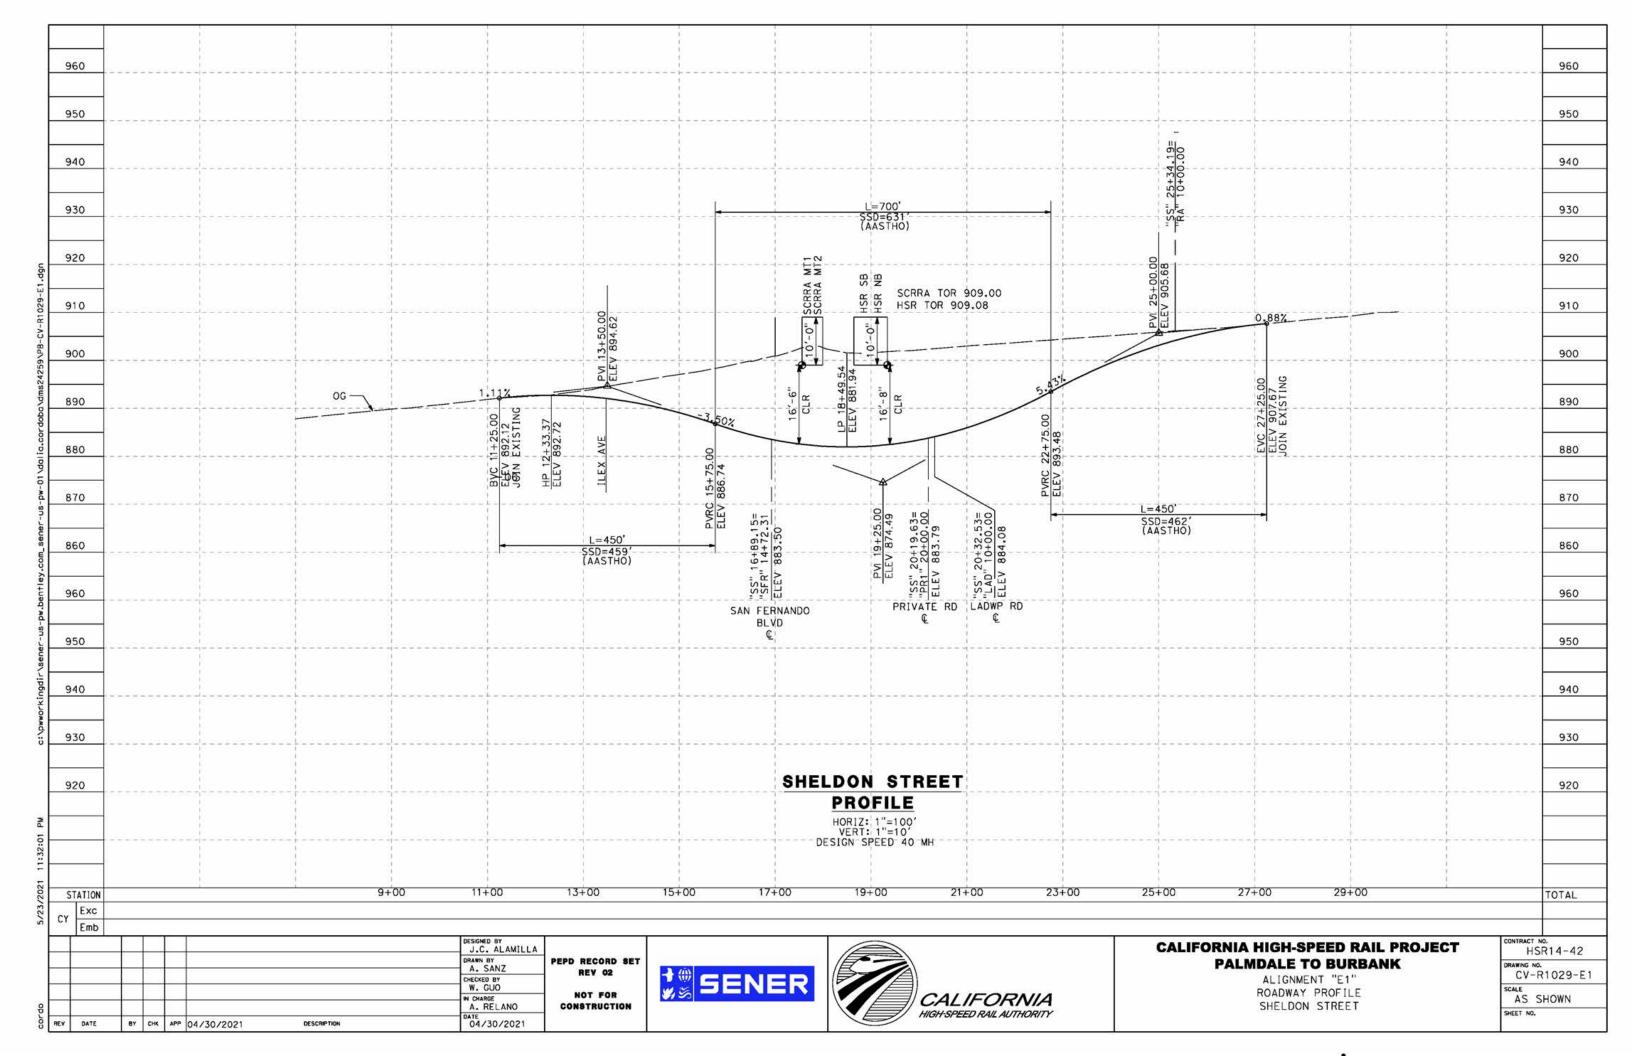

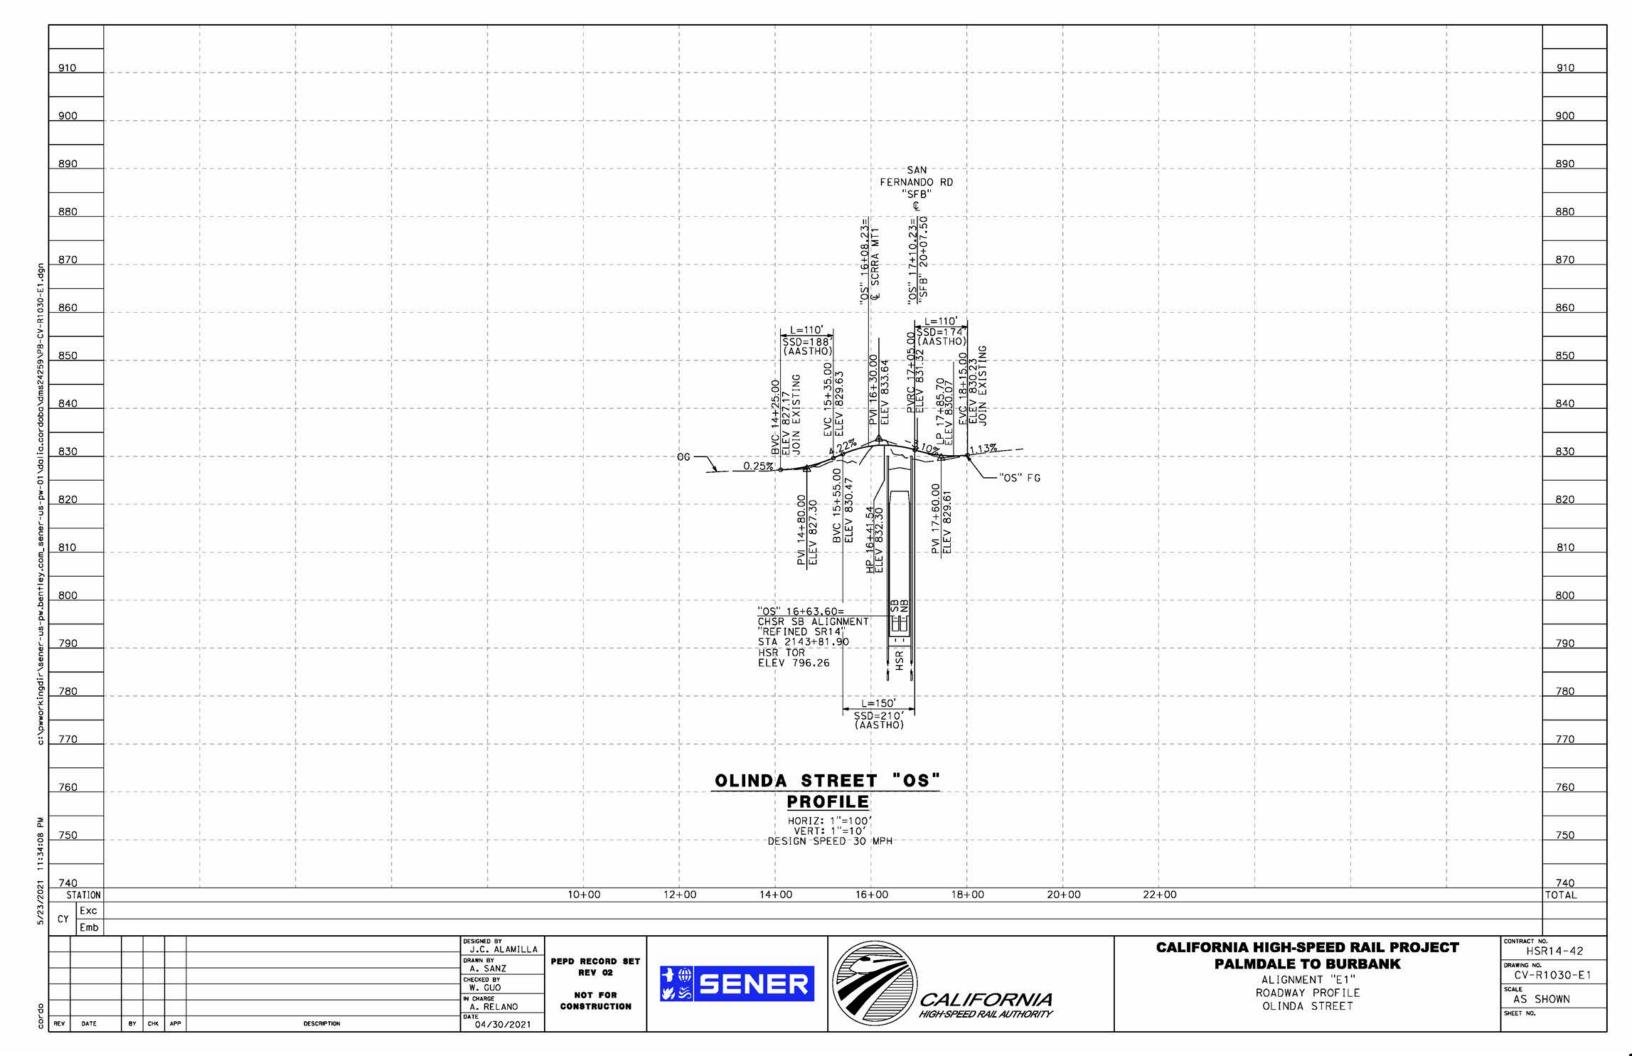

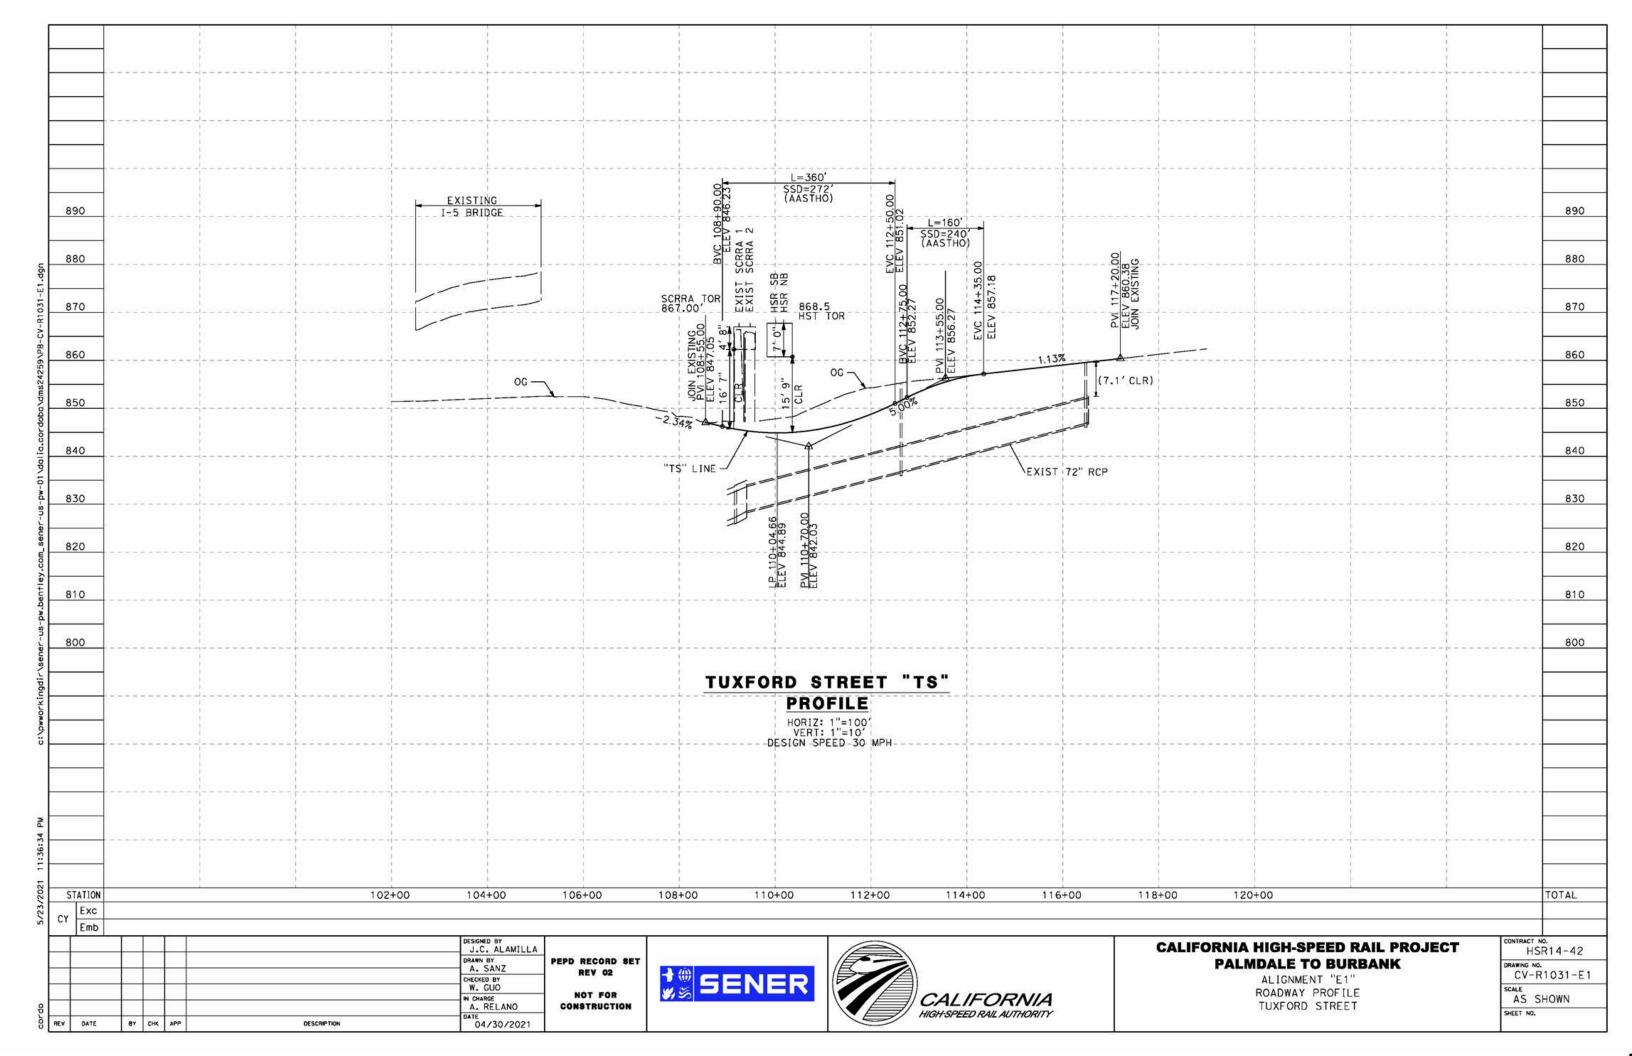

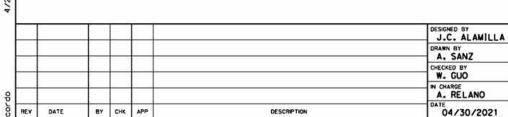

R/W

BENCH (TYP)

-OG

PEPD RECORD SET REV 02 NOT FOR CONSTRUCTION

04/30/2021

SENER



CALIFORNIA HIGH-SPEED RAIL PROJECT PALMDALE TO BURBANK

ALIGNMENT "E1" TYPICAL SECTIONS SIERRA HIGHWAY SHEET 1 OF 2

HSR14-42 RAWING NO. CV-R3001-E1 NO SCALE

SHEET NO.

SIERRA HIGHWAY

NB LANE SB LANE

OR SUPER OR SUPER


R/W

30'

STA 728+50 TO 775+12 MAJOR ARTERIAL (B1) PER CITY OF PALMDALE GENERAL PLAN

VAR 31' TO 187.5'

10' DITCH

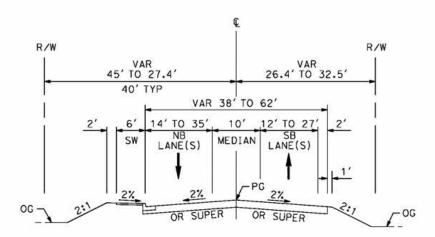

SIERRA HIGHWAY

STA 708+63 TO STA 728+50 MAJOR ARTERIAL (B1) PER CITY OF PALMDALE GENERAL PLAN



R/W

VAR 54.5'-64.5'

SB LANE

VAR

VAR 37'-40'

OR SUPER

OR SUPER

10'

OR SUPER

R/W

2:1 CUT OR FILL

og ブ

88'

12'

SIERRA HIGHWAY

STA 8+00 TO STA 34+50 MAJOR HIGHWAY PER LOS ANGELES COUNTY MASTER PLAN OF HIGHWAYS

VAR VAR VAR 12' TO 14' 12'

/-PG

SHLD SB LANE SB LANE MEDIAN NB LANE NB LANE SHLD

SIERRA HIGHWAY

STA 4+27 TO STA 8+00 MAJOR HIGHWAY PER LOS ANGELES COUNTY MASTER PLAN OF HIGHWAYS

12'

OR SUPER

SB LANE MEDIAN NB LANE NB LANE

					DESIGNED BY J.C. ALAMILLA DRAWN BY A. SANZ CHECKED BY W. GUO IN CHARGE	PEPD RECORD SET	NOT FOR	CALIFORNIA HIGH-SPEED RAIL AUTHORITY	CALIFORNIA HIGH-SPEED RAIL PROJECT PALMDALE TO BURBANK ALIGNMENT "E1" TYPICAL SECTIONS SIERRA HIGHWAY SHEET 2 OF 2	CONTRACT NO. HSR14-42 DRAWING NO. CV-R3002-E1 SCALE NO. SCALE
DATE	BY	СНК	APP	DESCRIPTION	A. RELANO DATE 04/30/2021	NOT FOR CONSTRUCTION				NO SCALE

R/W

-2:1 CUT OR FILL

√oc

R/W

OR FILL

₹ oc

VAR 48.3'-58.3'

VAR


VAR 36'-38'

OR SUPER


10'

SHLD

OR SUPER

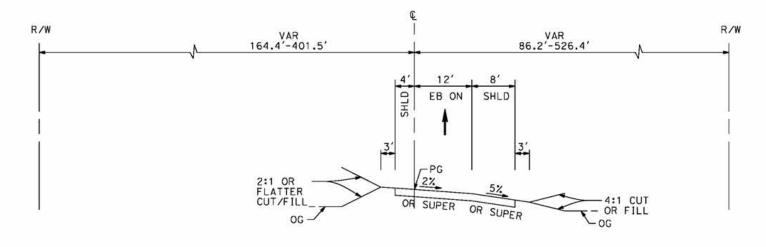

ROUTE 14 EB ON-RAMP STA 109+30 TO STA 122+25

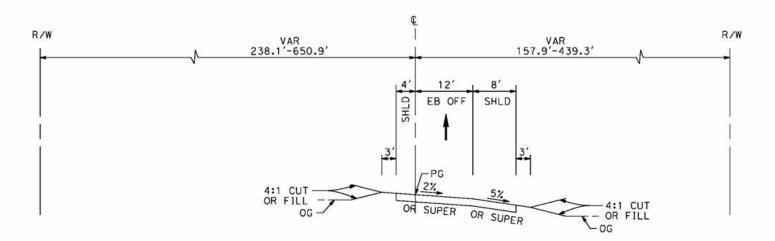

ROUTE 14 EB OFF-RAMP

STA 90+40 TO STA 108+68

[J.C. ALAMILLA	
-			\perp				DRAWN BY A. SANZ	PEPD RECORD SET
1	-		-	-			W. GUO	REV Q2
8			1	-	Н		IN CHARGE A. RELANO	NOT FOR CONSTRUCTION
Sor	REV	DATE	BY	CHK	APP	DESCRIPTION	04/30/2021	CONGINGUION






CALIFORNIA HIGH-SPEED RAIL PROJECT PALMDALE TO BURBANK


ALIGNMENT "E1" TYPICAL SECTIONS ROUTE 14 EB ON-RAMP AND ROUTE 14 EB OFF-RAMP

DRAWING CV	NO. -R3003-E1
SCALE	N3003 E
NO	SCALE

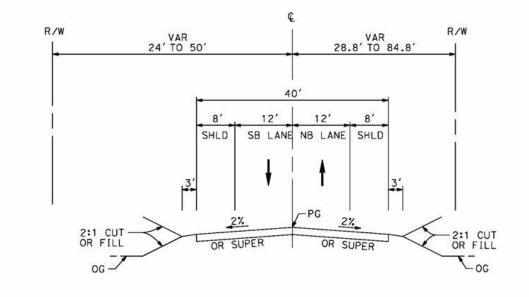

SIERRA HIGHWAY

STA 86+80 TO STA 114+66 MAJOR HIGHWAY
PER LOS ANGELES COUNTY
MASTER PLAN OF HIGHWAYS

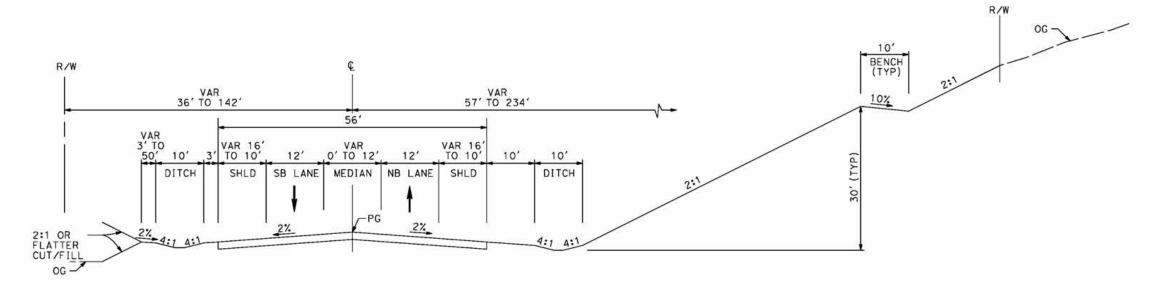

ANGELES FOREST HIGHWAY

STA 1+33 TO STA 48+86 MAJOR HIGHWAY PER LOS ANGELES COUNTY MASTER PLAN OF HIGHWAYS

						DESIGNED BY J.C. ALAMILLA	
	Ш		\perp			DRAWN BY A. SANZ	PE
	Н		+	-	-	CHECKED BY W. GUO	
e	\vdash		+	-	\vdash	IN CHARGE A. RELANO	
corc	REV	DATE	BY	СНК	APP	DESCRIPTION DATE 04/30/2021	



REV 02

NOT FOR




CALIFORNIA HIGH-SPEED RAIL PROJECT PALMDALE TO BURBANK

ALIGNMENT "E1" TYPICAL SECTIONS SIERRA HIGHWAY AND ANGELES FOREST HIGHWAY


CONTRACT NO. HSR14-42
ORAWING NO. CV-R3004-E1
NO SCALE

SHEET NO.

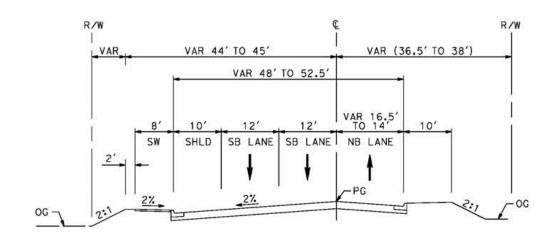


EAST TENTH STREET

STA 22+71 TO STA 32+38 SECONDARY ARTERIAL PER CITY OF PALMDALE GENERAL PLAN

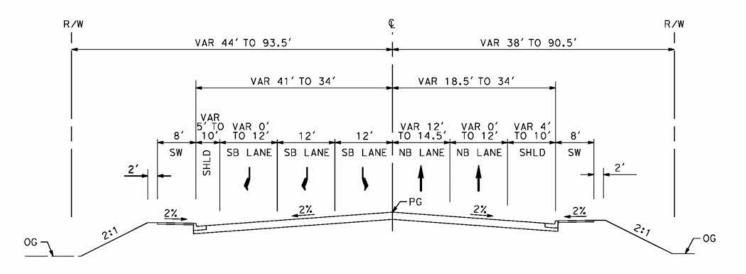

EAST TENTH STREET

STA 10+49 TO STA 22+71 SECONDARY ARTERIAL PER CITY OF PALMDALE GENERAL PLAN

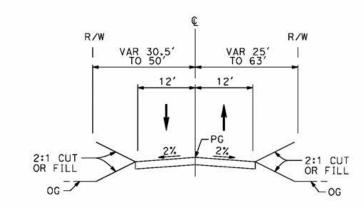

WATER TREATMENT PLANT ACCESS RD 2

STA 0+00 TO STA 8+00

						DESIGNED BY J.C. ALAMILLA	
		\perp				DRAWN BY A. SANZ	PE
		+	-			W. GUO	
		+				IN CHARGE A. RELANO	
REV	DATE	BY	CHK	APP	DESCRIPTION	DATE 04/30/2021	3,

PEPD RECORD SET REV 02 NOT FOR CONSTRUCTION






CALIFORNIA HIGH-SPEED RAIL PROJECT PALMDALE TO BURBANK

ALIGNMENT "E1" TYPICAL SECTIONS EAST TENTH STREET AND WATER TREATMENT PLANT ACCESS RD 2

CONTRAC	T NO. SR14-42
CV-	No. -R3005-E1
SCALE NO	SCALE
SHEET N	D.

W CARSON MESA ROAD

STA 8+50 TO STA 20+00 LOCAL ROADWAY
PER LOS ANGELES COUNTY MUNICIPAL CODE CHAPTER 21 PARTS 2 AND 3

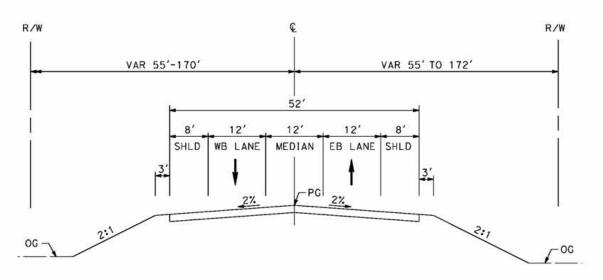

MOUNTAIN SPRINGS ROAD

STA 85+88 TO STA 98+94 COLLECTOR STREET PER LOS ANGELES COUNTY MUNICIPAL CODE CHAPTER 21 PARTS 2 AND 3

-							DESIGNED BY J.C. ALAMILLA	
	\dashv		\perp				DRAWN BY A. SANZ	PEPD RECORD SET
-	\dashv		+				CHECKED BY W. GUO	REV 02
8	\dashv	<u> </u>	+				IN CHARGE A. RELANO	NOT FOR
97.0	REV	DATE	BY	CHK	APP	DESCRIPTION	DATE 04/30/2021	CONSTRUCTION





CALIFORNIA HIGH-SPEED RAIL PROJECT PALMDALE TO BURBANK

ALIGNMENT "E1" TYPICAL SECTIONS W CARSON MESA ROAD AND MOUNTAIN SPRINGS RD

CONTRAC	T NO. SR14-42
DRAWING CV	NO. -R3006-E1
SCALE	113000 E1
	SCALE



J.C. ALAMILLA A. SANZ W. GUO A. RELANO CONSTRUCTION 04/30/2021 BY CHK APP DESCRIPTION

PEPD RECORD SET REV 02 NOT FOR





CALIFORNIA HIGH-SPEED RAIL PROJECT PALMDALE TO BURBANK

ALIGNMENT "E1" TYPICAL SECTIONS SAN FERNANDO ROAD SHEET 1 OF 2

CV-	[№] . -R3009-E1
SCALE	SCALE

CONTRACT NO.

R/W VAR 30' TO 50' VAR 21' TO 31' VAR 36' TO 48' VAR 18' TO 24' SW NB LANE SB LANE RET WALL WHERE ROAD HIGHER THAN TRACKS -PG 2% - SCRRA FG

SCRRA

SAN FERNANDO ROAD AT BRANDFORD

STA 16+00 TO STA 24+00

PEPD RECORD SET
REV 02

NOT FOR
CONSTRUCTION





CALIFORNIA HIGH-SPEED RAIL PROJECT PALMDALE TO BURBANK

ALIGNMENT "E1" TYPICAL SECTIONS SAN FERNANDO ROAD SHEET 2 OF 2

CONTRACT NO. HSR14-42
CV-R3010-E
NO SCALE
SHEET NO.

CSHR R/W VAR 33' TO 41' VAR 45'-53' R/W VAR 45'-53' NB LANE NB LANE MEDIAN SB LANE SB LANE SW CHSR FG 2% 2% PG 2% 2% 2% 20' OG


SAN FERNANDO ROAD AT SHELDON

STA 2+48 TO STA 24+00








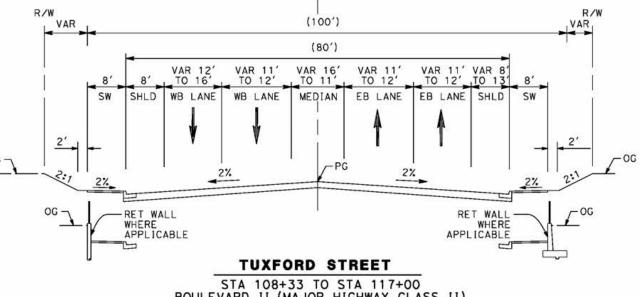

Œ

STA 108+33 TO STA 117+00 BOULEVARD II (MAJOR HIGHWAY CLASS II) PER CITY OF LOS ANGELES GENERAL PLAN 2035

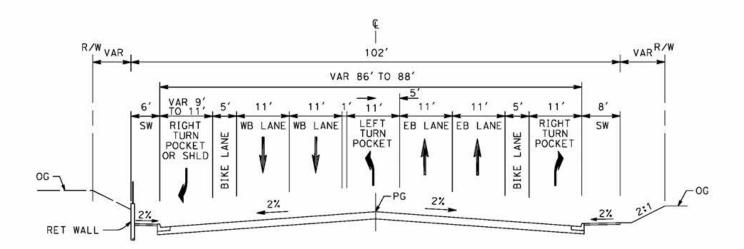

TUXFORD STREET

STA 105+00 TO STA 108+33
BOULEVARD II (MAJOR HIGHWAY CLASS II)
PER CITY OF LOS ANGELES GENERAL PLAN 2035


CALIFORNIA HIGH-SPEED RAIL PROJECT PALMDALE TO BURBANK

ALIGNMENT "E1" TYPICAL SECTIONS TUXFORD STREET

HSR14-42
ORAWING NO. CV-R3011-E1
NO SCALE

SHEET NO.



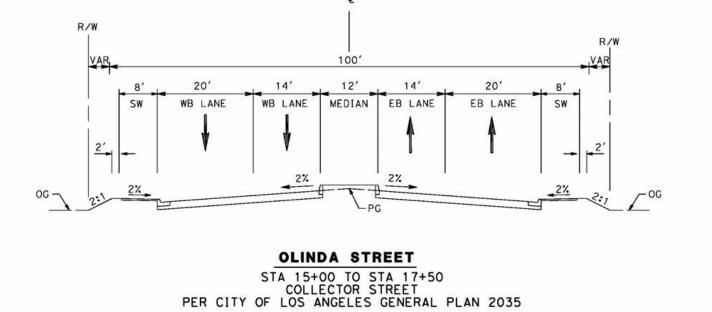

R/W VAR 25'-31' VAR 24'-36' VAR 38'-43' VAR 19'-22' VAR 19'-21' WB LANE EB LANE

OLINDA STREET

STA 13+50 TO STA 15+00 AND STA 17+50 TO STA 18+20 COLLECTOR STREET PER CITY OF LOS ANGELES GENERAL PLAN 2035

		1				J.C. ALAMILLA	
Ш		\perp				DRAWN BY A. SANZ	PE
		+	-			W. GUO	
		+				IN CHARGE A. RELANO	١.
REV	DATE	BY	CHK	APP	DESCRIPTION	04/30/2021	,

EPD RECORD SET SENER CONSTRUCTION

REV 02


NOT FOR



CALIFORNIA HIGH-SPEED RAIL PROJECT PALMDALE TO BURBANK


ALIGNMENT "E1" TYPICAL SECTIONS OLINDA STREET

CONTRACT NO. HSR14-42
ORAWING NO. CV-R3012-E1
NO SCALE
SHEET NO.

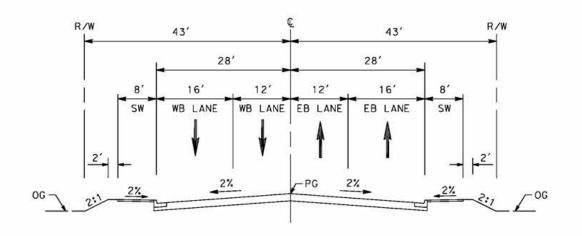


BRANFORD STREET

STA 14+51 TO STA 25+80 AVENUE II (SECONDARY HIGHWAY) PER CITY OF LOS ANGELES GENERAL PLAN 2035

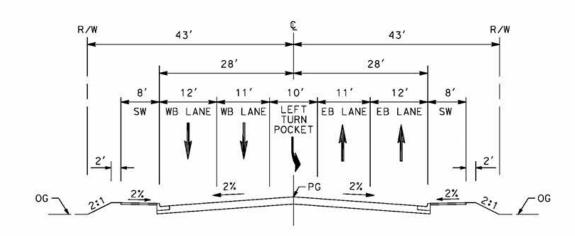


BRANFORD STREET

STA 13+34 TO STA 15+00 AVENUE II (SECONDARY HIGHWAY)
PER CITY OF LOS ANGELES GENERAL PLAN 2035

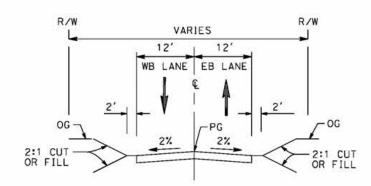

ACCESS ROAD

STA 1+00 TO STA 16+00 LOCAL STREET
PER CITY OF LOS ANGELES GENERAL PLAN 2035

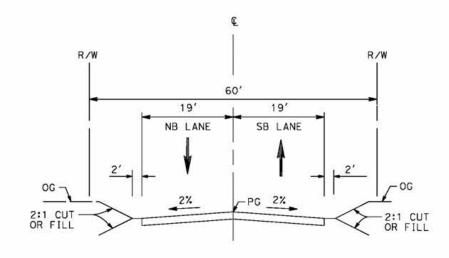

RALSTON AVENUE

STA 10+31 TO STA 24+34 LOCAL STREET
PER CITY OF LOS ANGELES GENERAL PLAN 2035

						J.C. ALAMILLA	
\dashv		+-				A. SANZ	PE
-		+	-			W. GUO	
\dashv		1				IN CHARGE A. RELANO	١,
REV	DATE	BY	CHK	APP	DESCRIPTION	DATE 04/30/2021	1

EPD RECORD SET REV 02 NOT FOR CONSTRUCTION






CALIFORNIA HIGH-SPEED RAIL PROJECT PALMDALE TO BURBANK

ALIGNMENT "E1" TYPICAL SECTIONS BRANFORD ST, RALSTON AVE AND ACCESS RD

HSR14-42
CV-R3013-E1
NO SCALE
SHEET NO.






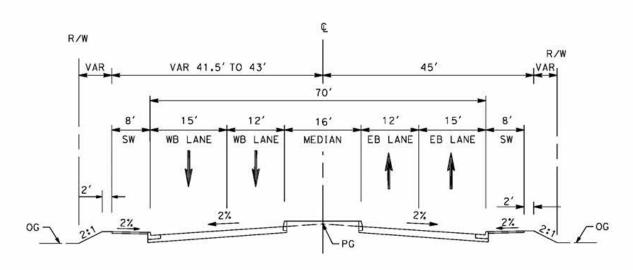


SHELDON STREET

STA 10+25 TO STA 12+70 AVENUE II (SECONDARY HIGHWAY) PER CITY OF LOS ANGELES GENERAL PLAN 2035

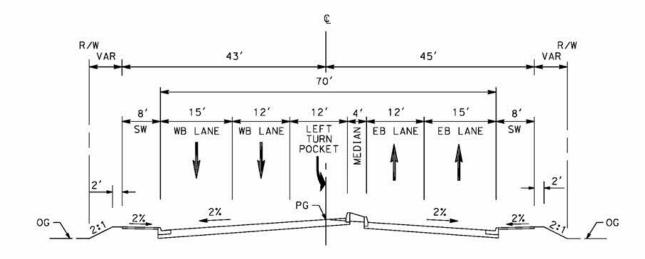


SHELDON STREET

STA 8+88 TO STA 10+25 AVENUE II (SECONDARY HIGHWAY) PER CITY OF LOS ANGELES GENERAL PLAN 2035

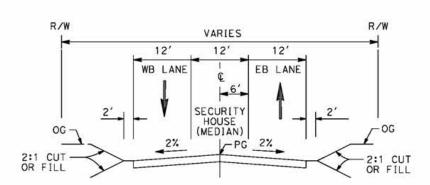

LADWP ROAD STA 1+00 TO STA 10+00

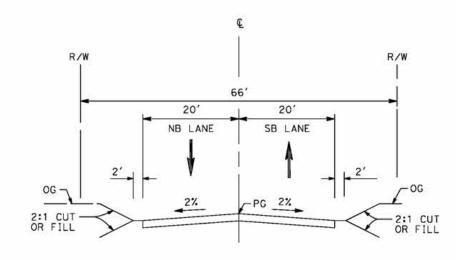

PRIVATE ROAD 1 STA 12+64 TO STA 27+24

						J.C. ALAMILLA	
Ш		\perp				DRAWN BY A. SANZ	PEPD RECORD SET
		+				W. GUO	REV 02
		1				IN CHARGE A. RELANO	NOT FOR CONSTRUCTION
REV	DATE	BY	CHK	APP	DESCRIPTION	DATE 04/30/2021	CONSTRUCTION






CALIFORNIA HIGH-SPEED RAIL PROJECT PALMDALE TO BURBANK

ALIGNMENT "E1" TYPICAL SECTIONS SHELDON ST, PRIVATE RD 1 AND LADWP RD

CONTRAC	SR14-42
DRAWING CV	NO. -R3014-E1
SCALE NO	SCALE
SHEET N	0.

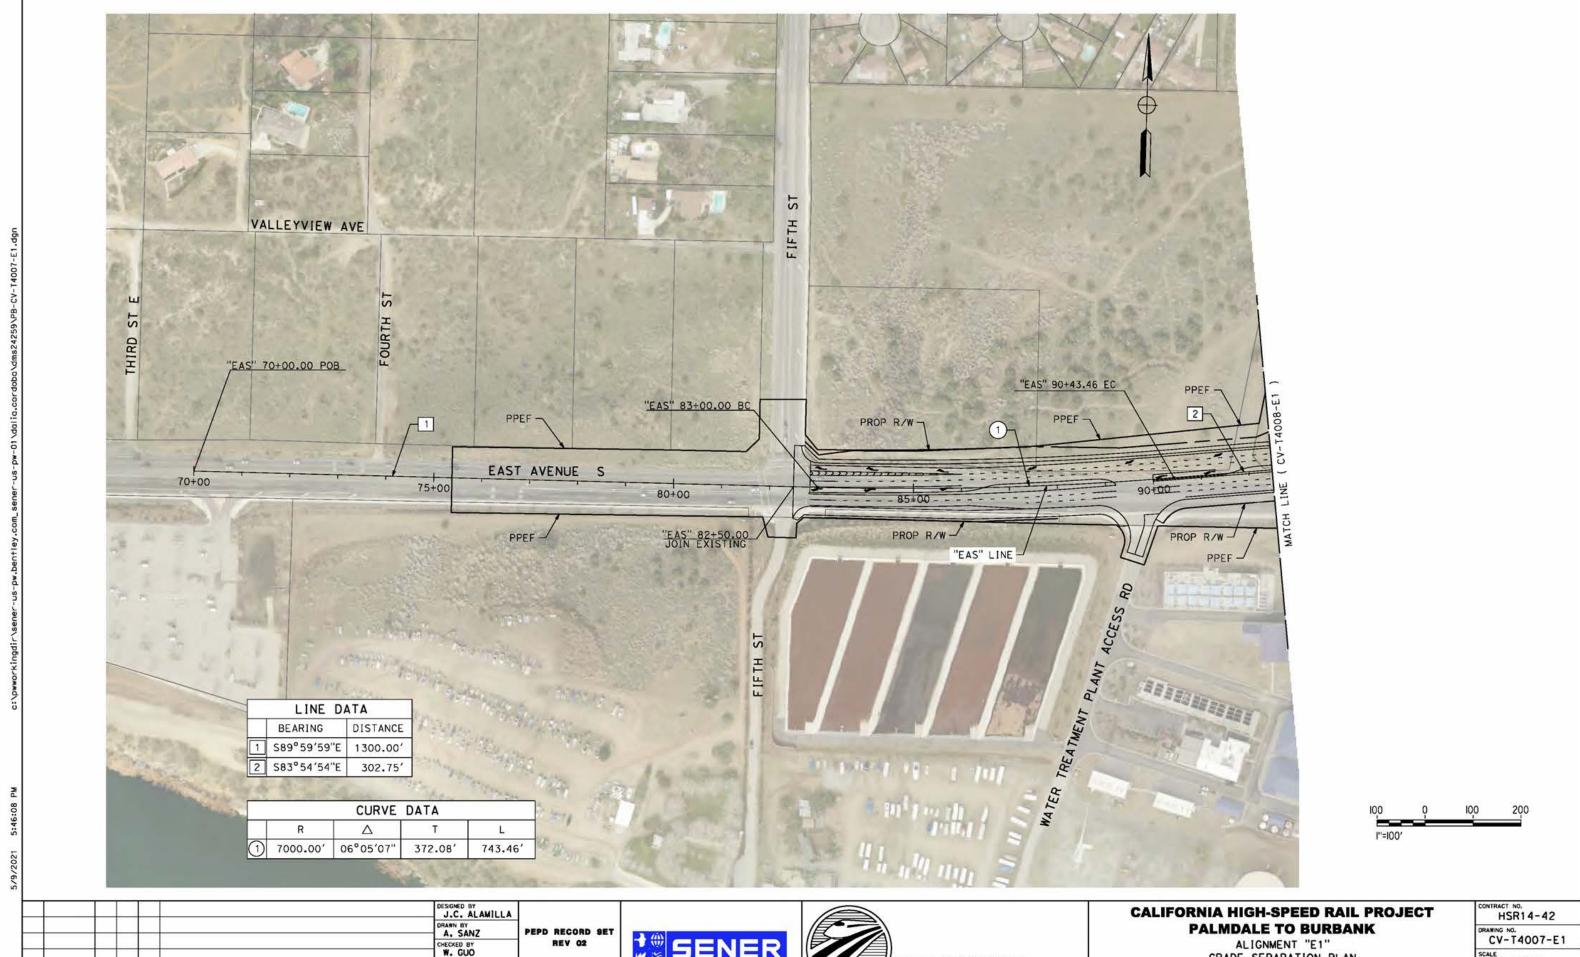

BY CHK APP

DESCRIPTION

NOT FOR CONSTRUCTION

A. RELANO


04/30/2021


SENER




ALIGNMENT "E1"
GRADE SEPARATION PLAN
EAST AVENUE S
SHEET 1 OF 3

	15K14-42
DRAWING CV	NO. - T4007-E1
SCALE	SHOWN
SHEET A	in.

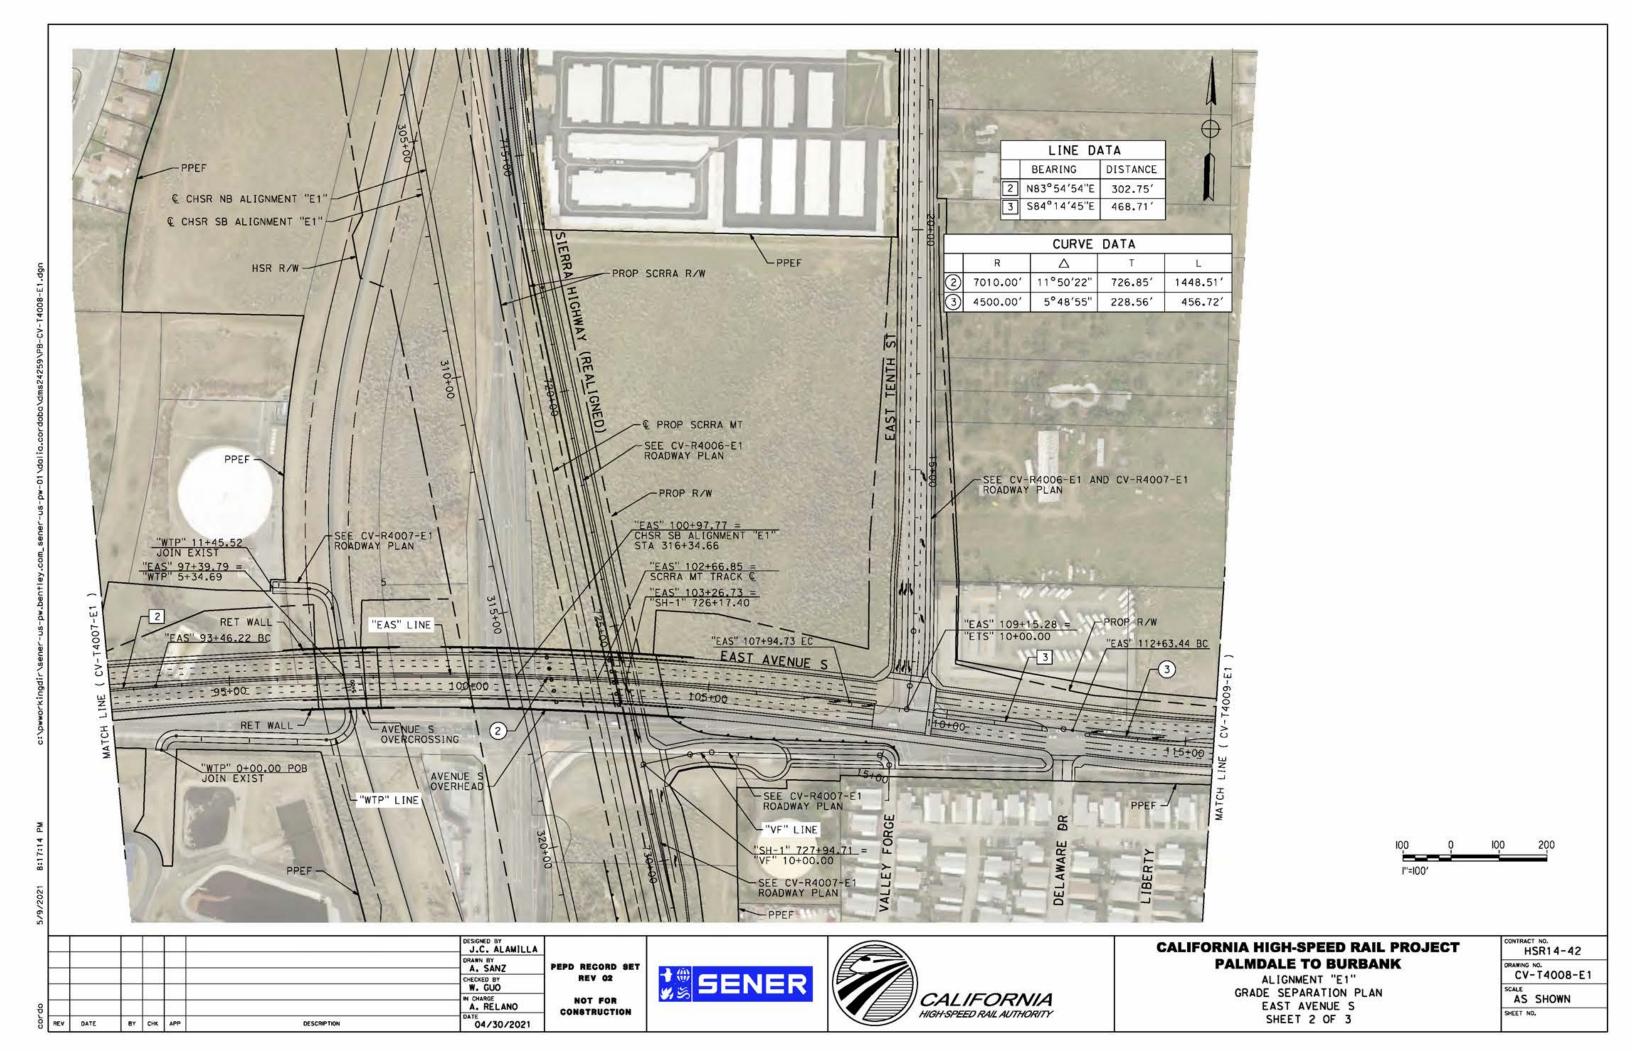

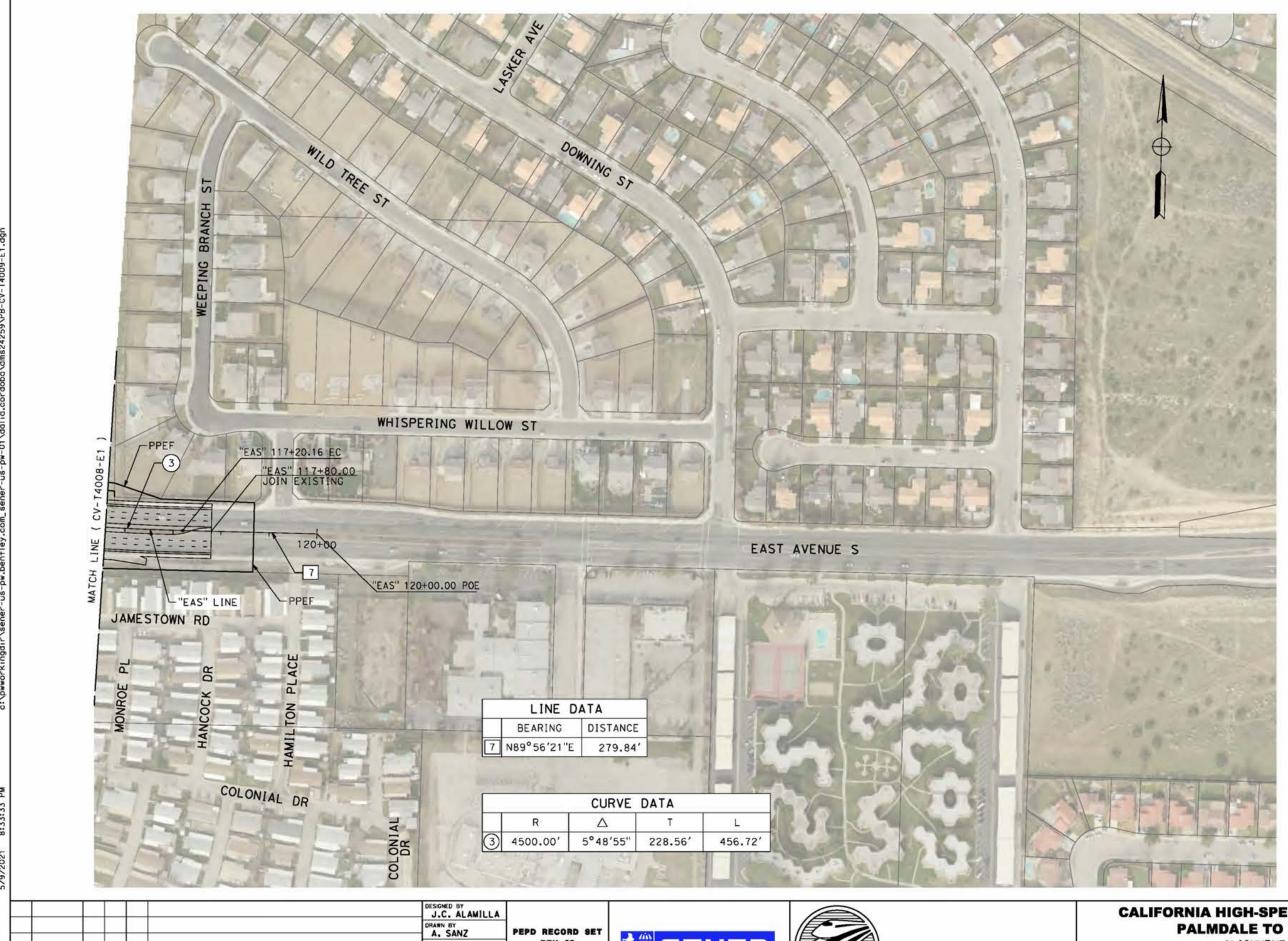

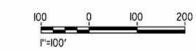

						J.C. ALAMILLA
		1				DRAWN BY A. SANZ
		+		-		W. GUO
				-		IN CHARGE A. RELANO
REV	DATE	BY	CHK	APP	DESCRIPTION	DATE 04/30/2021

REV 02 NOT FOR CONSTRUCTION





CALIFORNIA HIGH-SPEED RAIL PROJECT PALMDALE TO BURBANK

ALIGNMENT "E1"
GRADE SEPARATION PLAN
EAST AVENUE S
SHEET 3 OF 3

CONTRAC	T NO. SR14-42
DRAWING CV	[№] . - T4009-E1
SCALE	SHOWN
SHEET N	0.

A. RELANO

BY CHK APP

DESCRIPTION

04/30/2021

NOT FOR

CONSTRUCTION

CALIFORNIA

HIGH-SPEED RAIL AUTHORITY

BRANFORD ST AND SAN FERNANDO ROAD "SFR1"

SHEET 1 OF 2

SHEET NO.



						D.CORDOBA	Г
		\perp				DRAWN BY A.SANZ	P
		+				W. GUO	1
8		+		Н		IN CHARGE A. RELANO	1
O REV	DATE	BY	CHK	APP	DESCRIPTION	DATE 04/30/2021	1

PEPD RECORD SET REV 02 NOT FOR CONSTRUCTION








CALIFORNIA HIGH-SPEED RAIL PROJECT PALMDALE TO BURBANK

ALIGNMENT "E1"
GRADE SEPARATION PLAN
BRANFORD ST
SHEET 2 OF 2

CONTRAC	T NO. SR14-42
DRAWING CV	No. - T4O11-E1
SCALE	SHOWN
SHEET N	o.

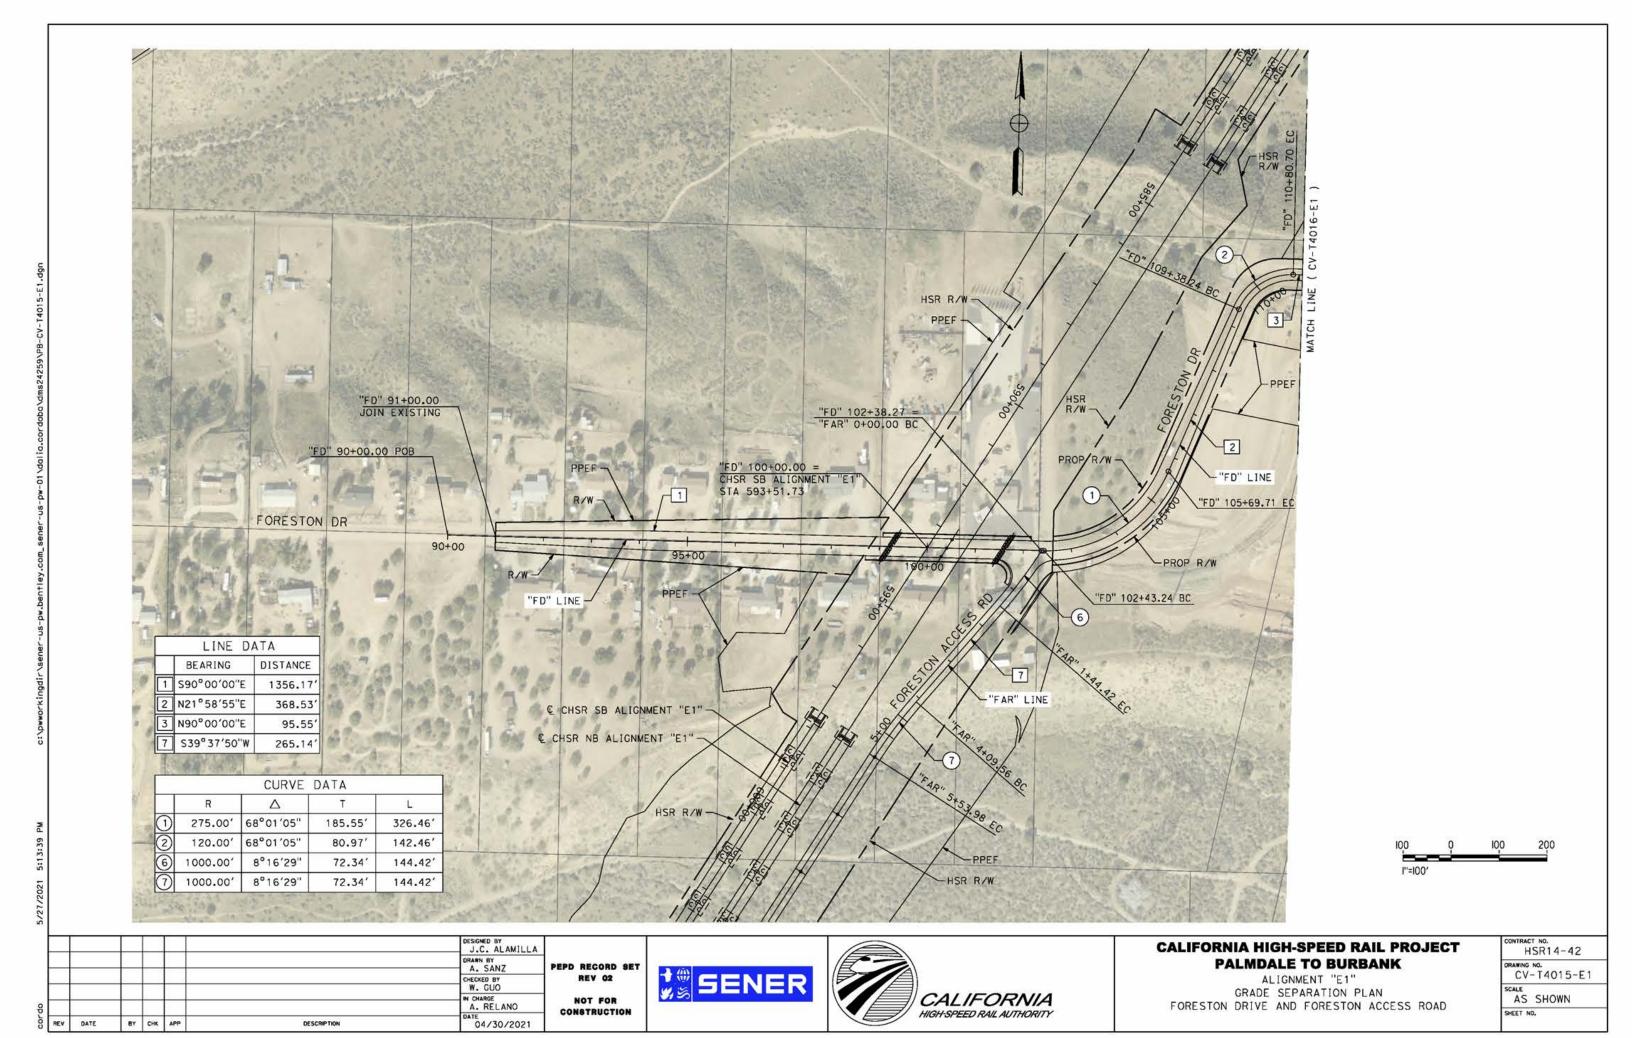

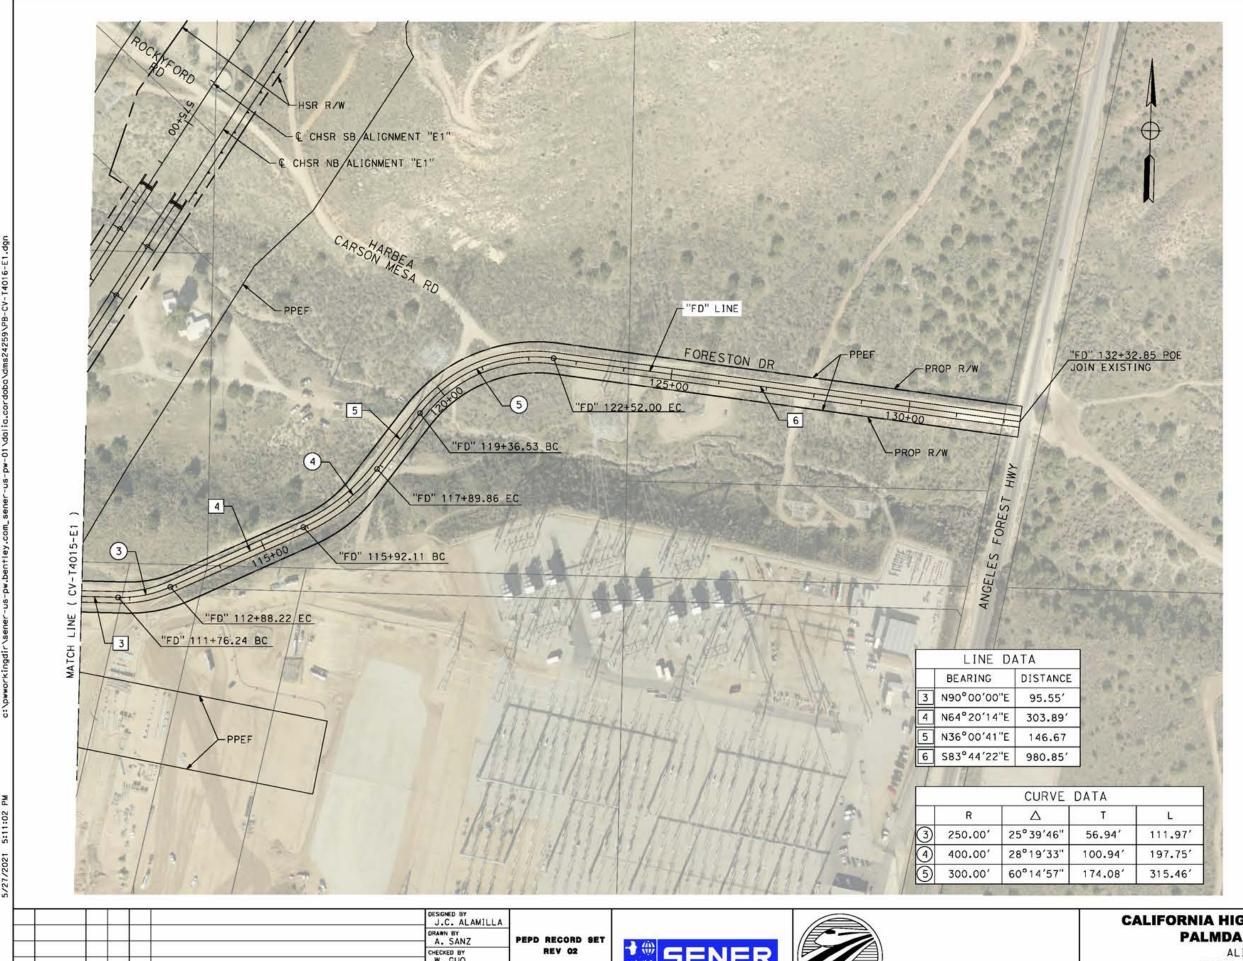

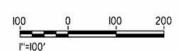

						J.C. ALAMILLA
		\perp				DRAWN BY A. SANZ
		+				CHECKED BY W. GUO
		1	1			IN CHARGE A. RELANO
REV	DATE	BY	СНК	APP	DESCRIPTION	DATE 04/30/2021

NOT FOR CONSTRUCTION






CALIFORNIA HIGH-SPEED RAIL PROJECT PALMDALE TO BURBANK

ALIGNMENT "E1" GRADE SEPARATION PLAN FORESTON DRIVE

CONTRACT NO. HSR14-42
ORAWING NO. CV-T4016-E1
SCALE AS SHOWN
SHEET NO.

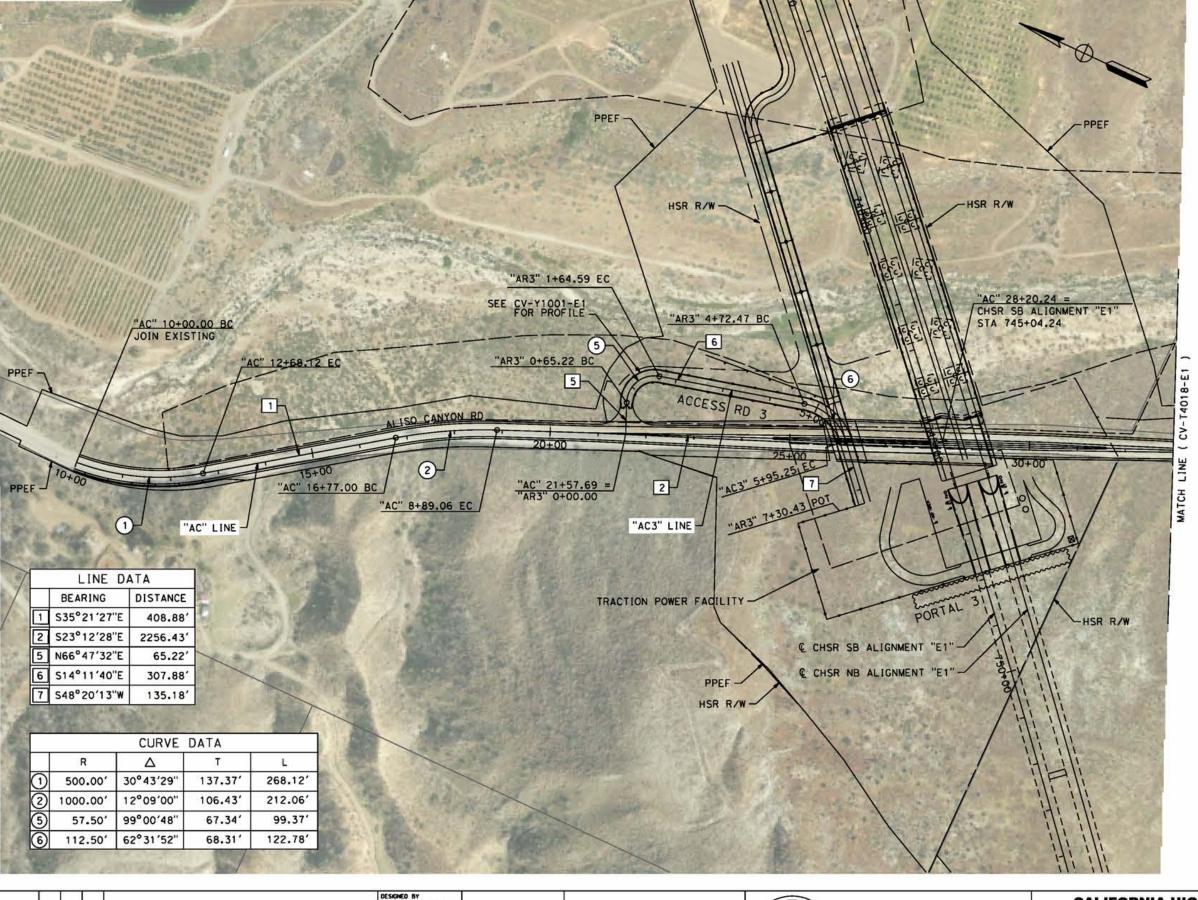



		\perp				J.C. ALAMILLA	
\vdash		_				DRAWN BY A. SANZ	P
\vdash		╁				CHECKED BY W. GUO	
\vdash		+		+		IN CHARGE A. RELANO	
REV	DATE	BY	СНК	APP	DESCRIPTION	04/30/2021	

PEPD RECORD SET
REV 02
NOT FOR
CONSTRUCTION






CALIFORNIA HIGH-SPEED RAIL PROJECT PALMDALE TO BURBANK

ALIGNMENT "E1"
GRADE DEPARATION PLAN
ALISO CANYON ROAD AND ACCESS ROAD 3

CONTRAC	T NO. SR14-42
DRAWING CV	мо. - Т4О17-Е1
SCALE AS	SHOWN
SHEET N	0.

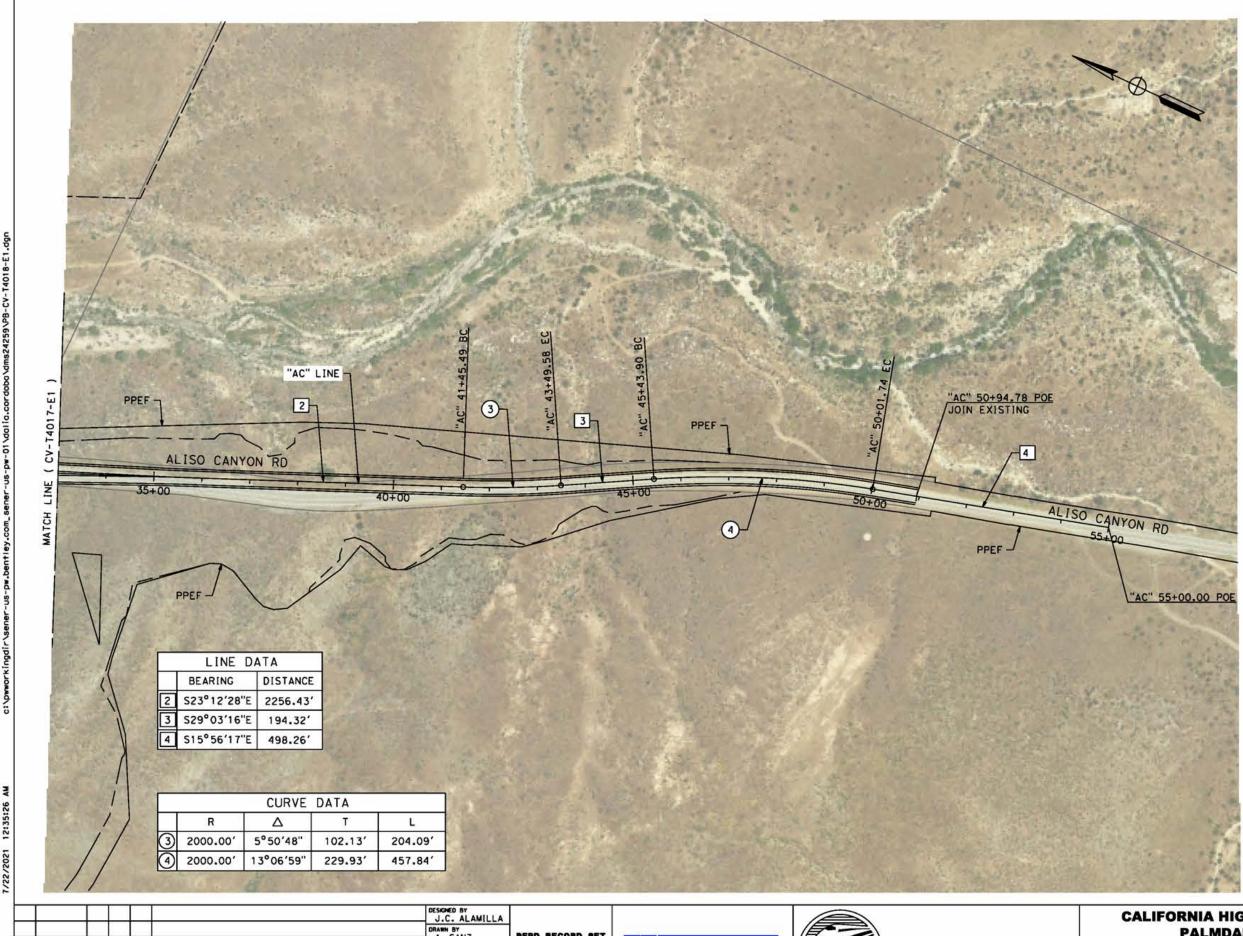



Ш						J.C. ALAMILLA	Γ
		_				DRAWN BY	,
Н		+				CHECKED BY W. GUO	
\vdash		+				IN CHARGE A. RELANO	
REV	DATE	ВУ	СНК	APP	DESCRIPTION	DATE 04/30/2021	

PEPD RECORD SET REV 02 NOT FOR

CONSTRUCTION








CALIFORNIA HIGH-SPEED RAIL PROJECT PALMDALE TO BURBANK


ALIGNMENT "E1"
GRADE SEPARATION PLAN
ALISO CANYON ROAD


	40
CV.	-T4018-E1
SCALE AS	SHOWN

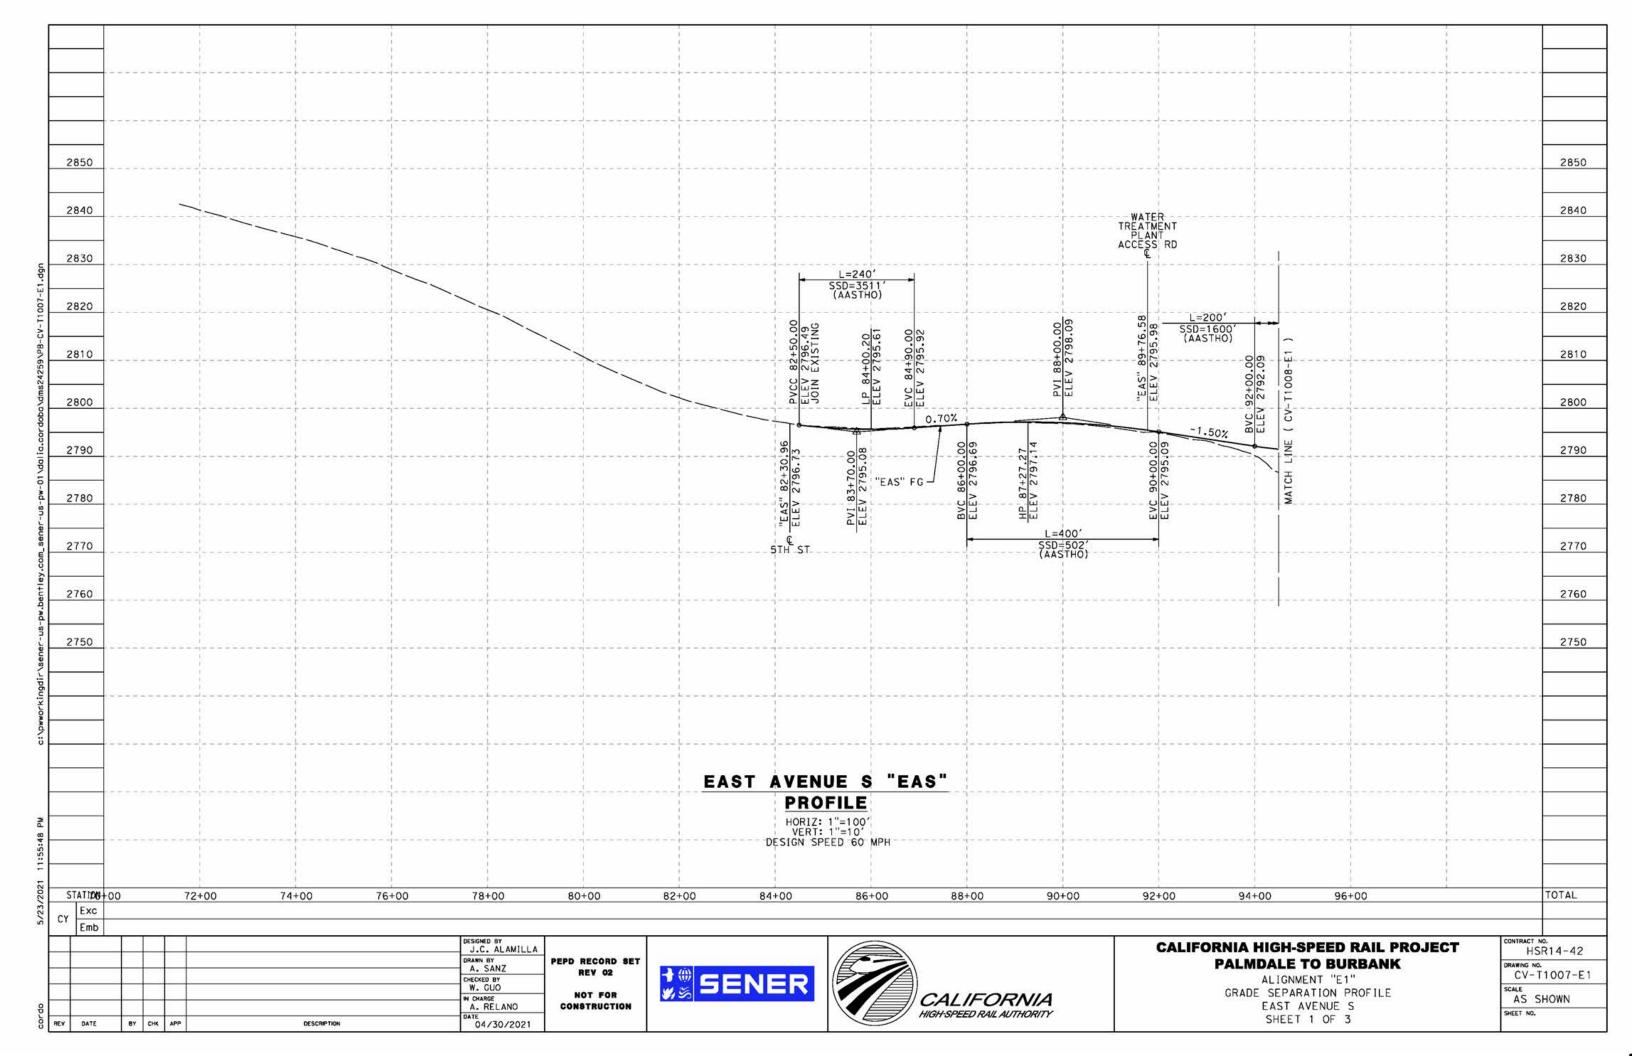


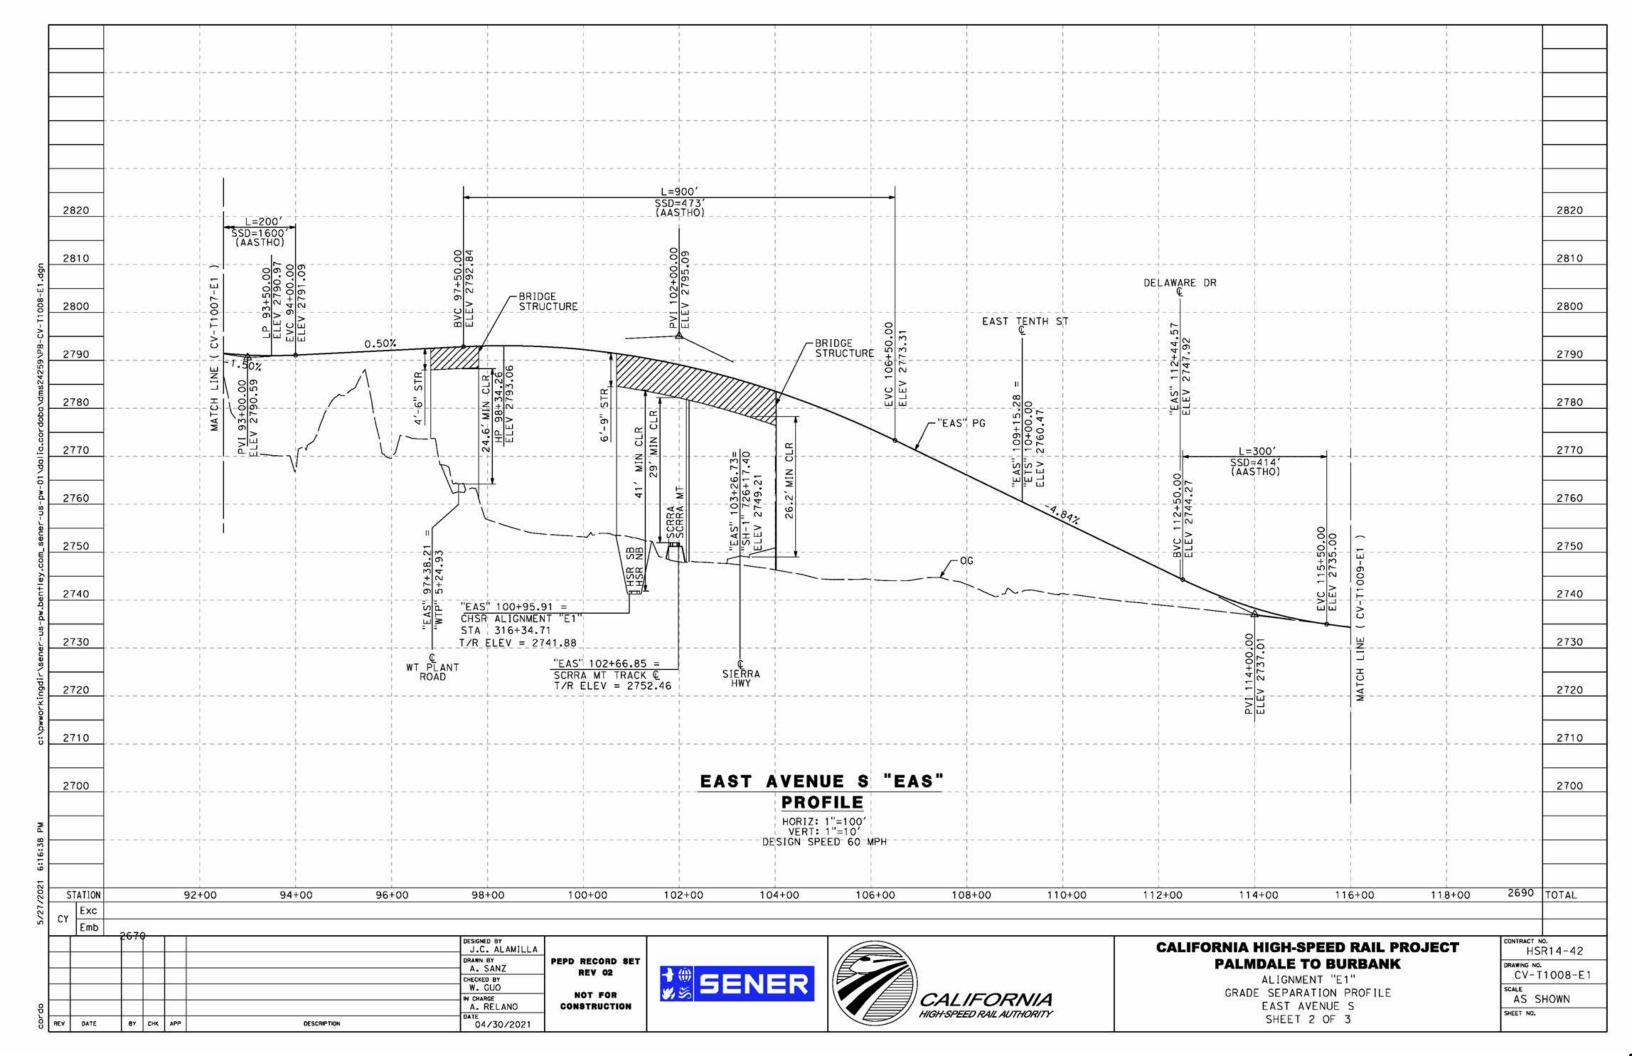


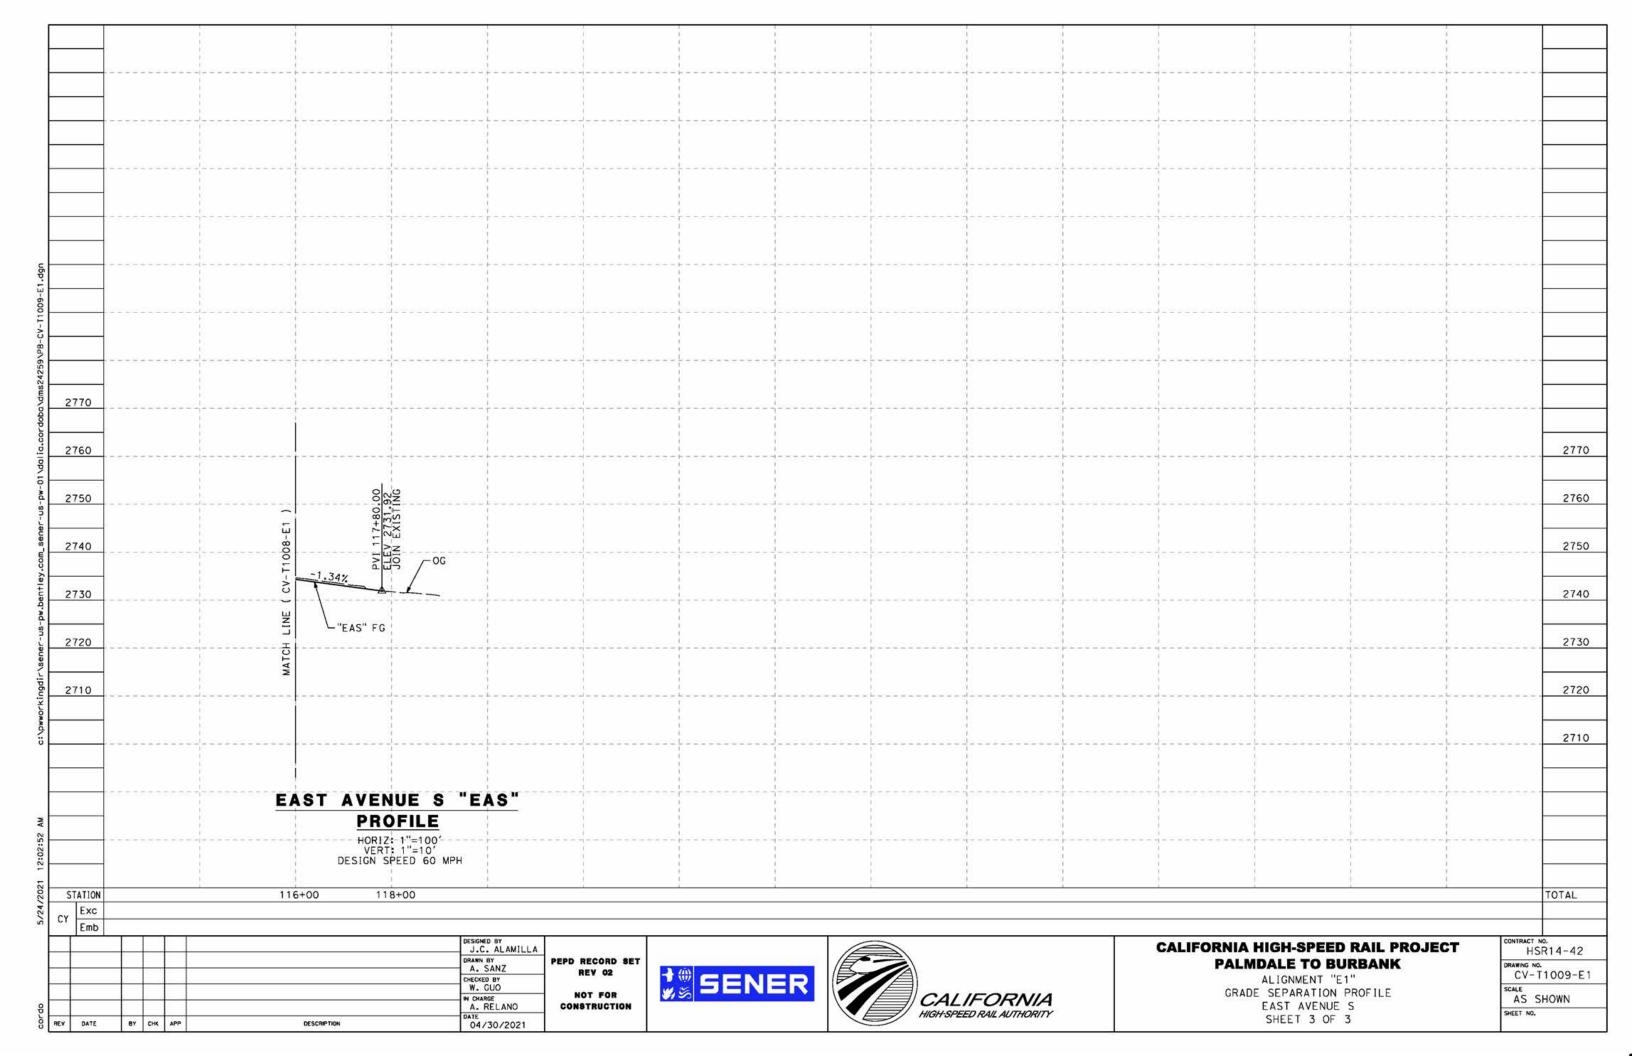


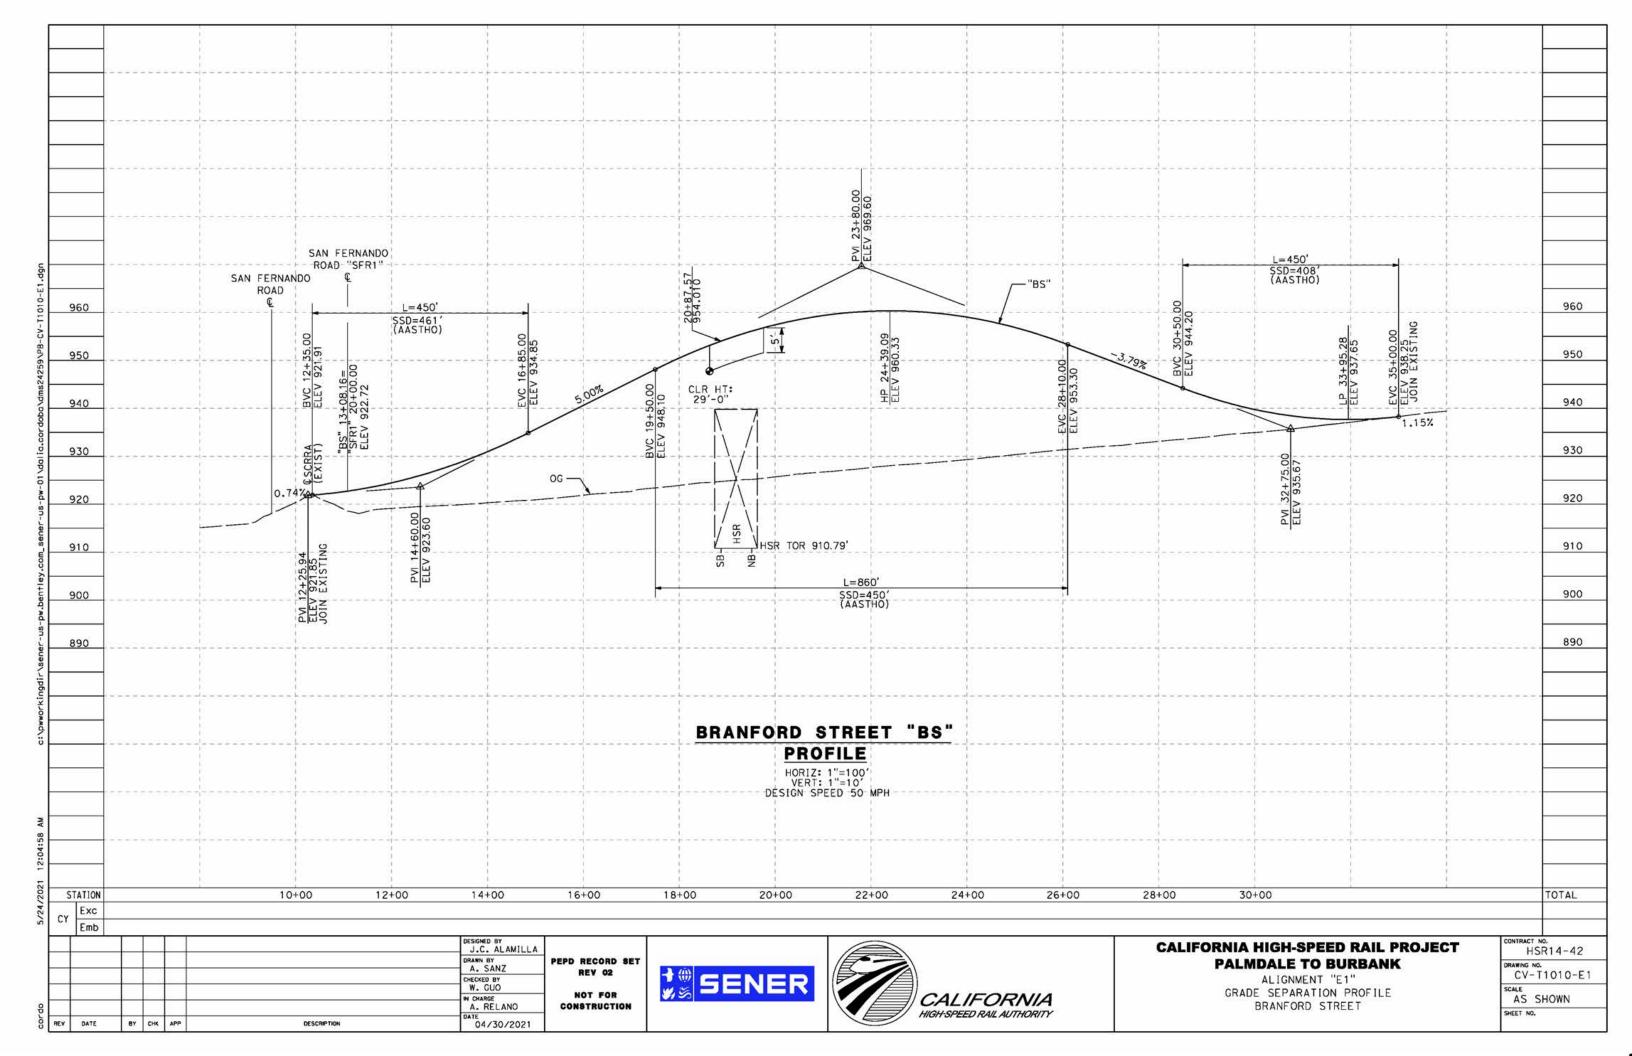


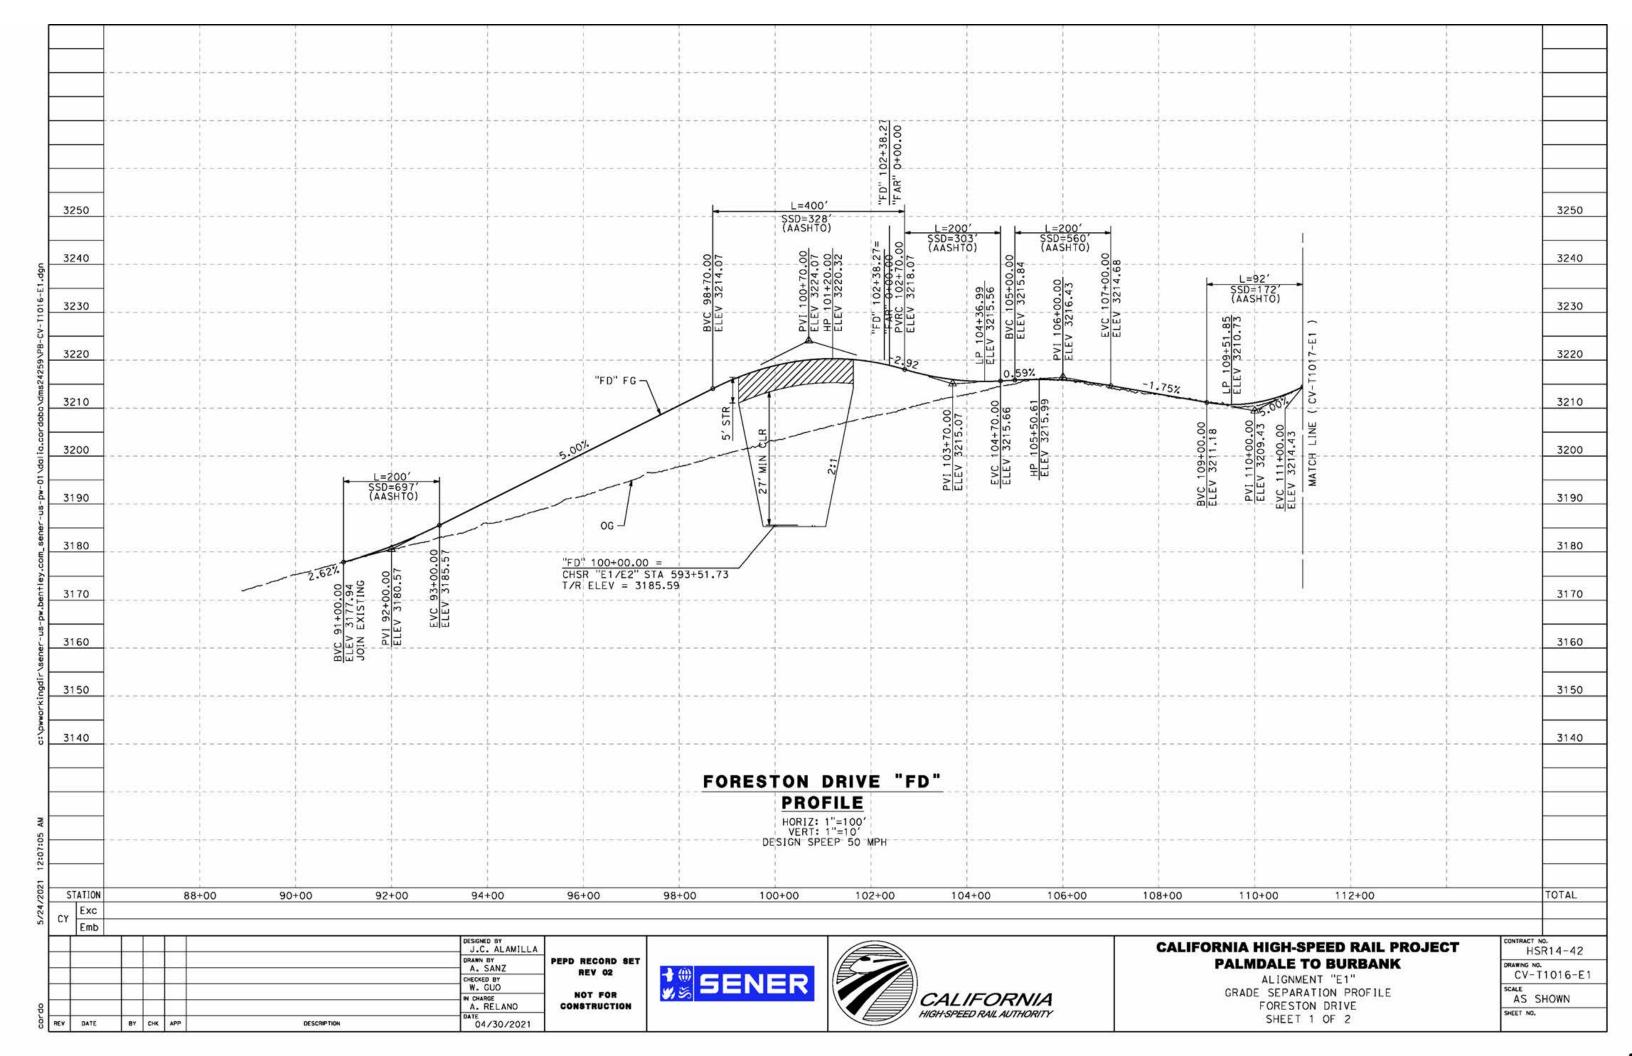

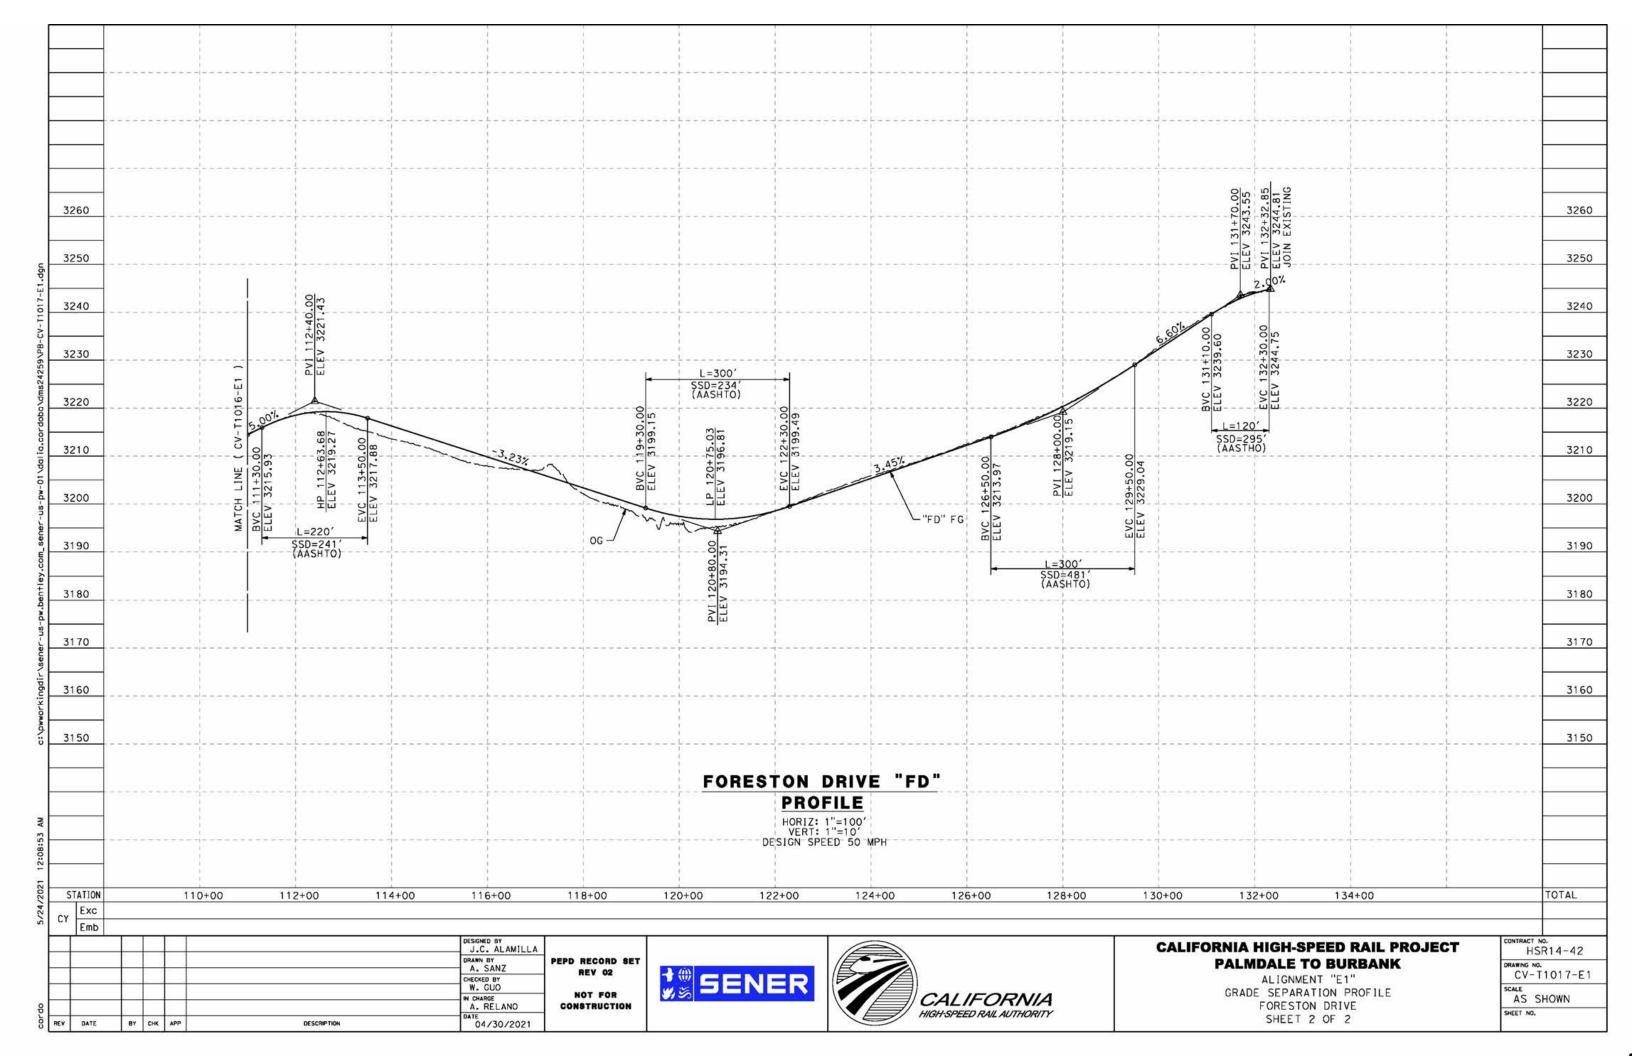

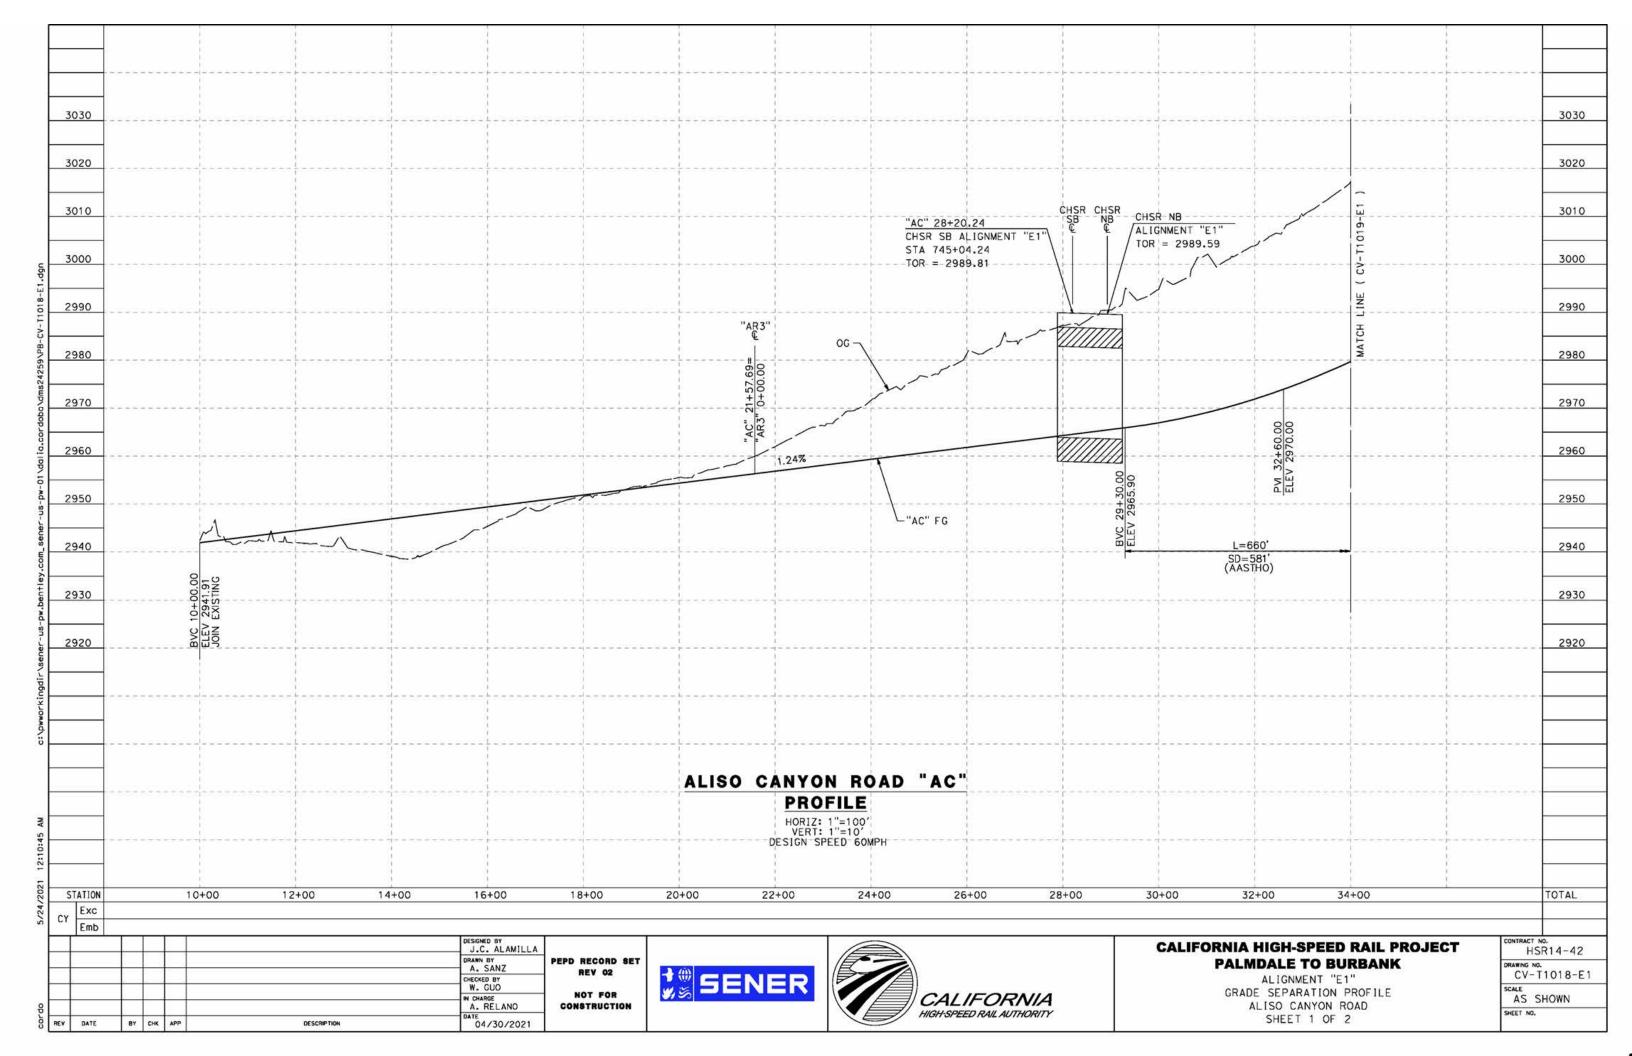


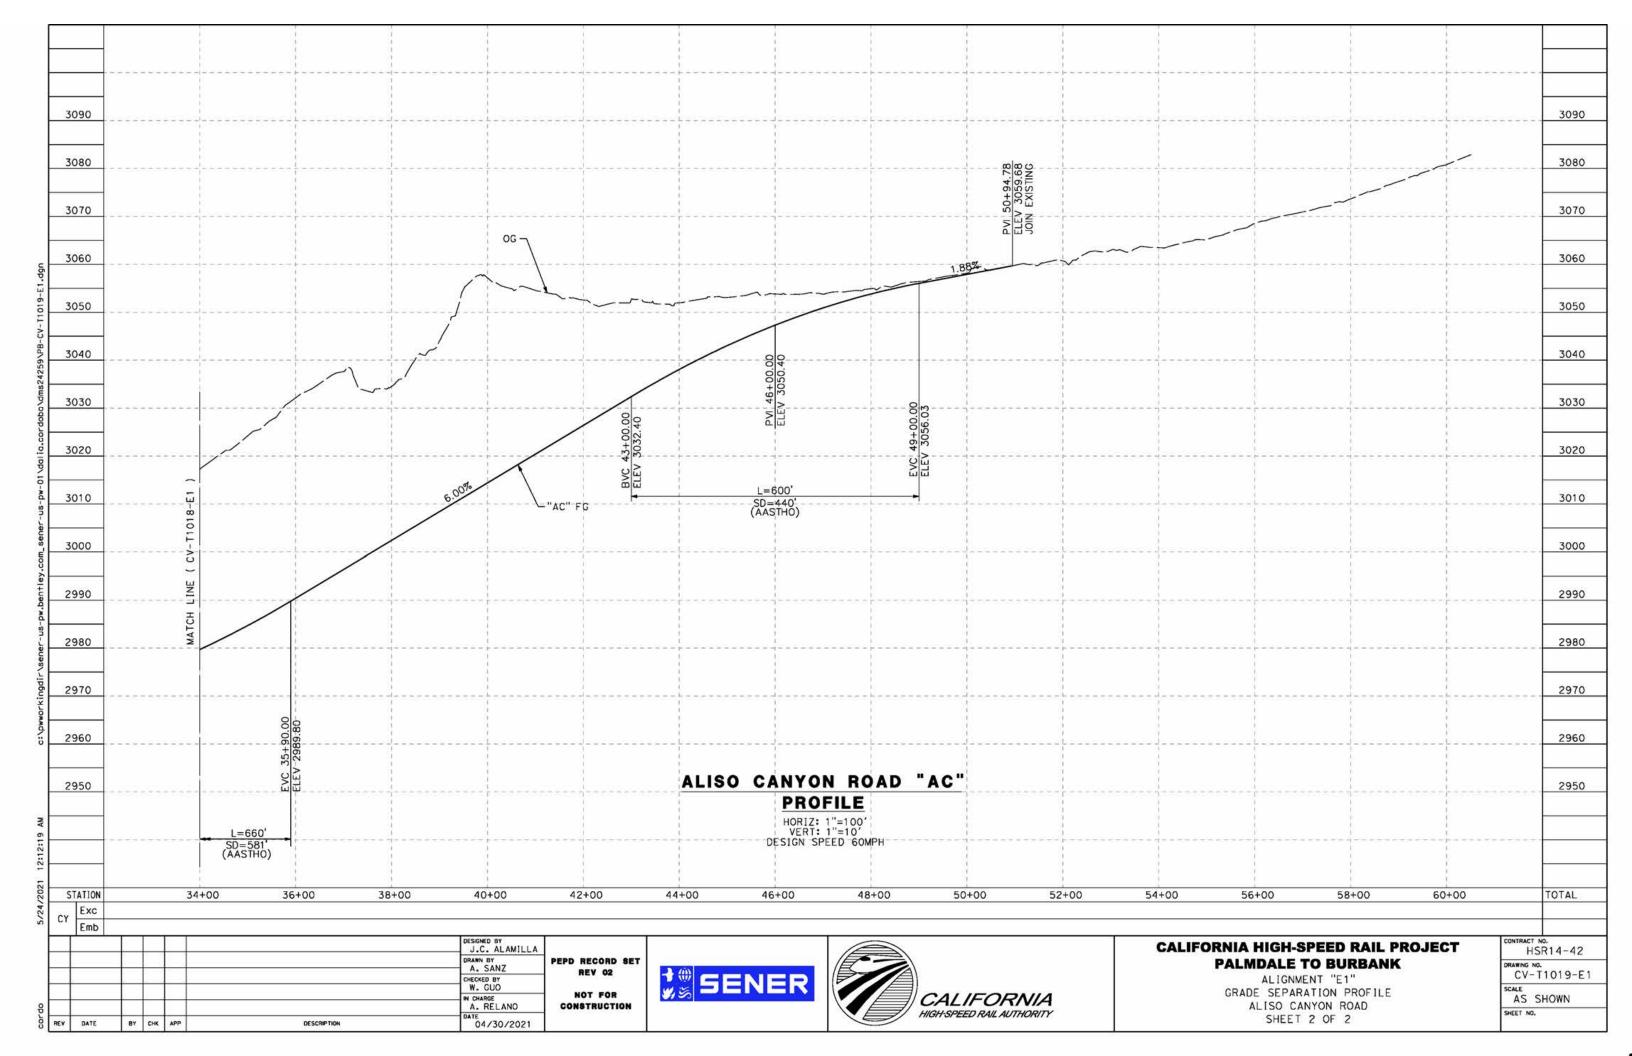

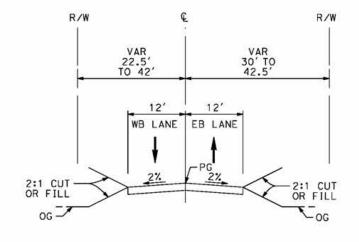

FORESTON DRIVE

STA 105+64 TO STA 132+32 LOCAL ROADWAY PER LOS ANGELES COUNTY MUNICIPAL CODE CHAPTER 21 PARTS 2 AND 3

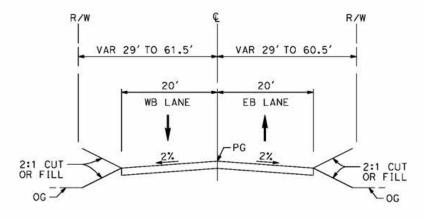

FORESTON DRIVE

STA 91+00 TO STA 105+64 LOCAL ROADWAY PER LOS ANGELES COUNTY MUNICIPAL CODE CHAPTER 21 PARTS 2 AND 3

	I						
						DESIGNED BY J.C. ALAMILLA	
	\square		-			DRAWN BY A. SANZ	PEF
	Н					CHECKED BY W. GUO	
9	\vdash					N CHARGE A. RELANO	
corc	REV	DATE	84	СНК	APP	DESCRIPTION DATE 04/30/2021	С

EPD RECORD SET REV 02 NOT FOR CONSTRUCTION





CALIFORNIA HIGH-SPEED RAIL PROJECT PALMDALE TO BURBANK


ALIGNMENT "E1" TYPICAL SECTIONS FORESTON DRIVE

CONTRACT NO. HSR14-42
ORAWING NO. CV-T3001-E1
NO SCALE

SHEET NO.


ALISO CANYON ROAD

STA 25+85 TO STA 27+92 SECONDARY HIGHWAY PER LOS ANGELES COUNTY MASTER PLAN

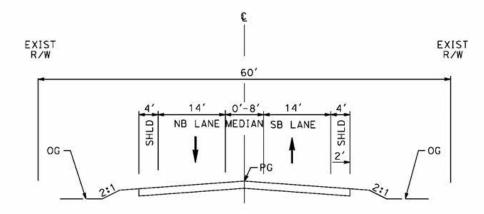

ALISO CANYON ROAD

STA 21+00 TO STA 25+85 AND STA 27+92 TO STA 35+41 SECONDARY HIGHWAY PER LOS ANGELES COUNTY MASTER PLAN

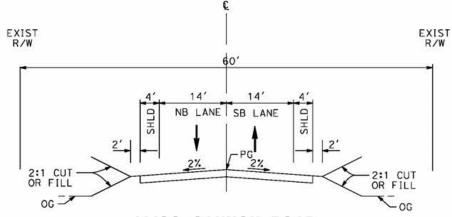

ALISO CANYON ROAD

STA 10+00 TO STA 21+00

AND
STA 35+41 TO STA 51+00
SECONDARY HIGHWAY
PER LOS ANGELES COUNTY MASTER PLAN

- 1			-	_				_
- [_		1		Ш		J.C. ALAMILLA	
-			1				DRAWN BY A. SANZ	PE
ł	\dashv		+	-			W. GUO	
8	\dashv	9	+	-			IN CHARGE A. RELANO	
COL	REV	DATE	BY	СНК	APP	DESCRIPTION	DATE 04/30/2021	i i

PEPD RECORD SET SENER CONSTRUCTION

REV 02


NOT FOR




CALIFORNIA HIGH-SPEED RAIL PROJECT PALMDALE TO BURBANK

ALIGNMENT "E1" TYPICAL SECTIONS ALISO CANYON ROAD

CONTRACT NO.
CONTRACT NO. HSR14-42
DRAWING NO. CV-T3002-E1
NO SCALE
SHEET NO.

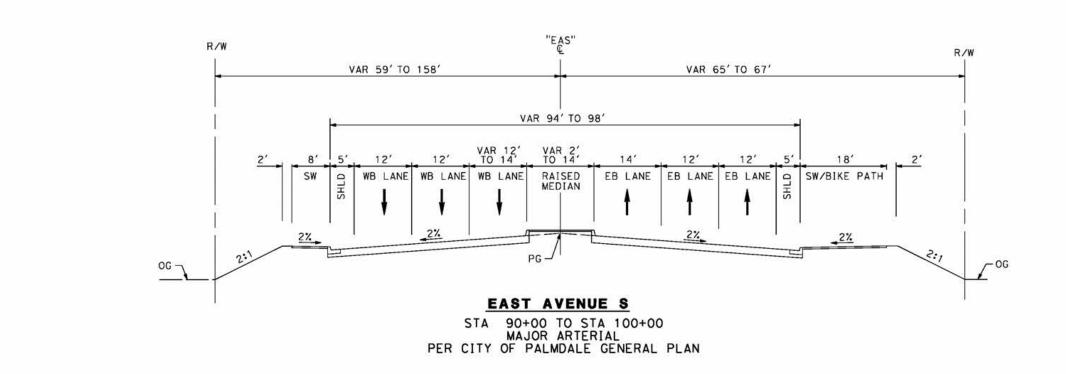

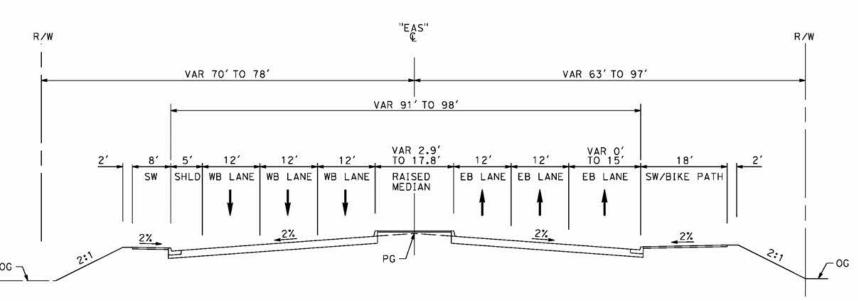

EAST AVENUE S

STA 83+84 TO STA 90+00 MAJOR ARTERIAL PER CITY OF PALMDALE GENERAL PLAN

							J.C. ALAMILLA	
			-				DRAWN BY A. SANZ	PE
			+	-			W. GUO	
유		2	1				A. RELANO	١.
COL	REV	DATE	BY	СНК	APP	DESCRIPTION	04/30/2021	ે



REV 02


NOT FOR




CALIFORNIA HIGH-SPEED RAIL PROJECT PALMDALE TO BURBANK

ALIGNMENT "E1" TYPICAL SECTIONS EAST AVENUE S SHEET 1 OF 2

11515	SR14-42
DRAWING	NO.
CV-	-T3003-E1
SCALE	010200000
NO	SCALE

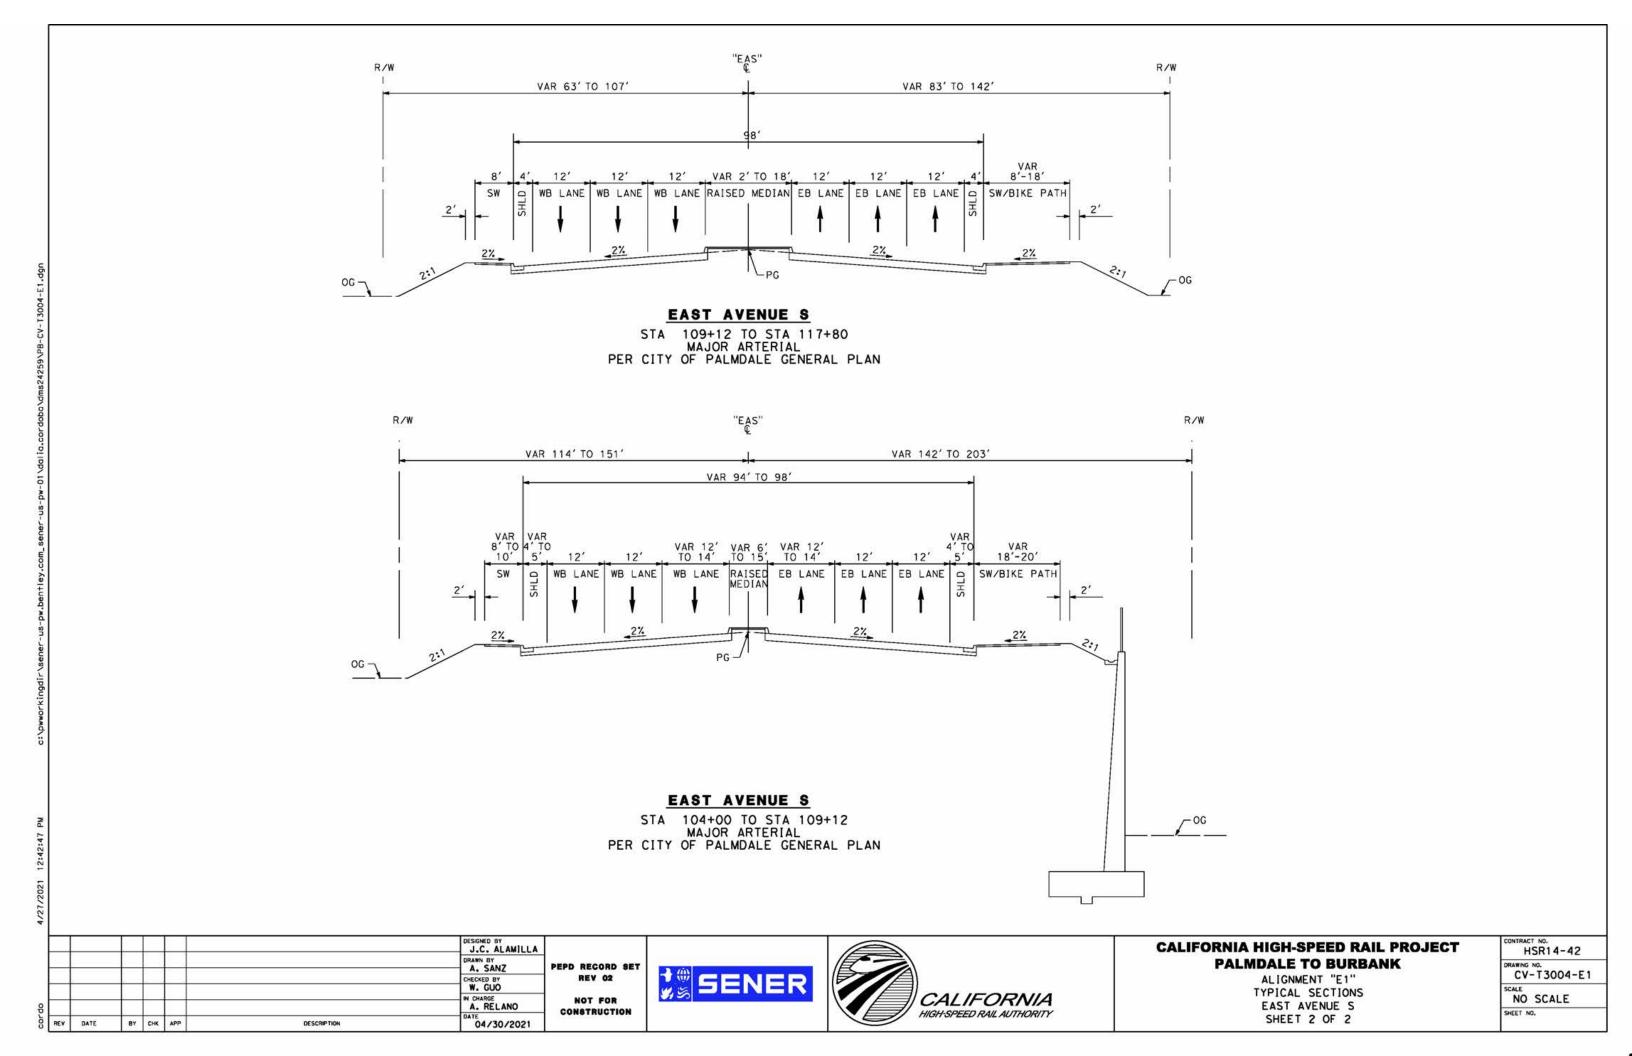

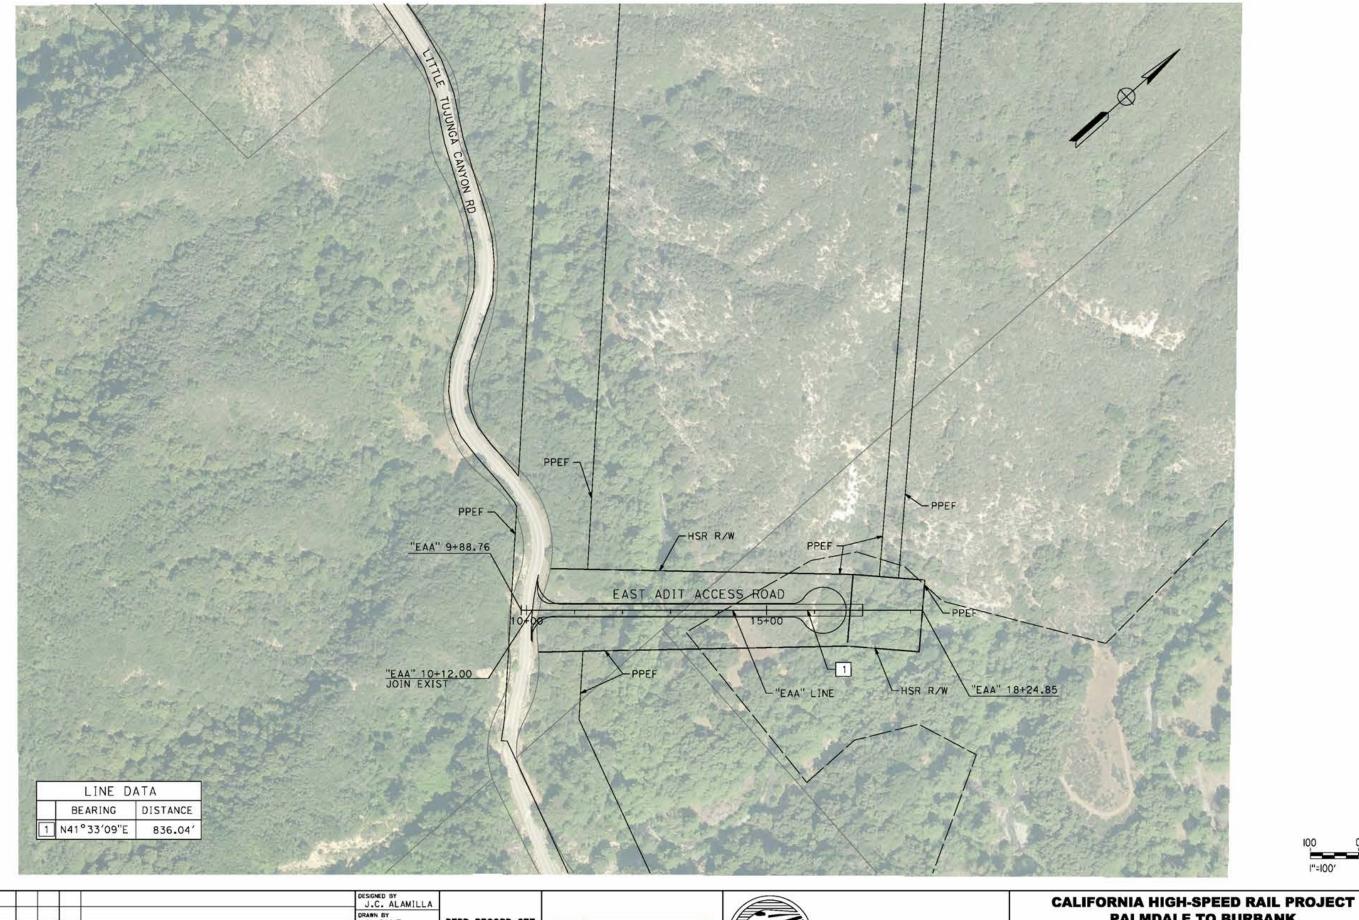



						J.C. ALAMILLA	
\vdash		-				DRAWN BY A. SANZ	P
\vdash	-	+				W. GUO	
\vdash		1	-			IN CHARGE A. RELANO	
REV	DATE	BY	СНК	APP	DESCRIPTION	04/30/2021	

PEPD RECORD SET REV 02 NOT FOR CONSTRUCTION








PALMDALE TO BURBANK

ALIGNMENT "E1" ACCESS ROAD PLAN EAST ADIT ACCESS ROAD

CONTRAC	T NO. SR14-42
DRAWING CV	NO. - Y4001 - E1
SCALE	SHOWN

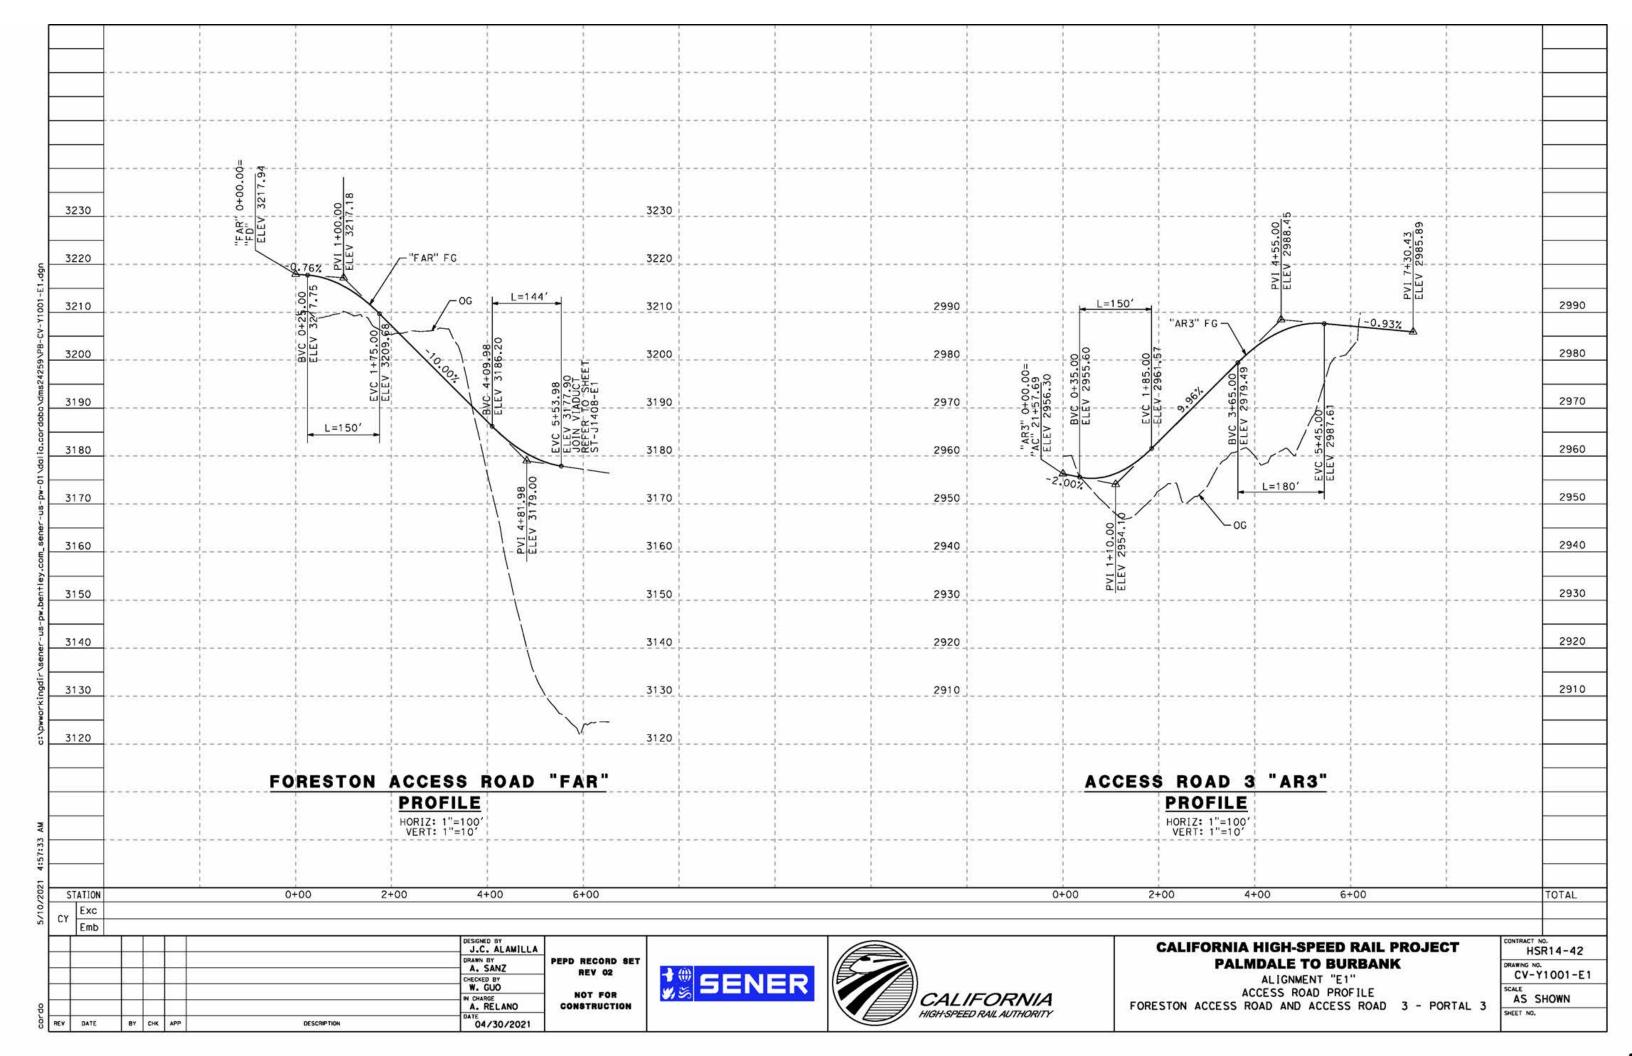


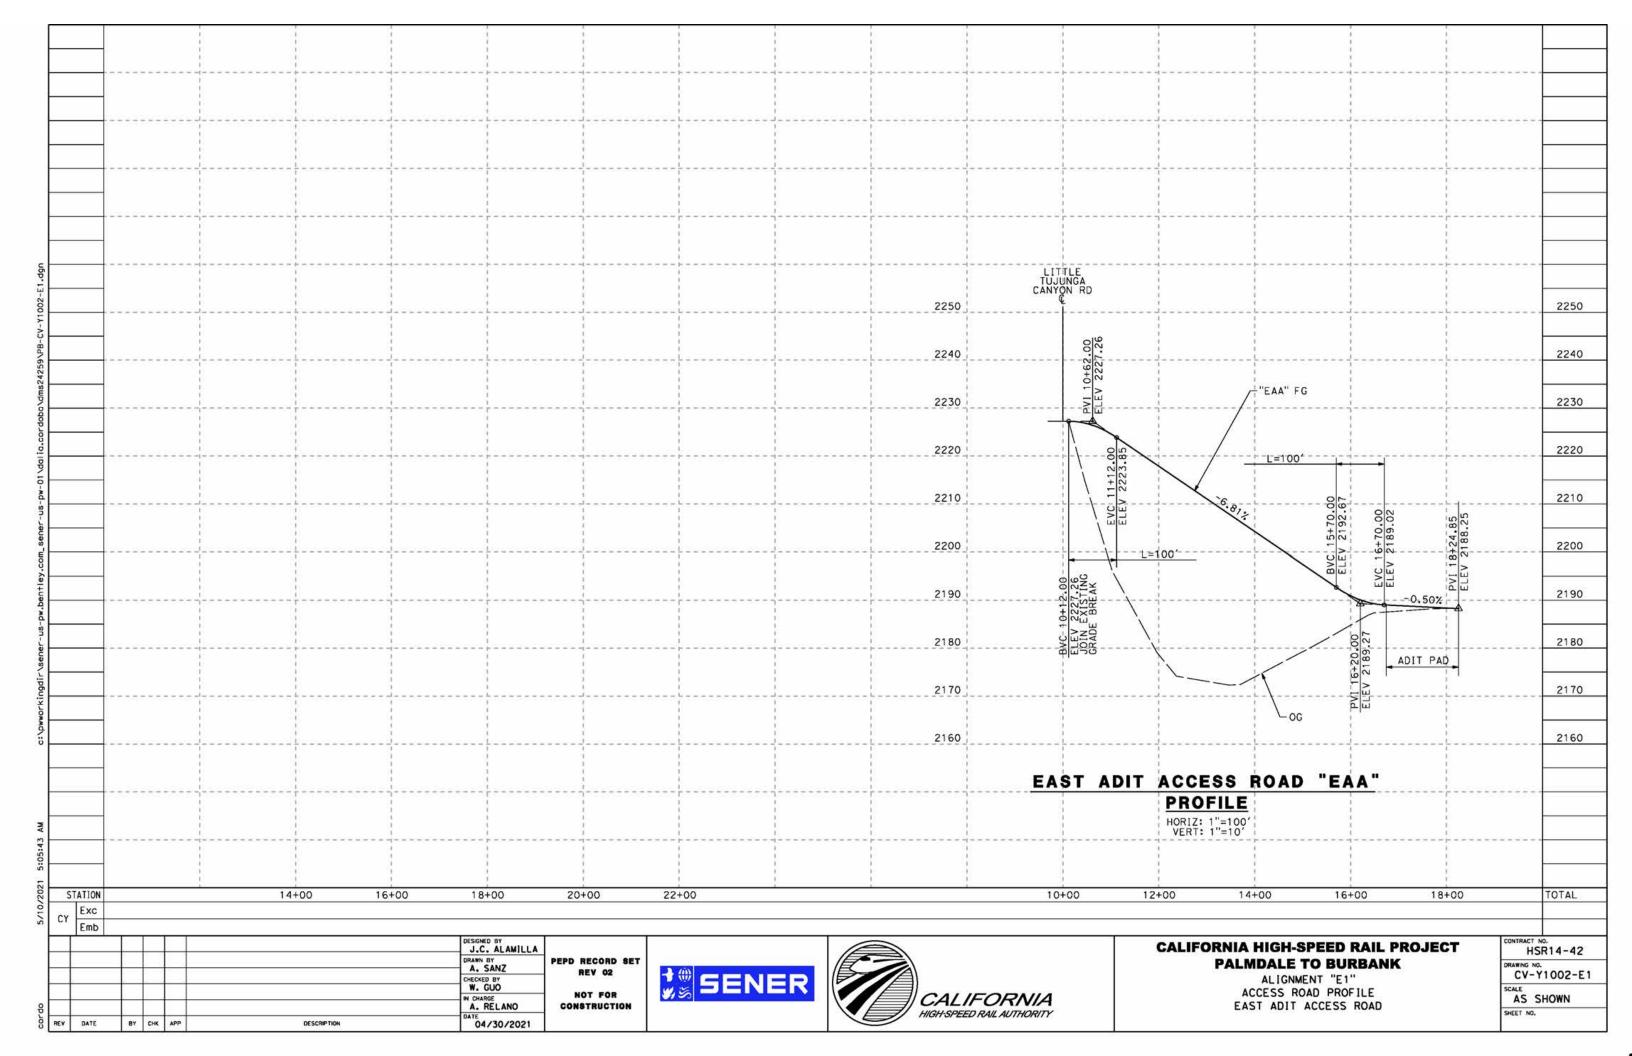

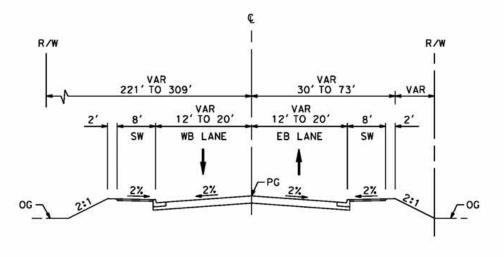

VALLEY FORGE

STA 10+34 TO 15+34 RESIDENTIAL STREET (E) PER CITY OF PALMDALE GENERAL PLAN

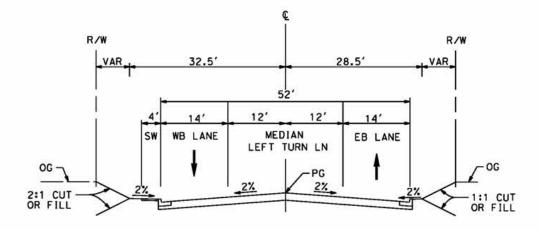

EAST AVENUE R11

STA 10+00 TO STA 18+73 LOCAL INTERIOR STREET PER CITY OF PALMDALE GENERAL PLAN

CHECKED BY	1
W. GUO IN CHARGE A. RELANO	
L	

PEPD RECORD SET REV 02 NOT FOR CONSTRUCTION






CALIFORNIA HIGH-SPEED RAIL PROJECT PALMDALE TO BURBANK

ALIGNMENT "E1" TYPICAL SECTIONS VALLEY FORGE AND EAST AVE R11

DRAWING	NO.
CV	-Y3001-E1
SCALE	100000000000000000000000000000000000000
NO	SCALE

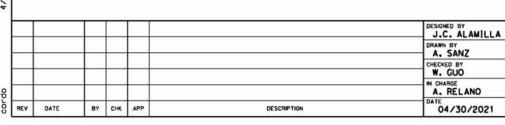

PEPD RECORD SET REV 02 NOT FOR

CONSTRUCTION

R/W

2:1 CUT OR FILL 15'

* SENER



R/W

CALIFORNIA HIGH-SPEED RAIL PROJECT PALMDALE TO BURBANK

ALIGNMENT "E1"
TYPICAL SECTIONS
CARSON MESA ACCESS ROAD AND ACCESS ROAD 3

DRAWING	NO.
CV	-Y3002-E1
SCALE	
NO	SCALE
NO	SCALE

25'

NB LANE SB LANE


ACCESS ROAD 3 STA 0+00 TO STA 7+30

12.5

CARSON MESA ACCESS ROAD

STA 1+00 TO STA 17+28



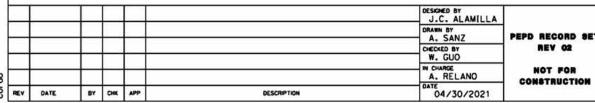

PEPD RECORD SET REV 02 NOT FOR





R/W

VARIABLE 25'

EAST ADIT ACCESS ROAD STA 10+00 TO STA 18+25

12.5

CALIFORNIA HIGH-SPEED RAIL PROJECT PALMDALE TO BURBANK

ALIGNMENT "E1"
TYPICAL SECTIONS EAST ADIT ACCESS ROAD

	SR14-42
DRAWING CV	мо. - Y 3003-E
SCALE NO	SCALE
SHEET N	



CV-R4006-E2

SIXTH ST

FIFTH ST

PEPD RECORD SET REV 02 NOT FOR CONSTRUCTION



- C CHSR ALIGNMENT "E2"

CV-R4009-E2


CV-R4008-E2

LAKE PALMDALE

<u>E2</u>


CV-R4007-E2



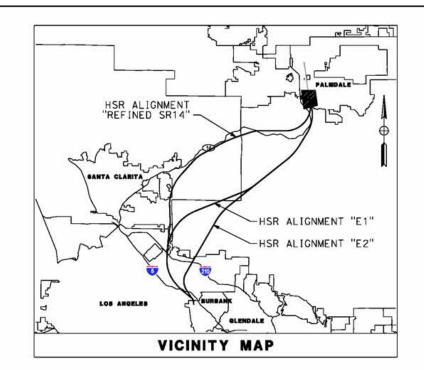

LEGEND:

ROADWAY PLAN AND ACCESS ROAD PLAN

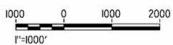


CALIFORNIA HIGH-SPEED RAIL PROJECT PALMDALE TO BURBANK

ALIGNMENT "E2"
ROADWAY AND GRADE SEPARATION PLAN KEY MAP SHEET 1 OF 3

CONTRACT N	o. ?14-42
DRAWING NO.	0001-E2
SCALE AS	SHOWN

SHEET NO.

GRADE SEPARATION PLAN

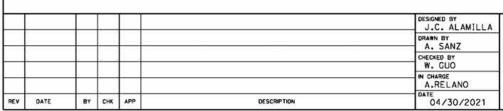

CV-R4023-E2

PEPD RECORD SE REV 02 NOT FOR





LEGEND: ROADWAY PLAN AND ACCESS ROAD PLAN GRADE SEPARATION PLAN

HSR ALIGNMENT "REFINED SR14"

VICINITY MAP

CALIFORNIA HIGH-SPEED RAIL PROJECT PALMDALE TO BURBANK

ALIGNMENT "E2"
ROADWAY AND GRADE SEPARATION PLAN KEY MAP SHEET 2 OF 3

CONTRACT NO. HSR14-42
DRAWING NO. CV-B0002-E2
SCALE AS SHOWN
SHEET NO.

2000

1000

MEST IT

-HSR ALIGNMENT "E1" -HSR ALIGNMENT "E2"

€ CHSR ALIGNMENT "E1/E2" -

& CHSR ALIGNMENT "E2"

CV-R4018-E2

E2


SIERRA HIGHWAY

CV-R4019-E2

CV-R4020-E2

<u>E2</u>

PEPD RECORD SET		/
REV 02	##SENER	
NOT FOR CONSTRUCTION	W. 50	1

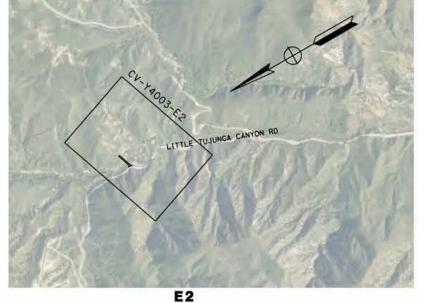



AT APRROXIMATE CHSR ALIGNMENT "E2" STA 1463+50

LEGEND:

ROADWAY PLAN AND ACCESS ROAD PLAN

GRADE SEPARATION PLAN

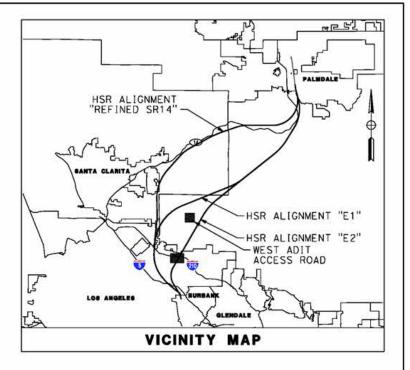

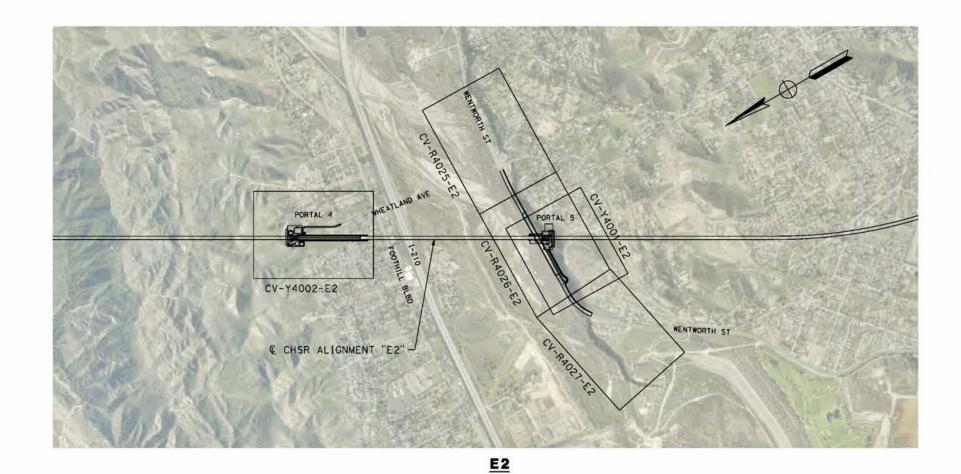

1"=1000'

						J.C. ALAMILLA	
		1				DRAWN BY A. SANZ	PEP
		+	-			W. GUO	
H			-			IN CHARGE A.RELANO	c
REV	DATE	84	СНК	APP	DESCRIPTION	DATE 04/30/2021	~

PEPD RECORD SET REV 02 NOT FOR CONSTRUCTION






CALIFORNIA HIGH-SPEED RAIL PROJECT PALMDALE TO BURBANK

ALIGNMENT "E2"
ROADWAY AND GRADE SEPARATION PLAN
KEY MAP
SHEET 3 OF 3

CONTRAC	T NO. SR14-42
DRAWING CV:	NO. -B0003-E2
SCALE	SHOWN

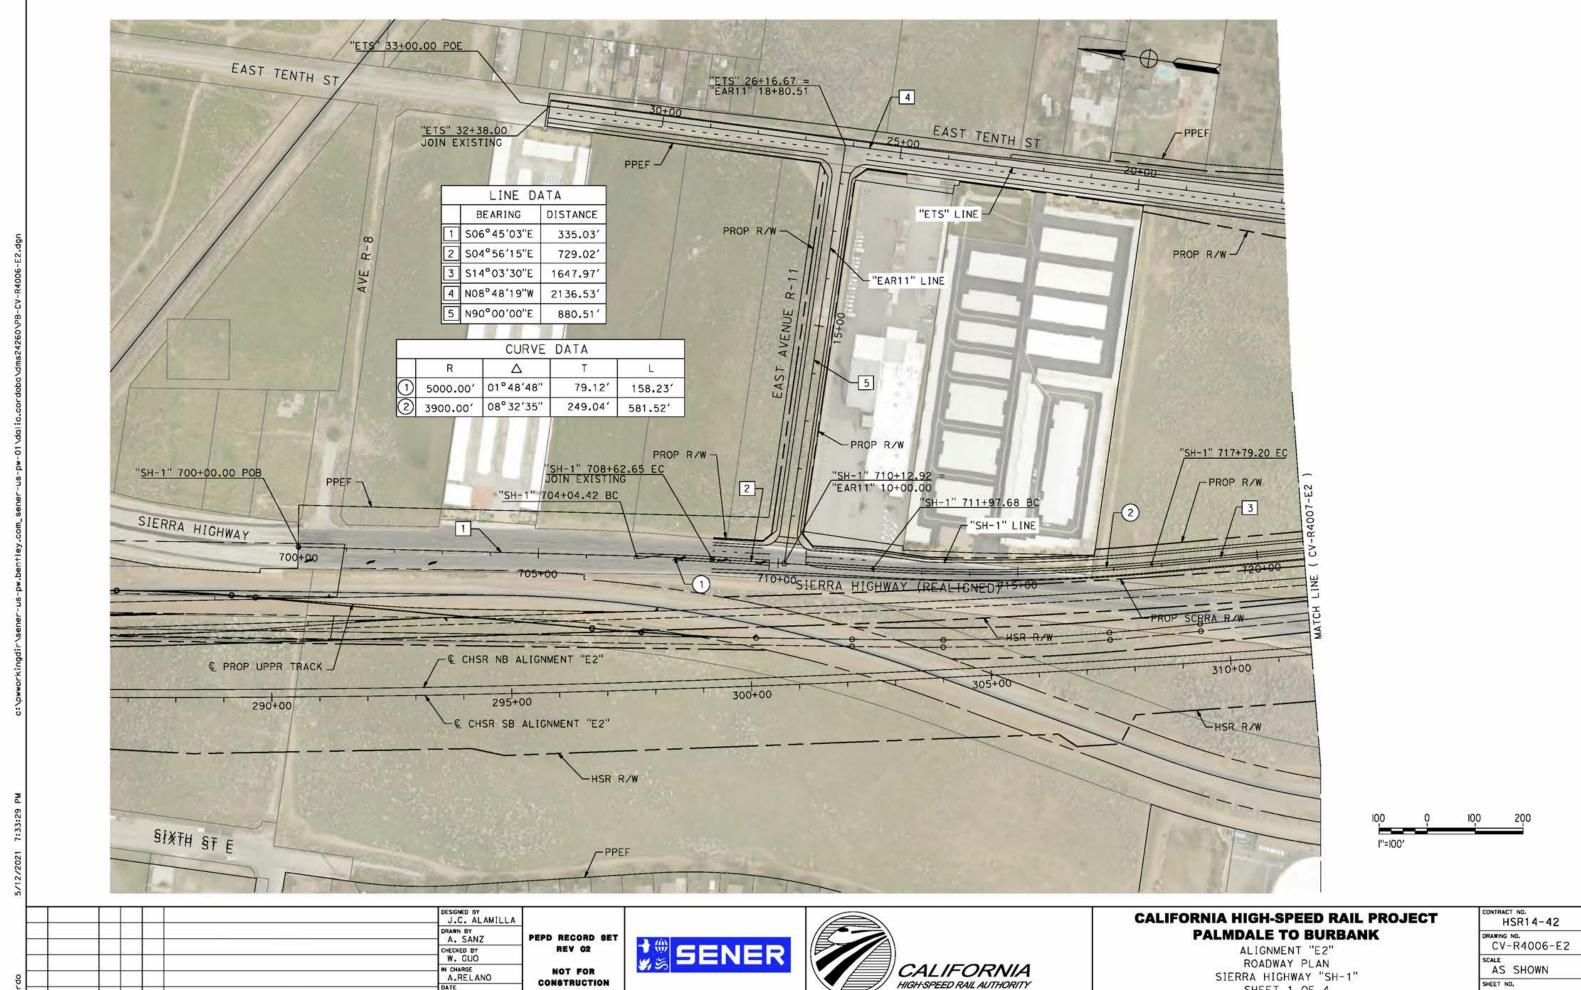



04/30/2021

BY CHK APP

DESCRIPTION

SHEET 1 OF 4

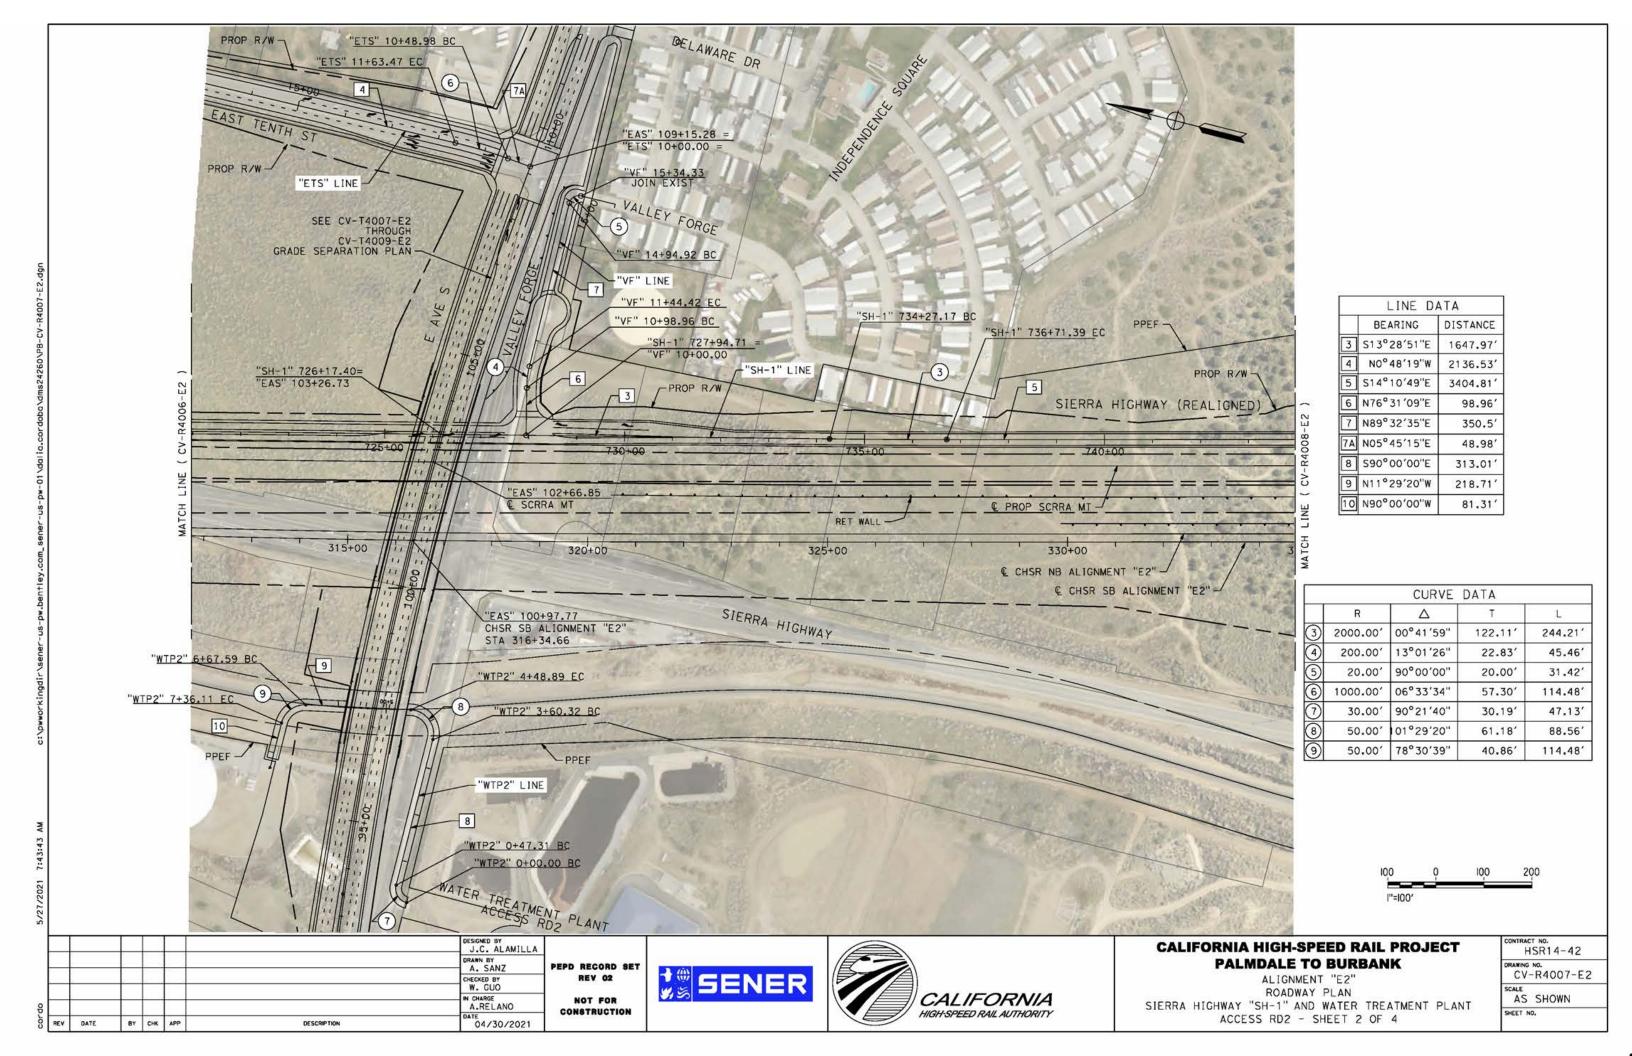

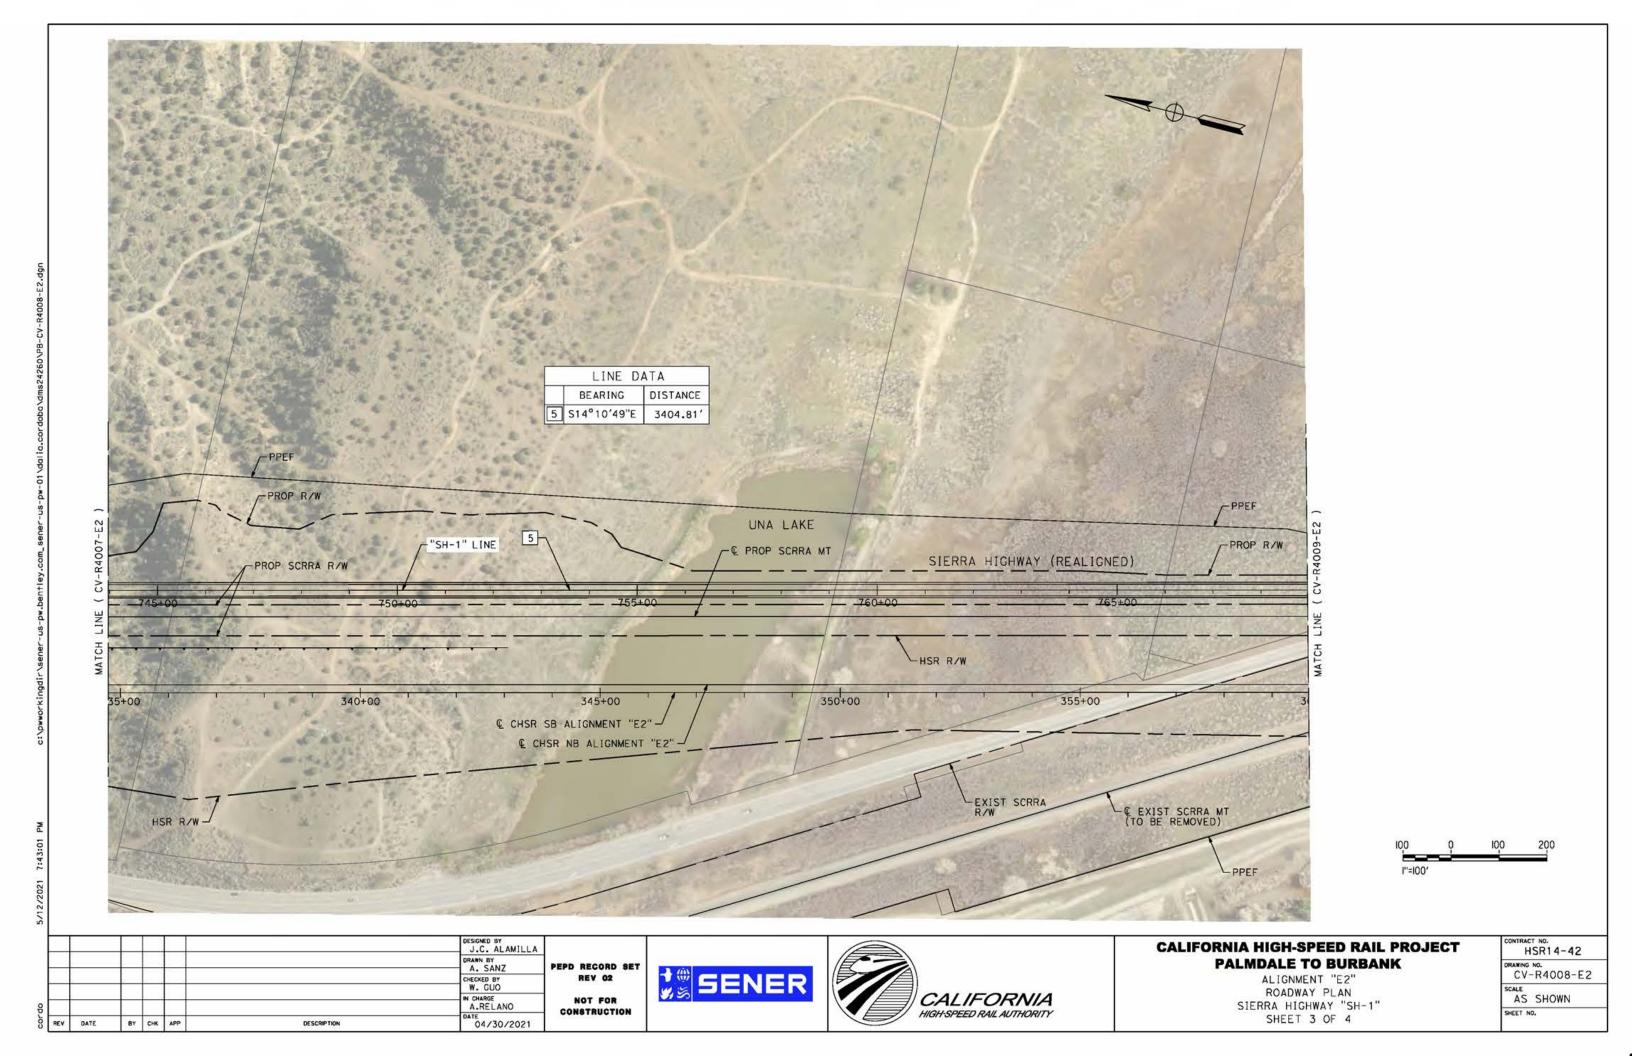

HIGH-SPEED RAIL AUTHORITY

SHEET NO.


SHEET 4 OF 4

CONSTRUCTION

04/30/2021

BY CHK APP

DESCRIPTION

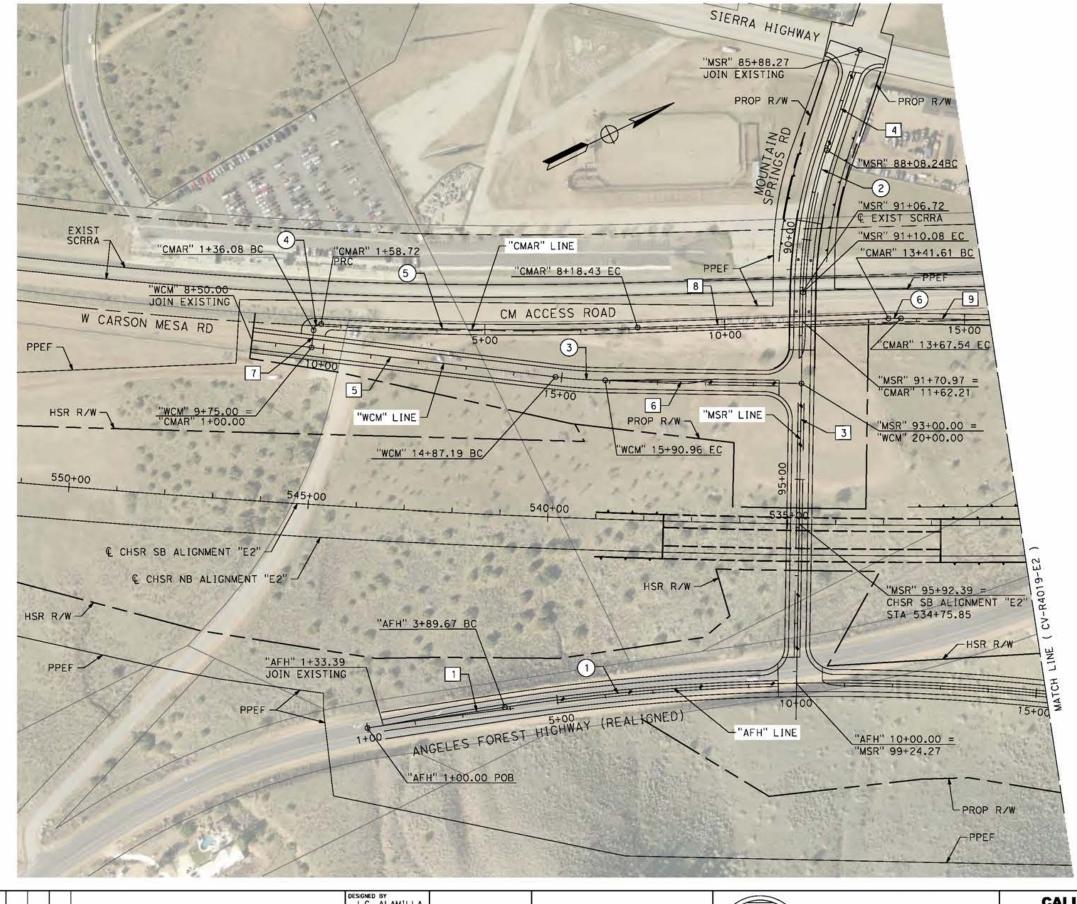

_	LINE D	1.1.0
	BEARING	DISTANCE
1	N17°29′36"E	256.29'
3	S62°58′16"E	814.19
4	S45°40′37"E	219.97
5	N32°58′29"E	664.55
6	N27°01′44"E	409.04
7	N57°01'31"W	36.08′
8	N24°02′23"E	523.18'
9	N27°01'44"E	360.52

		CURVE	DATA	
	R	Δ	T	L
1	4500.00'	15°15′24"	602.75	1198.37'
2	1000.00	17°17′39"	152.08'	301.84
3	1000.00'	05°56′46"	51.94	103.78
4	15.00′	86°27′45"	14.10	22.64
(5)	7003.00	05°23′51"	330.10′	659.71
6	497.00	2°59′20"	12.97′	25.93



						J.C. ALAMILLA	
\Box		-				DRAWN BY A. SANZ	PEPD RECORD SET
\dashv		+				CHECKED BY W. GUO	REV 02
\dashv		+				IN CHARGE A. RELANO	NOT FOR CONSTRUCTION
REV	DATE	84	СНК	APP	DESCRIPTION	04/30/2021	CONSTRUCTION


SENER



CALIFORNIA HIGH-SPEED RAIL PROJECT PALMDALE TO BURBANK


ALIGNMENT "E2" ROADWAY PLAN ANGELES FOREST HIGHWAY, W CARSON MESA ROAD AND MOUNTAIN SPRINGS ROAD

CONTRAC	T NO. SR14-42
DRAWING CV-	NO. -R4018-E2
SCALE	SHOWN

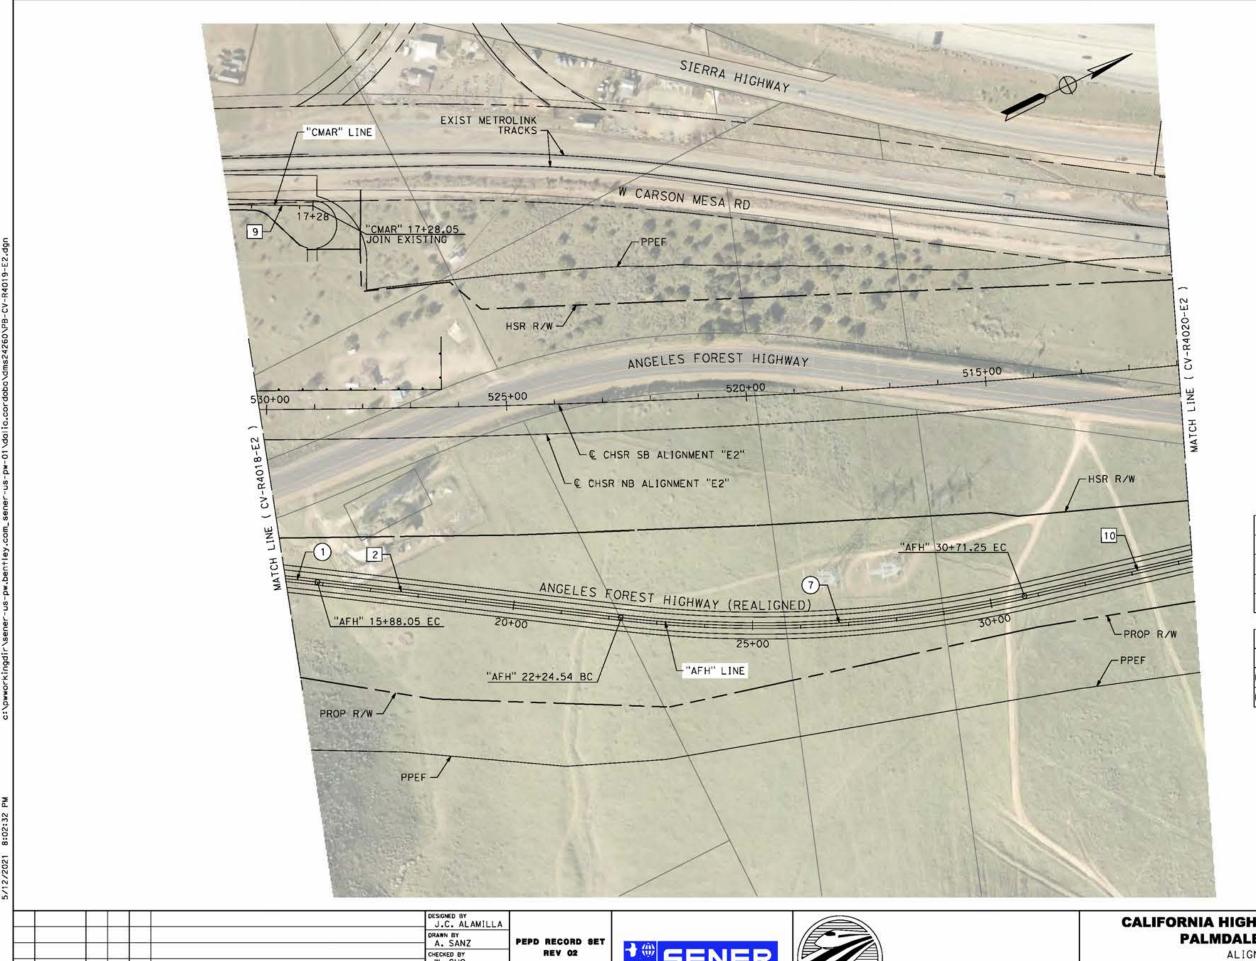

	LINE DA	ATA
	BEARING	DISTANCE
2	N32°45′05"E	636.49
9	N27°01′44"E	360.52
10	N13°20′47"E	731.75

		CURVE	DATA	
	R	Δ	T	L
1	4500.00'	15°15′29"	602.75	1198.37"
7	2500.00'	19°24′18"	427.45	846.71

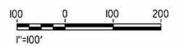

						J.C. ALAMILLA
-		-				DRAWN BY A. SANZ
\dashv		-				CHECKED BY W. GUO
\dashv		+		\vdash		IN CHARGE A.RELANO
REV	DATE	BY	CHK	APP	DESCRIPTION	DATE 04/30/2021

NOT FOR CONSTRUCTION






CALIFORNIA HIGH-SPEED RAIL PROJECT PALMDALE TO BURBANK

ALIGNMENT "E2" ROADWAY PLAN ANGELES FOREST HIGHWAY

CV-R4019-E
AS SHOWN

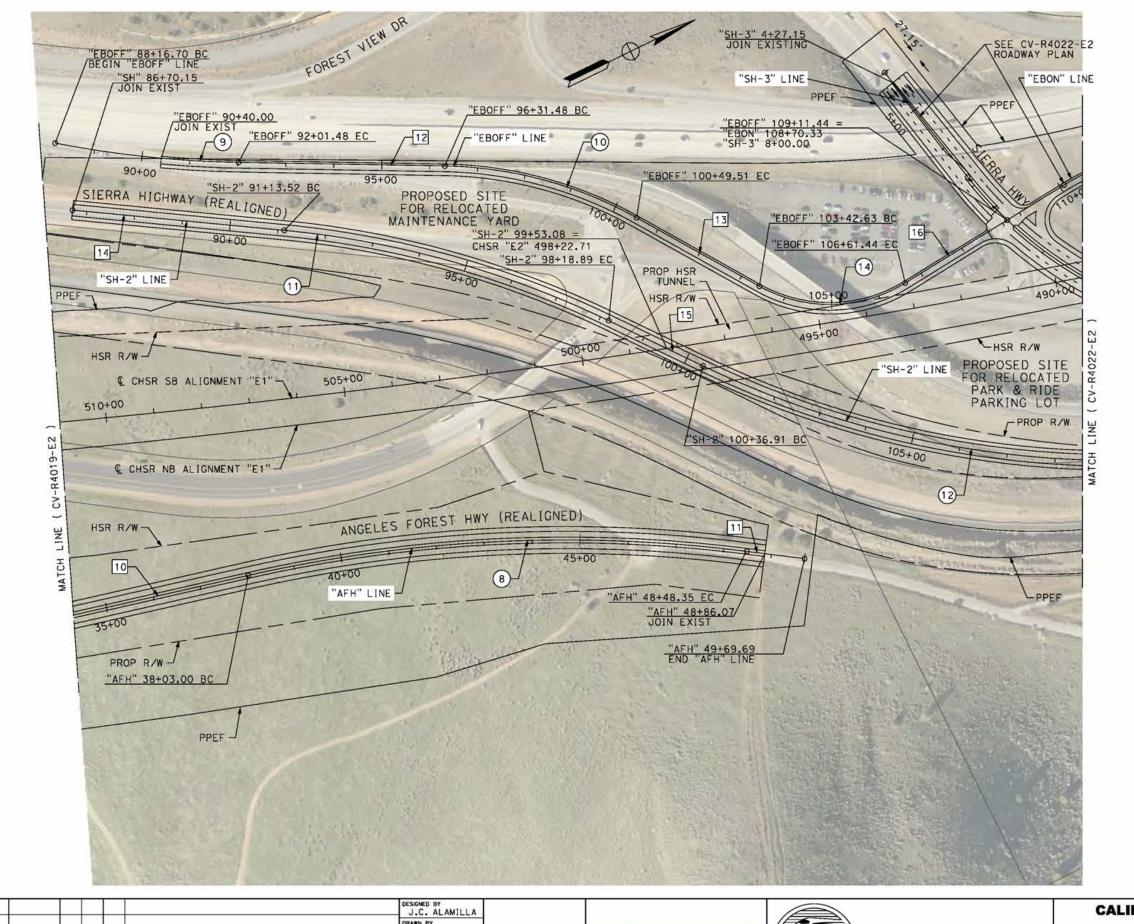

	LINE D	ATA
	BEARING	DISTANCE
10	N13°20'47"E	731.75
1.1	S33°18'40"E	121.14
12	N27°05′44"E	430.00
13	N55°16′24"E	293.12
14	N31°32′53″E	443.36
15	N51°45′19"E	218.02
16	NO5° 36'55"W	250.00′

		CURVE	DATA	
	R	Δ	T	L
8	3000.00'	19°57′53"	528.03'	1045.35
9	2200.00'	10°01′16"	192.88'	384.78
10	850.00'	28°10′40"	213.33'	418.03
1	2000.00'	20°12′27"	356.39	705.37
13	2000.00'	29°08′56"	520.01	1017.49
13	300.00	60°53′19"	176.32	318.81



						J.C. ALAMILLA	
		1				DRAWN BY A. SANZ	P
		-				CHECKED BY W. GUO	
\dashv		+		\vdash		IN CHARGE A.RELANO	
REV	DATE	84	СНК	APP	DESCRIPTION	DATE 04/30/2021	

PEPD RECORD SET REV 02 NOT FOR

CONSTRUCTION





CALIFORNIA HIGH-SPEED RAIL PROJECT PALMDALE TO BURBANK


ALIGNMENT "E2"


ROADWAY PLAN

SIERRA HIGHWAY "SH-2", ANGELES FOREST HIGHWAY AND

ROUTE 14 EB OFF-RAMP

CONTRA	CT NO.
- 6	T NO. HSR14-42
DRAWING	NO.
CV	-R4020-E2
SCALE	
AS	SHOWN

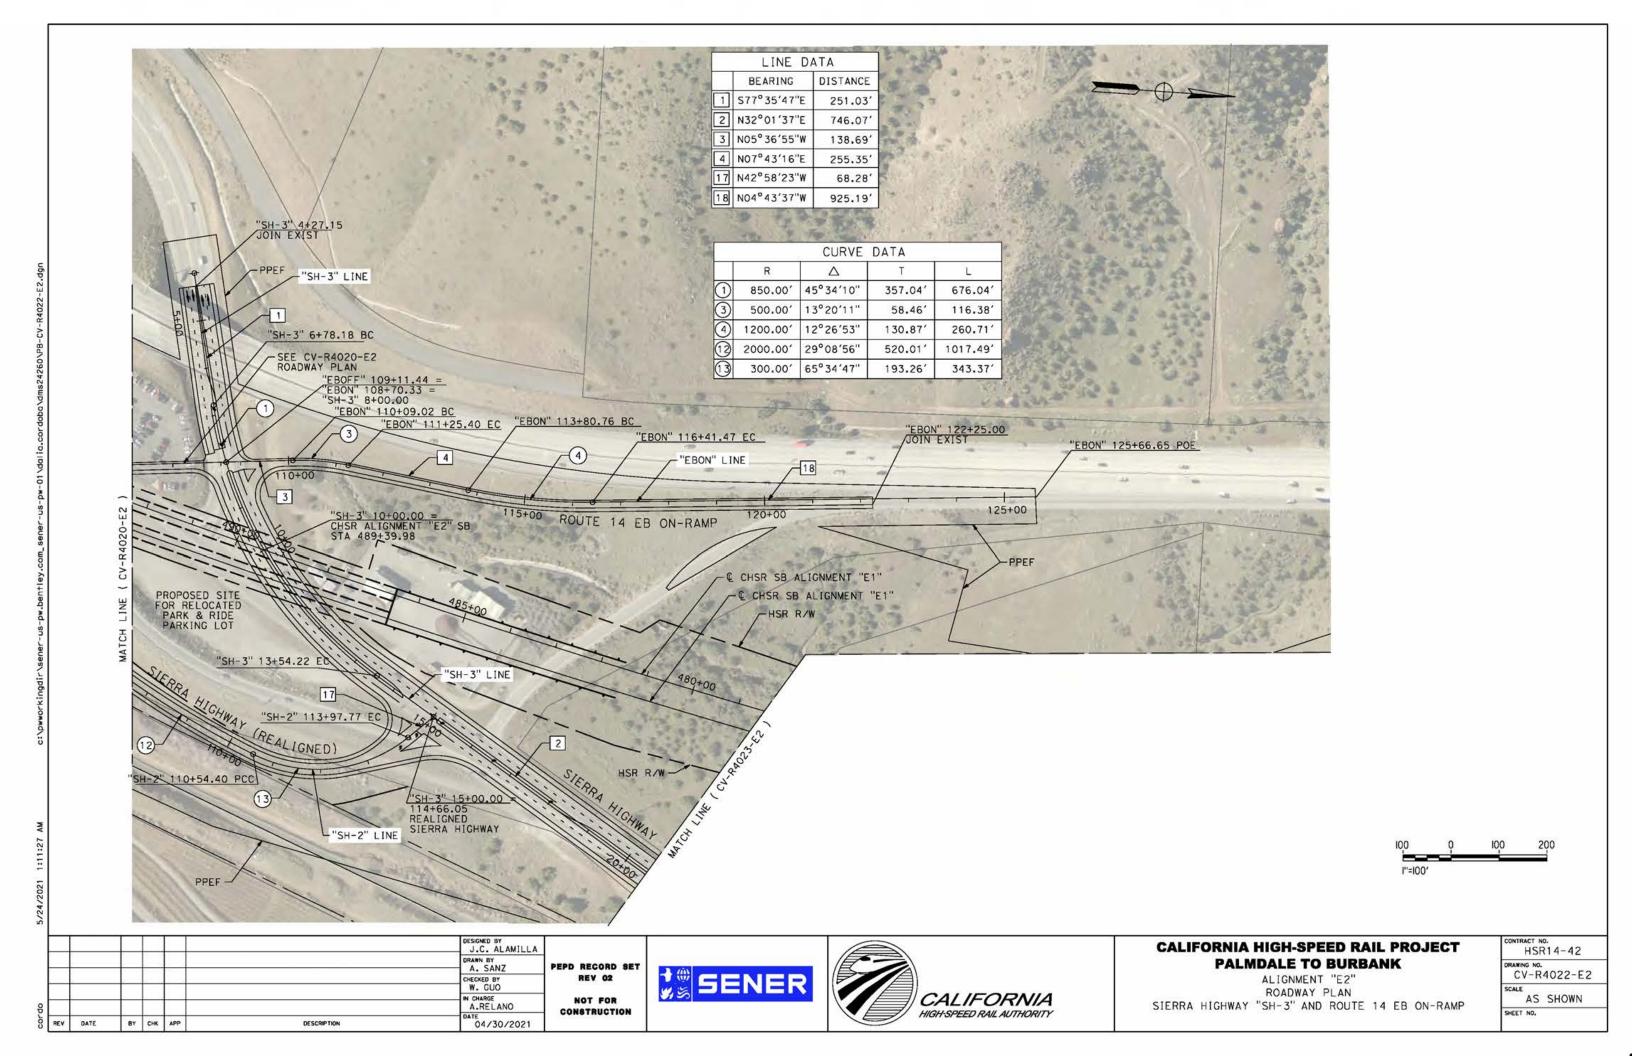


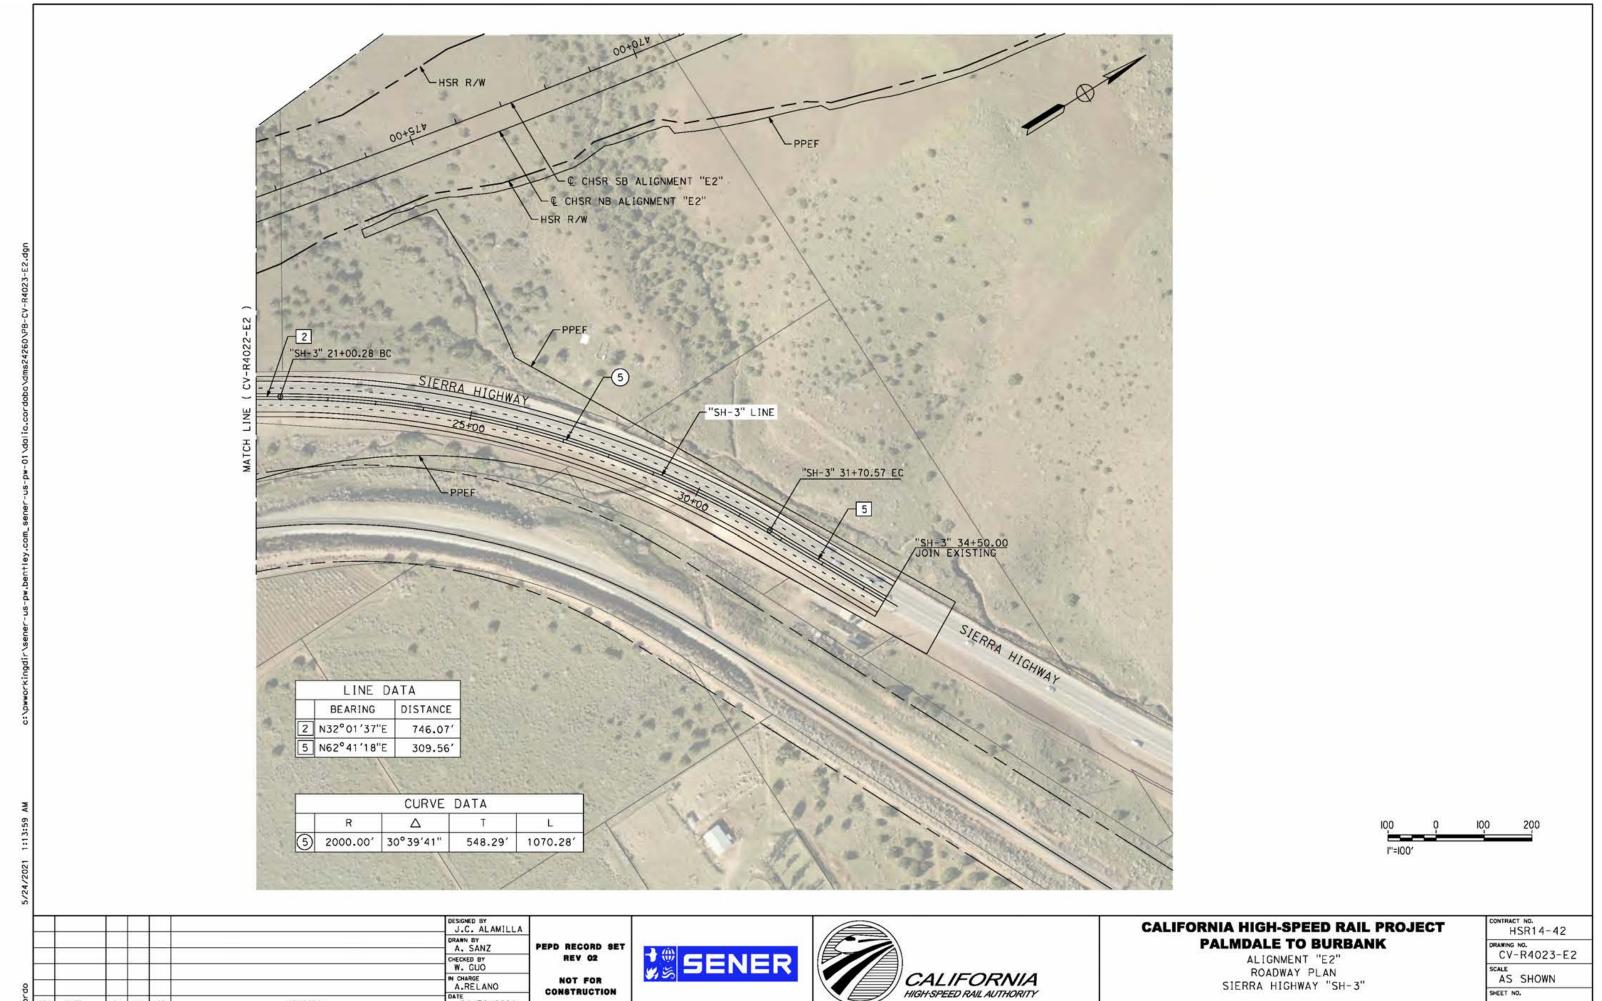


04/30/2021

DESCRIPTION

BY CHK APP

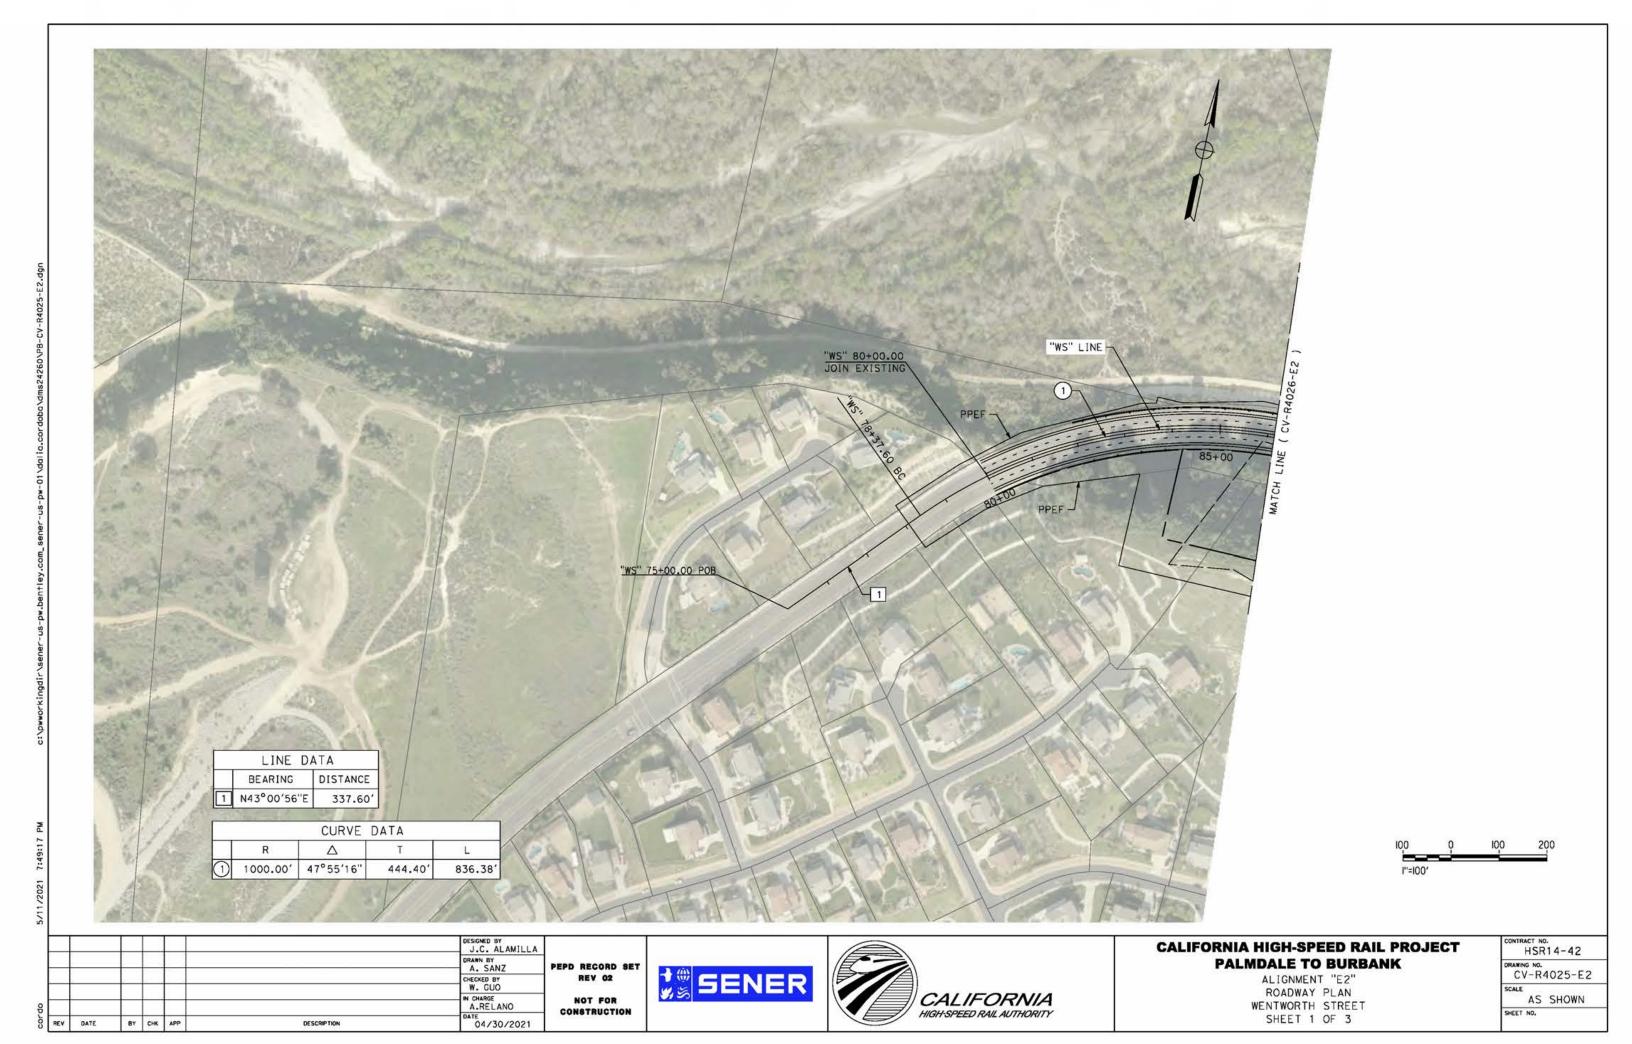

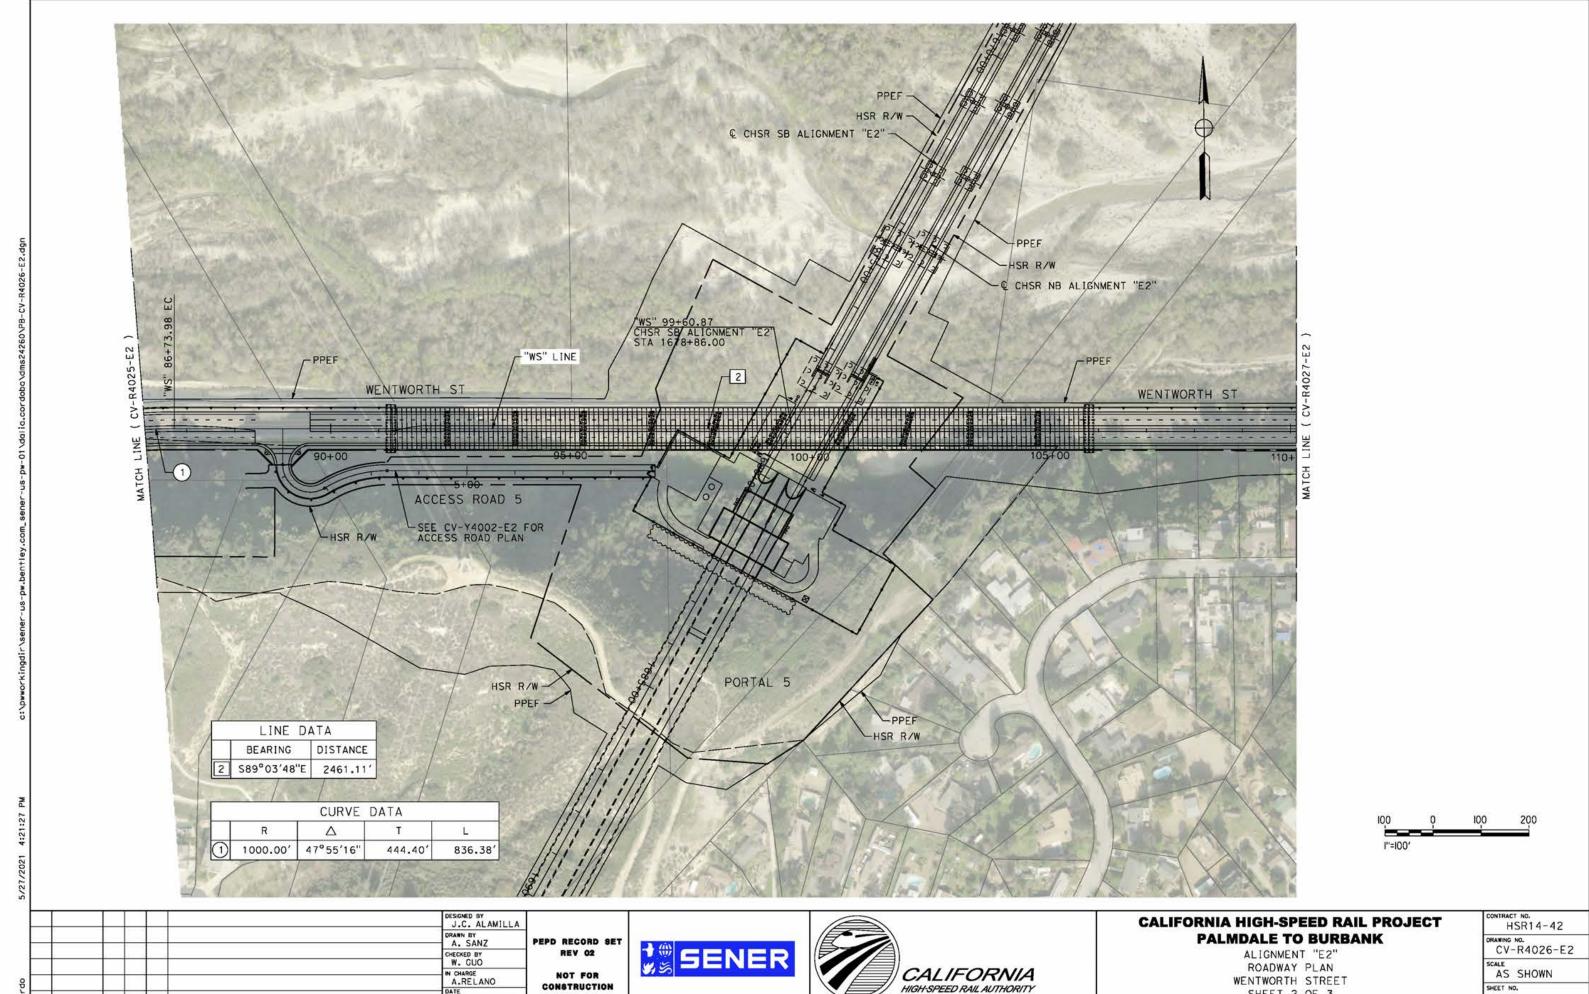


04/30/2021

BY CHK APP

DESCRIPTION

SHEET 2 OF 3

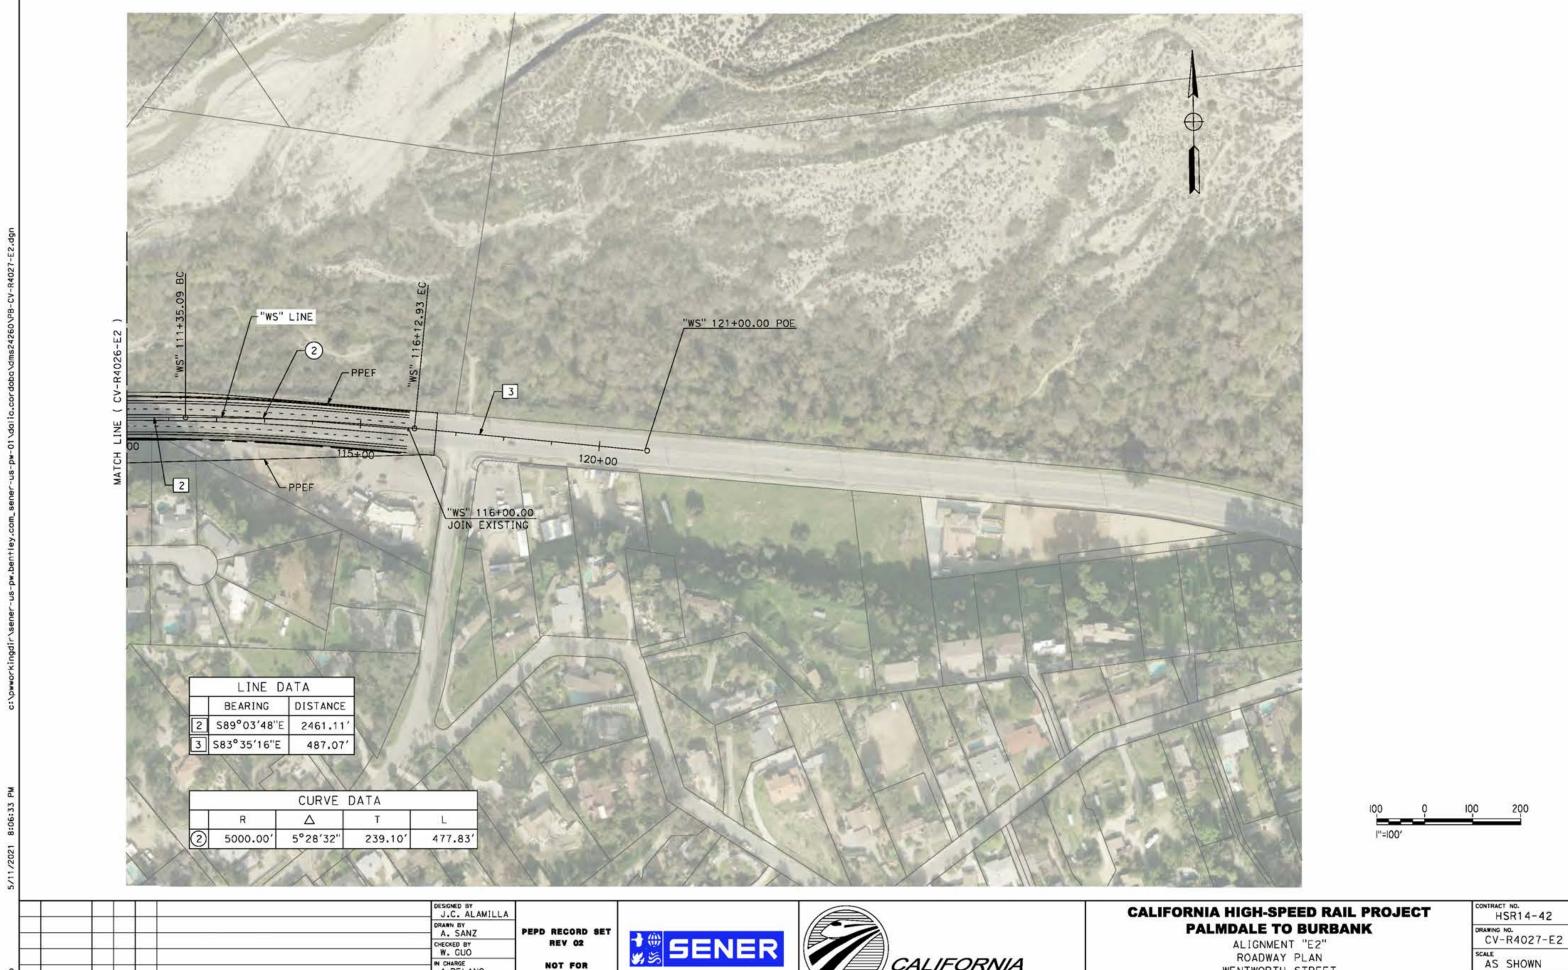

A.RELANO

DESCRIPTION

BY CHK APP

04/30/2021

NOT FOR


CONSTRUCTION


CALIFORNIA HIGH-SPEED RAIL AUTHORITY


SHEET NO.


WENTWORTH STREET


SHEET 3 OF 3

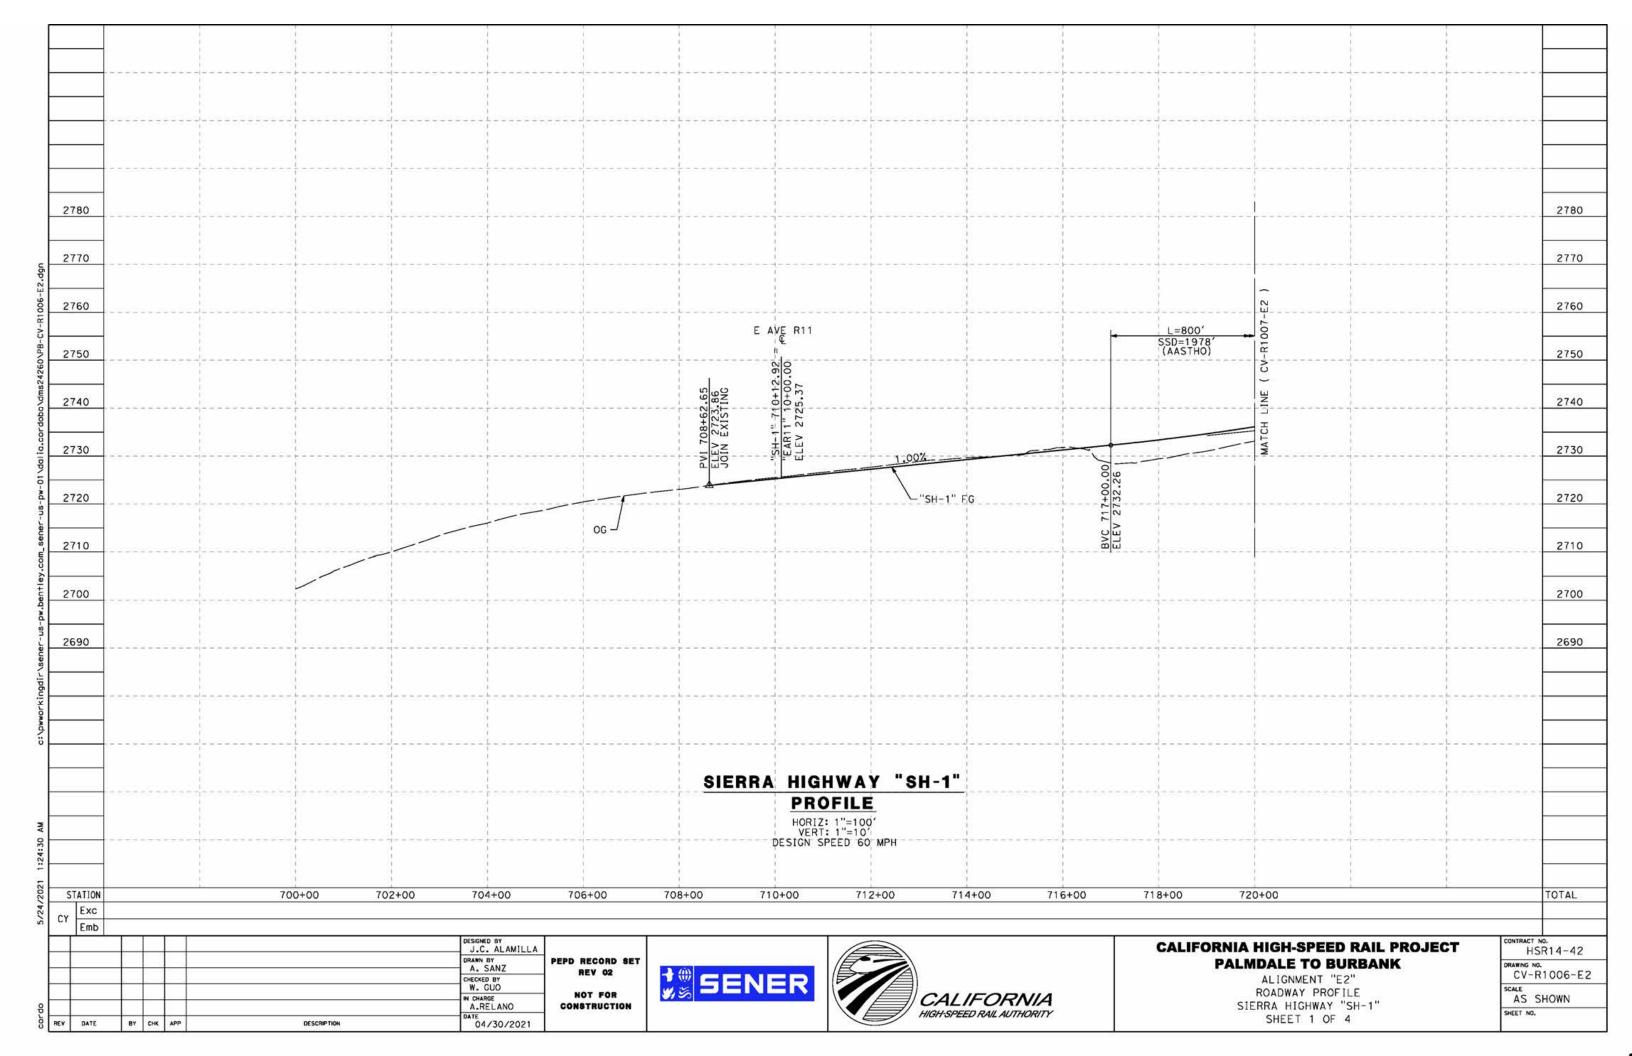


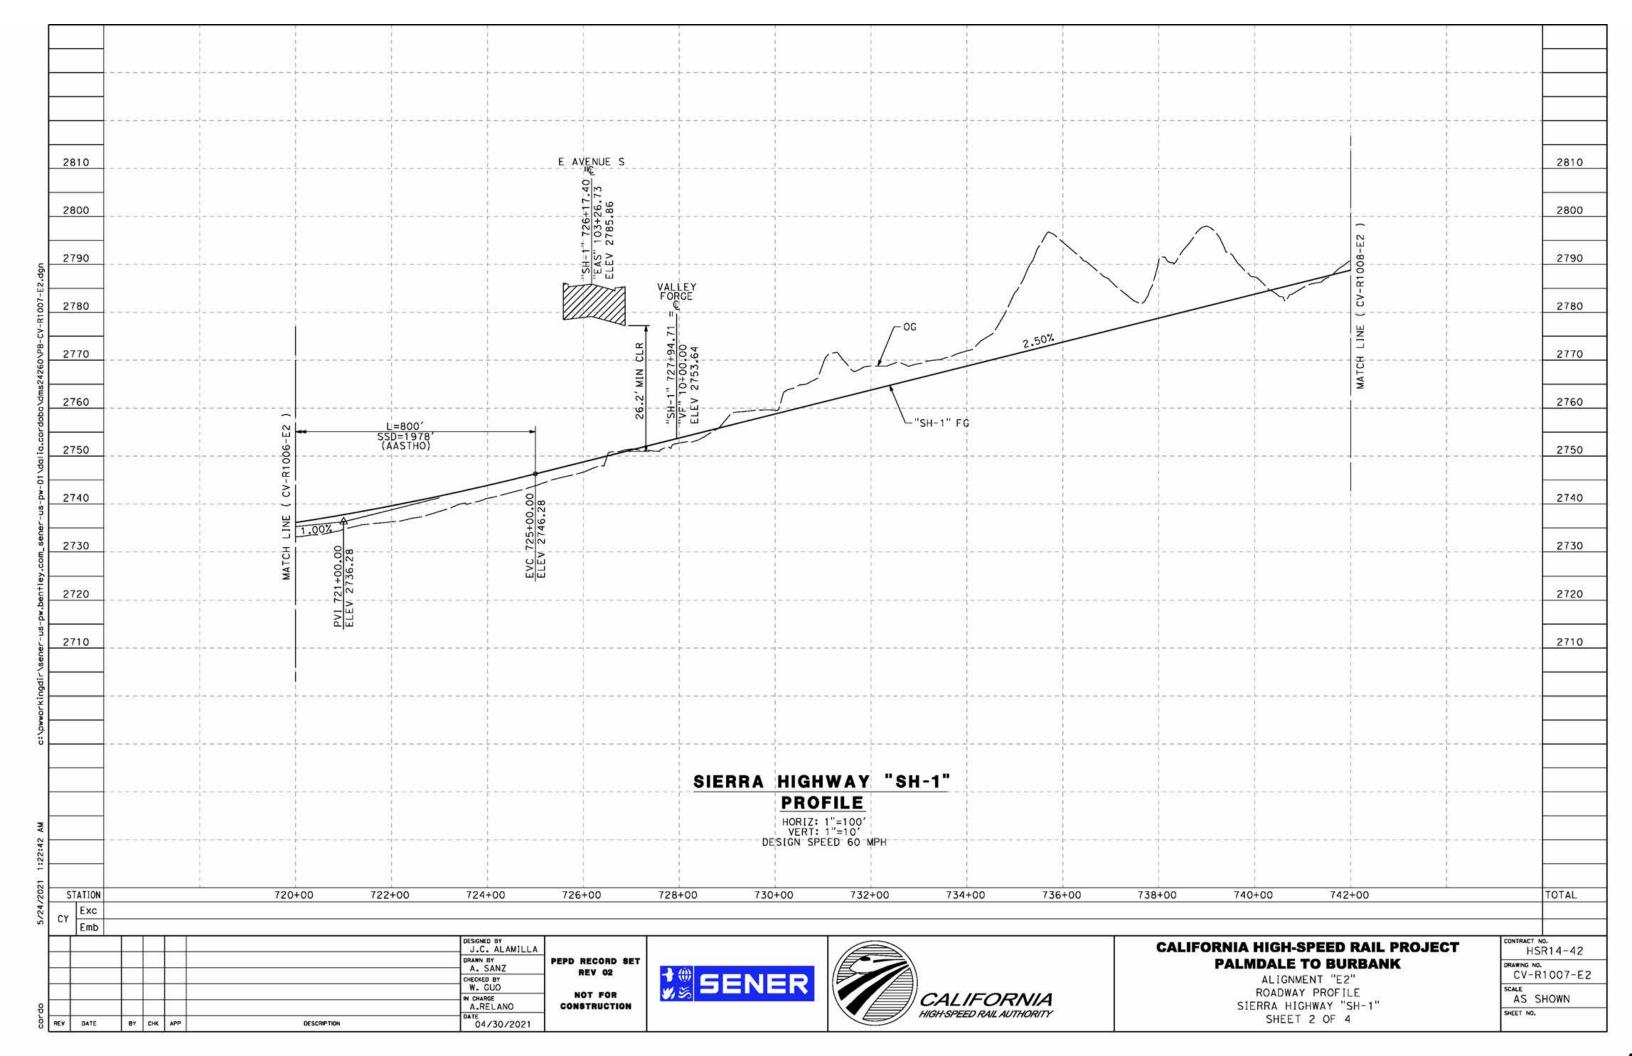


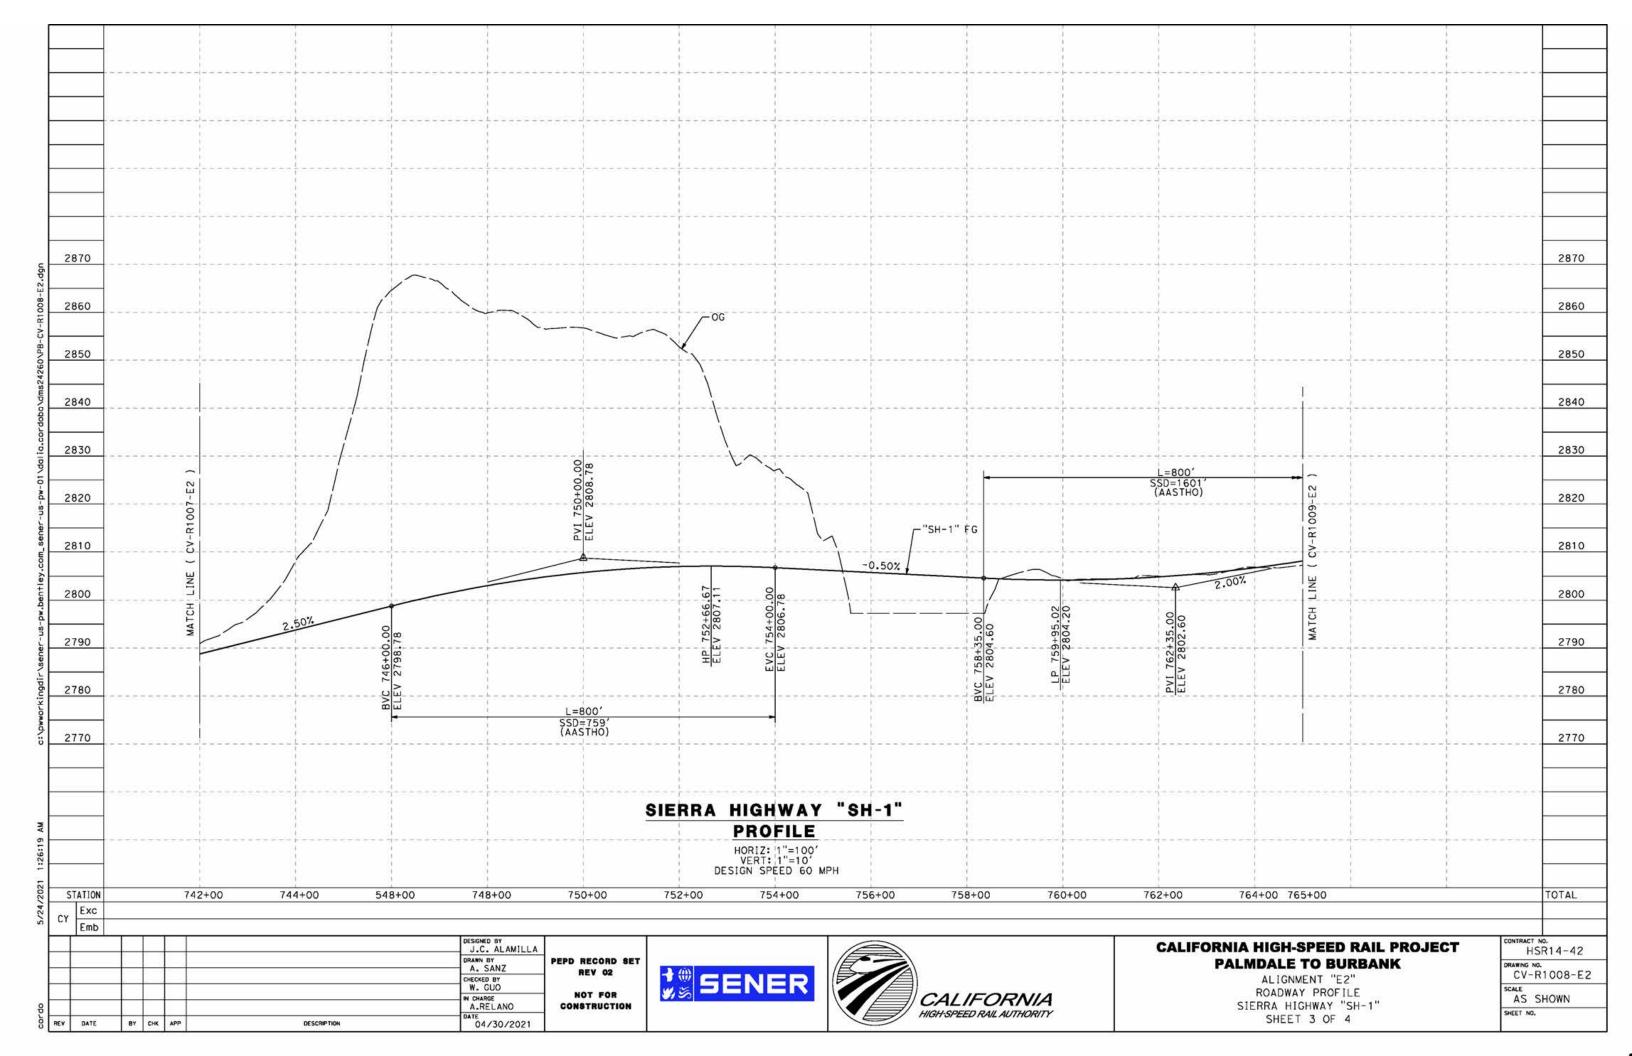


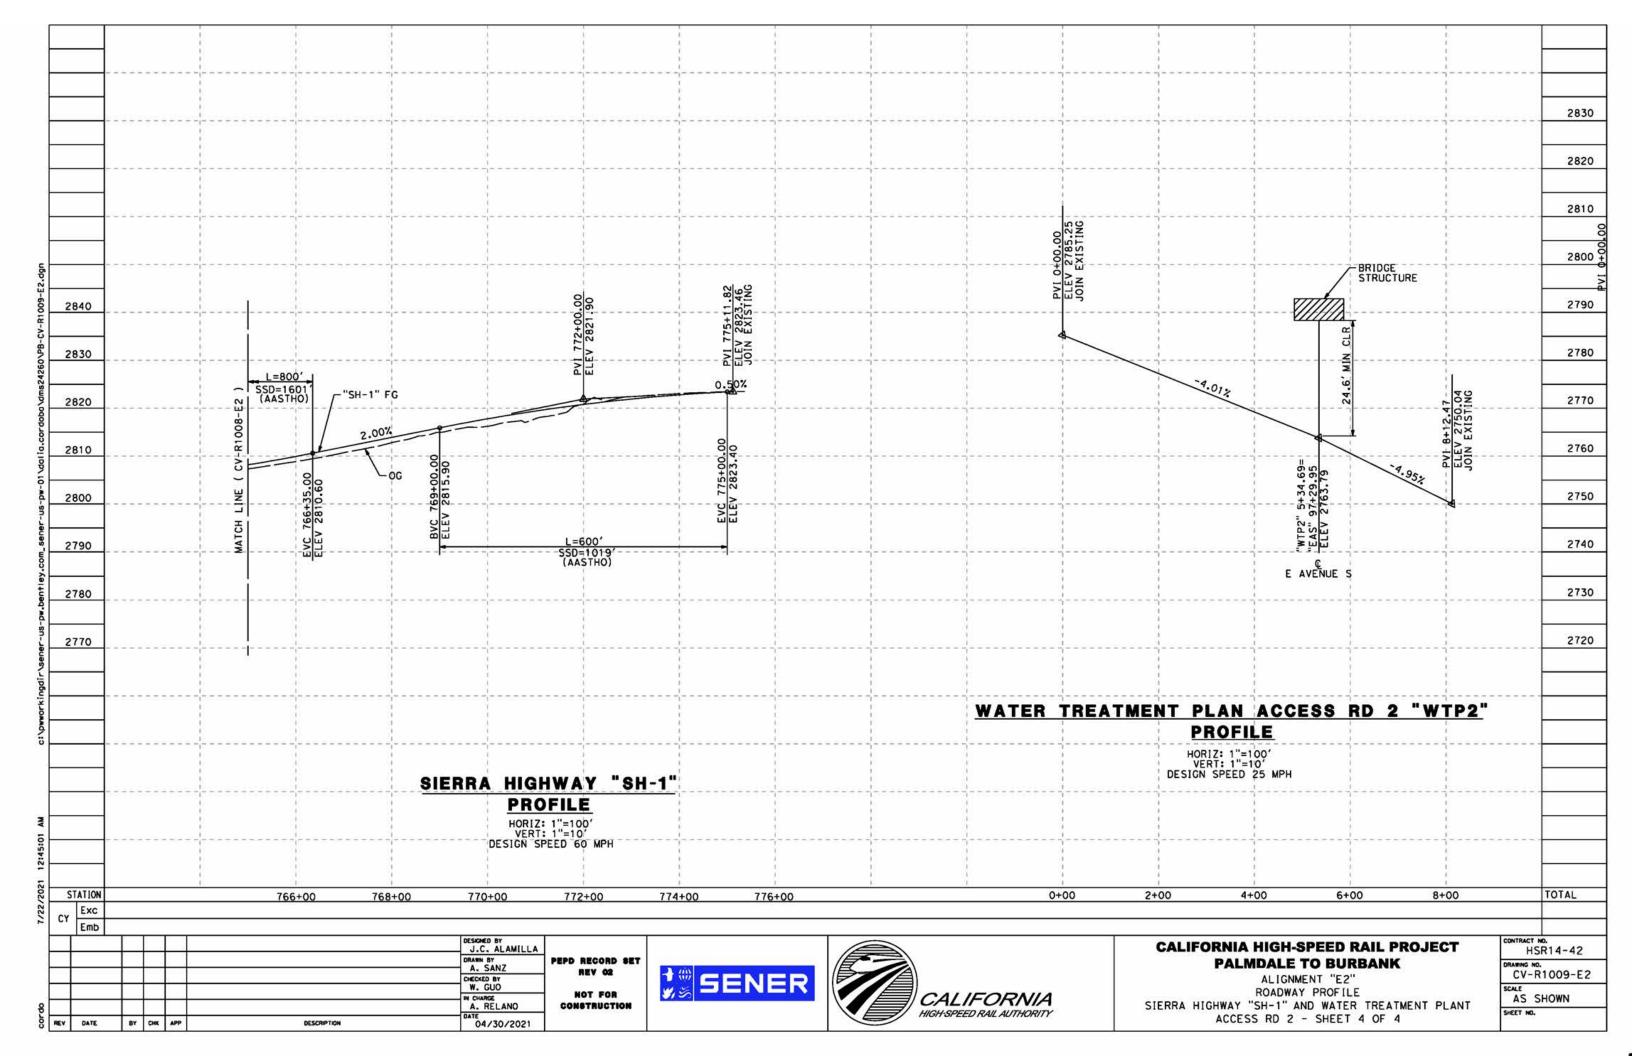


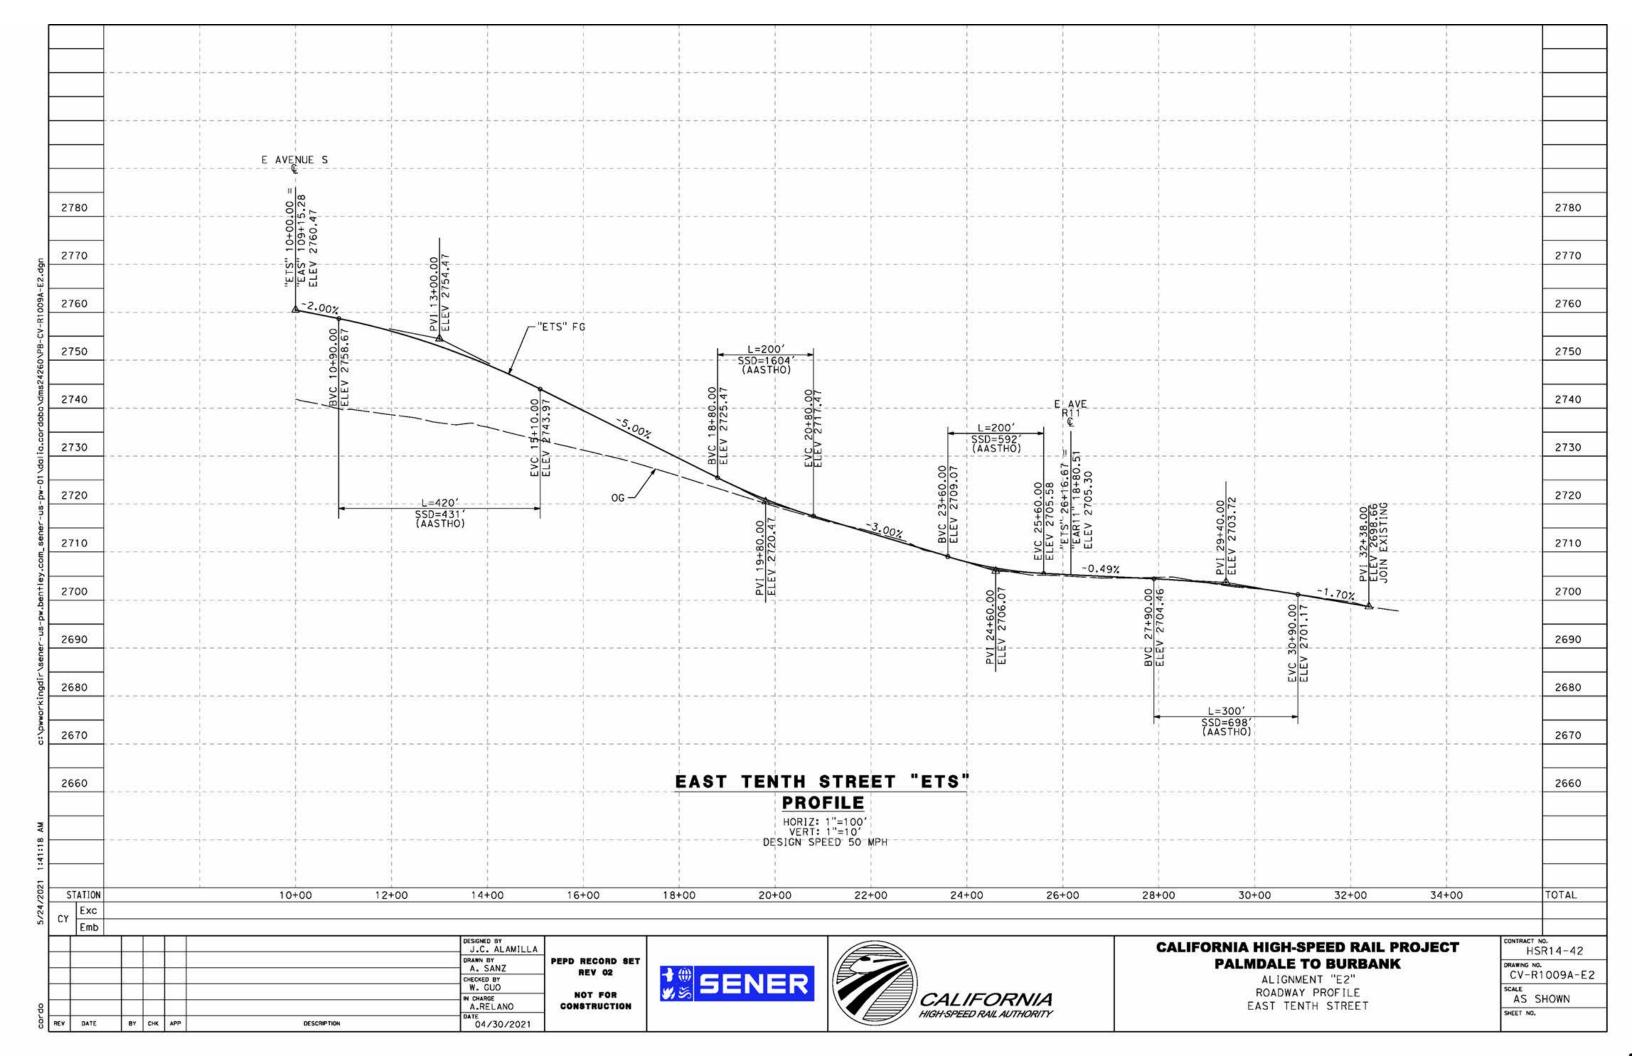


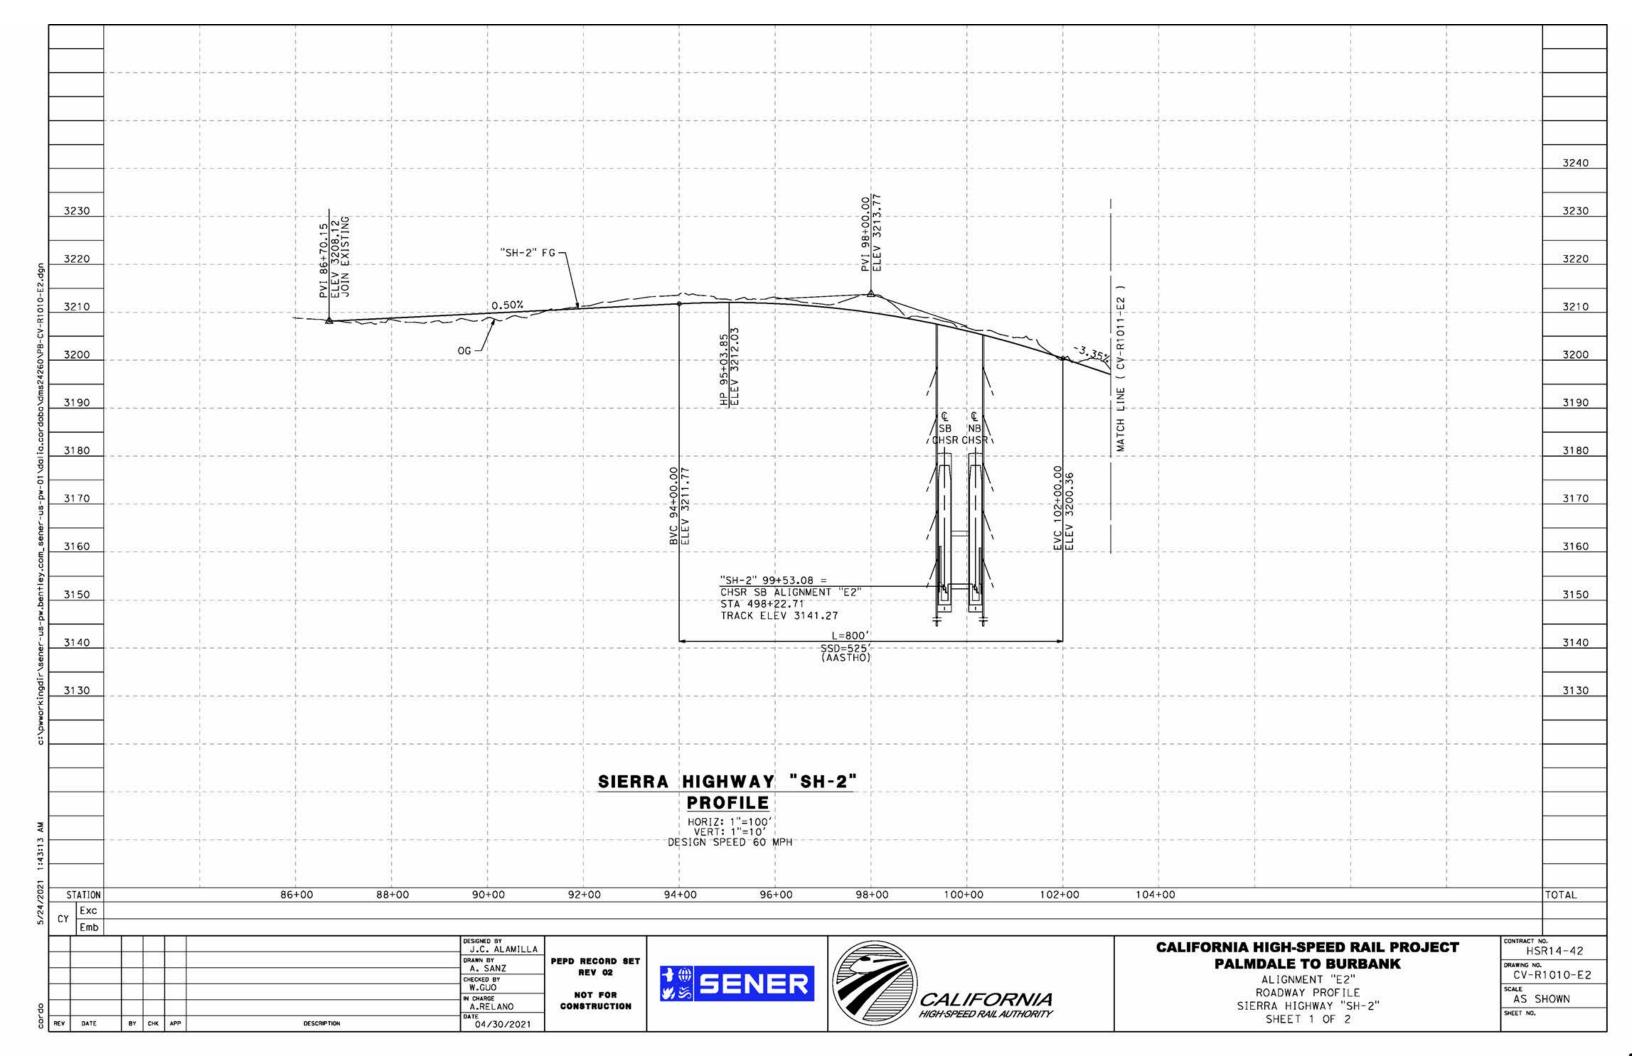


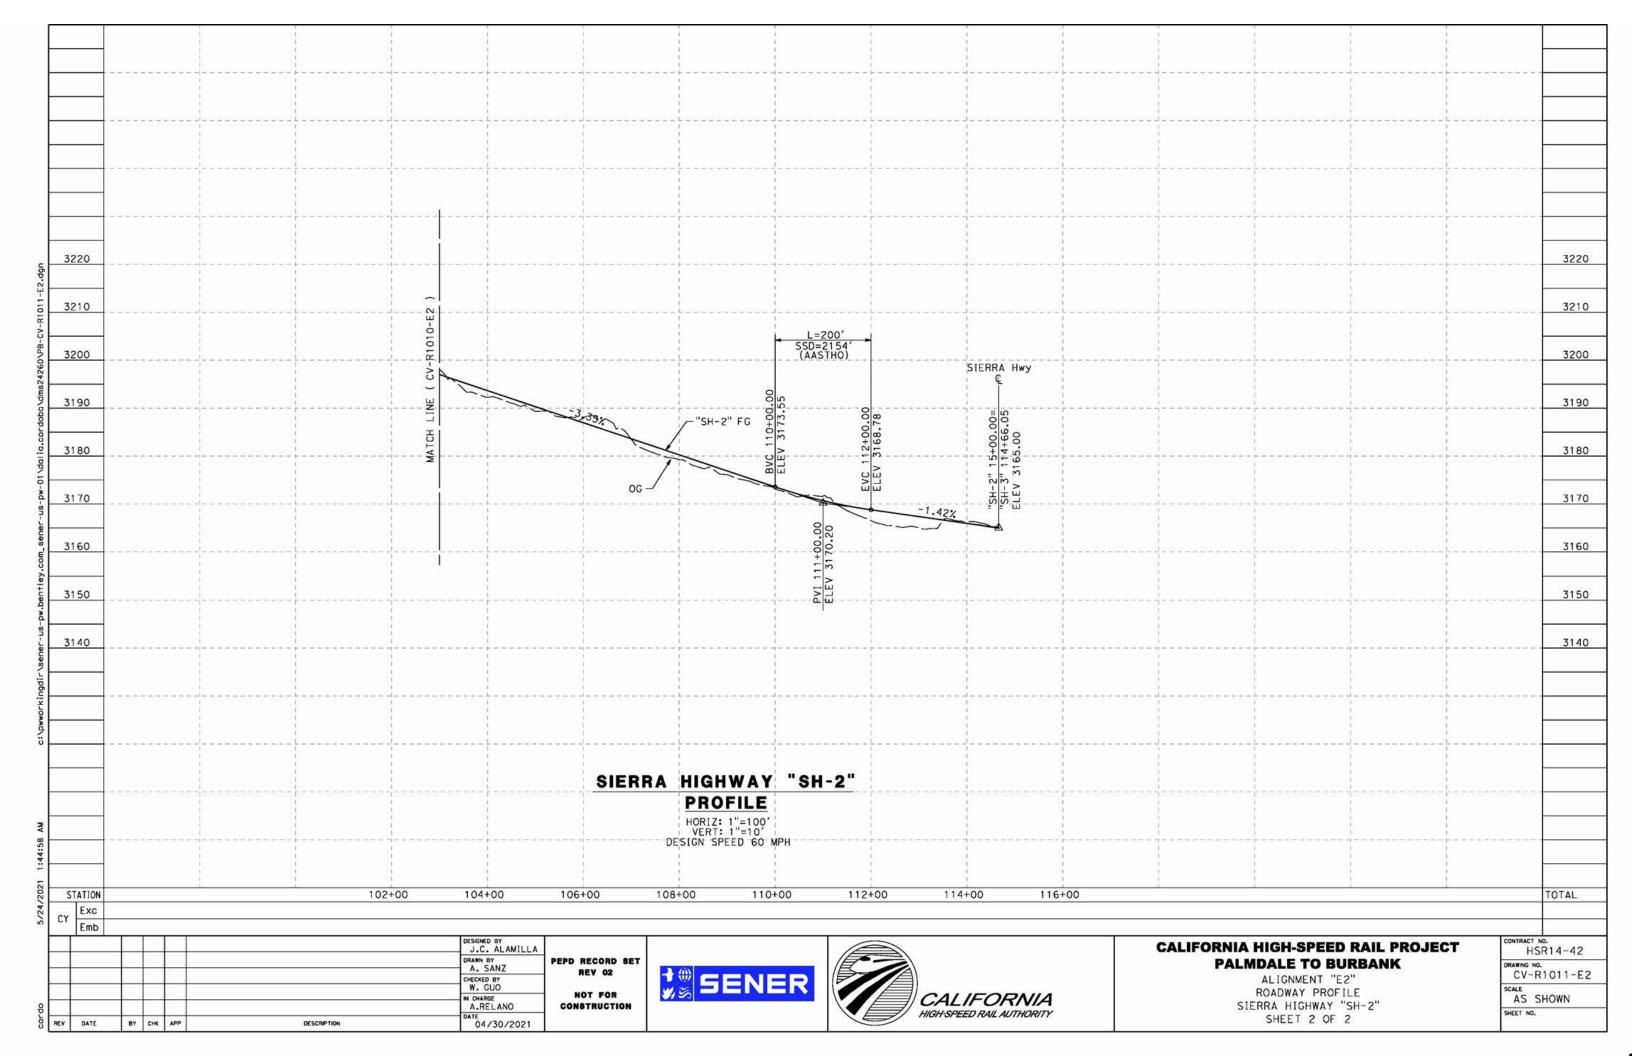


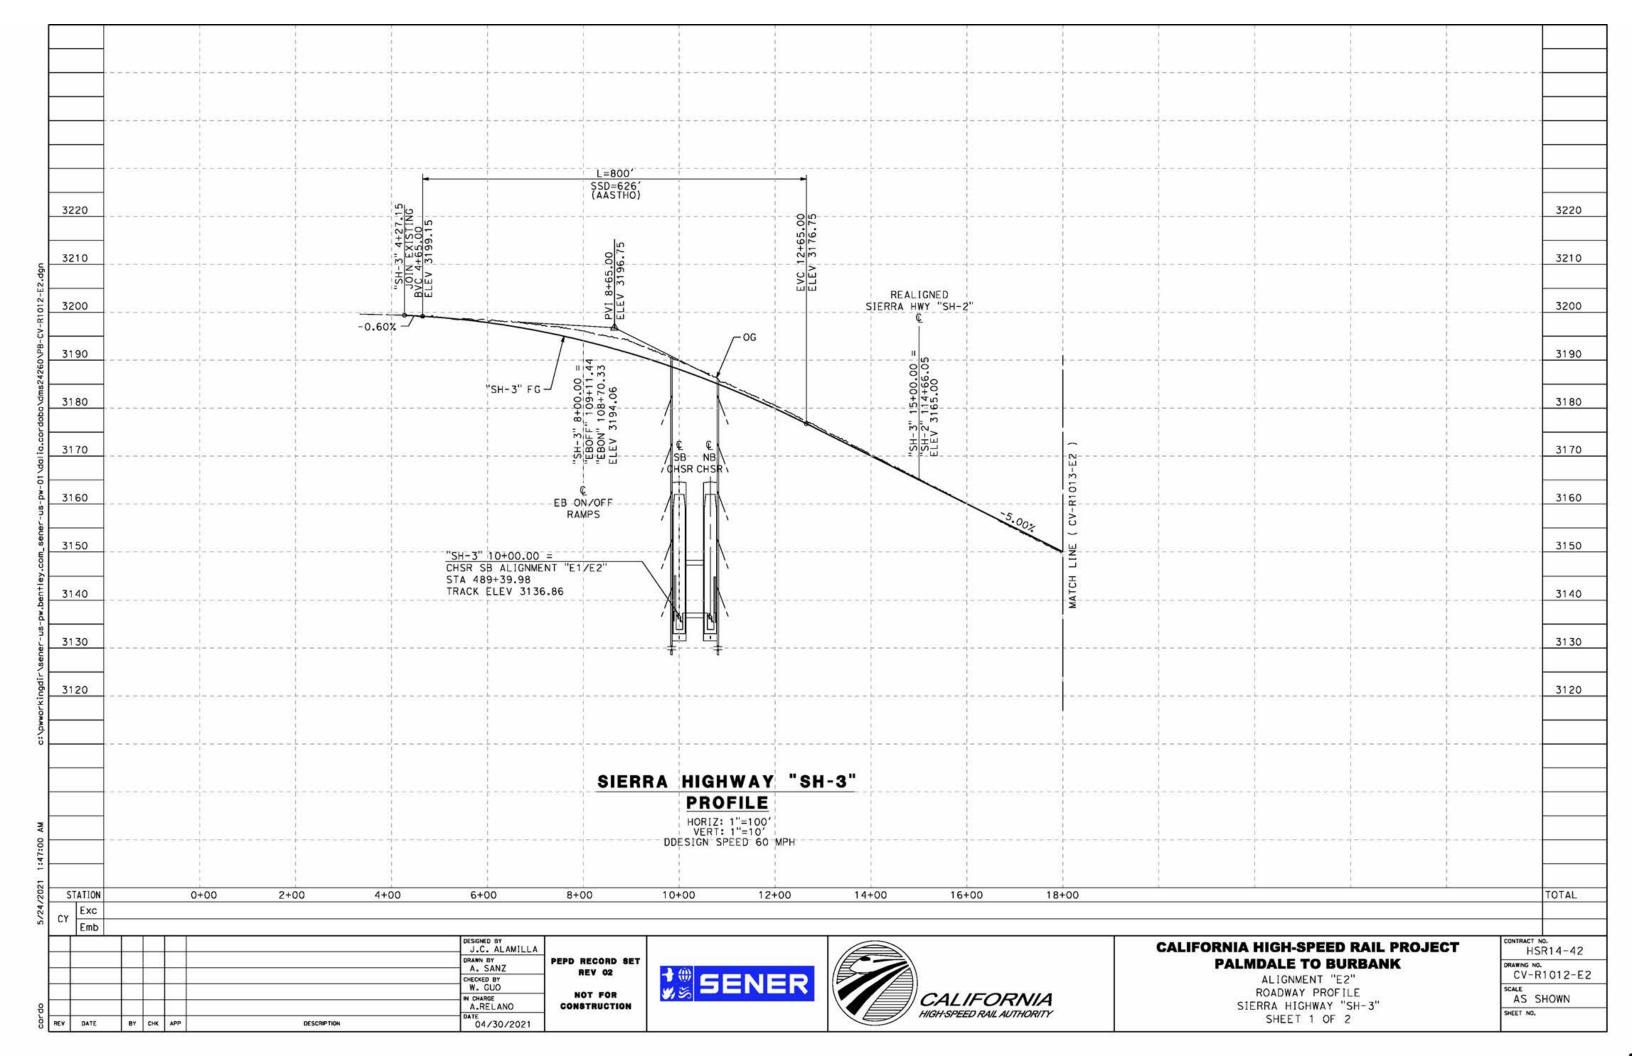


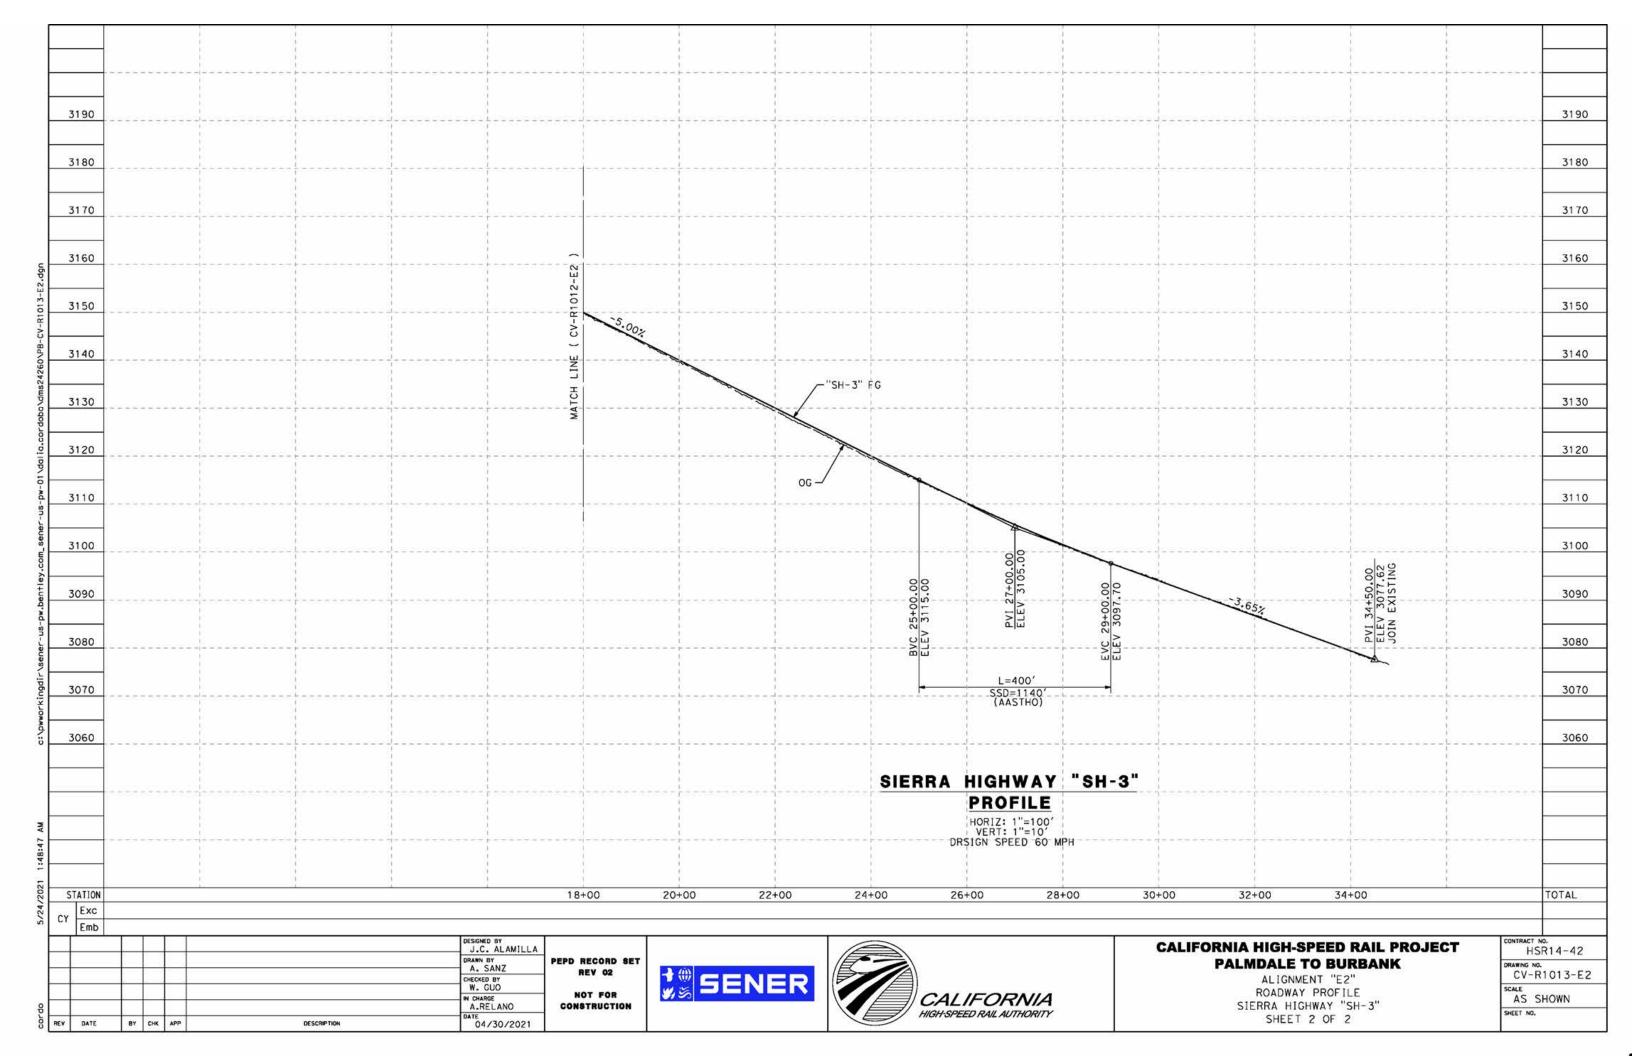


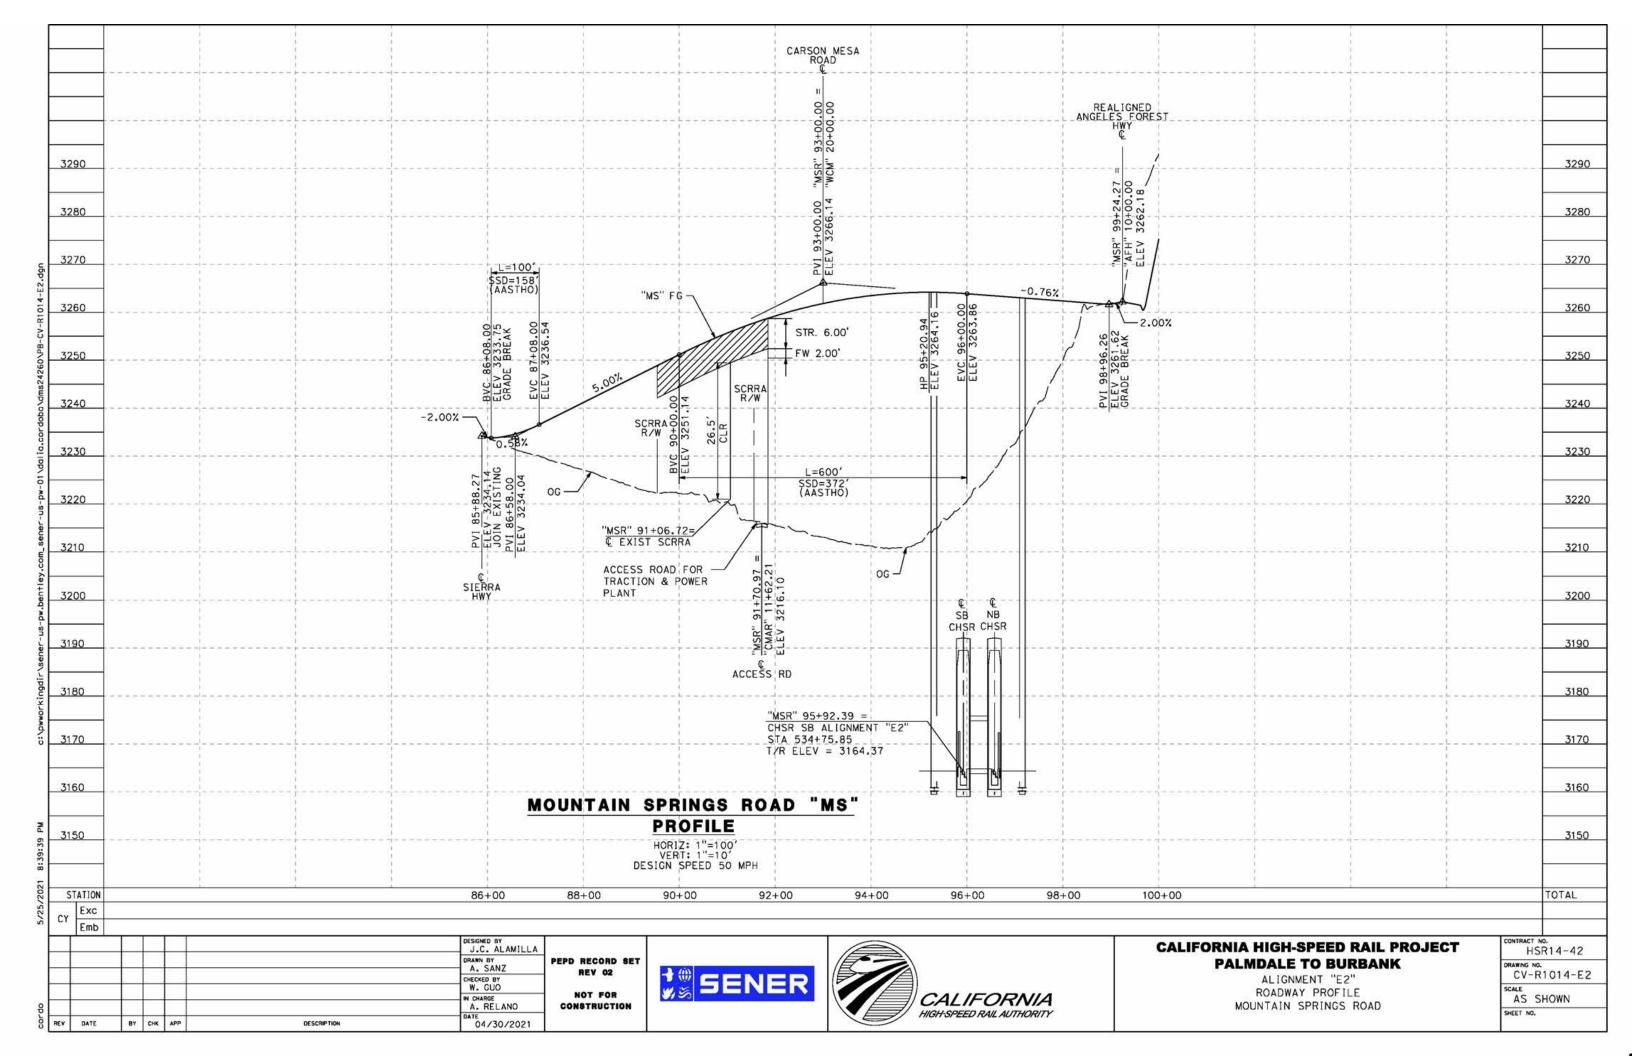


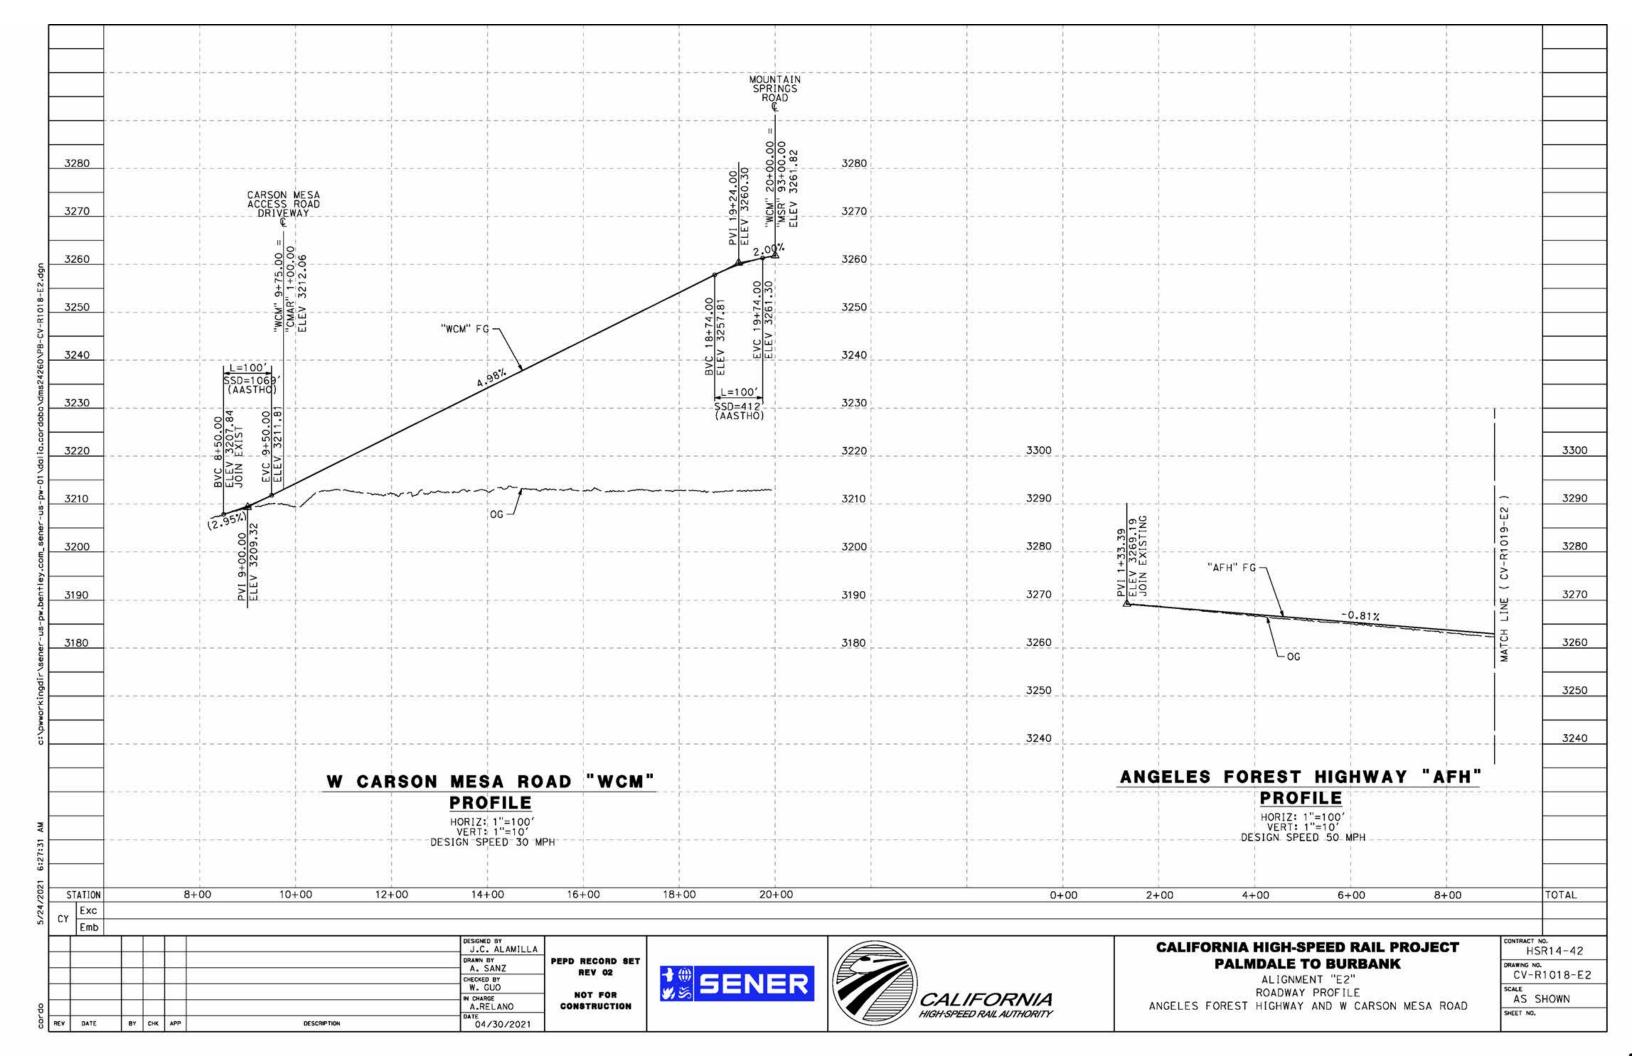


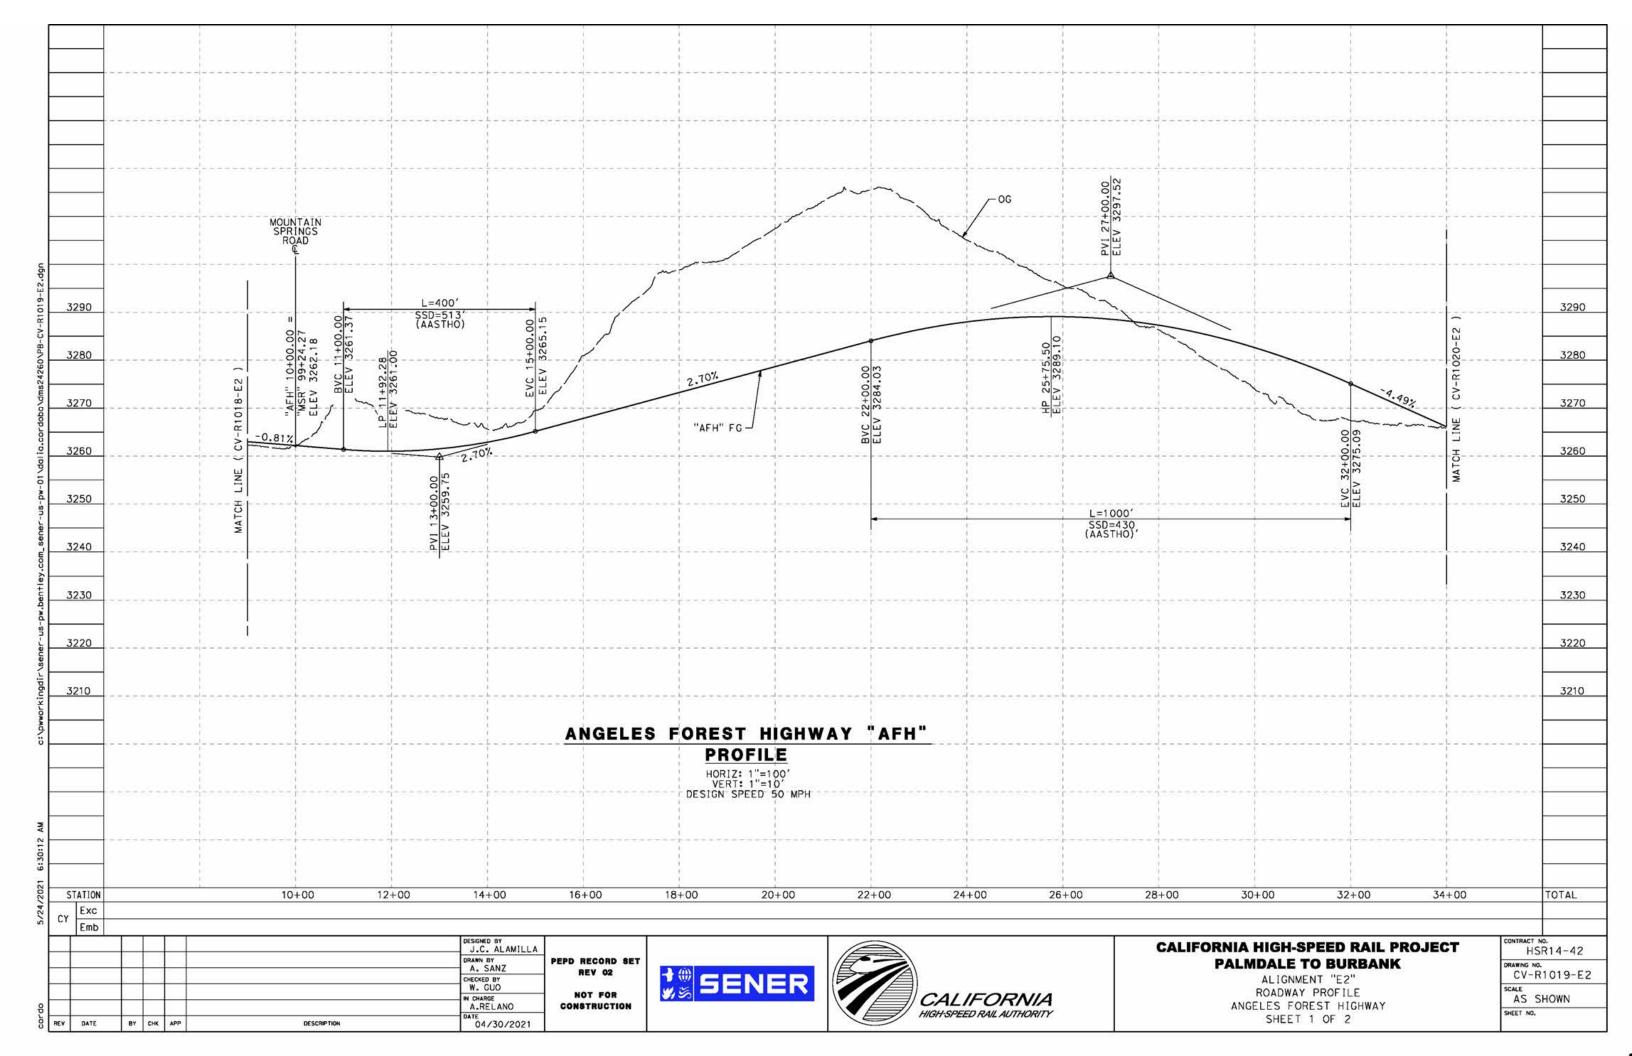


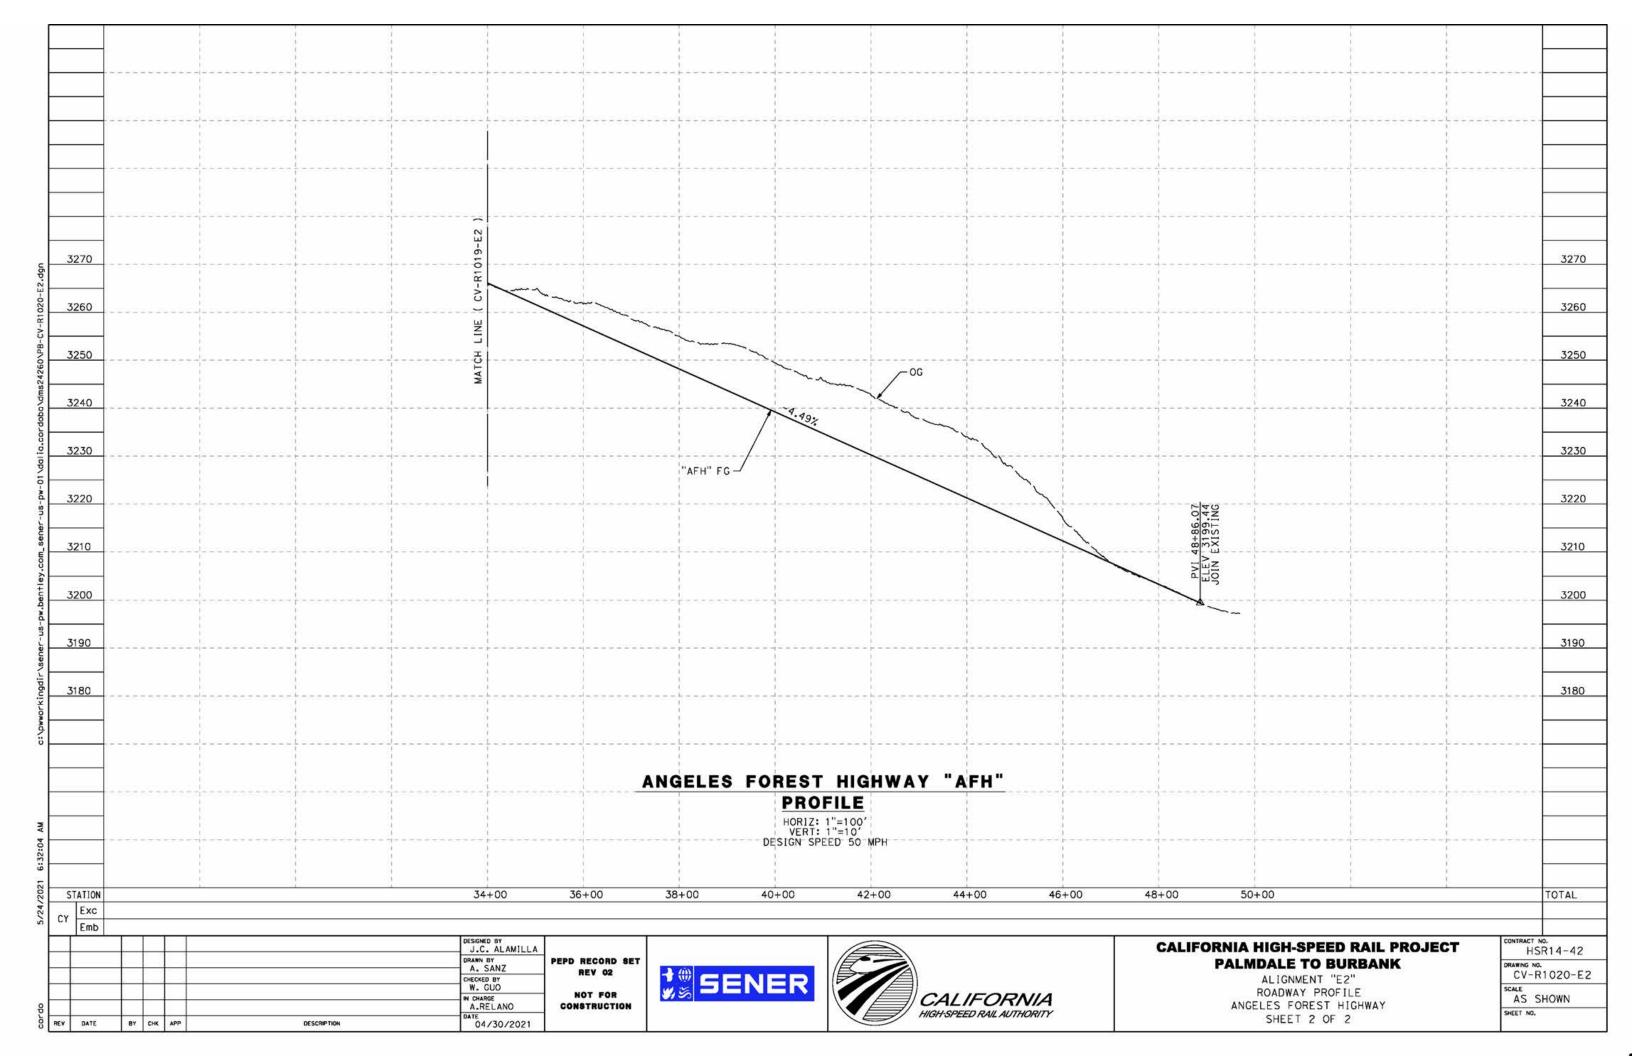


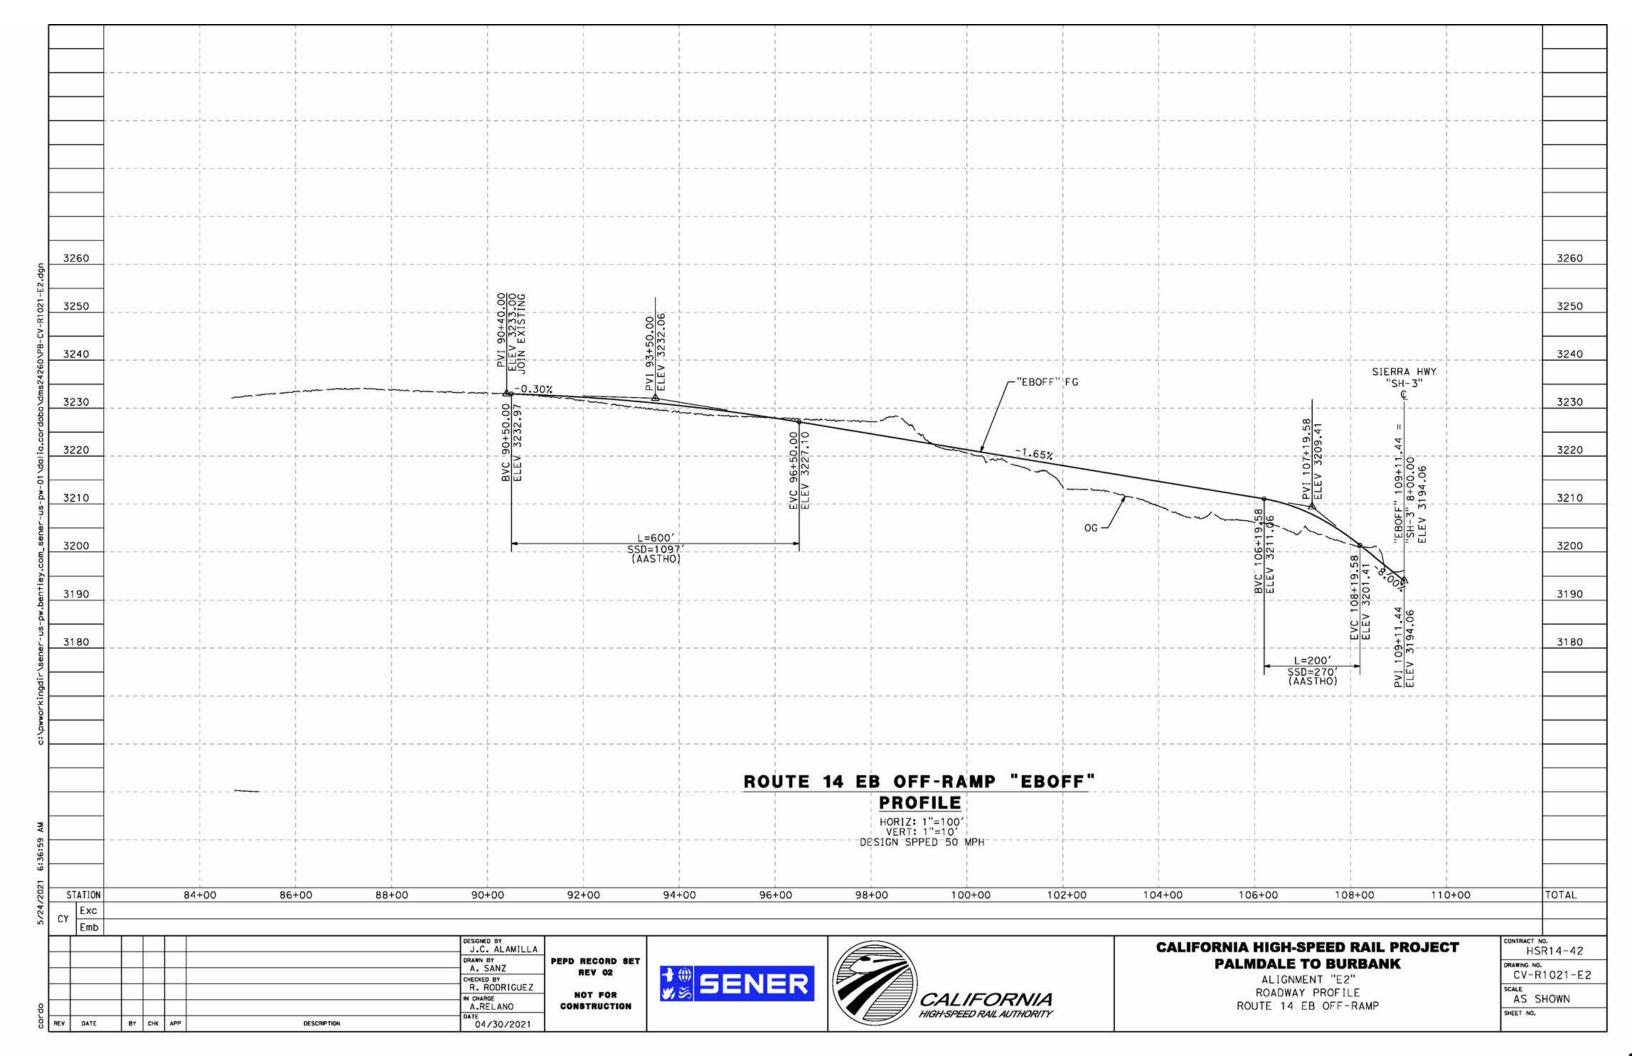


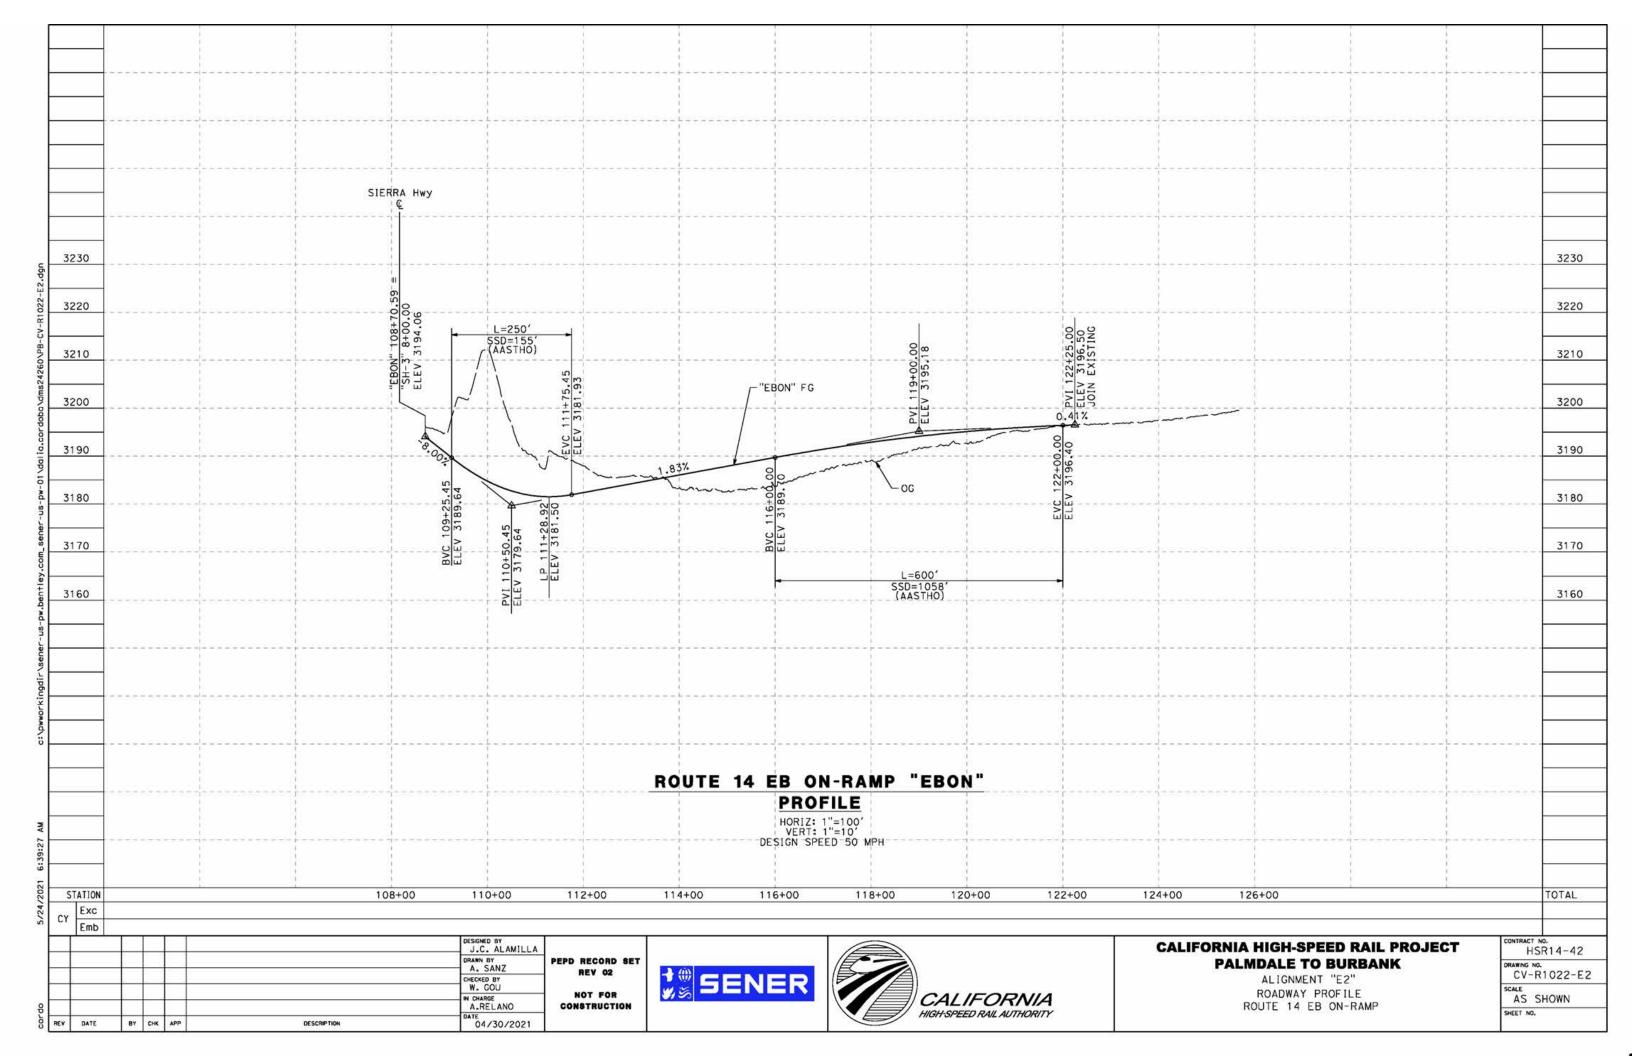


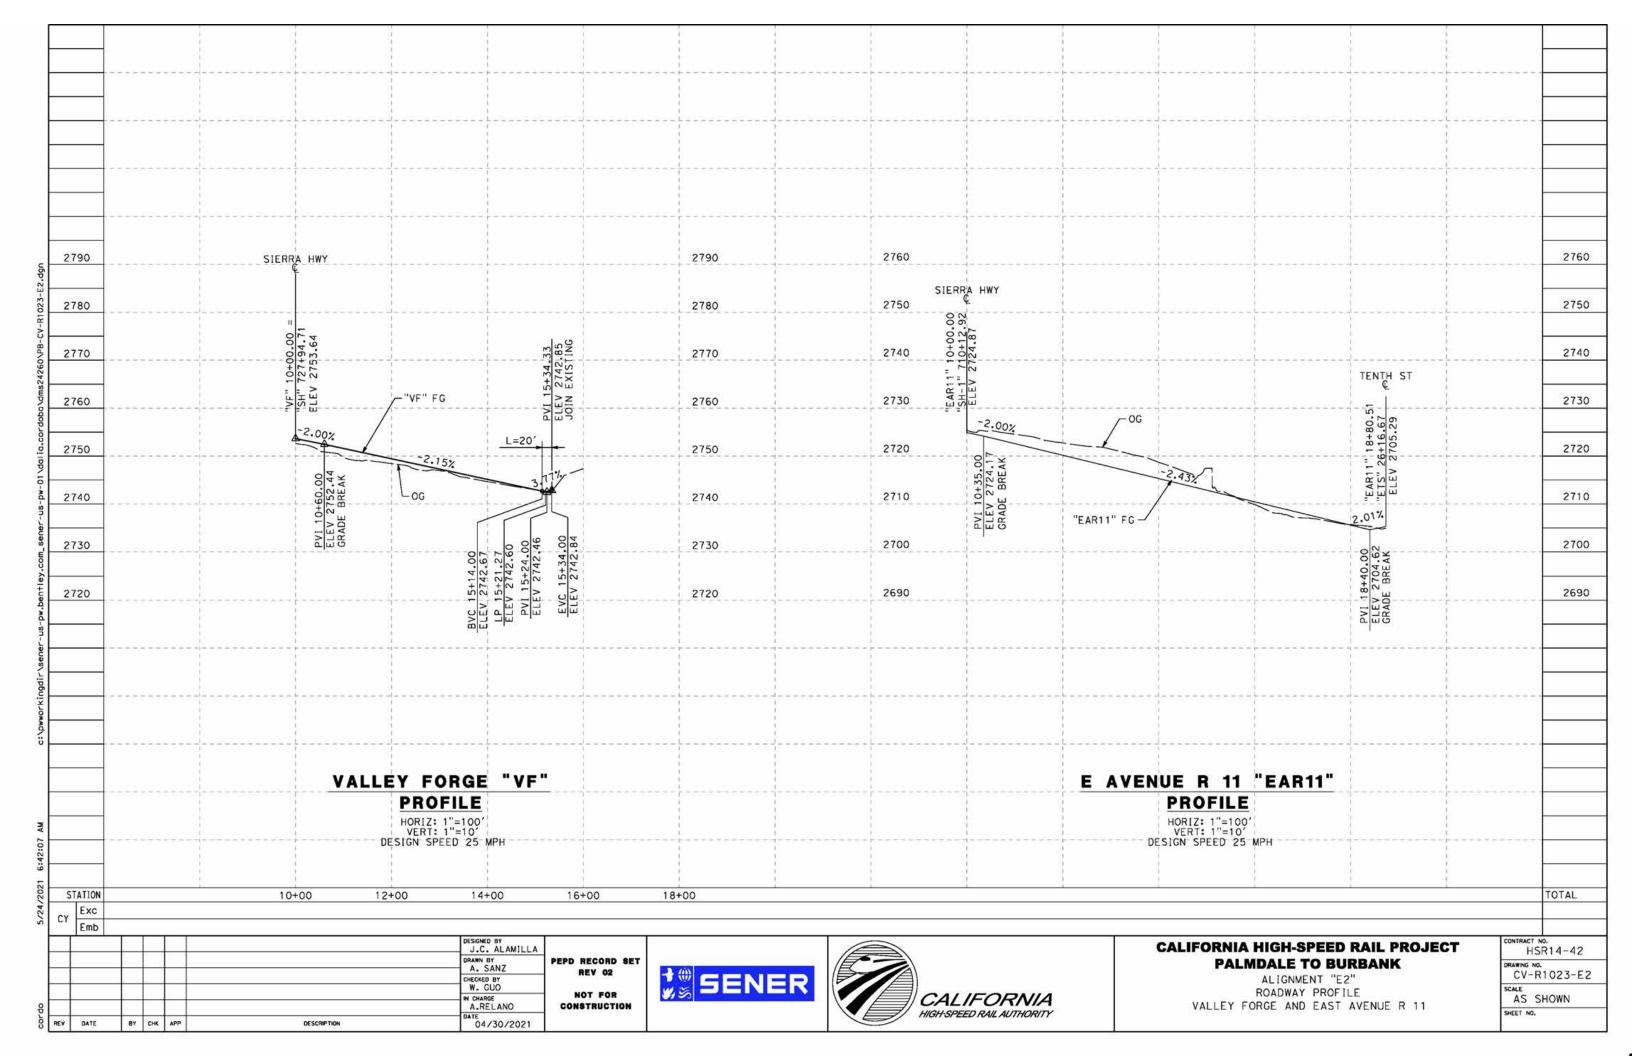


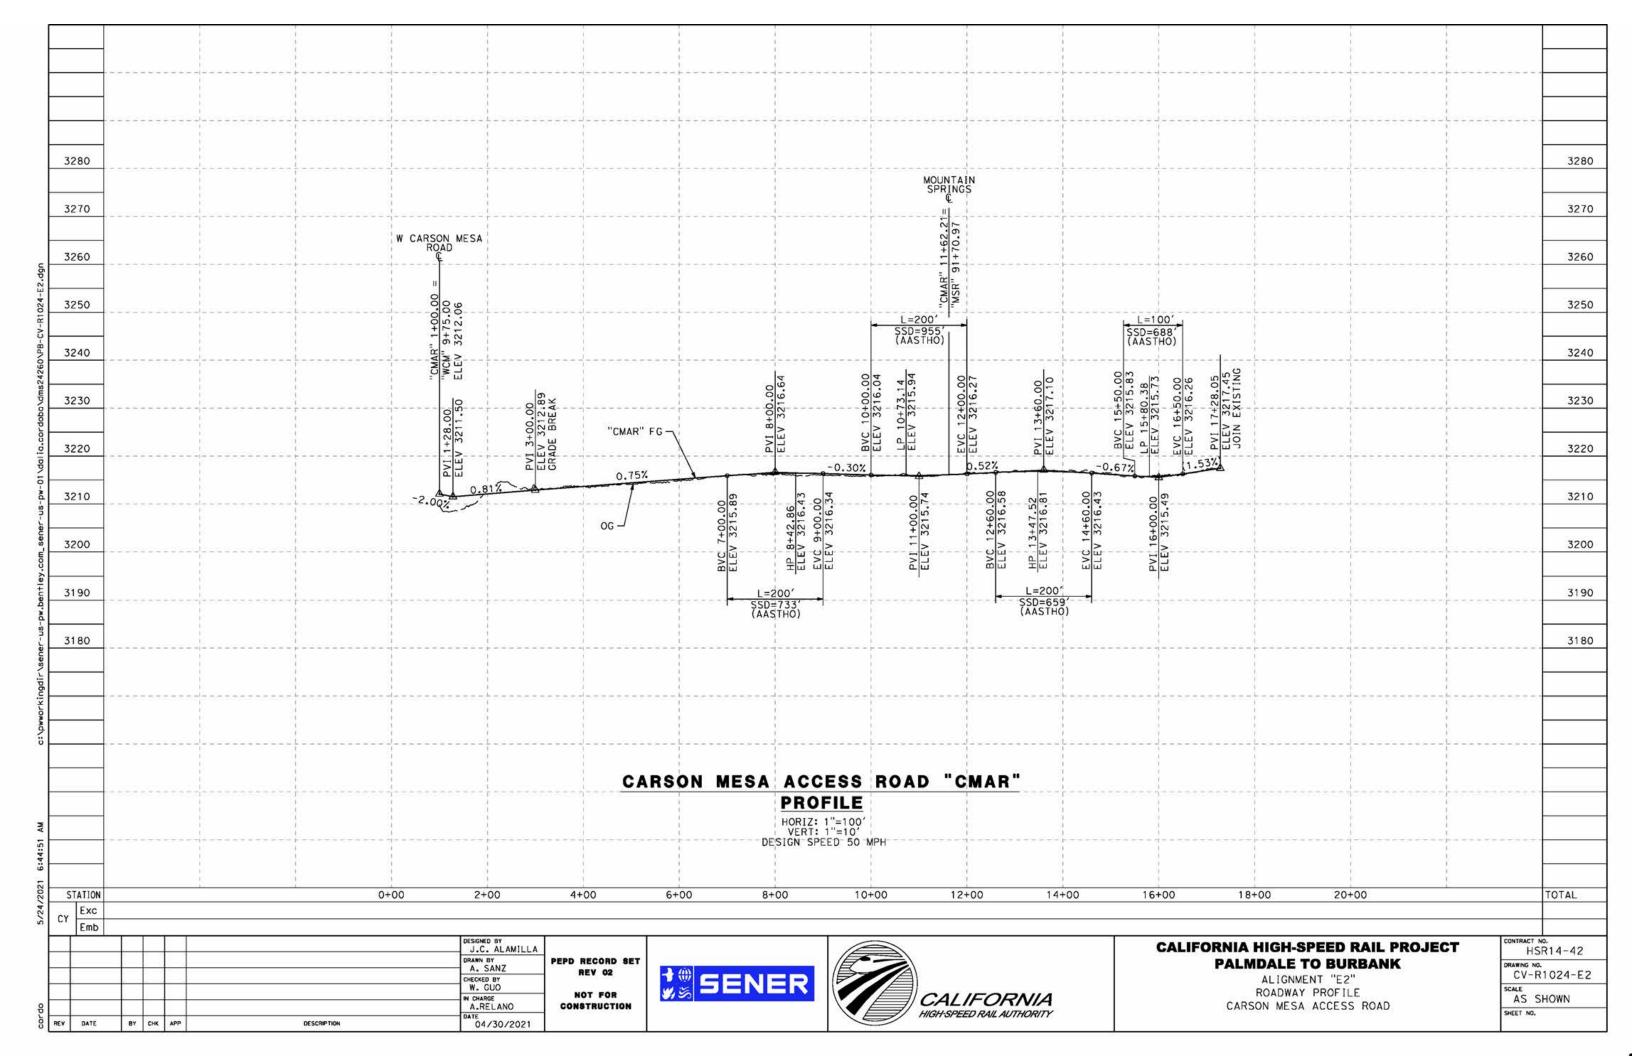

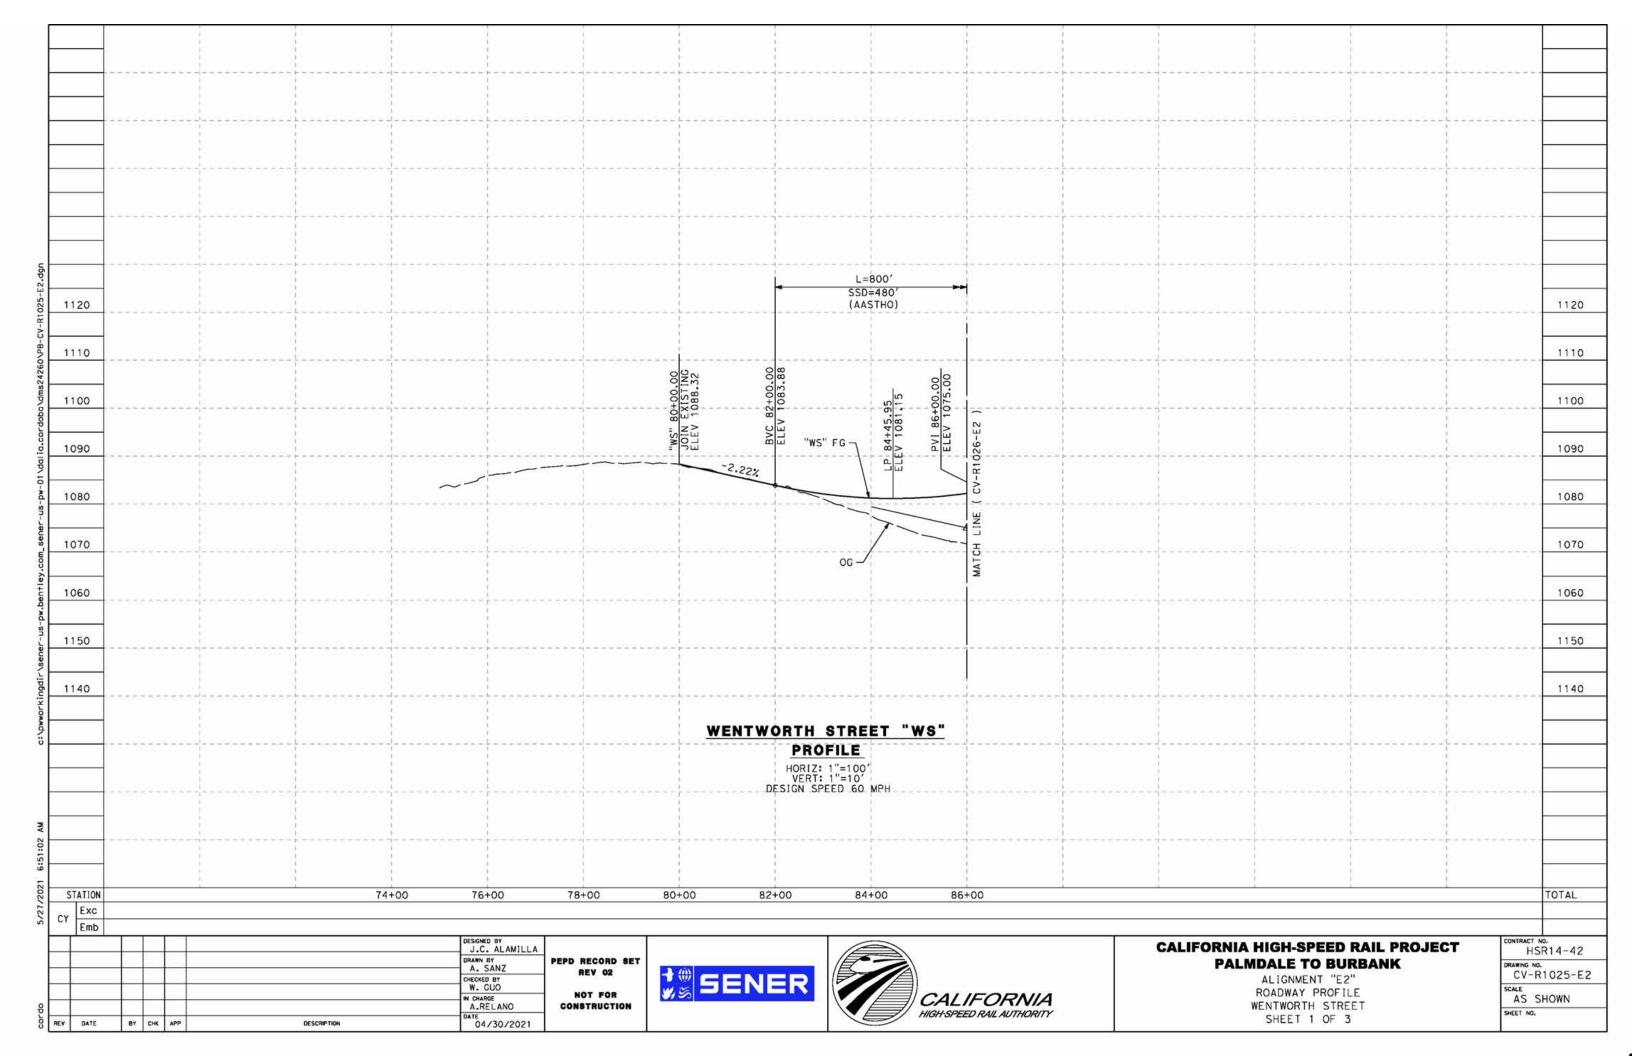

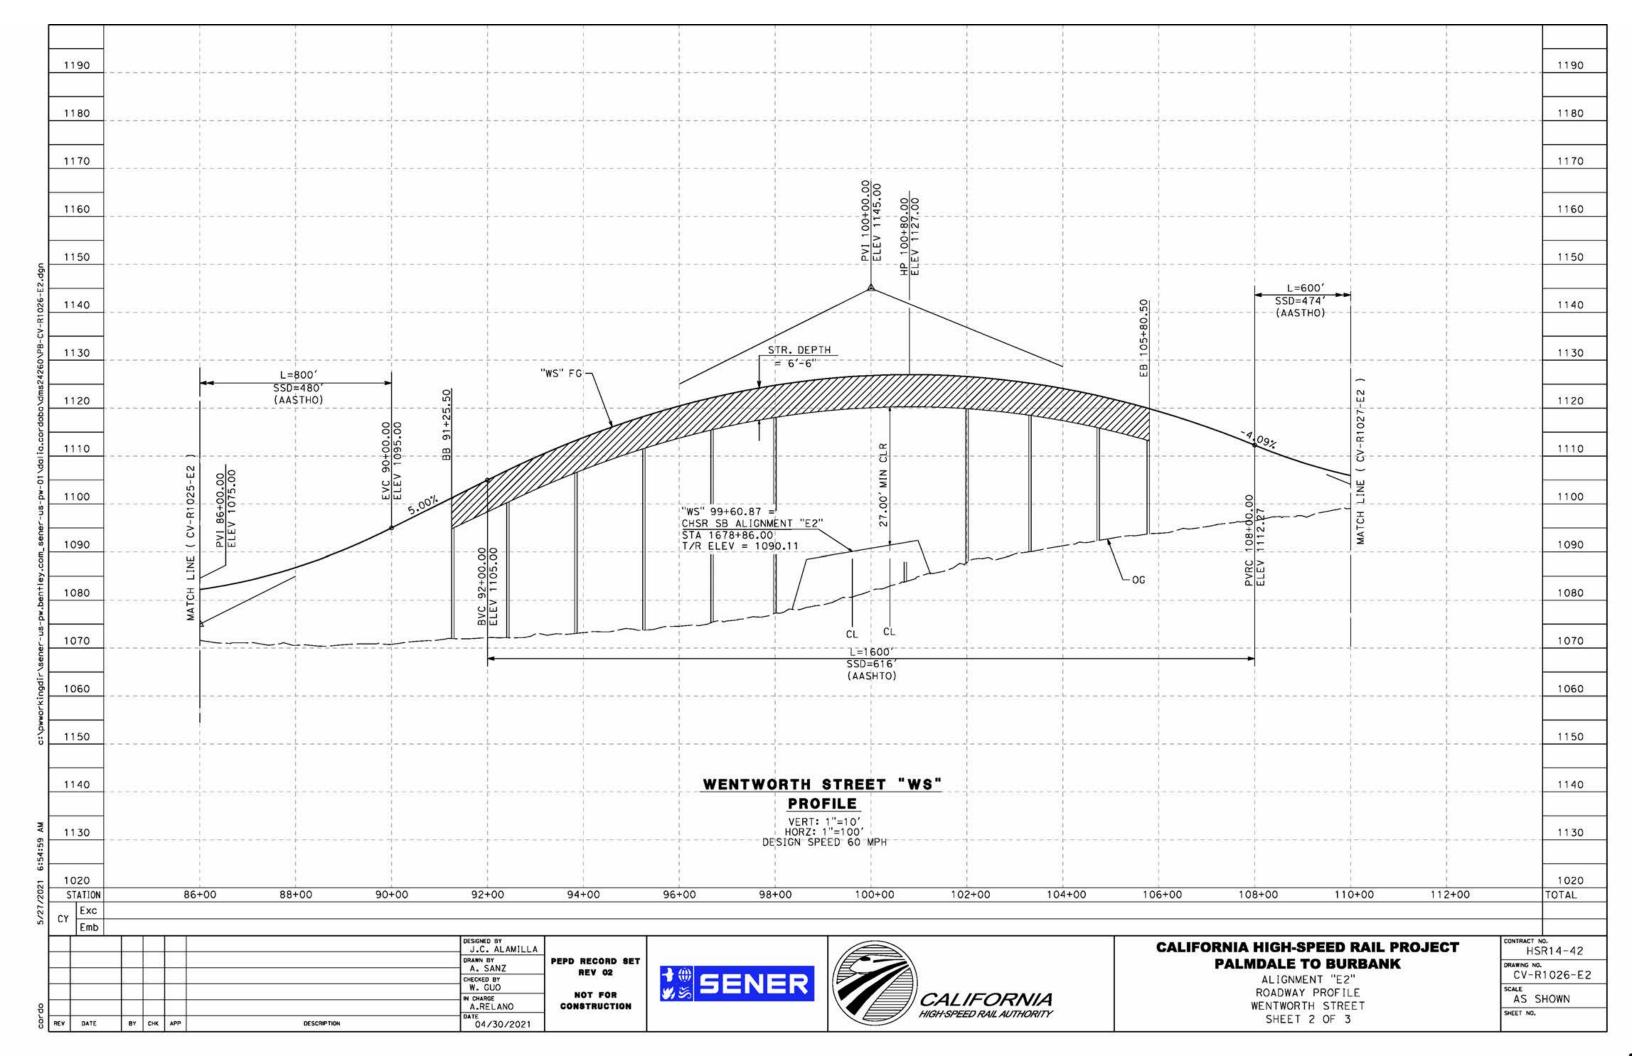

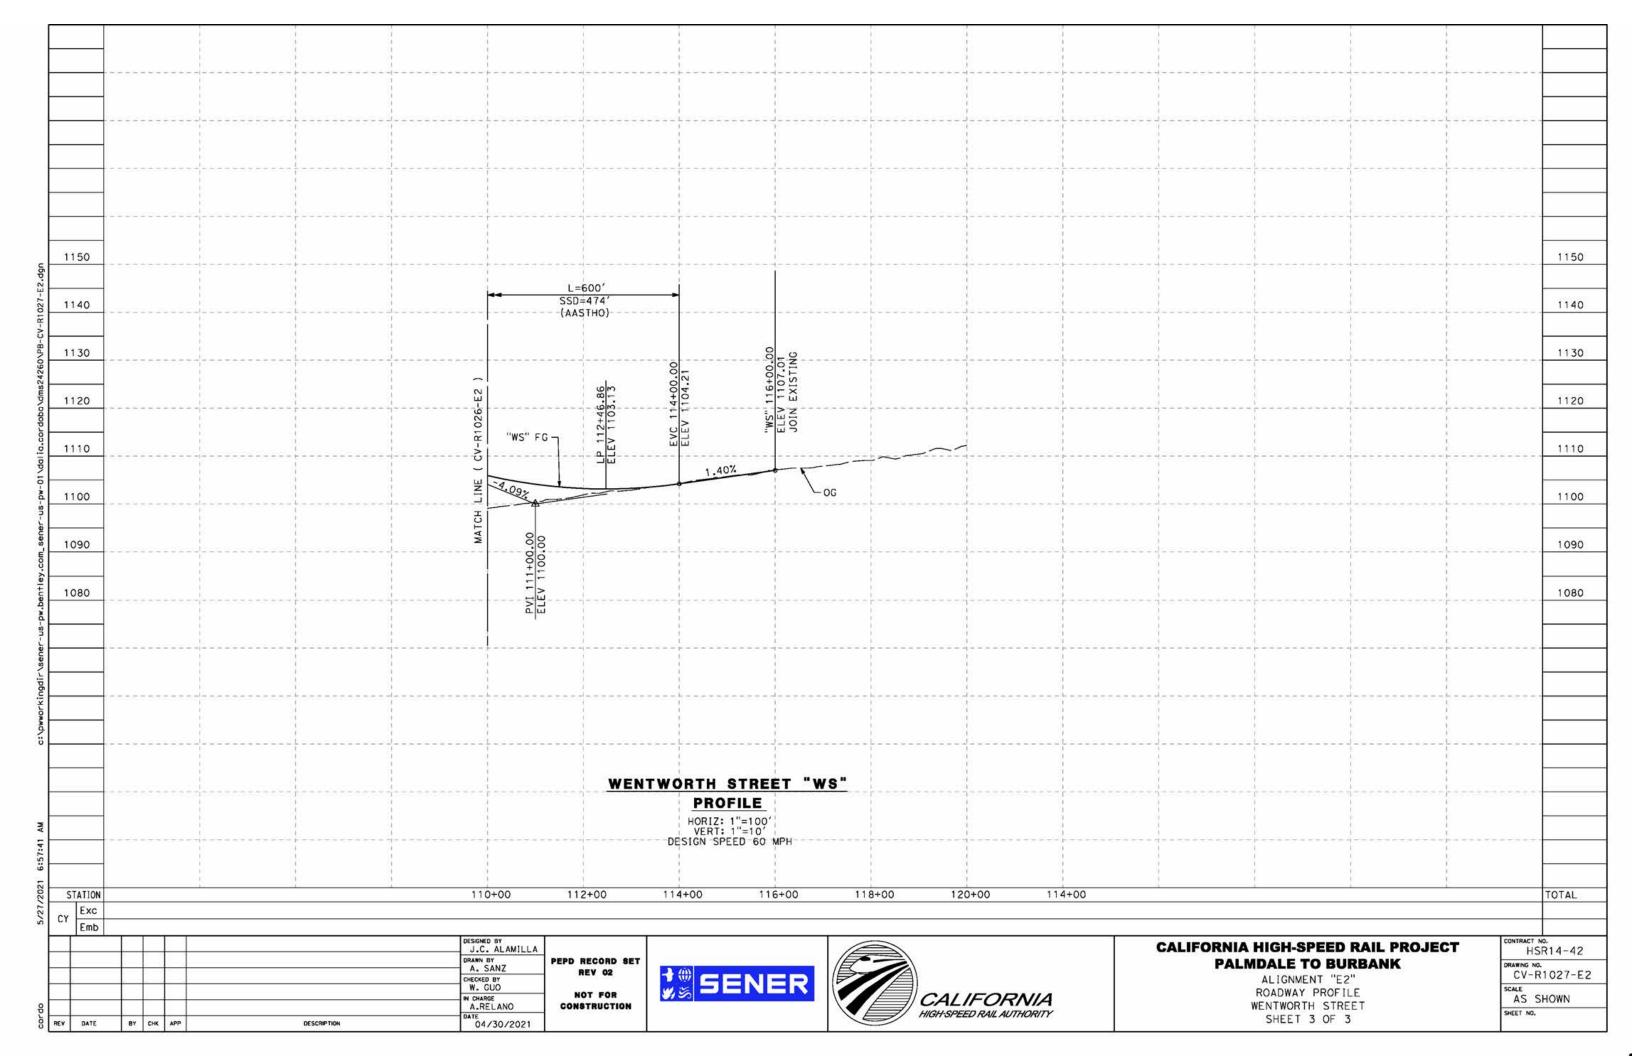

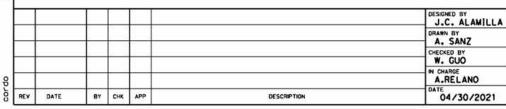

R/W

BENCH (TYP)

10%

-OG

PEPD RECORD SET REV 02 NOT FOR CONSTRUCTION

SENER



CALIFORNIA HIGH-SPEED RAIL PROJECT PALMDALE TO BURBANK

ALIGNMENT "E2" TYPICAL SECTIONS SIERRA HIGHWAY SHEET 1 OF 2 CONTRACT NO.
HSR14-42
DRAWING NO.
CV-R3001-E2
SCALE
NO SCALE

SHEET NO.

SIERRA HIGHWAY

NB LANE SB LANE


OR SUPER OR SUPER

VAR 31' TO 187.5'

10' DITCH R/W

30'

STA 728+50 TO 775+12 MAJOR ARTERIAL (B1) PER CITY OF PALMDALE GENERAL PLAN

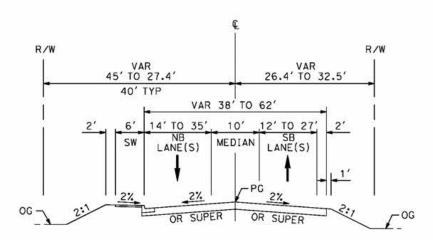

SIERRA HIGHWAY

STA 708+63 TO STA 728+50 MAJOR ARTERIAL (B1) PER CITY OF PALMDALE GENERAL PLAN

PEPD RECORD SET SENER NOT FOR CONSTRUCTION

REV 02




CALIFORNIA HIGH-SPEED RAIL PROJECT PALMDALE TO BURBANK

ALIGNMENT "E2" TYPICAL SECTIONS SIERRA HIGHWAY SHEET 2 OF 2


CV-R3002-E2 NO SCALE SHEET NO.

HSR14-42

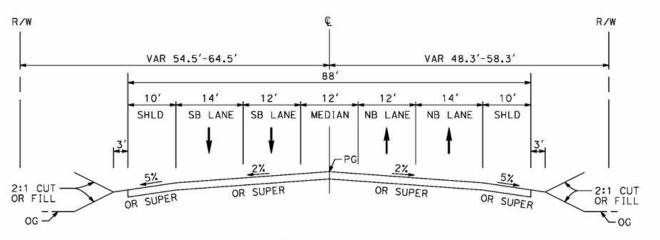


SIERRA HIGHWAY

STA 8+00 TO STA 34+50 MAJOR HIGHWAY
PER LOS ANGELES COUNTY MASTER PLAN OF HIGHWAYS

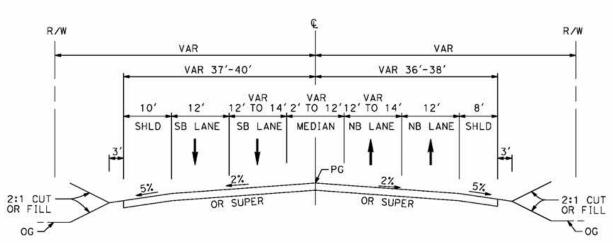


SIERRA HIGHWAY

STA 4+27 TO STA 8+00 MAJOR HIGHWAY
PER LOS ANGELES COUNTY MASTER PLAN OF HIGHWAYS

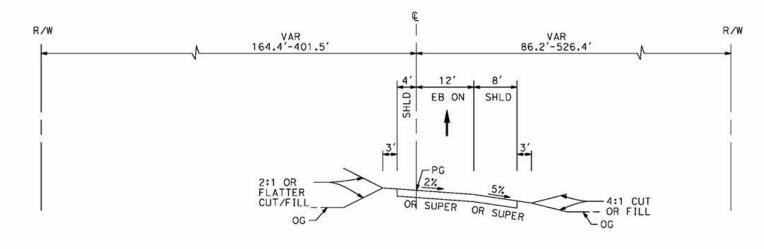

ROUTE 14 EB ON-RAMP

STA 109+30 TO STA 122+25

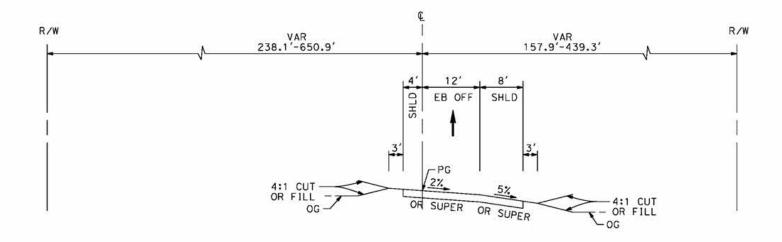

ROUTE 14 EB OFF-RAMP

STA 90+40 TO STA 108+68

t						DESIGNED BY J.C. ALAMILLA	Г
-	4		-			DRAWN BY A. SANZ	PE
+	-		-			CHECKED BY W. GUO	
8	\dashv		-	-		N CHARGE A.RELANO	١,
Sor	REV	DATE	BY	СНК	APP	DESCRIPTION DATE 04/30/2021	්

PEPD RECORD SET REV 02

NOT FOR CONSTRUCTION






CALIFORNIA HIGH-SPEED RAIL PROJECT PALMDALE TO BURBANK


ALIGNMENT "E2"
TYPICAL SECTIONS
ROUTE 14 EB ON-RAMP AND ROUTE 14 EB OFF-RAMP

CONTRACT NO.
HSR14-42
CV-R3003-E2
NO SCALE
SHEET NO.

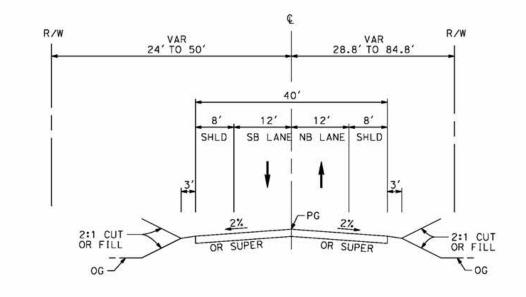

SIERRA HIGHWAY

STA 86+80 TO STA 114+66 MAJOR HIGHWAY
PER LOS ANGELES COUNTY
MASTER PLAN OF HIGHWAYS

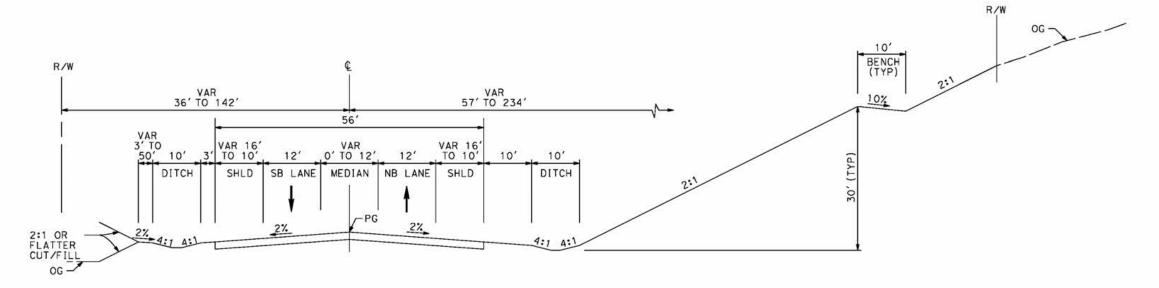

ANGELES FOREST HIGHWAY

STA 1+33 TO STA 48+86 MAJOR HIGHWAY PER LOS ANGELES COUNTY MASTER PLAN OF HIGHWAYS

2220								
							J.C. ALAMILLA	
							DRAWN BY A. SANZ	PE
				-			W. GUO	
e e	-	4	1	-			IN CHARGE A.RELANO	١,
COL	REV	DATE	BY	СНК	APP	DESCRIPTION	04/30/2021	ે ે

EPD RECORD SET SENER NOT FOR CONSTRUCTION

REV 02




CALIFORNIA HIGH-SPEED RAIL PROJECT PALMDALE TO BURBANK

ALIGNMENT "E2" TYPICAL SECTIONS SIERRA HIGHWAY AND ANGELES FOREST HIGHWAY


CONTRACT NO. HSR14-42
DRAWING NO. CV-R3004-E2
NO SCALE

SHEET NO.

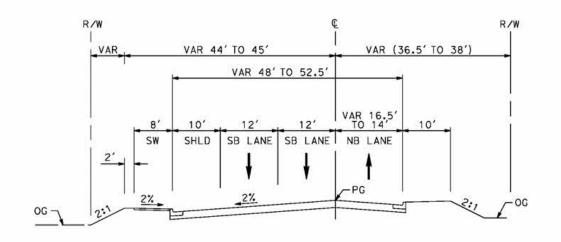


EAST TENTH STREET

STA 22+71 TO STA 32+38 SECONDARY ARTERIAL PER CITY OF PALMDALE GENERAL PLAN

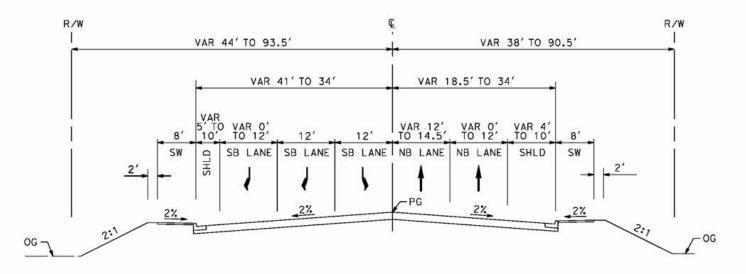

STA 10+49 TO STA 22+71 SECONDARY ARTERIAL PER CITY OF PALMDALE GENERAL PLAN

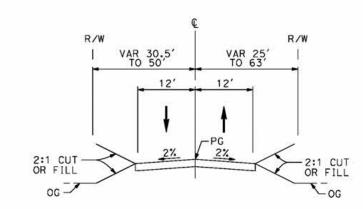

WATER TREATMENT PLANT ACCESS RD 2

STA 0+00 TO STA 8+00

EAST TENTH STREET

\vdash		+				J.C. ALAMILLA	
\vdash		+				A. SANZ	PE
H		+				W. GUO	
		+	1			IN CHARGE A.RELANO	١,
REV	DATE	BY	СНК	APP	DESCRIPTION	04/30/2021	ਂ

PEPD RECORD SET REV 02 NOT FOR CONSTRUCTION






CALIFORNIA HIGH-SPEED RAIL PROJECT PALMDALE TO BURBANK

ALIGNMENT "E2" TYPICAL SECTIONS EAST TENTH STREET AND WATER TREATMENT PLANT ACCESS RD 2

DRAWING NO. CV-R3005-E2 SCALE NO SCALE	HSR14-42					
SCALE NO SCALE	DRAWING CV-	_{No.} -R3005-E2				
III GOULL	SCALE NO	SCALE				

W CARSON MESA ROAD

STA 8+50 TO STA 20+00 LOCAL ROADWAY
PER LOS ANGELES COUNTY MUNICIPAL CODE CHAPTER 21 PARTS 2 AND 3

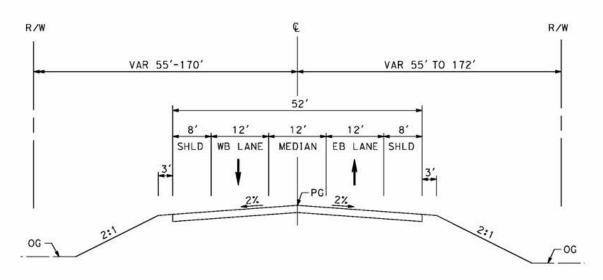

W MOUNTAIN SPRINGS ROAD

STA 85+88 TO STA 98+94 COLLECTOR STREET PER LOS ANGELES COUNTY MUNICIPAL CODE CHAPTER 21 PARTS 2 AND 3

İ							DESIGNED BY J.C. ALAMILLA	
-			-				DRAWN BY A. SANZ	PEPD RECORD SET
ŀ	\dashv		+				CHECKED BY W. GUO	REV 02
g	\dashv		1				IN CHARGE A.RELANO	NOT FOR CONSTRUCTION
92	REV	DATE	BY	СНК	APP	DESCRIPTION	04/30/2021	CONSTRUCTION

EPD RECORD SET SENER



CALIFORNIA HIGH-SPEED RAIL PROJECT PALMDALE TO BURBANK

ALIGNMENT "E2" TYPICAL SECTIONS MOUNTAIN SPRINGS ROAD AND W CARSON MESA ROAD

CONTRAC	T NO. SR14-42
Н	SR14-42
DRAWING	NO.
CV-	-R3006-E2
SCALE	00 text(81,00%) 17%)
	SCALE





SENER





ALIGNMENT "E2"
TYPICAL SECTIONS
WENTWORTH STREET
SHEET 1 OF 2

DRAWING	NO.
CV-	-R3007-E2
SCALE	10161211 SIJI.
	SCALE

CONTRACT NO.

R/W PROPOSED WENTWORTH ST EXIST R/W EXIST R/W VARIES (40') TO (56') TUJUNGA WASH 12' 12' VARIES SW BL WB LANE WB LANE MEDIAN EB LANE EB LANE BL SW 2% 2% & VAR. EXISTING WENTWORTH ST EXISTING TUJUNGA — WASH WALL 2% OR SUPER 2% OR —SUPER (62′) [EXISTING CONCRETE SLOPE - PROTECT IN PLACE EXISTING EQUESTRIAN TRAIL RETAINING WALL -

WENTWORTH STREET

STA 80+00.00 TO STA 91+25.50 AVENUE II (SECONDARY HIGHWAY) PER CITY OF LOS ANGELES GENERAL PLAN 2035

WENTWORTH STREET

STA 105+80.50 TO STA 116+00.00 AVENUE II (SECONDARY HIGHWAY) PER CITY OF LOS ANGELES GENERAL PLAN 2035

						J.C. ALAMILLA	
-		4				A. SANZ	PI
\dashv		+	-			W. GUO	
\dashv		1				IN CHARGE A.RELANO	
REV	DATE	BY	СНК	APP	DESCRIPTION	DATE 04/30/2021	1

PEPD RECORD SET CONSTRUCTION

REV 02

NOT FOR







CALIFORNIA HIGH-SPEED RAIL PROJECT PALMDALE TO BURBANK


ALIGNMENT "E2" TYPICAL SECTIONS WENTWORTH STREET SHEET 2 OF 2


Н	SR14-42
DRAWING CV-	[№] . -R3008-E2
SCALE NO	SCALE

SHEET NO.

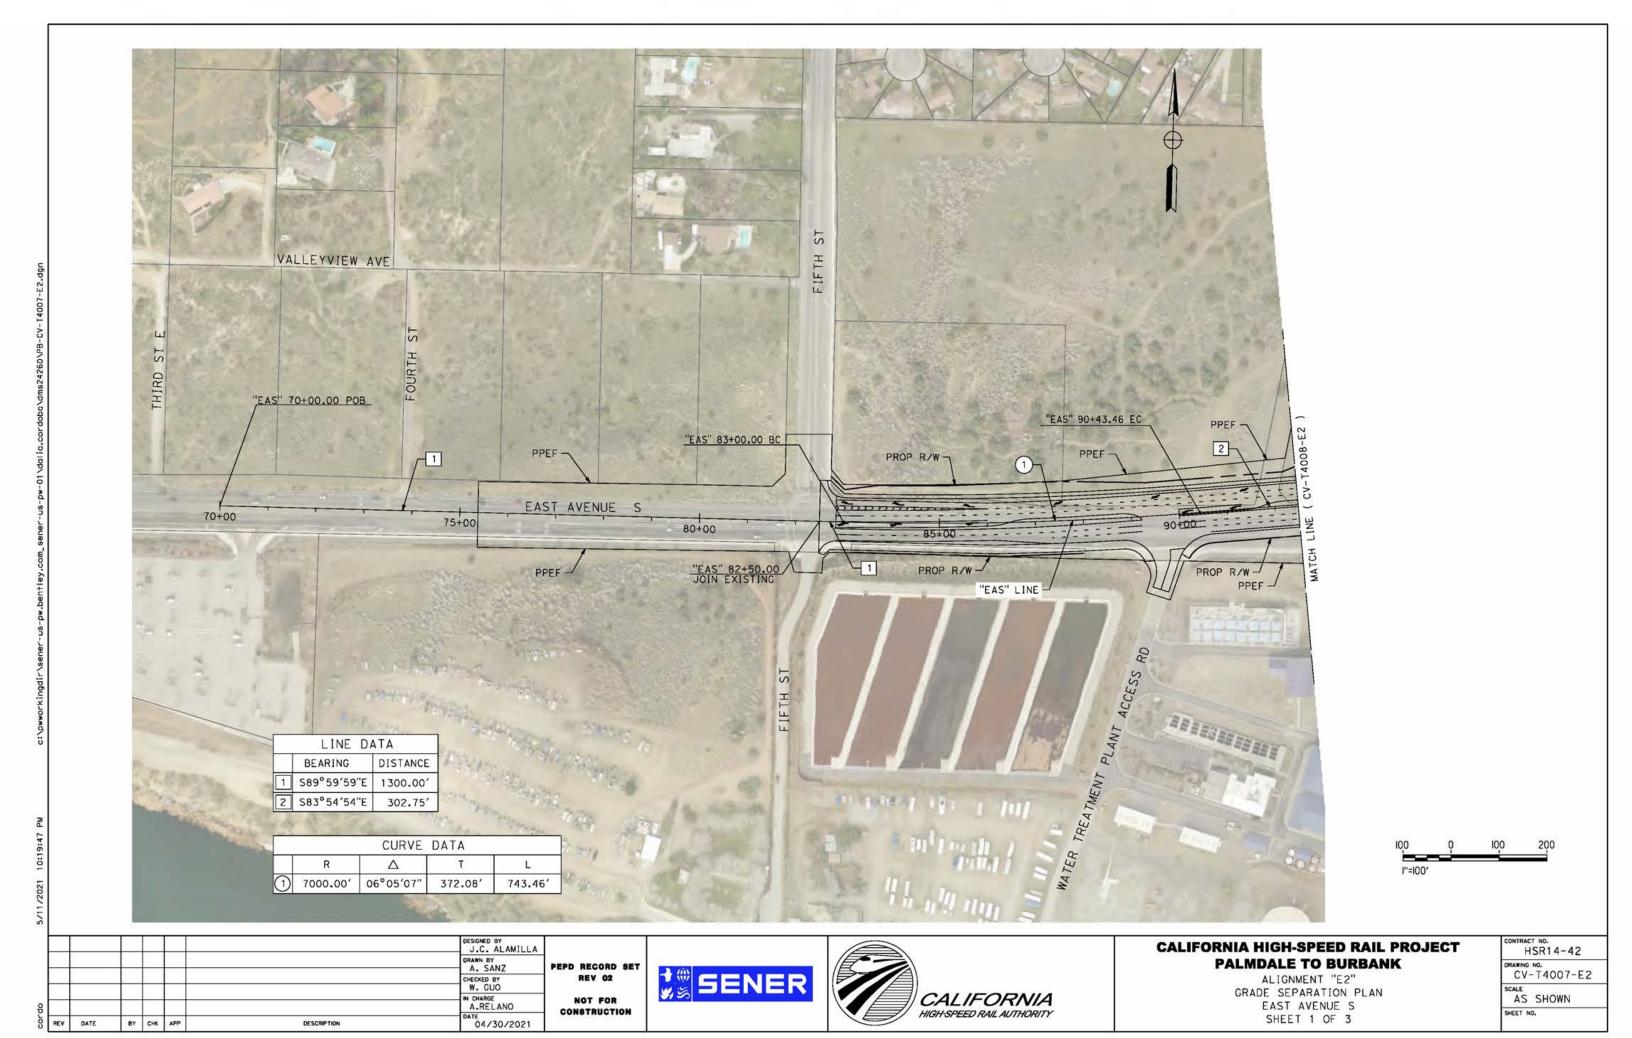

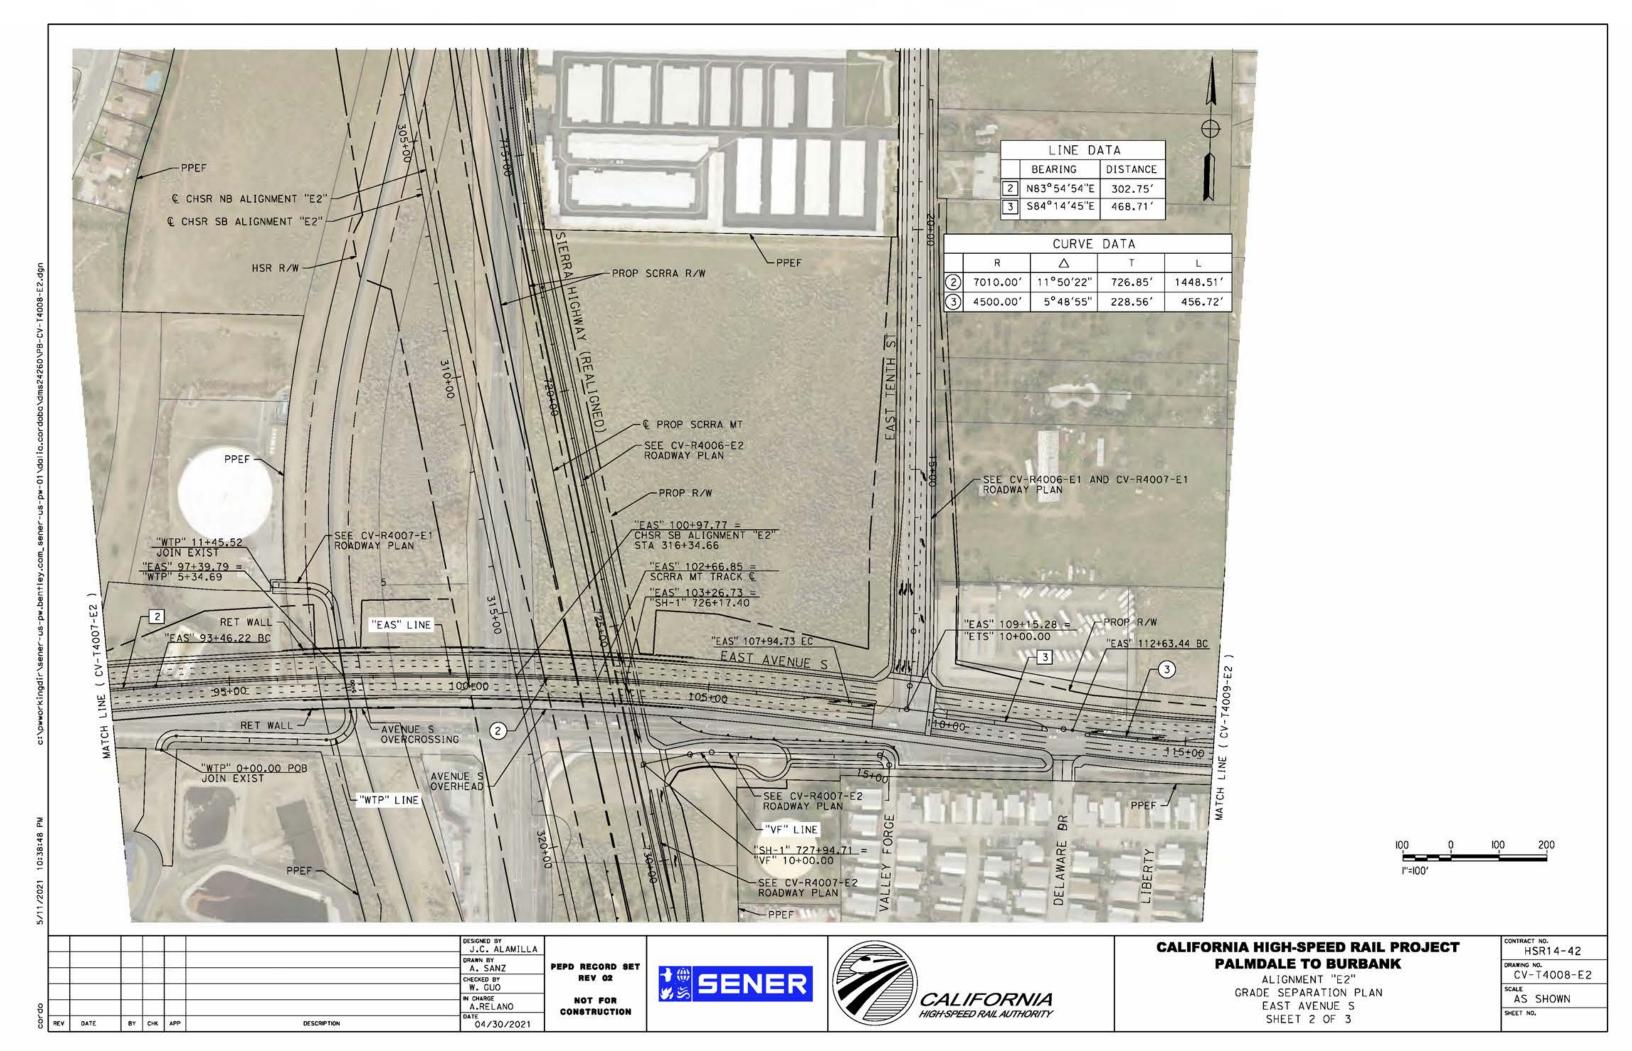

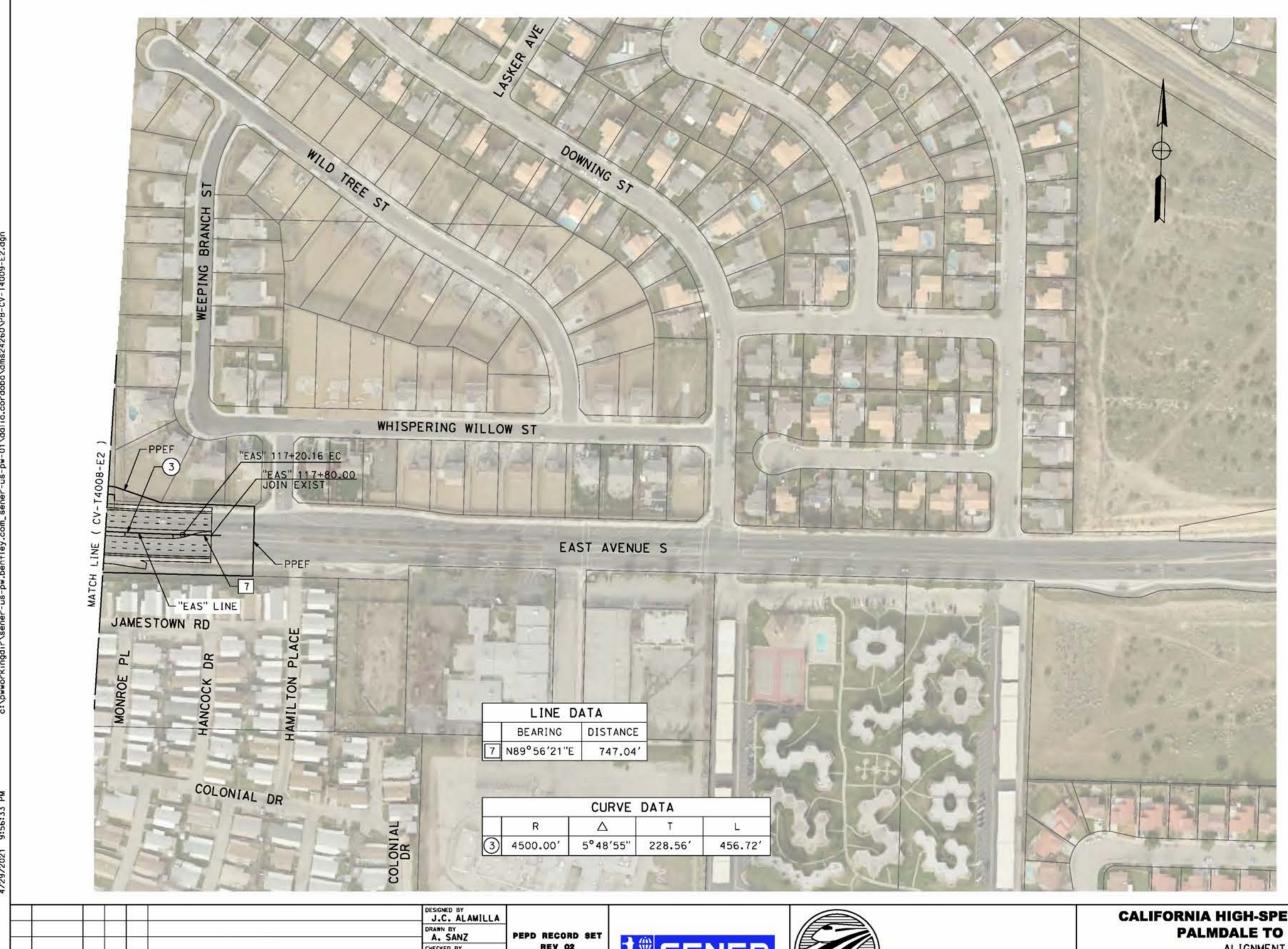

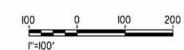

						J.C. ALAMILLA
		-				A. SANZ
						W. GUO
-	-	1				IN CHARGE A.RELANO
REV	DATE	84	СНК	APP	DESCRIPTION	DATE 04/30/2021

REV 02 NOT FOR

CONSTRUCTION







CALIFORNIA HIGH-SPEED RAIL PROJECT PALMDALE TO BURBANK

ALIGNMENT "E2"
GRADE SEPARATION PLAN EAST AVENUE S SHEET 3 OF 3

I	CONTRACT NO. HSR14-42 DRAWING NO. CV-T4009-E2					
Ì	AS SHOWN					
ı	SHEET NO.					

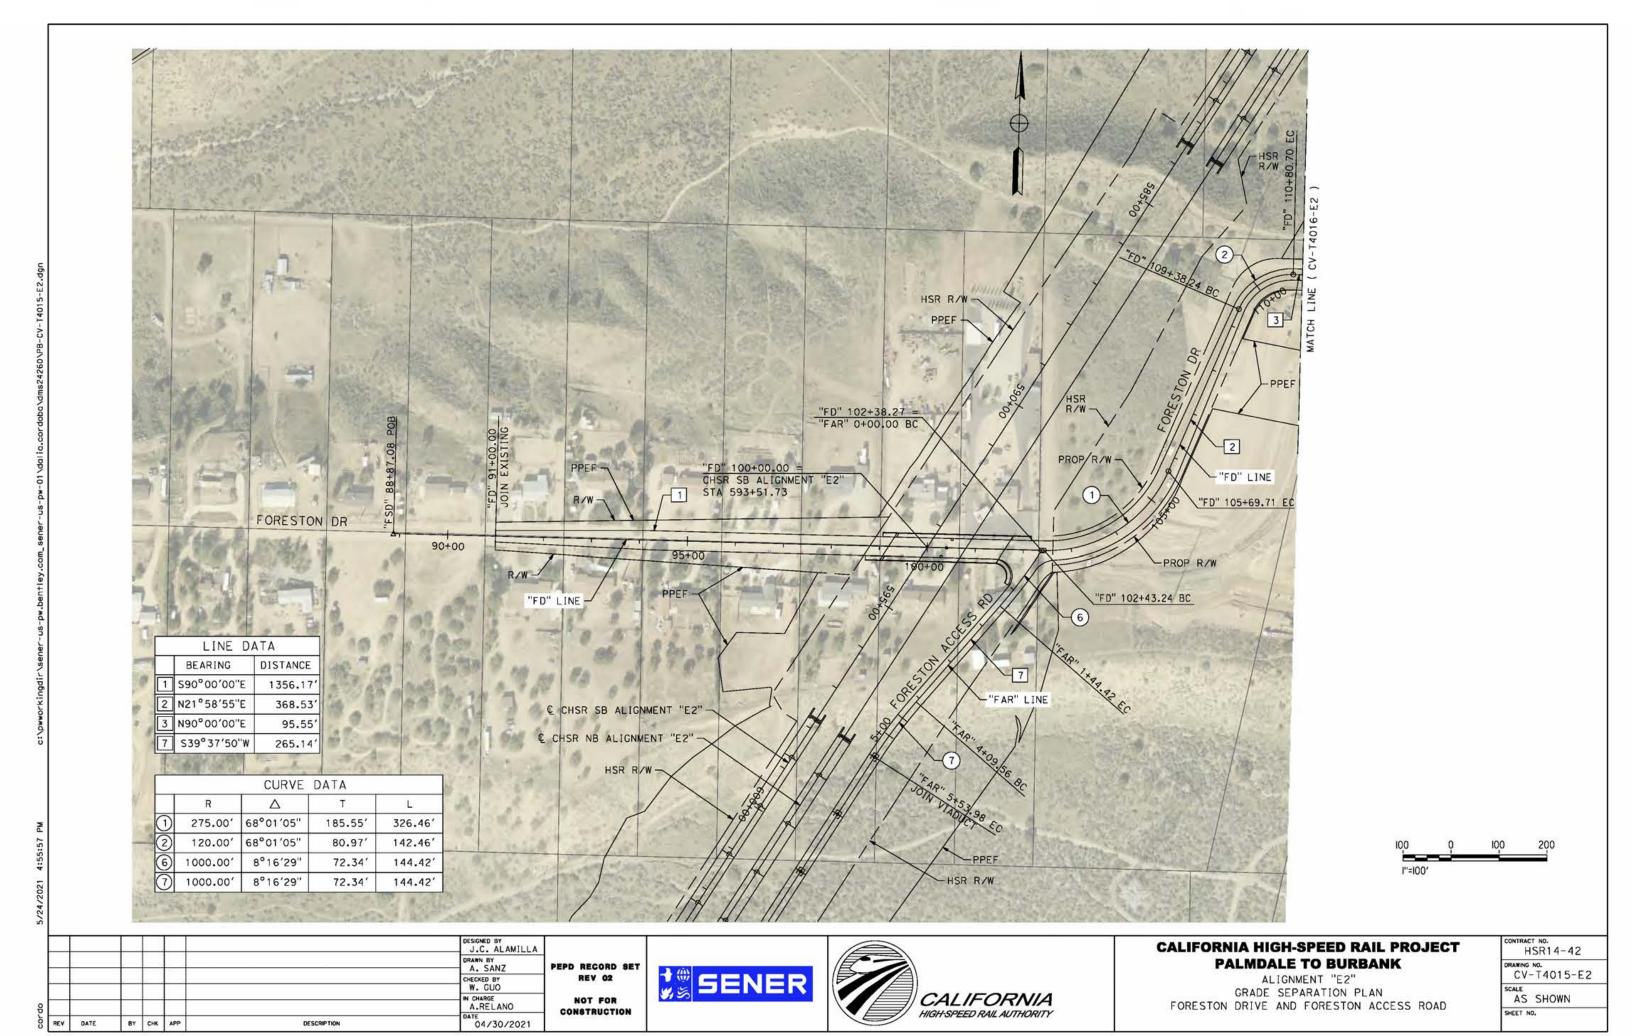

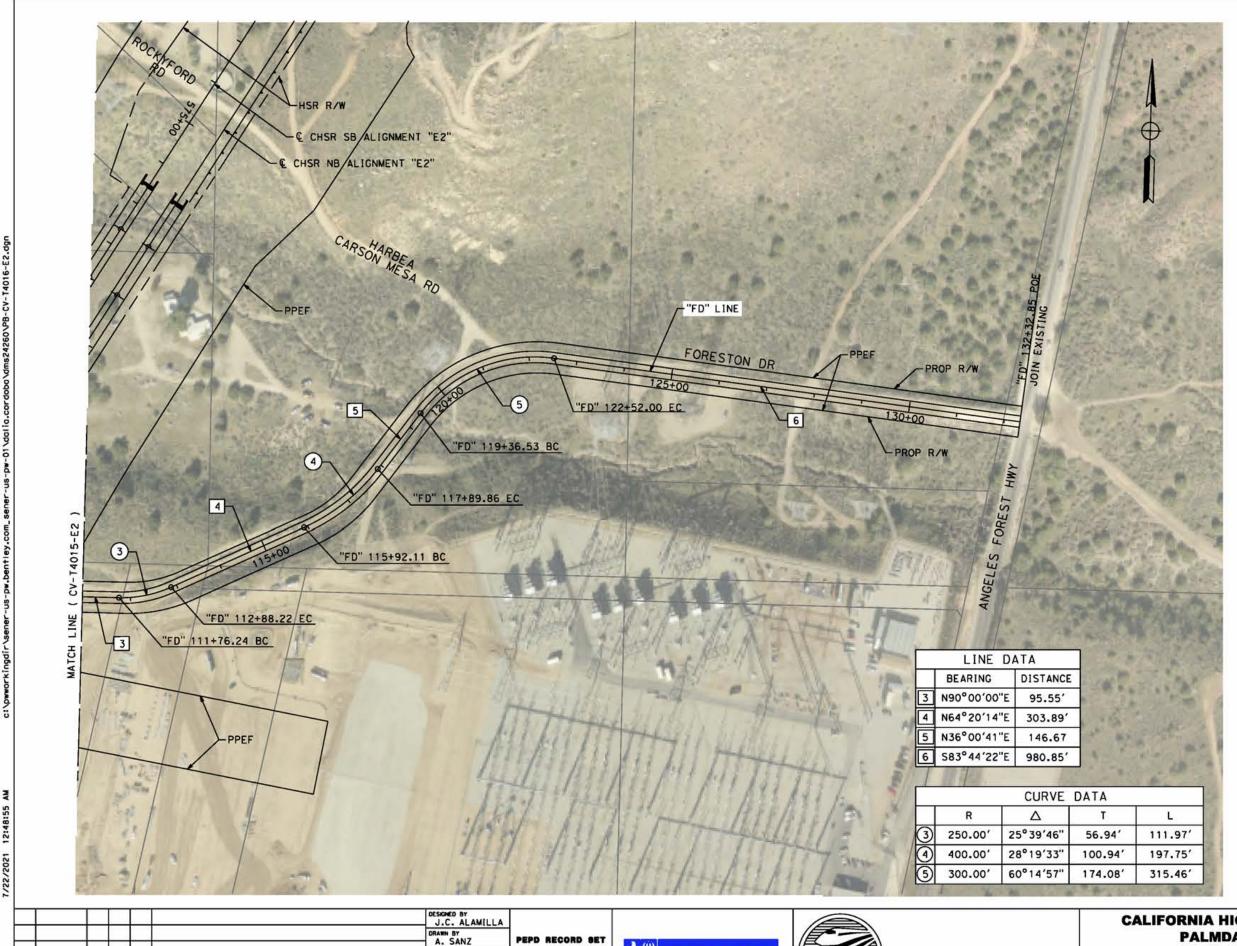



						J.C. ALAMILLA	
						DRAWN BY A. SANZ	P
\vdash		-				W. GUO	
		\vdash				IN CHARGE A.RELANO	
REV	DATE	BY	CHK	APP	DESCRIPTION	DATE 04/30/2021	

REV 02

NOT FOR
CONSTRUCTION







CALIFORNIA HIGH-SPEED RAIL PROJECT PALMDALE TO BURBANK

ALIGNMENT "E2"
GRADE SEPARATION PLAN
FORESTON DRIVE

CONTRACT NO. HSR14-42					
DRAWING NO. CV-T4016-E2					
SCALE AS SHOWN					
SHEET NO.					

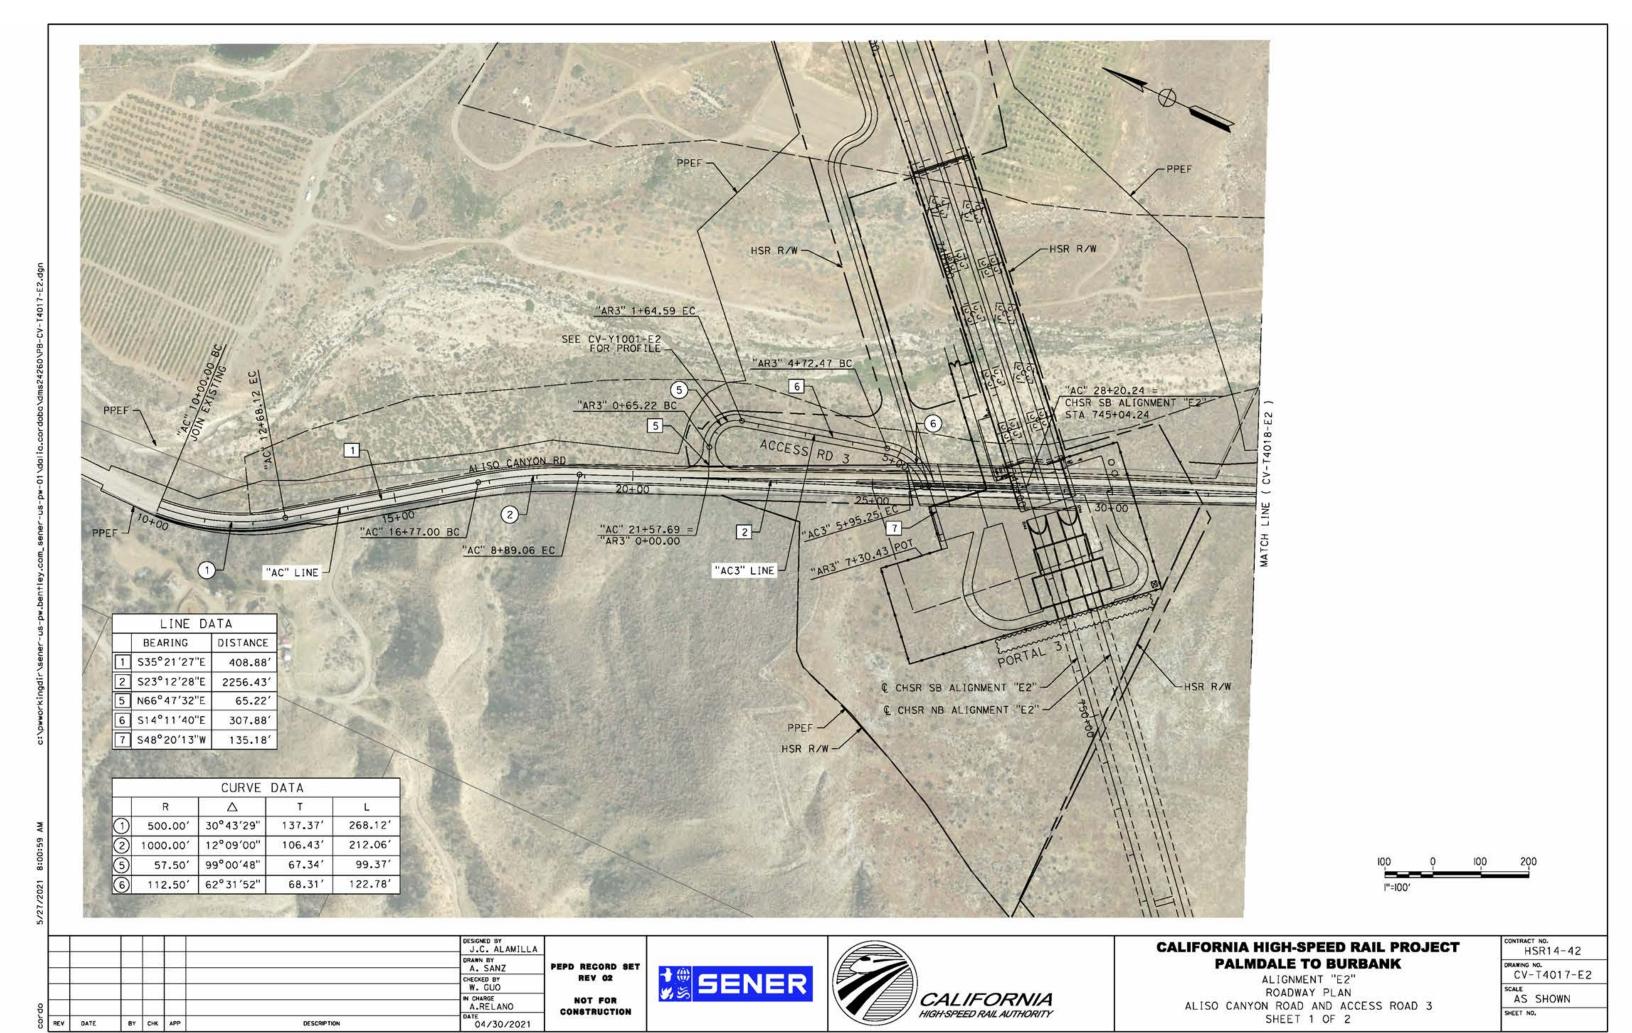

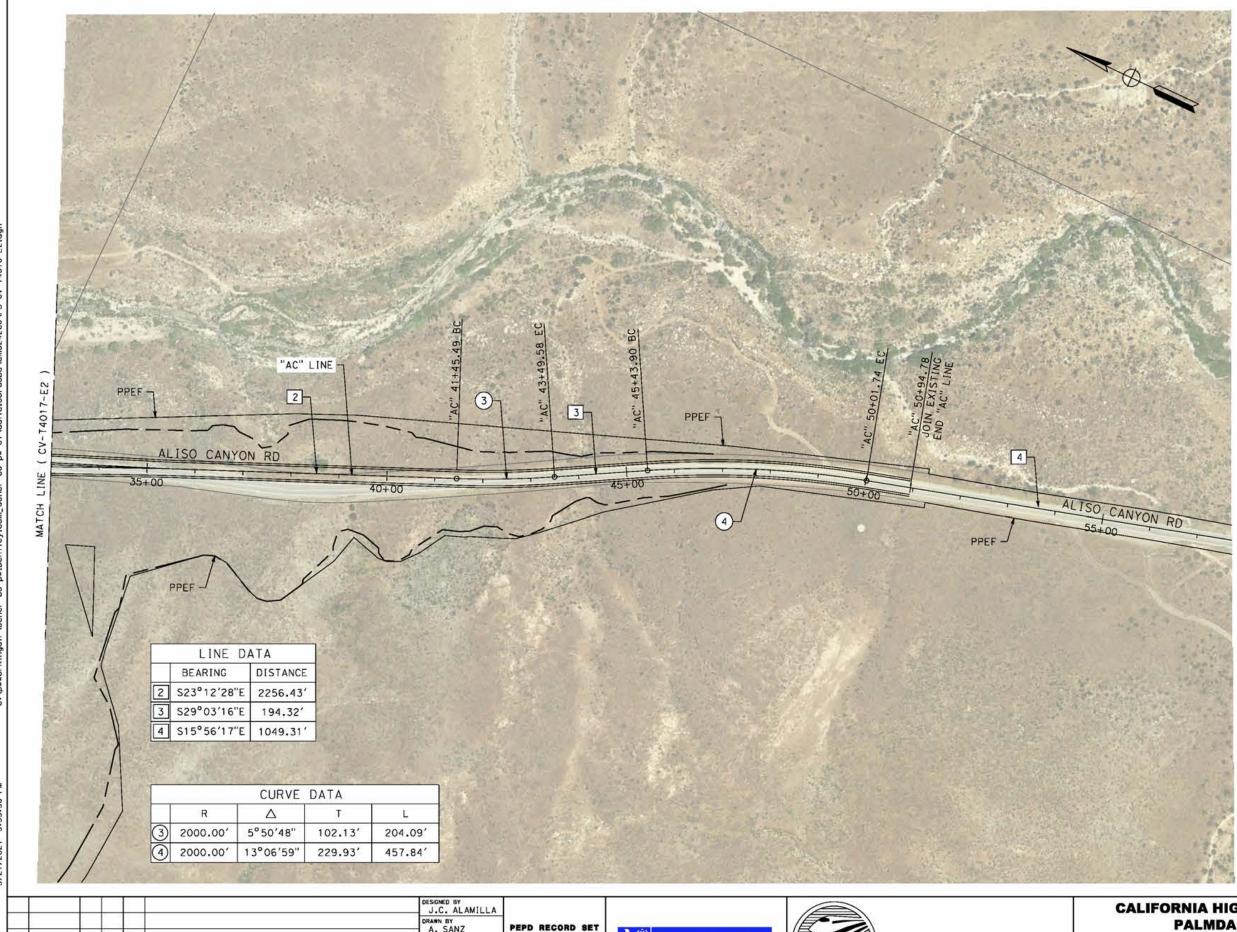



PALMDALE TO BURBA

ALIGNMENT "E2"

ROADWAY PLAN

ALISO CANYON ROAD

SHEET 2 OF 2


PEED RAIL PROJECT	CONTRACT NO. HSR14-42
O BURBANK	DRAWING NO. CV-T4018-E2
Y PLAN YON ROAD	AS SHOWN
TON ROAD	SHEET NO.


						J.C. ALAMILLA	
						DRAWN BY A. SANZ	8
		-				CHECKED BY W. GUO	
	<u> </u>	1				IN CHARGE A.RELANO	
REV	DATE	BY	СНК	APP	DESCRIPTION	DATE 04/30/2021	


PEPD RECORD SET REV 02 NOT FOR CONSTRUCTION







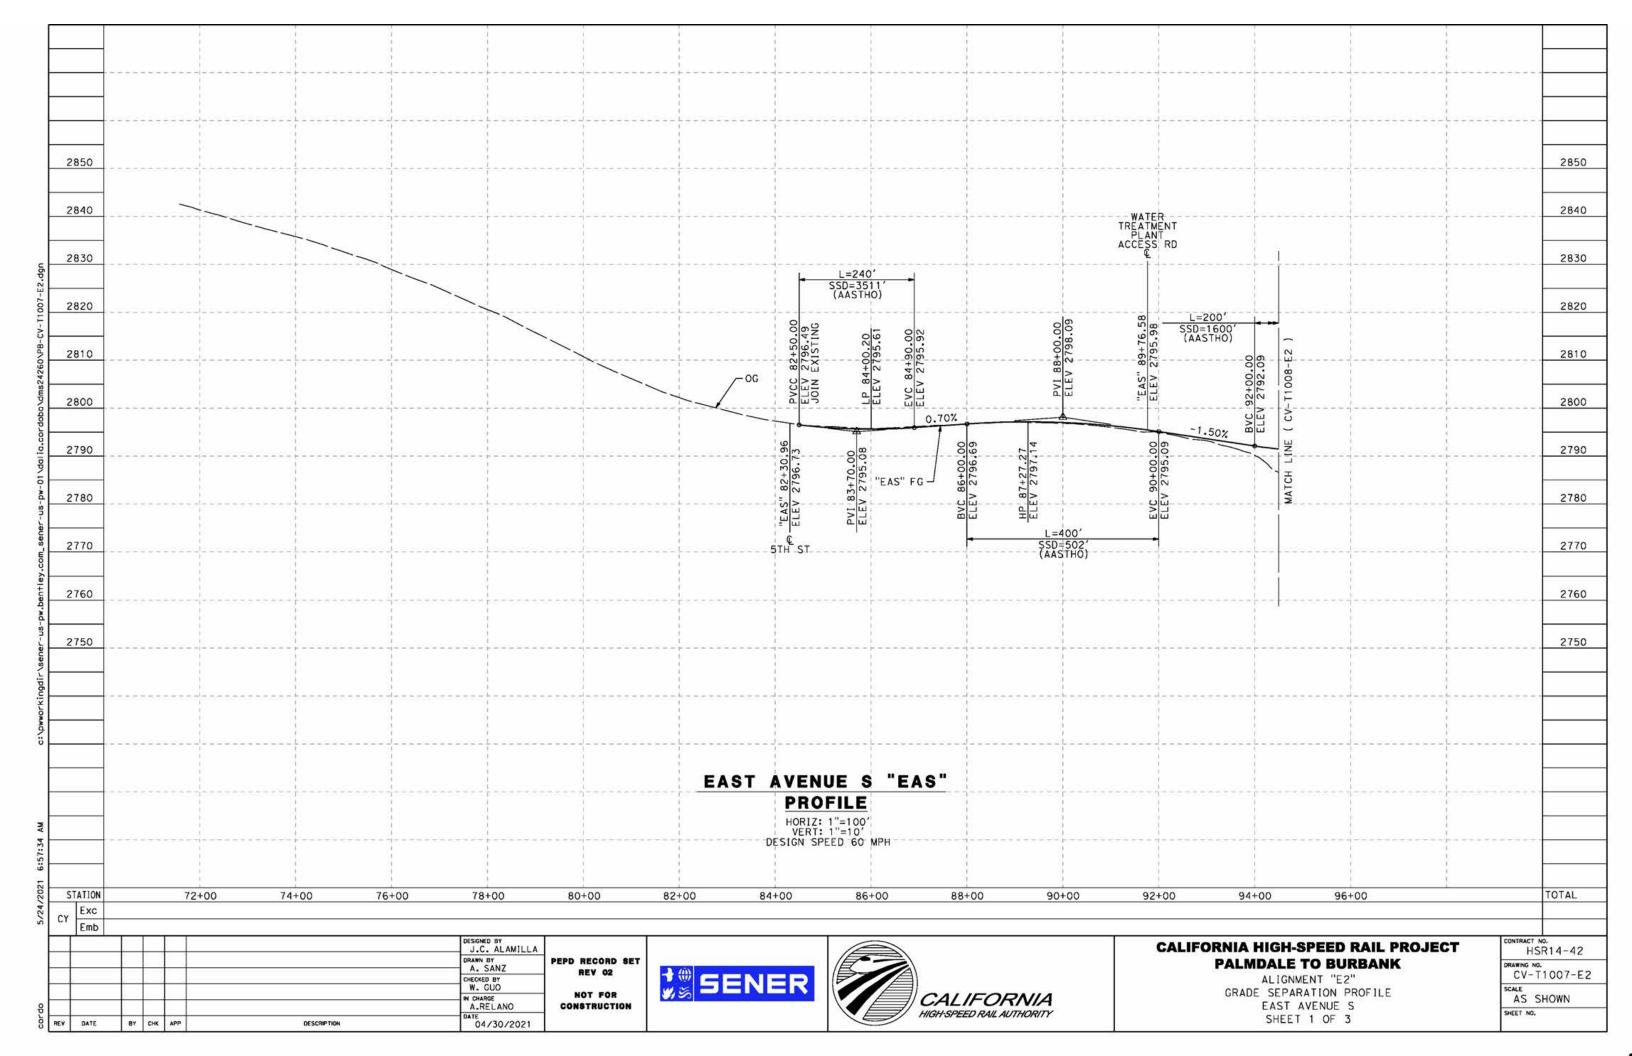


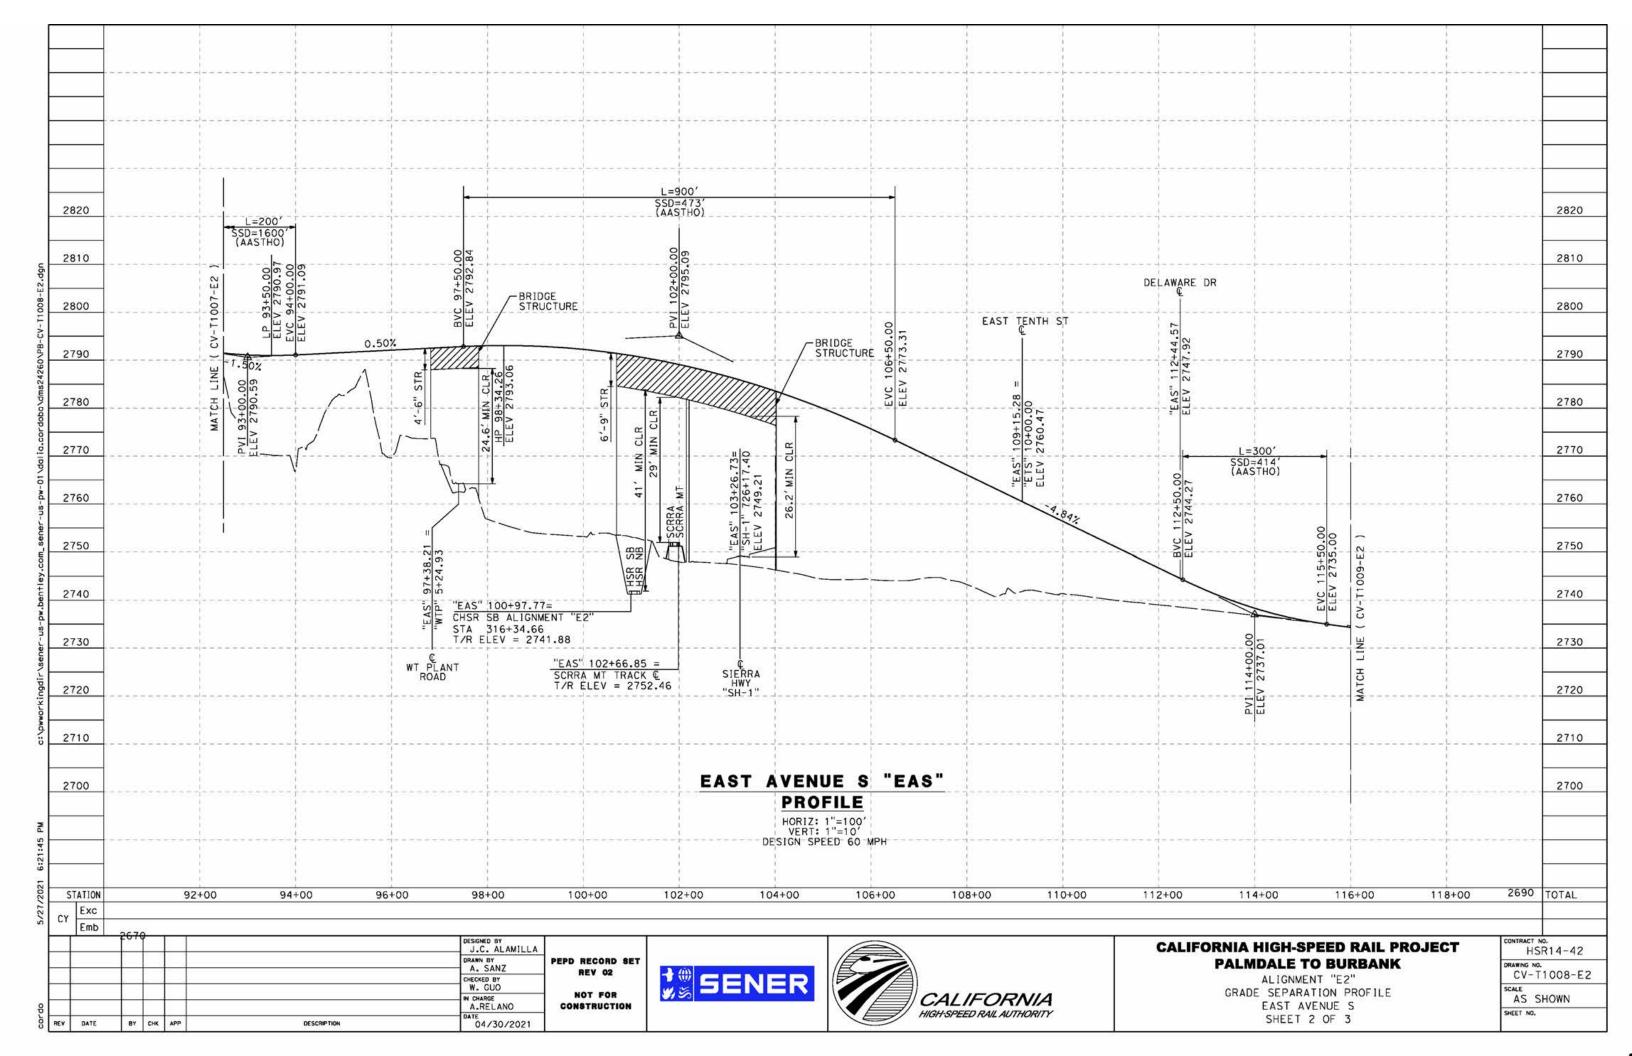


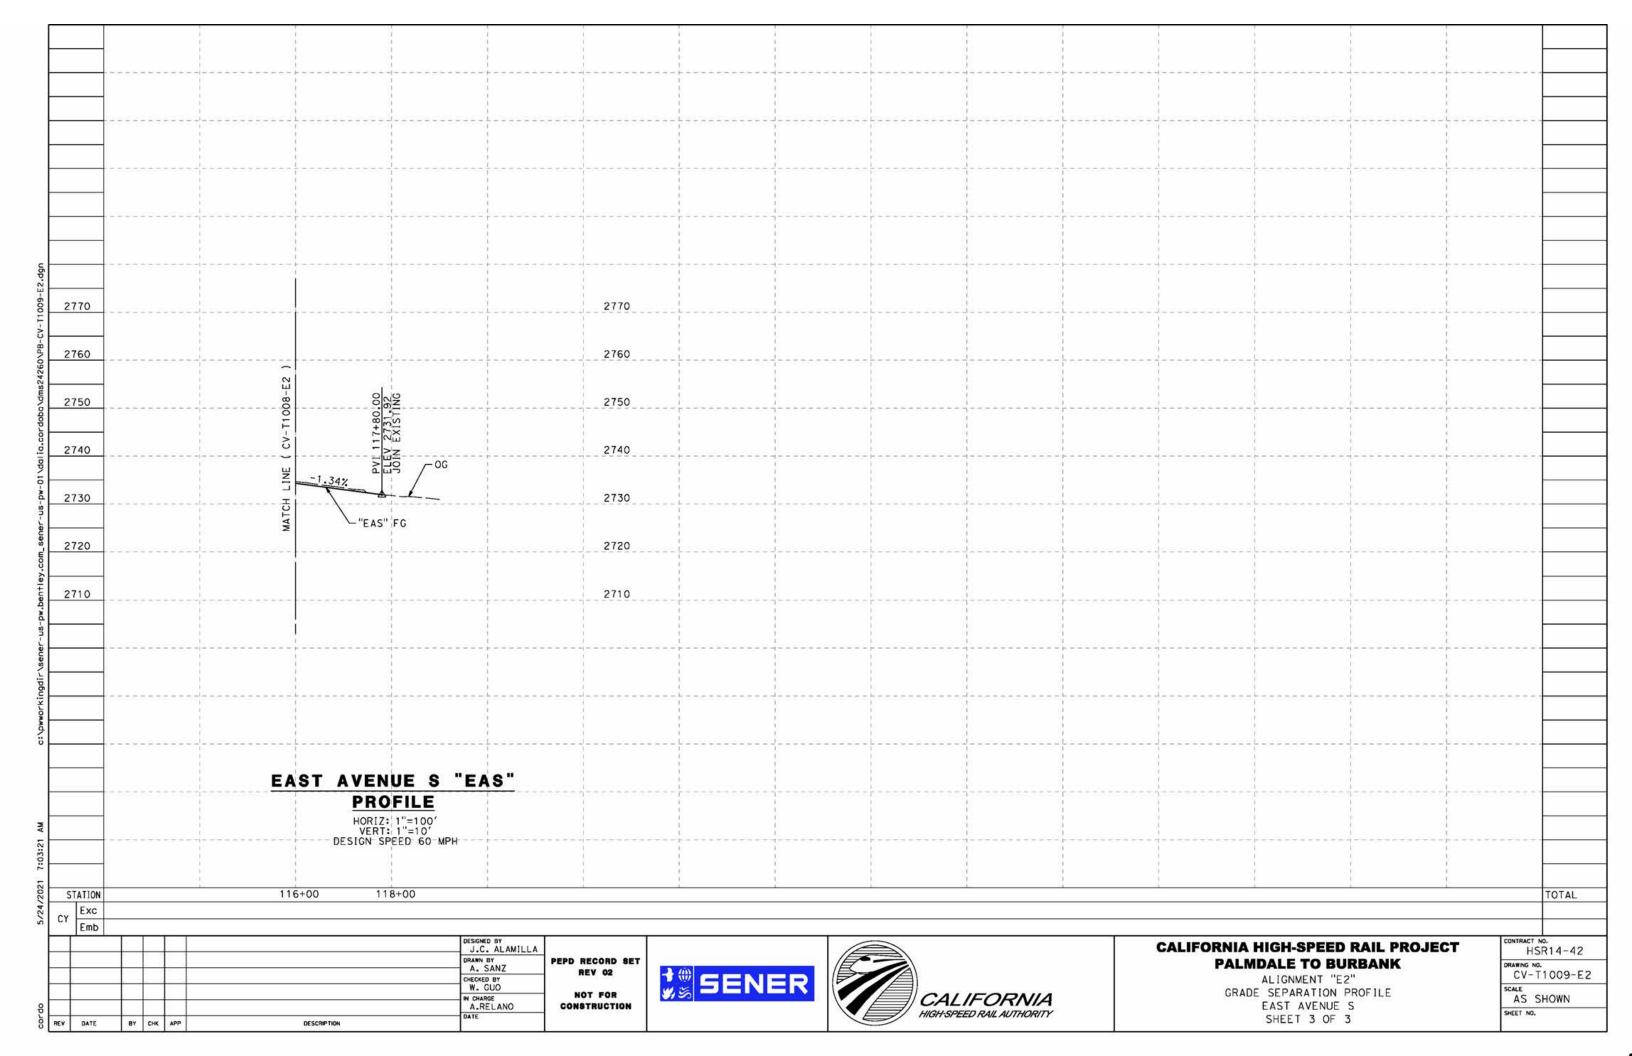

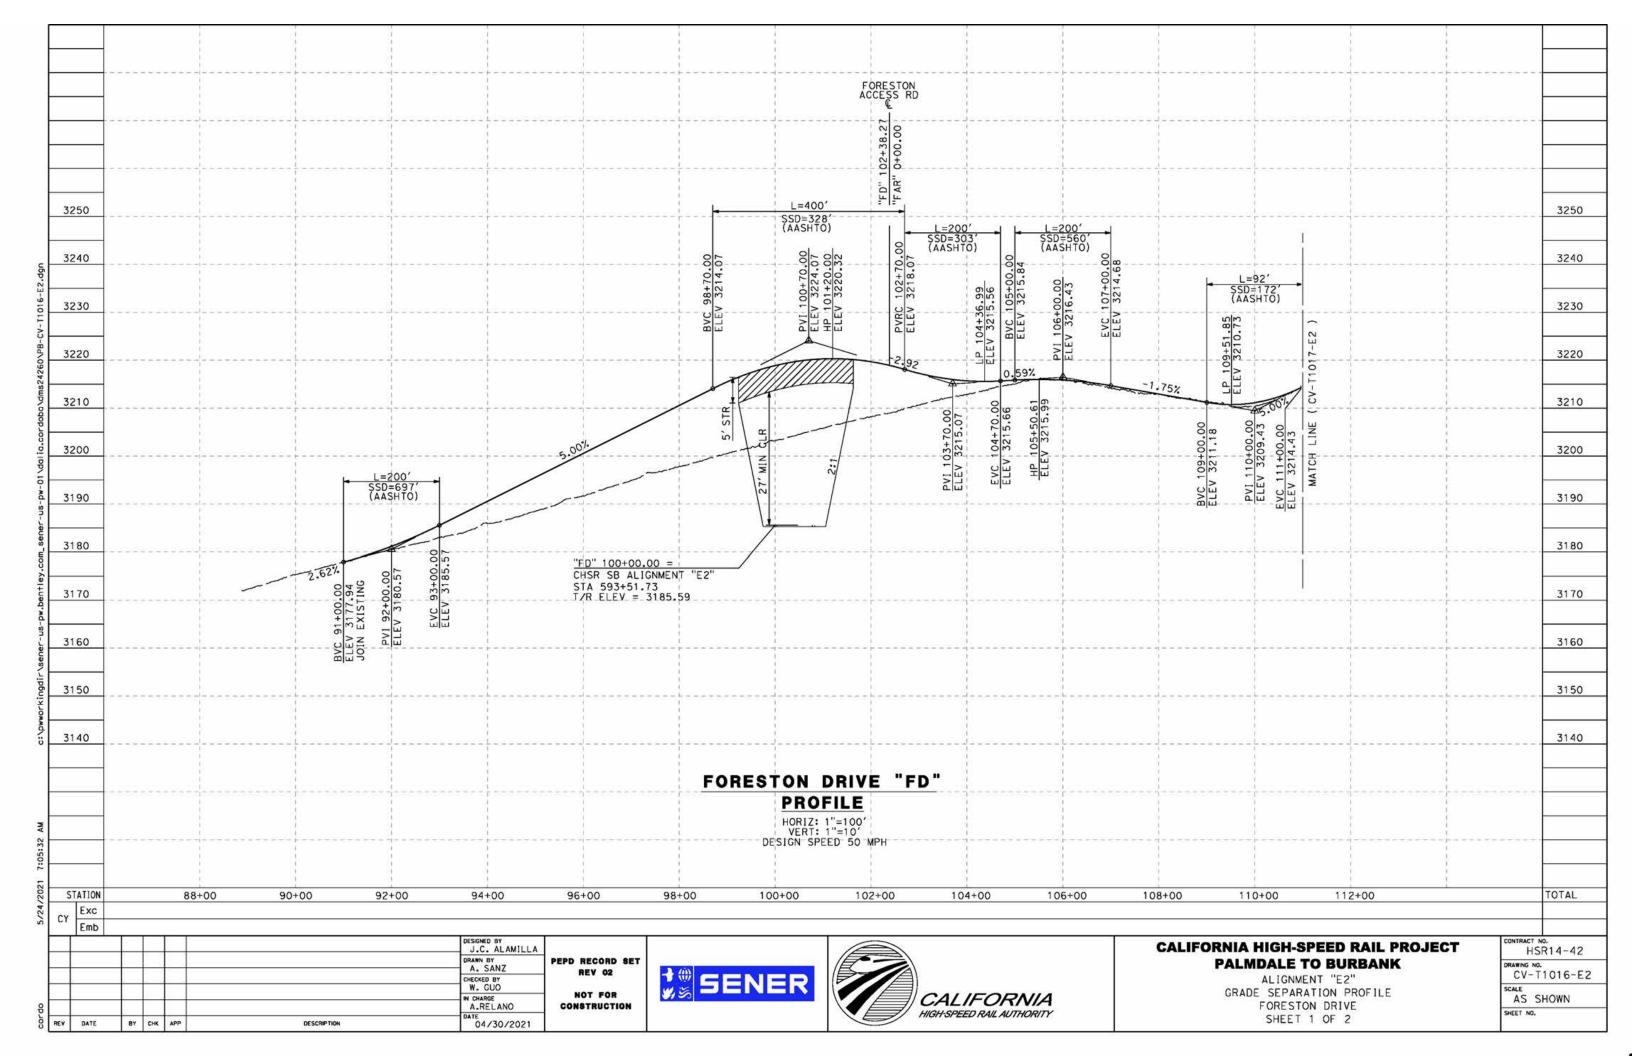

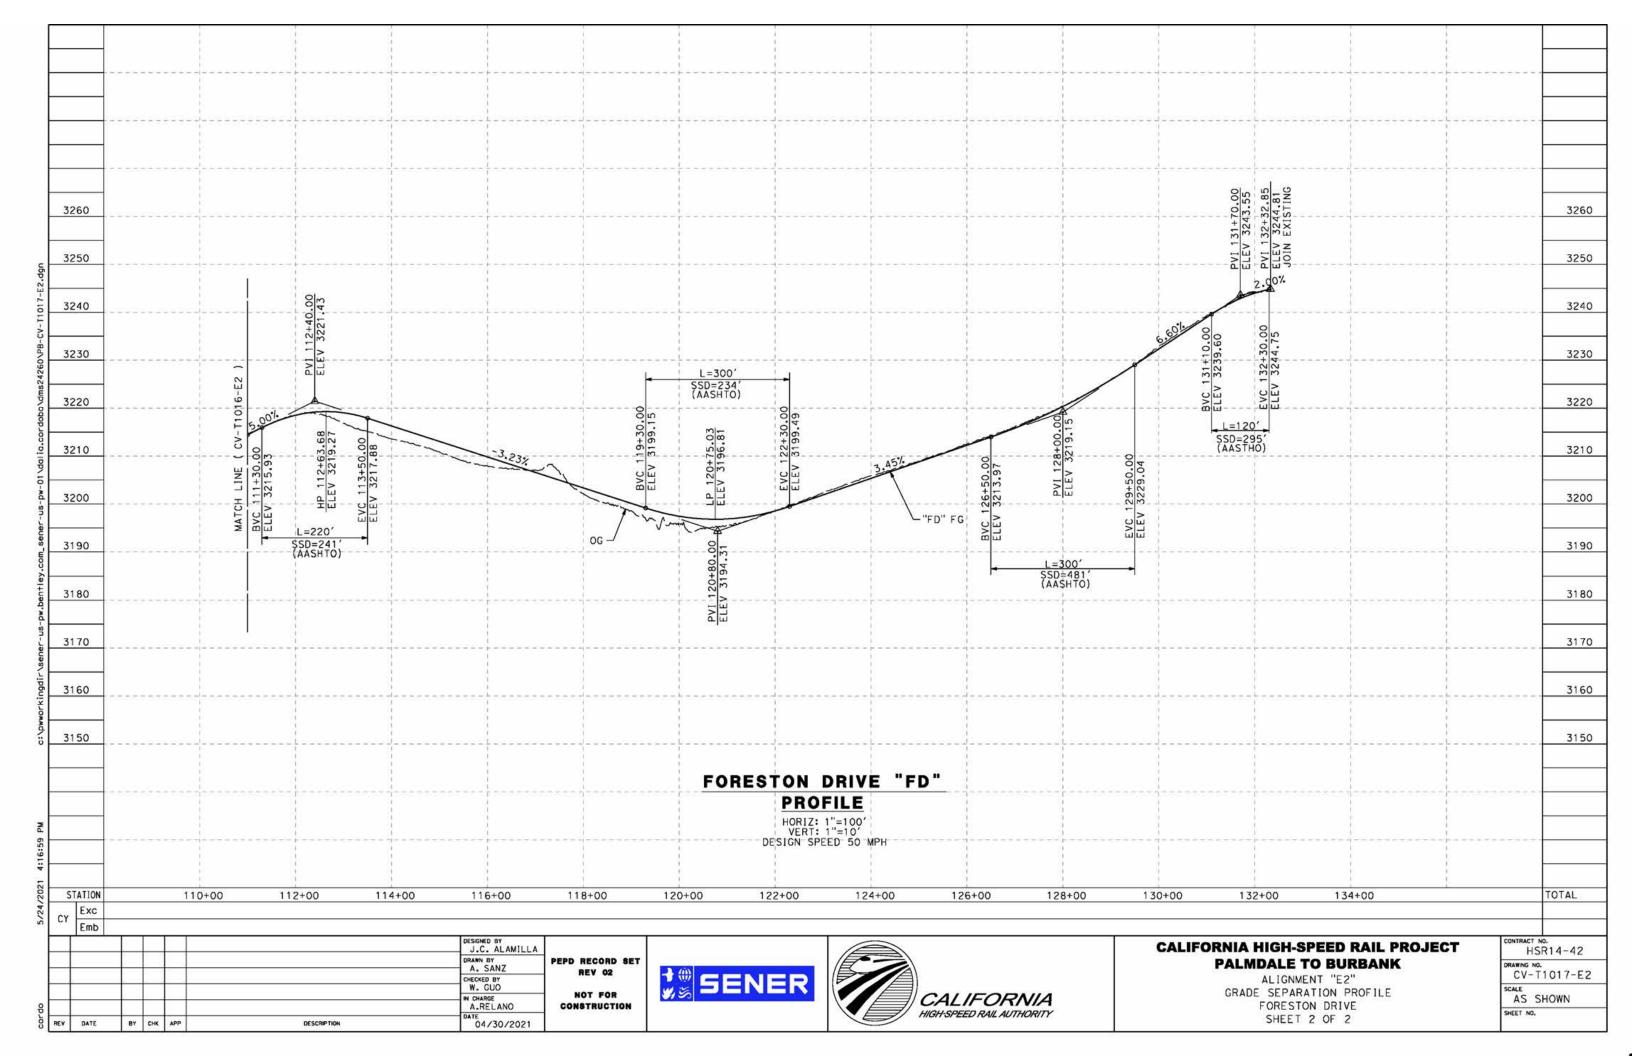

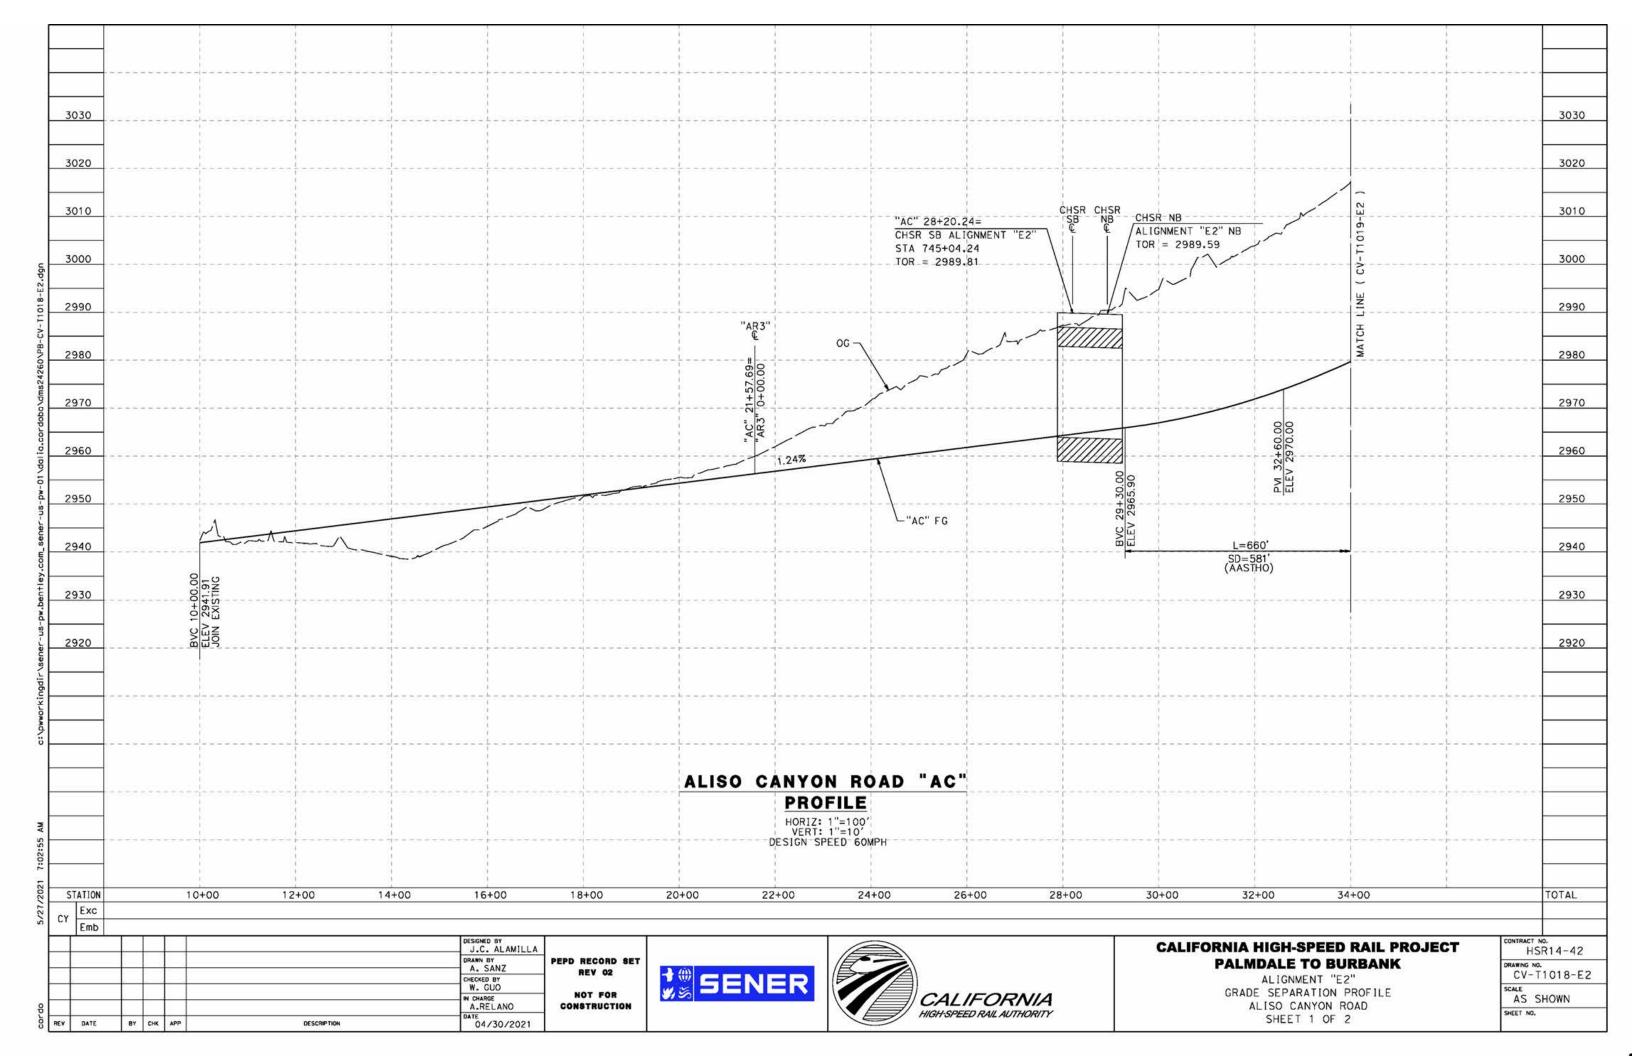

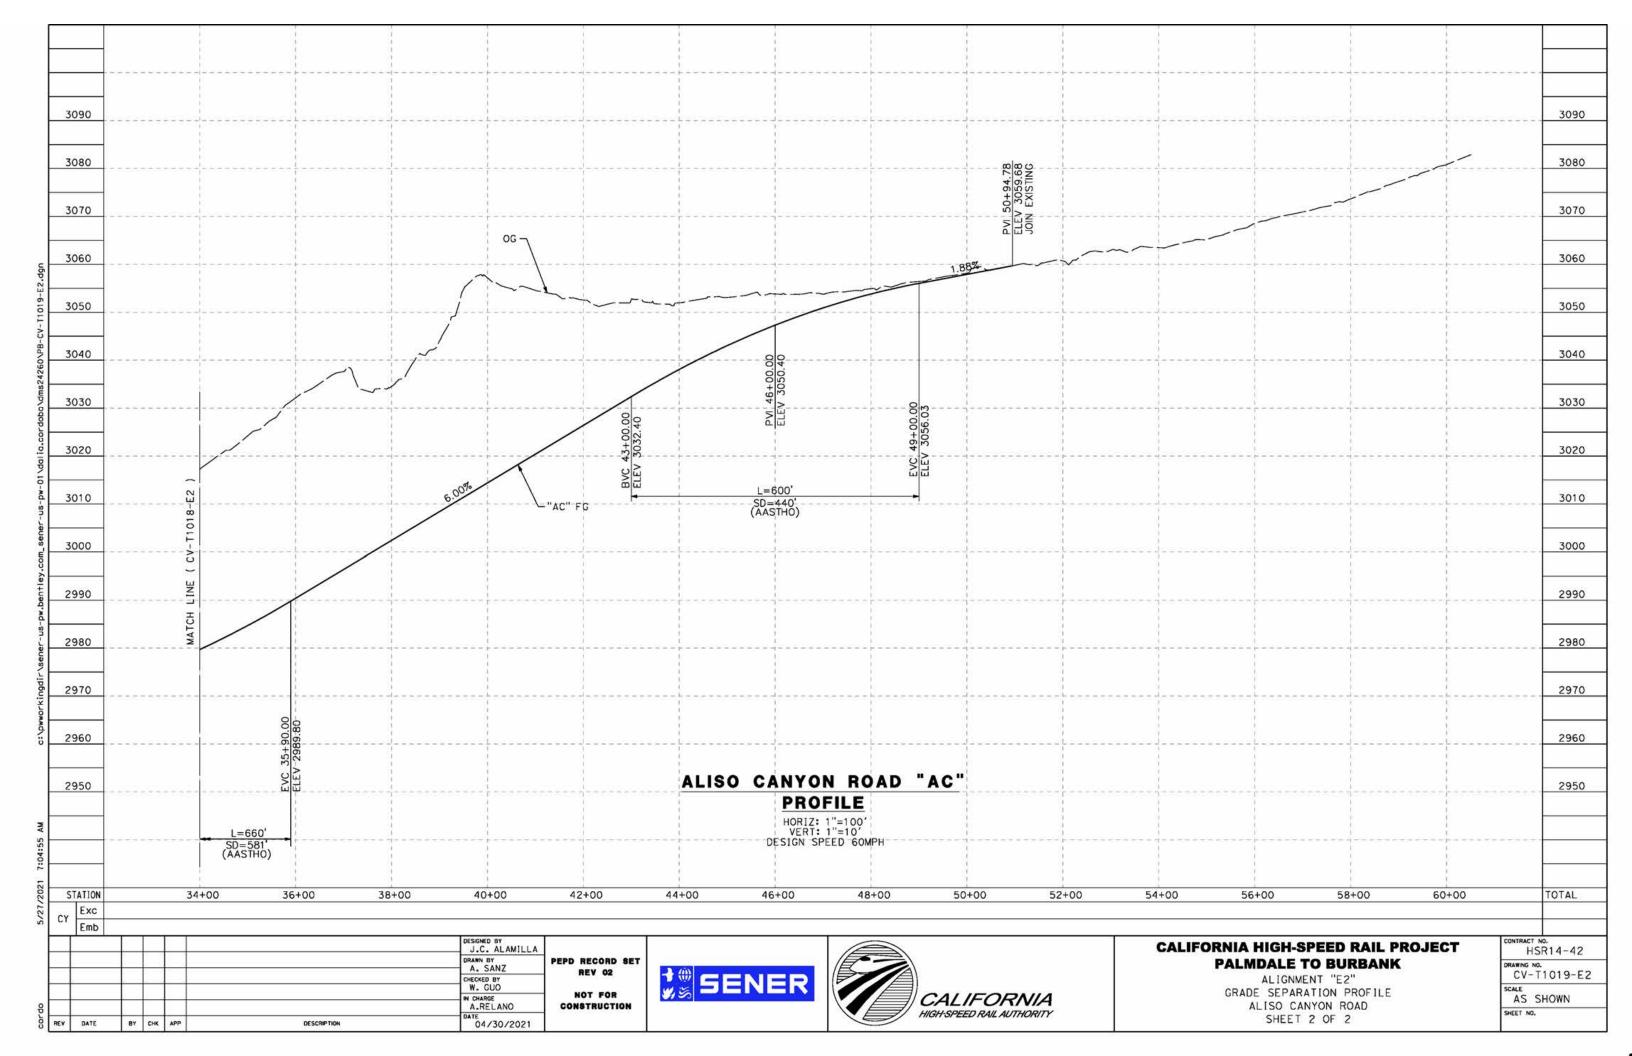










ALIGNMENT "E2" TYPICAL SECTIONS FORESTON DRIVE


CONTRACT NO. HSR14-42
DRAWING NO. CV-T3001-E2
SCALE

NO SCALE SHEET NO.

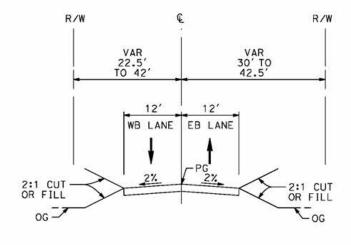

FORESTON DRIVE

STA 105+64 TO STA 132+32 LOCAL ROADWAY PER LOS ANGELES COUNTY MUNICIPAL CODE CHAPTER 21 PARTS 2 AND 3

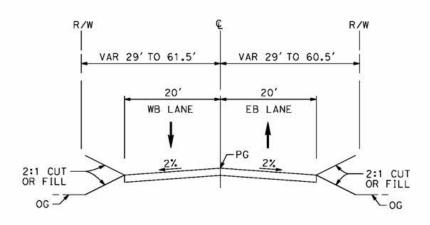


FORESTON DRIVE

STA 91+00 TO STA 105+64 LOCAL ROADWAY PER LOS ANGELES COUNTY MUNICIPAL CODE CHAPTER 21 PARTS 2 AND 3

٠							
						J.C. ALAMILLA	
		-				DRAWN BY A. SANZ	PEP
		+	-			W. GUO	
ᇷᅳ	1	-				IN CHARGE A.RELANO	c
REV	DATE	BY	СНК	APP	DESCRIPTION	DATE 04/30/2021	۱ ۲


ALISO CANYON ROAD

STA 25+85 TO STA 27+92 SECONDARY HIGHWAY PER LOS ANGELES COUNTY MASTER PLAN

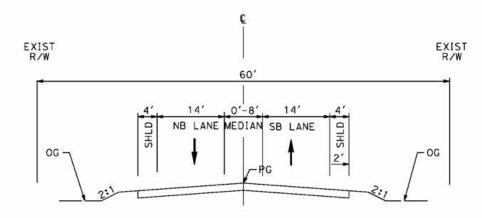

ALISO CANYON ROAD

STA 21+00 TO STA 25+85 AND STA 27+92 TO STA 35+41 SECONDARY HIGHWAY PER LOS ANGELES COUNTY MASTER PLAN

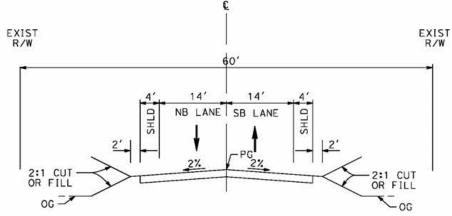

ALISO CANYON ROAD

STA 10+00 TO STA 21+00

AND
STA 35+41 TO STA 51+00
SECONDARY HIGHWAY
PER LOS ANGELES COUNTY MASTER PLAN

٦,								
1							J.C. ALAMILLA	
			-				A. SANZ	PE
-	\dashv		+				W. GUO	
8	\dashv		+		Н		IN CHARGE A.RELANO],
Sor	REV	DATE	84	СНК	APP	DESCRIPTION	04/30/2021	ै

EPD RECORD SET REV 02 NOT FOR CONSTRUCTION







CALIFORNIA HIGH-SPEED RAIL PROJECT PALMDALE TO BURBANK

ALIGNMENT "E2" TYPICAL SECTIONS ALISO CANYON ROAD

CONTRACT NO.				
HSR14-42				
DRAWING NO. CV-T3002-E2				
NO SCALE				
ALTER NA				

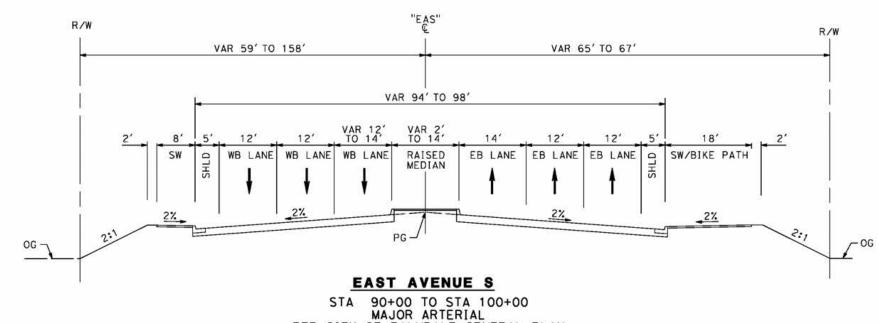

PER CITY OF PALMDALE GENERAL PLAN

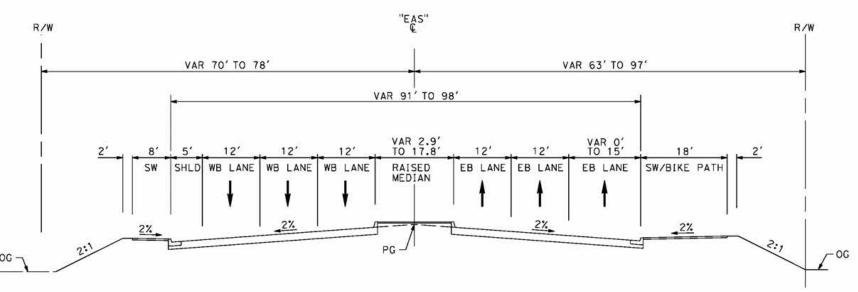

EAST AVENUE S

STA 83+84 TO STA 90+00 MAJOR ARTERIAL PER CITY OF PALMDALE GENERAL PLAN

					Ш	DESIGNED BY J.C. ALAMILLA	
			-		\vdash	DRAWN BY A. SANZ	PEP
			+		H	CHECKED BY W. GUO	
유		2	+		\vdash	IN CHARGE A.RELANO	
COL	REV	DATE	BY	СНК	APP	DESCRIPTION DATE 04/30/2021] ້



REV 02

NOT FOR





CALIFORNIA HIGH-SPEED RAIL PROJECT PALMDALE TO BURBANK

ALIGNMENT "E2" TYPICAL SECTIONS EAST AVENUE S SHEET 1 OF 2

Н	SR14-42			
DRAWING NO. CV-T3003-E2				
SCALE NO	SCALE			

SHEET NO.

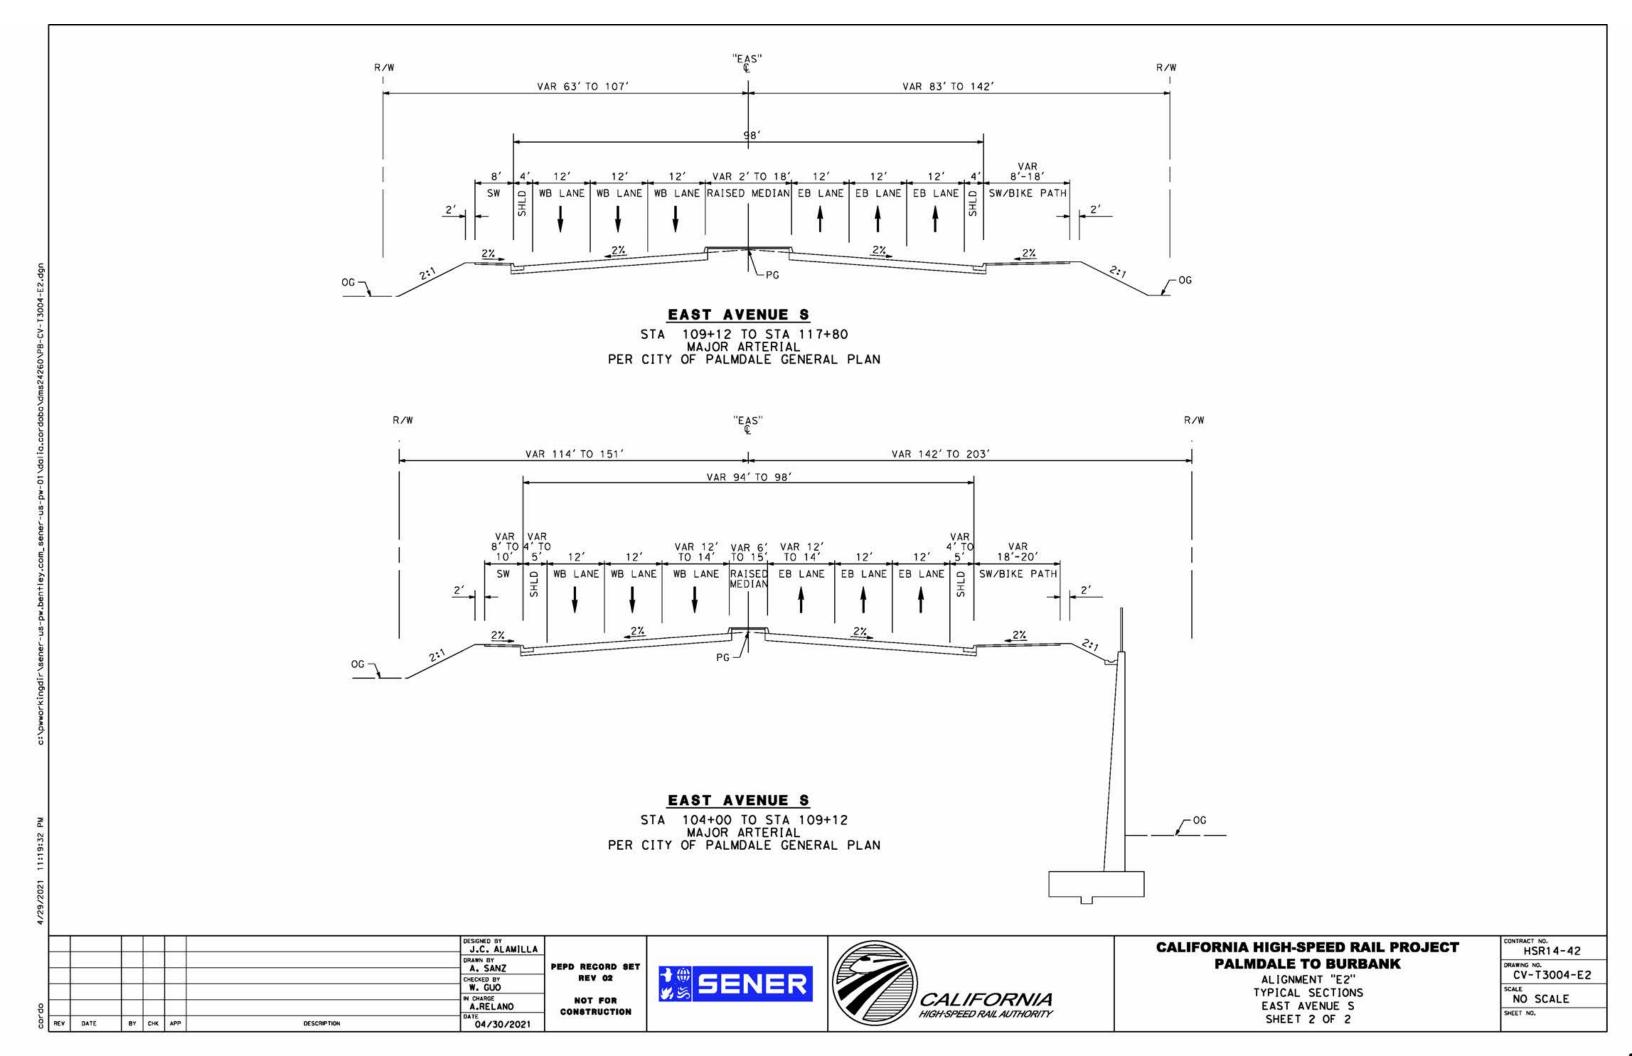

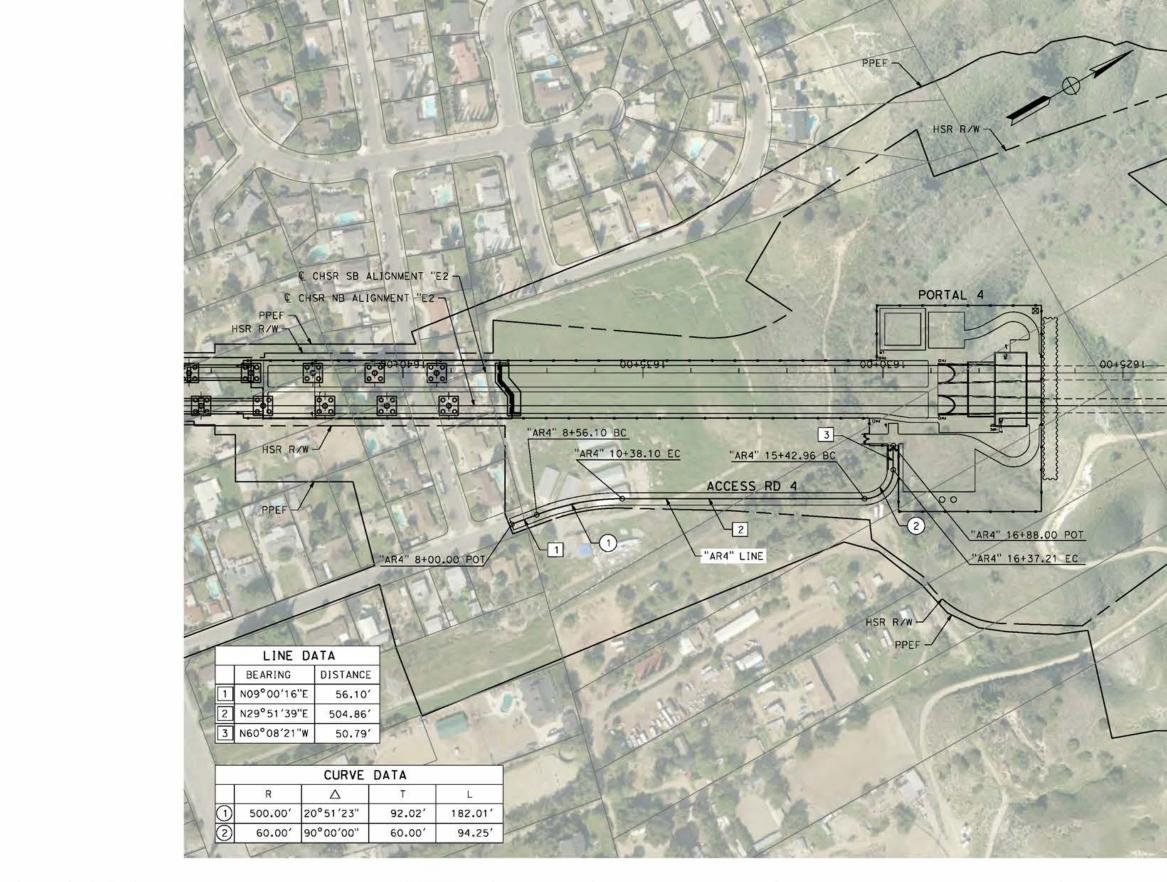



		\perp				J.C. ALAMILLA	
		-				DRAWN BY A. SANZ	PE
\dashv	-	+				CHECKED BY	
\dashv	-	+	-			IN CHARGE A.RELANO	
REV	DATE	84	СНК	APP	DESCRIPTION	DATE 04/30/2021	Š

PEPD RECORD SET REV 02

NOT FOR CONSTRUCTION








CALIFORNIA HIGH-SPEED RAIL PROJECT PALMDALE TO BURBANK


ALIGNMENT "E2" ACCESS ROAD PLAN ACCESS ROAD 4


CONTRAC	T NO. SR14-42
DRAWING CV-	NO. -Y4001-E2
SCALE	SHOWN
SHEET N	0.

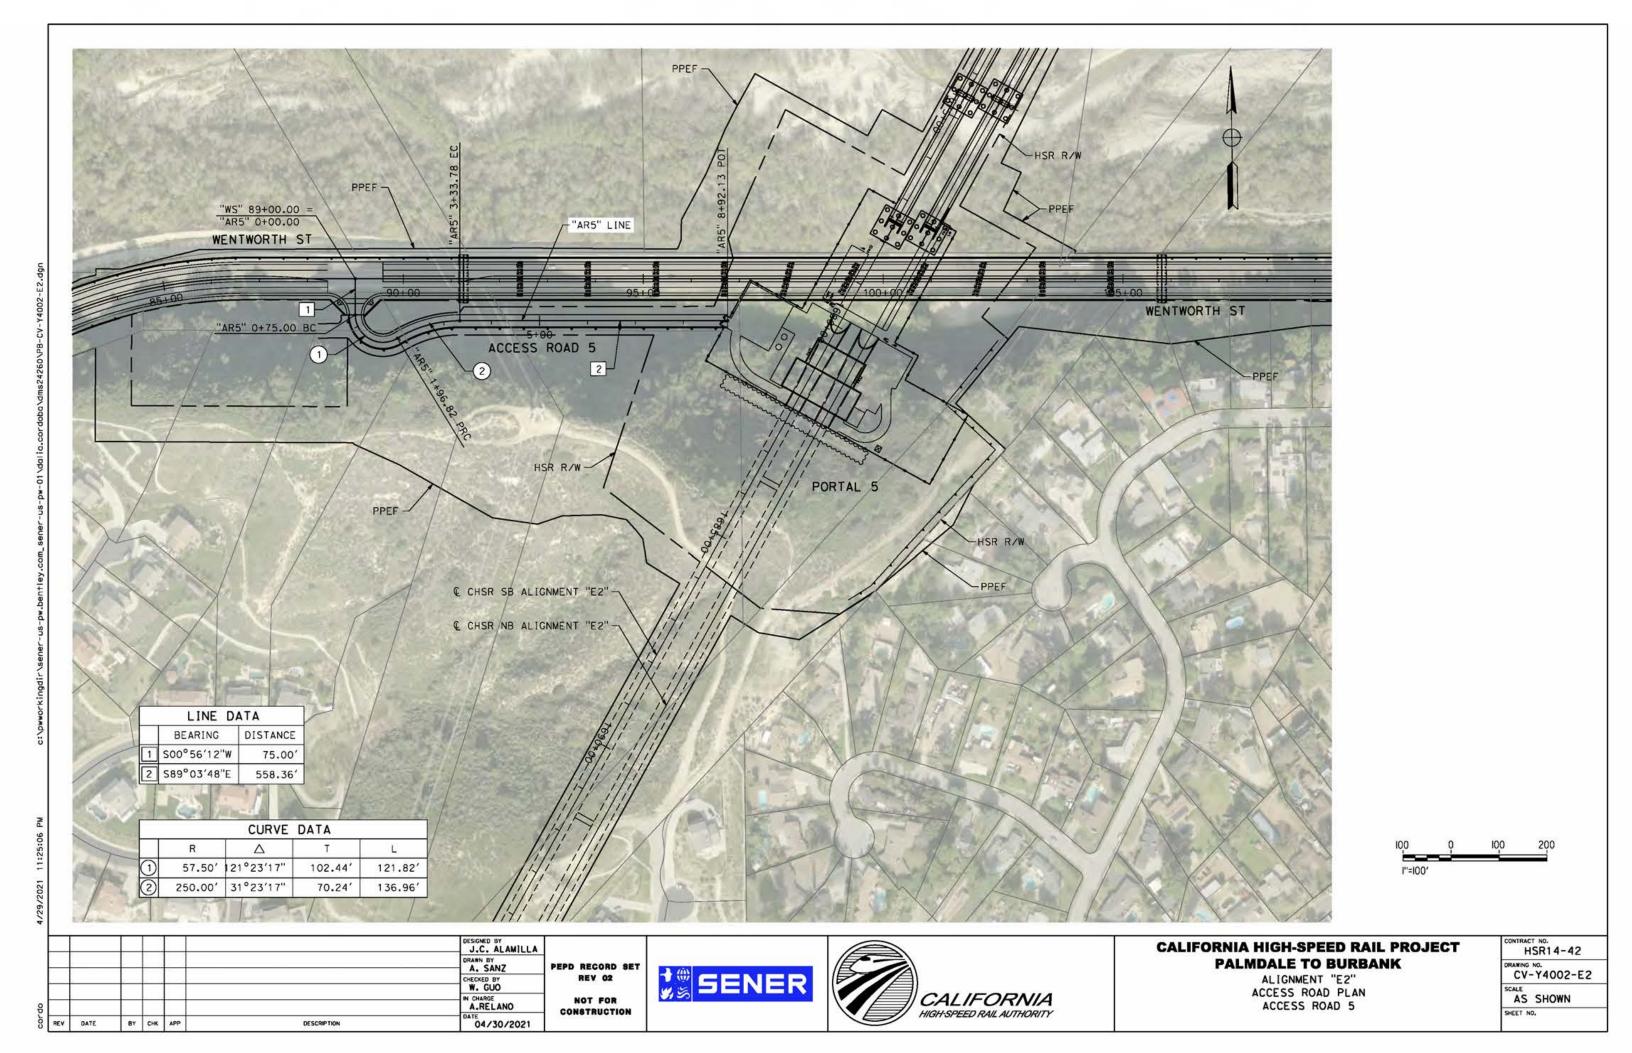


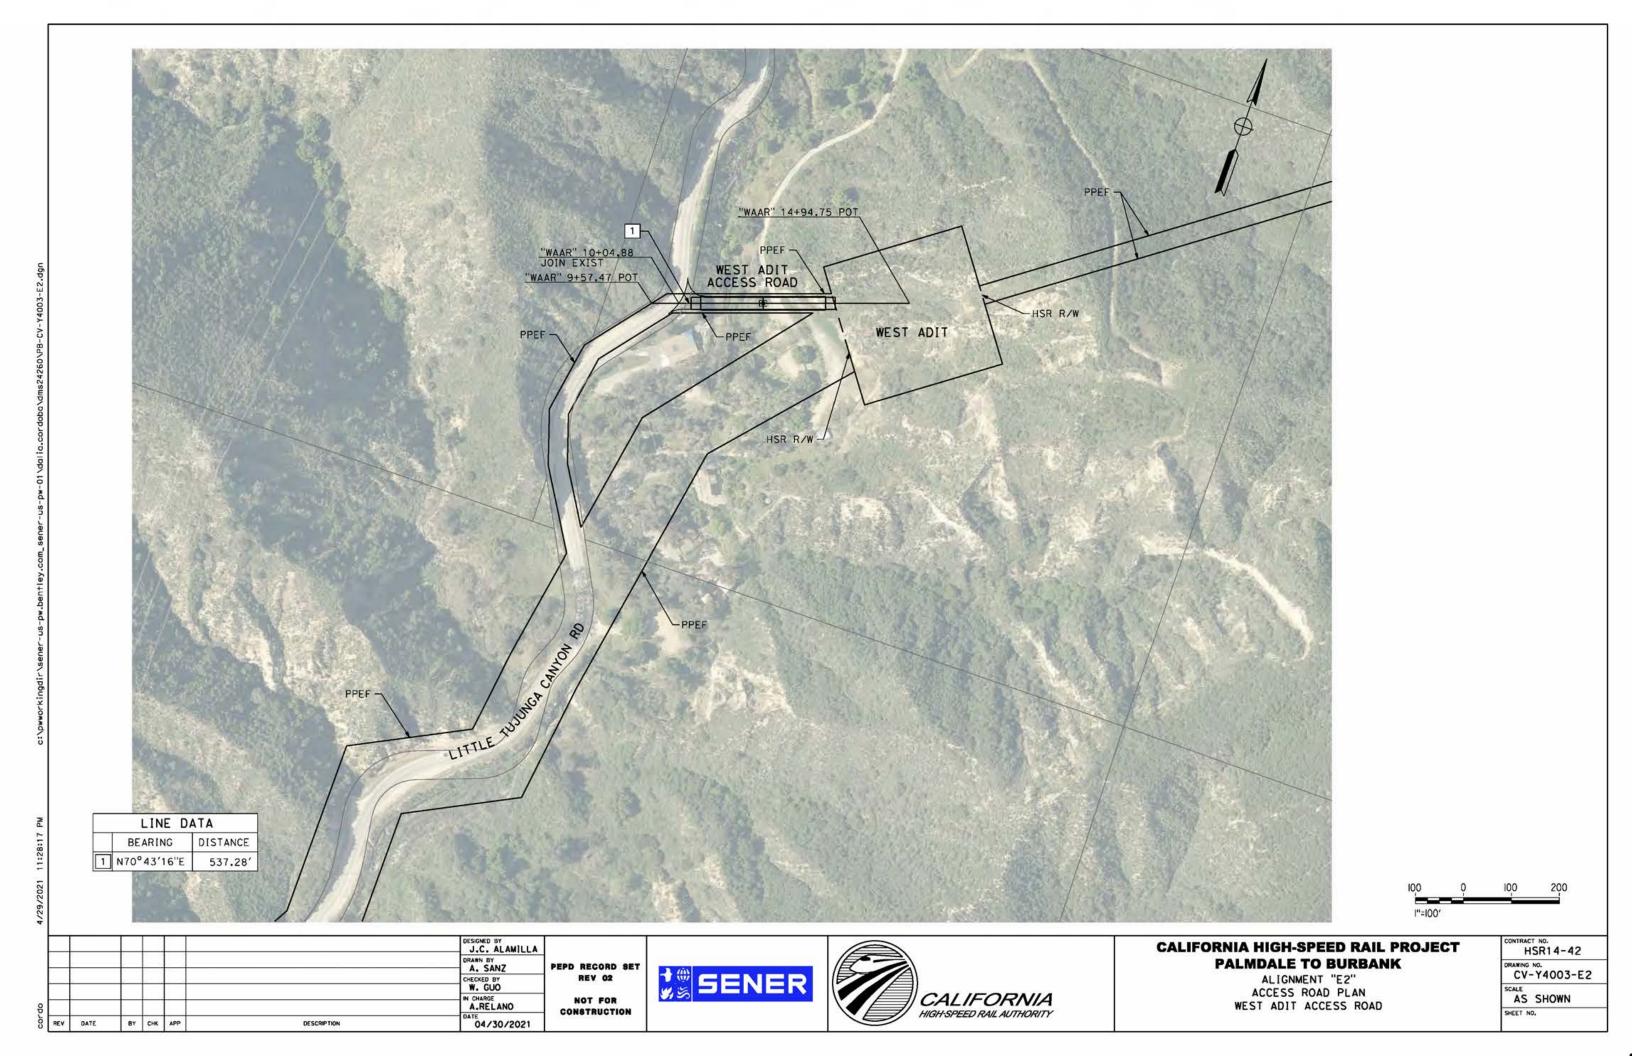

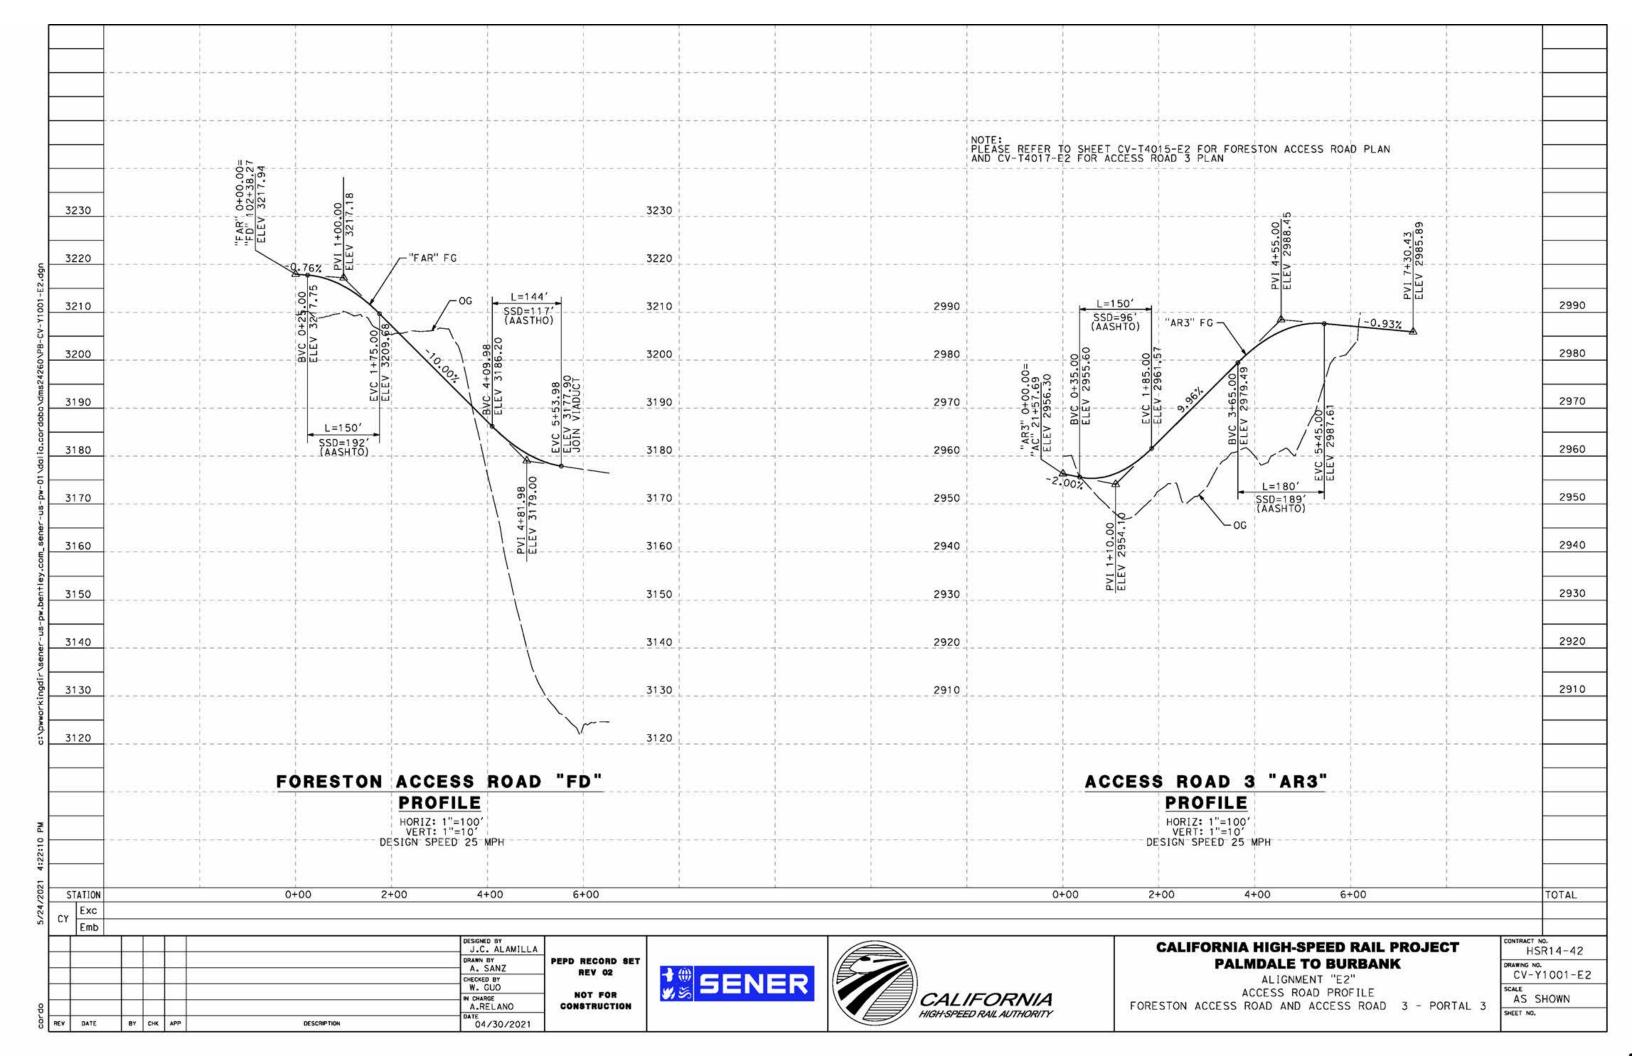

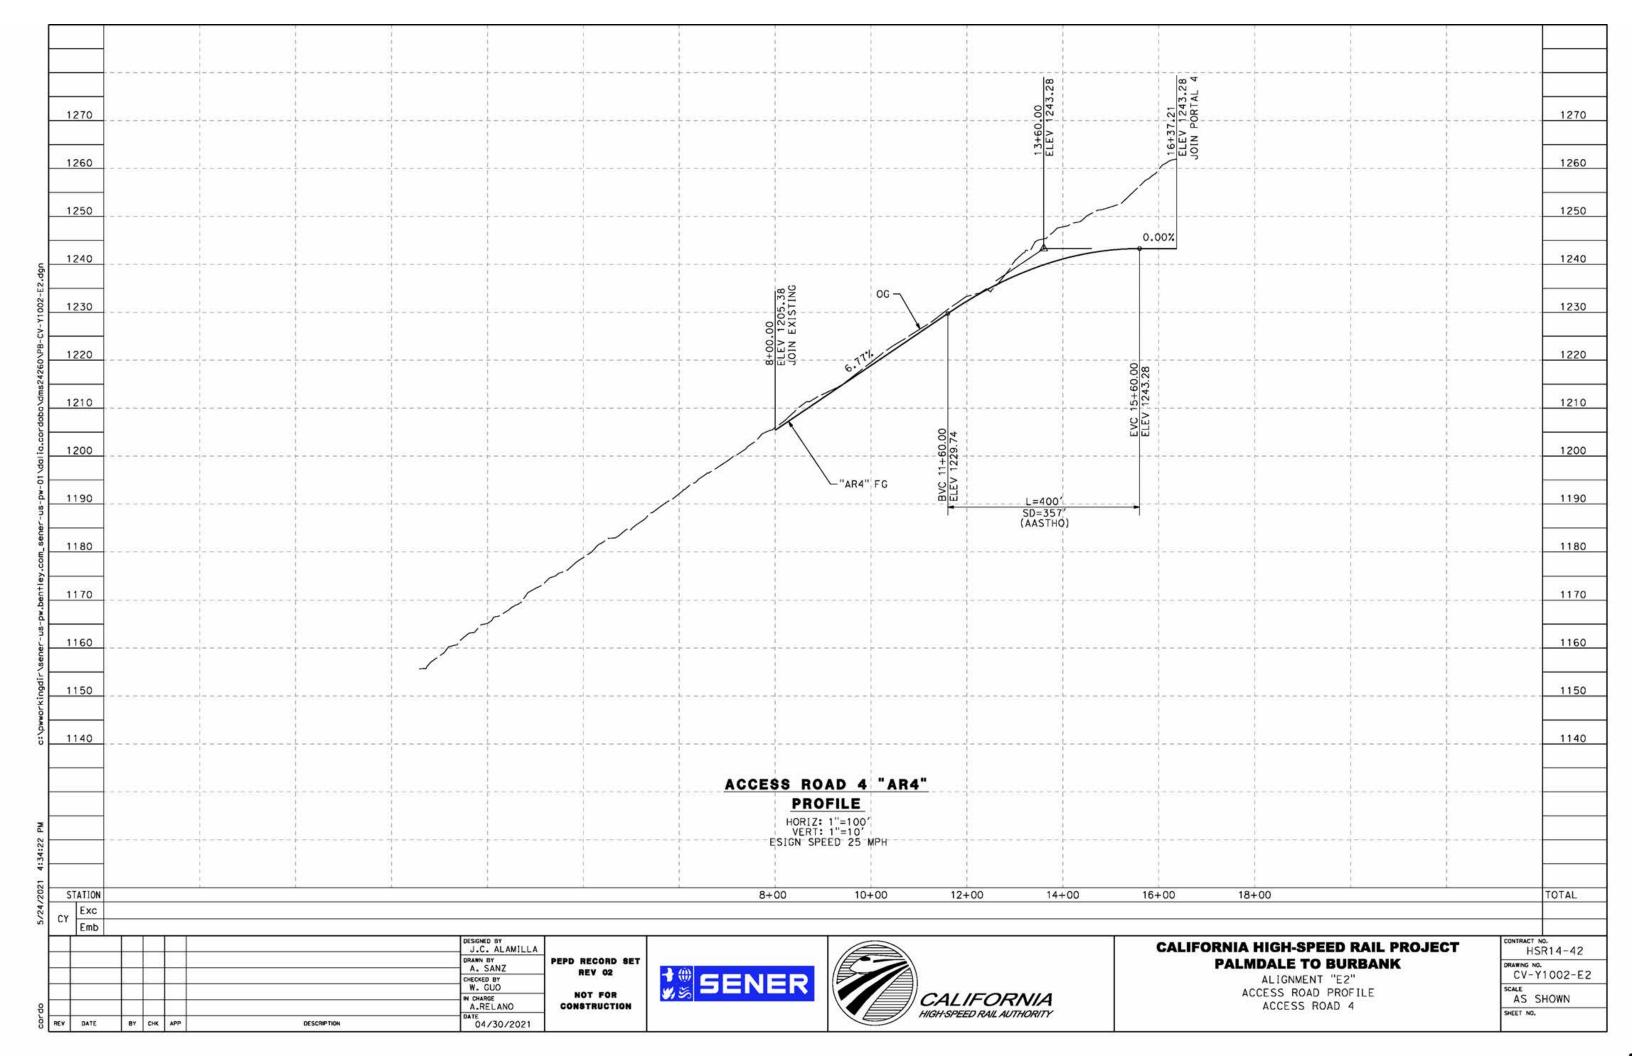

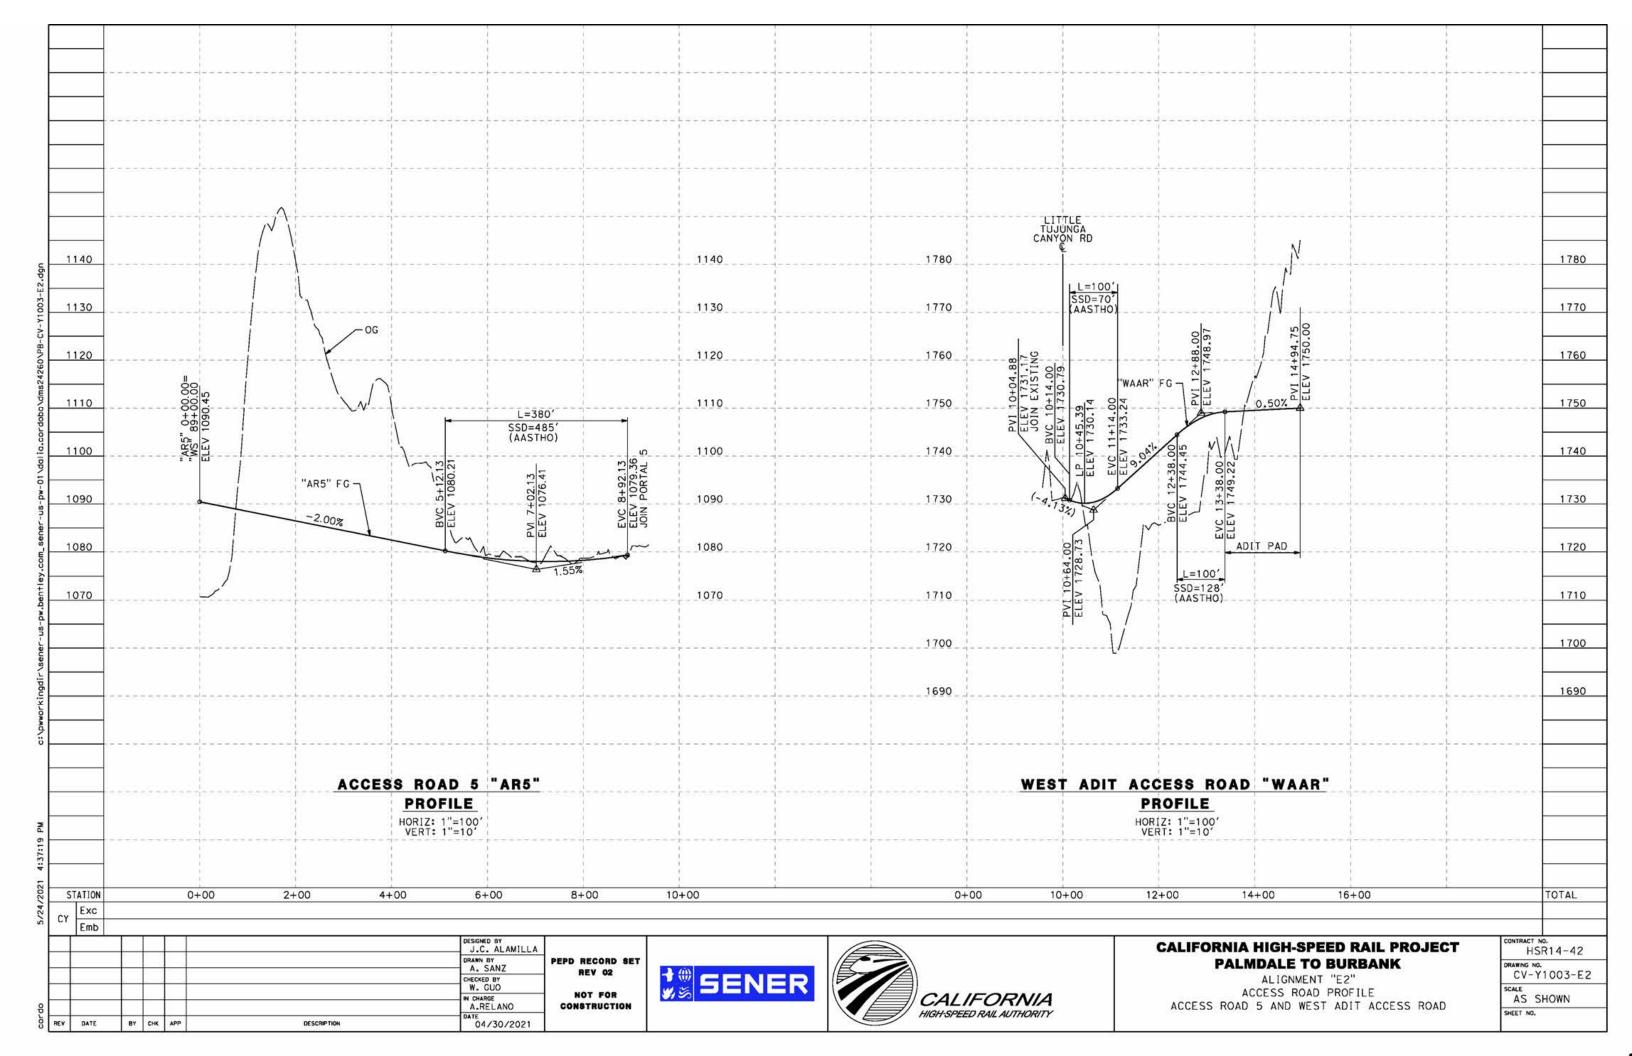

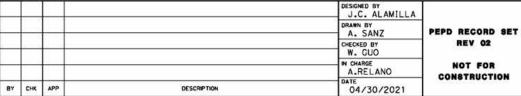





CALIFORNIA HIGH-SPEED RAIL PROJECT PALMDALE TO BURBANK

ALIGNMENT "E2" TYPICAL SECTIONS VALLEY FORGE AND EAST AVE R11


DRAWING	NO.
CV-	NO. - Y3001 - E2
SCALE	
NIO	SCALE
INC	SCALE

CONTRACT NO.

R/W R/W 221' TO 309' 30' TO 73' VAR 12' TO 20' VAR 12' TO 20' SW WB LANE EB LANE SW 2:1 /OG

VALLEY FORGE


STA 10+34 TO 15+34 RESIDENTIAL STREET (E) PER CITY OF PALMDALE GENERAL PLAN

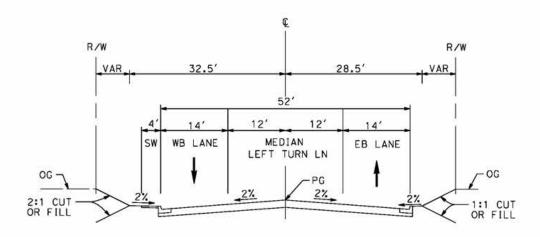

EAST AVENUE R11

STA 10+00.00 TO STA 18+80.51 LOCAL INTERIOR STREET PER CITY OF PALMDALE GENERAL PLAN



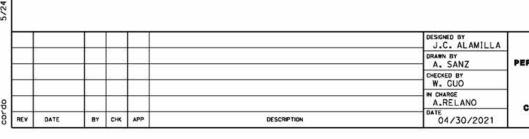


PEPD RECORD SET
REV 02

NOT FOR
CONSTRUCTION




R/W



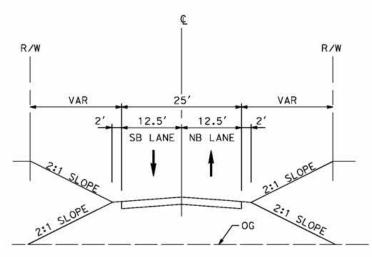

WEST ADIT ACCESS ROAD

STA 10+04.88 TO STA 14+94.75

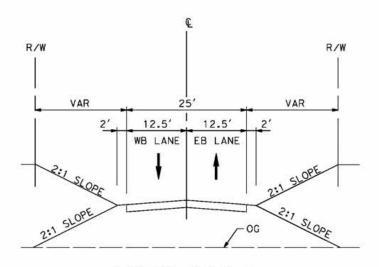

12.5

WB LANE EB LANE

ACCESS ROAD 4

STA 8+00 TO STA 16+88

12.5'

R/W

ACCESS ROAD 5 STA 0+00 TO STA 8+92.13

CALIFORNIA HIGH-SPEED RAIL PROJECT PALMDALE TO BURBANK

ALIGNMENT "E2"
TYPICAL SECTIONS
ACCESS ROAD 4, ACCESS ROAD 5
AND WEST ADIT ACCESS ROAD

DRAWING NO. CV-Y3002-E2
NO SCALE

BY CHK APP

DESCRIPTION



J.C. ALAMILLA

DRAWN BY A. SANZ

W. GUO

A.RELANO

04/30/2021



R/W

2:1 CUT OR FILL 15'





R/W

15'

CALIFORNIA HIGH-SPEED RAIL PROJECT PALMDALE TO BURBANK

ALIGNMENT "E2"
TYPICAL SECTIONS
CARSON MESA ACCESS ROAD AND ACCESS ROAD 3

CONTRACT NO. HSR14-42
DRAWING NO. CV-Y3003-E2
SCALE NO SCALE
SHEET NO.

SCRRA
R/W
VAR
11'TO
91'
VAR
22'
27

CARSON MESA ACCESS ROAD

STA 1+00 TO STA 17+28

25'

NB LANE SB LANE

ACCESS ROAD 3 STA 0+00 TO STA 7+30

12.5'

12.5'